PARKING SUMMARY CHART RIVER'S EDGE HOUSING OVERLAY DISTRICT (REHOD) PARKING SPACES SHALL BE PROVIDED AT A MINIMUM RATIO OF 1.25 PARKING SPACES PER DWELLING UNIT(1) (218 UNITS TOTAL) * (1.25 SPACES/UNITS) =273 SPACES TOTAL OFF-STREET PARKING REQUIREMENT =273 SPACES THEREFORE, 273 PARKING SPACES ARE REQUIRED AT A MINIMUM RATIO OF 1.25 SPACES PER 1 DWELLING UNIT. 345 TOTAL PARKING SPACES ARE CURRENTLY PROPOSED, INCLUDING 181 SPACES WITHIN THE PODIUM PARKING AREAS AND 164 SURFACE PARKING STALLS, FOR A PROPOSED PARKING RATIO OF 1.58 SPACES PER 1 DWELLING UNIT. 1.58 > 1.25, THEREFORE PROPOSED PARKING COUNT MEETS/EXCEEDS MINIMUM REQUIRED. THERE ARE BETWEEN 301 AND 400 TOTAL PARKING SPACES ADA REQUIRED: REQUIRING 8 ACCESSIBLE STALLS PER ADA REGULATIONS AND 2 OF THEM TO BE VAN ACCESSIBLE. ADA PROVIDED: 13 ADA ACCESSIBLE SPACES, 5 OF WHICH SHALL BE VAN STRUCTURED PARKING SURFACE PARKING STANDARD EV ADA STANDARD EV ADA SPACES SPACES SPACES SPACES SPACES REQUIRED **PROVIDED**

PARKING NOTES:

149 6

DIG SAFE

CALL 811 OR 1-888-DIG-SAFE 1-888-344-7233 (1) ...AND MAXIMUM OF 15 PARKING SPACES FOR ANY ACCESSORY CAFE OR DINER IN ADDITION TO SAID DWELLING UNIT PARKING SPACES. IF OVER 50% OF THE TOTAL NUMBER OF DWELLING UNITS ARE AGE RESTRICTED AS SET FORTH IN § 198-2506.6 BELOW, PARKING MAY BE PROVIDED AT A MINIMUM OF 0.50 PARKING SPACE PER AGE-RESTRICTED DWELLING UNIT. (2) INCLUDES 3 VAN ACCESSIBLE PARKING STALLS WITHIN STRUCTURED PODIUM PARKING.

345

273

9 | 171 | 6 | 4

BOLLARD BUILDING **BUILDING ARCHITECTURE** CURB RETAINING WALL < **?**** PARKING STRIPING TRAFFIC ARROWS HEAVY DUTY CONCRETE **SIDEWALK** ADA ACCESSIBLE RAMP ADA DET. WARNING SURFACE SETBACK LINE PARKING COUNT TREE LINE TRANSFORMER MONOLITHIC CURBING MONO. PRECAST CONC. CURB

LEGEND

PROPERTY LINE

SIGN

NOTES:

1. THE LOCATIONS OF EXISTING UNDERGROUND UTILITIES ARE SHOWN IN AN AND HAVE NOT BEEN INDEPENDENTLY VERIFIED APPROXIMATE WAY ONLY AND HAVE NOT BEEN INDEPENDENTLY VERIFIED BY THE OWNER OR ITS REPRESENTATIVE. THE CONTRACTOR SHALL DETERMINE THE EXACT LOCATION OF ALL EXISTING UTILITIES BEFORE COMMENCING WORK, AND AGREES TO BE FULLY RESPONSIBLE FOR ANY AND ALL DAMAGES WHICH MIGHT BE OCCASIONED BY THE CONTRACTOR'S FAILURE TO EXACTLY LOCATE AND PRESERVE ANY AND ALL UNDERGROUND UTILITIES.

2. THE INFORMATION SHOWN ON THIS PLAN IS THE SOLE PROPERTY OF ALLEN & MAJOR ASSOCIATES, INC. ITS INTENDED USE IS TO PROVIDE INFORMATION. ANY ALTERATION, MISUSE, OR RECALCULATION OF INFORMATION OR DATA WITHOUT THE EXPRESSED, WRITTEN CONSENT OF ALLEN & MAJOR ASSOCIATES, INC. IS STRICTLY PROHIBITED.

3. THE CONTRACTOR SHALL CONTACT "DIGSAFE" AND THE TOWN OF WAYLAND DEPARTMENT OF PUBLIC WORKS AT LEAST 72 HOURS PRIOR TO ANY EXCAVATION WORK TO REQUEST THE LOCATION OF THE EXISTING

DIGSAFE: 1-800-344-7233 WAYLAND DEPT. OF PUBLIC WORKS: (508) 358-3672

4. SEE THE ABBREVIATIONS AND NOTES PLAN AND DETAILS FOR FURTHER

5. ALL CURBING RADII SHALL BE 3' UNLESS OTHERWISE NOTED. ALL RADII AND DIMENSIONS MEASURED AT FACE OF CURB.

6. ALL ADA RAMPS ARE TO BE CONCRETE UNLESS SPECIFIED OTHERWISE.

7. EXISTING CONDITIONS BASE PLAN TAKEN FROM AN EXISTING CONDITIONS BASE PLAN ENTITLED "EXISTING CONDITIONS", PREPARED BY ALLEN &

MAJOR ASSOCIATES, INC., ORIGINAL SCALE 1"=40', DATED MAY 8, 2019. RIVERFRONT FLAGGINGS (RA SERIES) AND A&B SERIES WETLANDS FLAGGINGS TAKEN FROM A PLAN ENTITLED "EXSITING CONDITIONS SURVEY 484-490 BOSTON POST ROAD - WAYLAND, MASSACHUSETTS," PREPARED BY WSP SELLS DATED JULY 16, 2015, SCALE 1"=60'.

9. ALL PAVEMENT MARKINGS AND SIGNAGE SHALL BE COORDINATED WITH THE WAYLAND DPW AND SHALL CONFIRM TO THE LATEST MUTCD STANDARDS.

10. ALL SIDEWALK MEASUREMENTS TAKEN FROM FACE OF CURB.

11. THE EXISTING PAVEMENT SHALL BE MILLED AND PAVED, PER DPW SPECIFICATIONS, FROM BOSTON POST ROAD TO THE PROPOSED GATE LOCATION ONCE CONSTRUCTION IS COMPLETE.

12. ALL EXISTING SIGNS WITHIN THE LIMIT OF WORK SHALL BE RETAINED UNLESS OTHERWISE INDICATED ON THE DRAWINGS.

13. ALL MARKINGS OUTSIDE THE DEVELOPMENT PARCEL SHALL BE THERMOPLASTIC UNLESS OTHERWISE NOTED.

14. THE MINIMUM MOUNTING HEIGHT OF POST MOUNTED SIGNS, MEASURED VERTICALLY FROM THE BOTTOM OF THE SIGN TO THE TOP OF THE CURB OR SIDEWALK, OR ELEVATION OF THE NEAR EDGE OF TRAVEL WAY, SHALL BE 7 FEET, UNLESS OTHERWISE NOTED.

15. REMOVE THE EXISTING PASSING ZONE BY STRIPING NEW CENTERLINE PAVEMENT MARKINGS AS SHOWN. RELOCATE EXISTING SIGNAGE FROM THE EXISTING ZONE TERMINUS TO THE PROPOSED ZONE TERMINUS. ERADICATE CONFLICTING CENTERLINE PAVEMENT MARKINGS AS NECESSARY.

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Consultant: ALLEN & MAJOR ASSOCIATES, INC.

civil & structural engineering • land surveying environmental consulting • landscape architecture www.allenmajor.com 100 COMMERCE WAY, SUITE 5 WOBURN MA 01801 TEL: (781) 935-6889 FAX: (781) 935-2896

WOBURN, MA ◆ LAKEVILLE, MA ◆ MANCHESTER, NH Revision:


BULLETIN #1

Engineer of Record:

SJL/ND Drawn:

Checked: CMQ 1" = 40' Scale:

Key Plan:

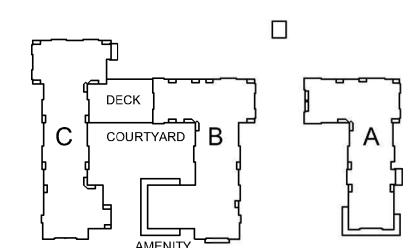

Project Name:

ALTA AT RIVER'S EDGE

490, 492, 494 BOSTON **POST RD** WAYLAND, MA 01778

Sheet Name:

LAYOUT & **MATERIALS** PLAN


Project Number:

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Issue Date:

SEPTEMBER 23, 2020

Sheet Number:

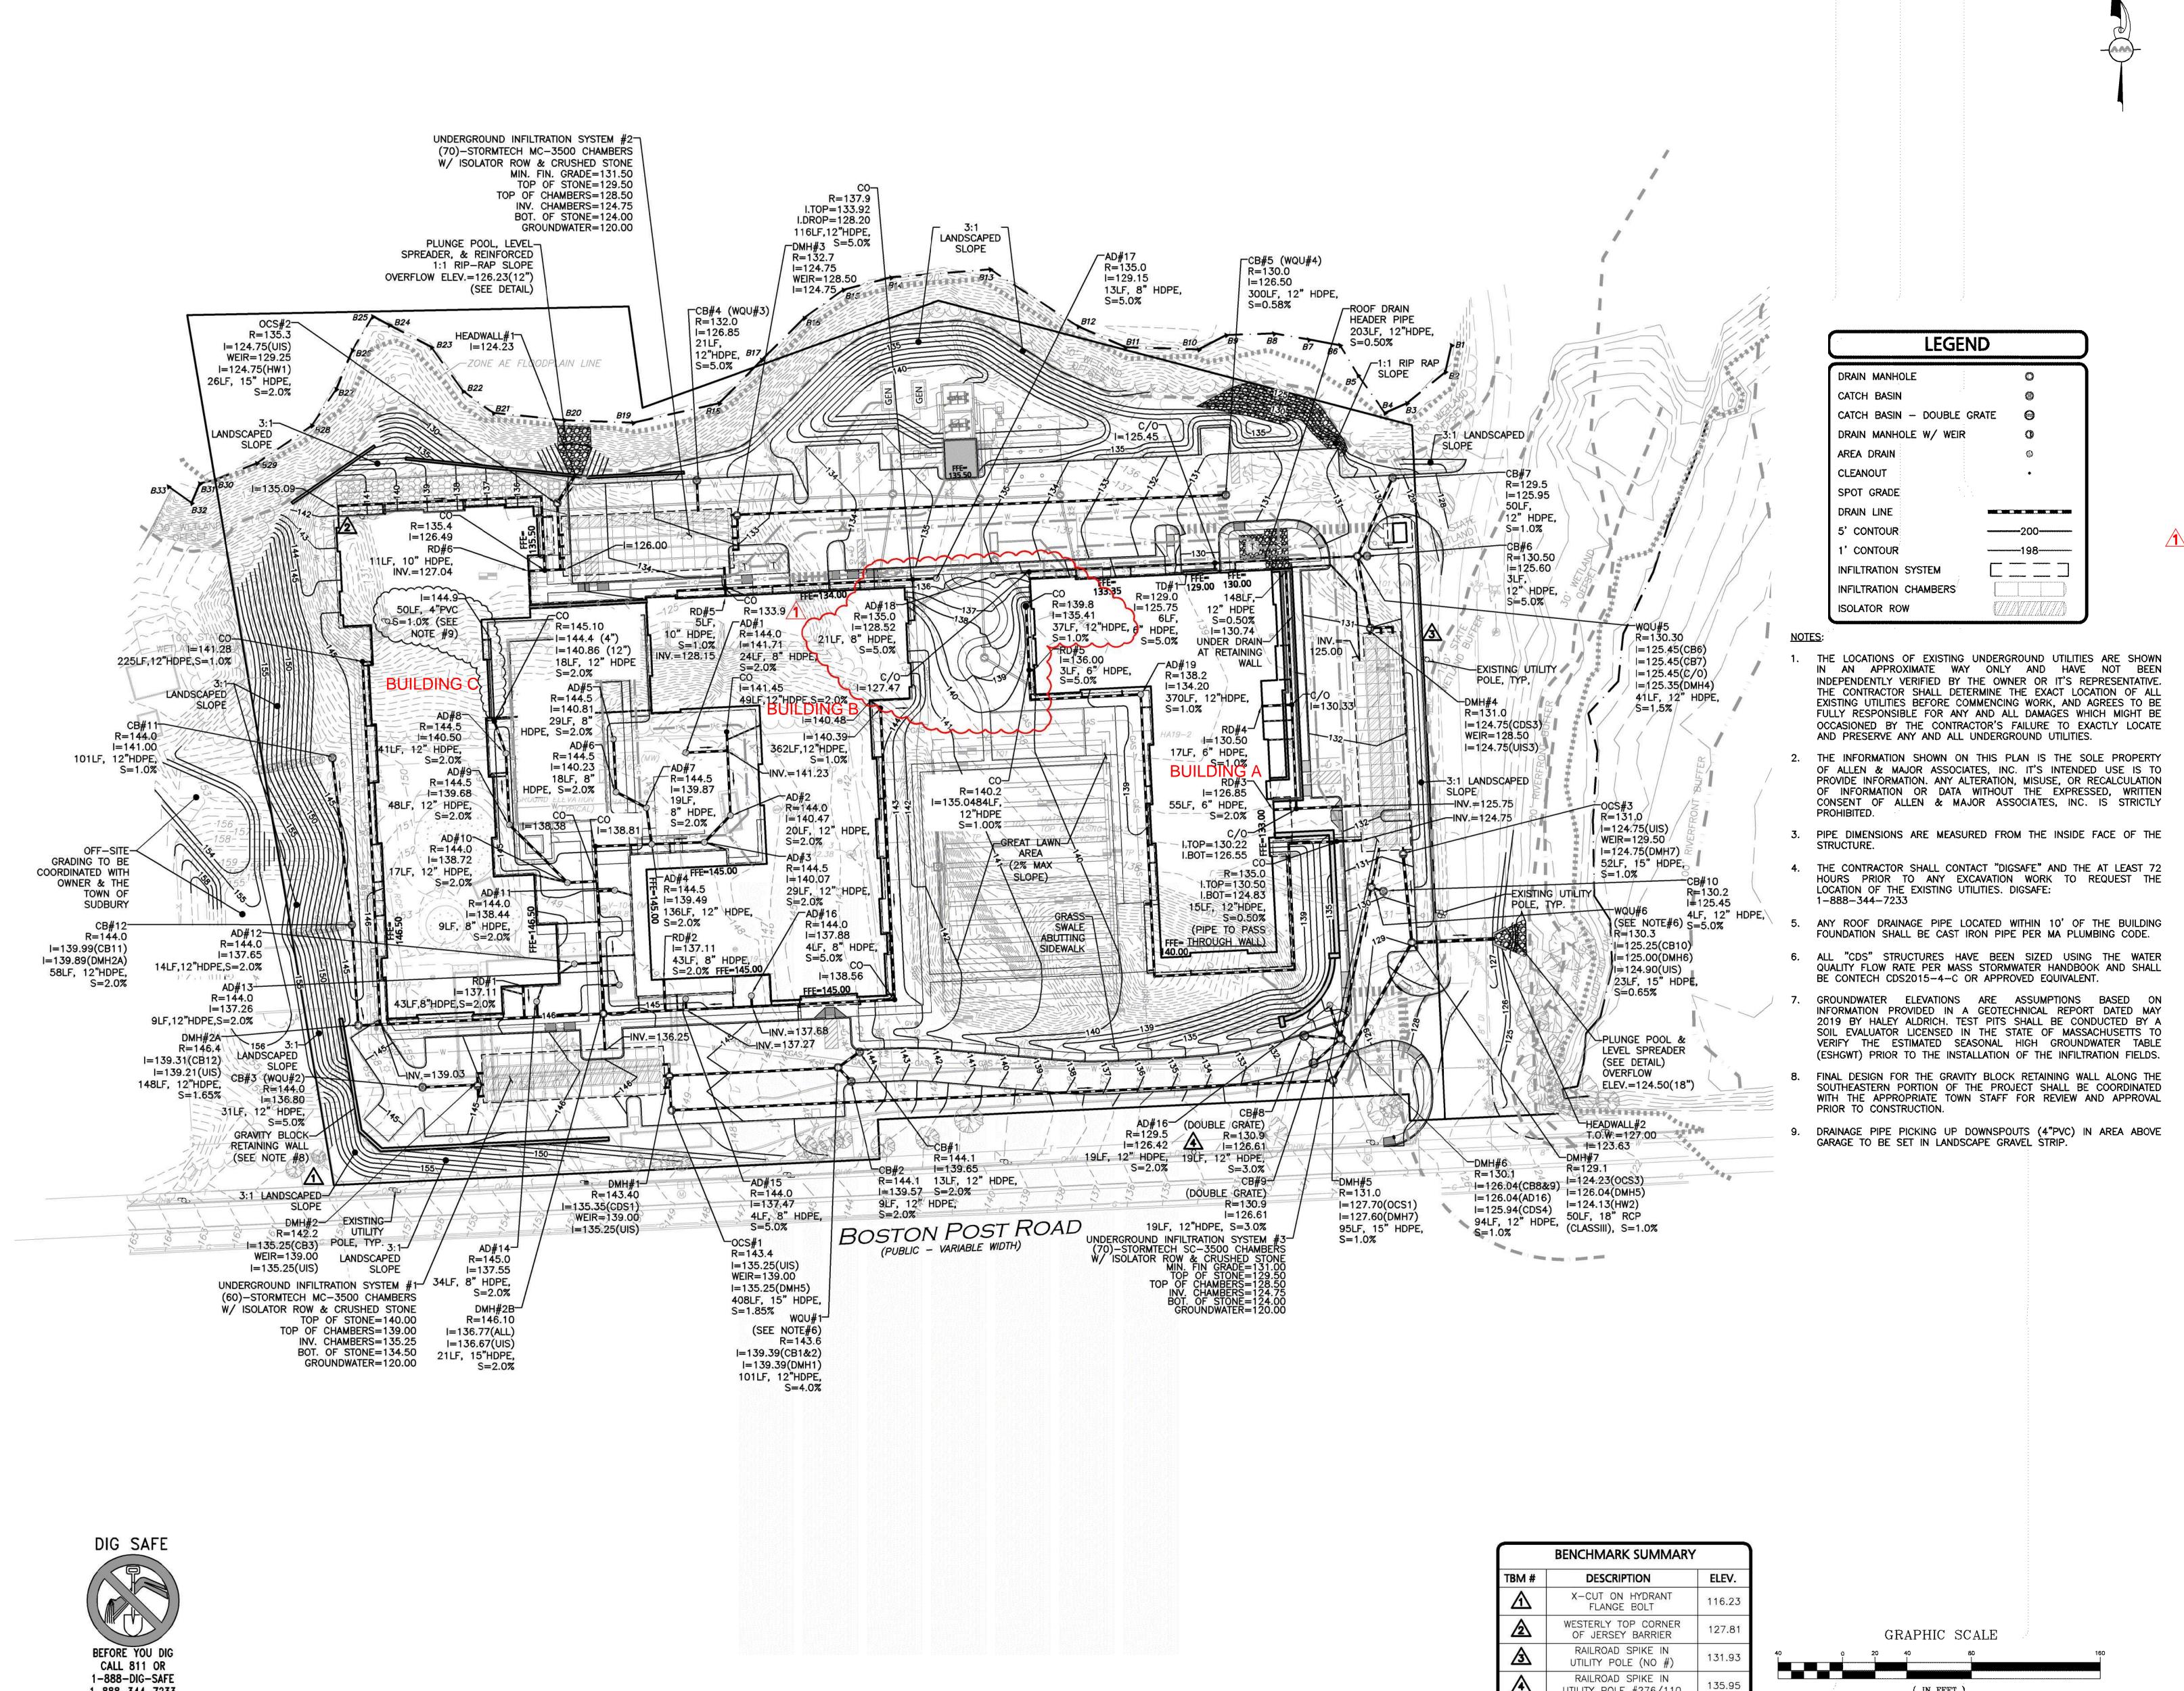

1-888-344-7233

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WOBURN, MA ◆ LAKEVILLE, MA ◆ MANCHESTER, NH Revision:

BULLETIN #1


Engineer of Record:

SJL/ND Drawn:

Checked: CMQ

1" = 40' Scale:

Key Plan:

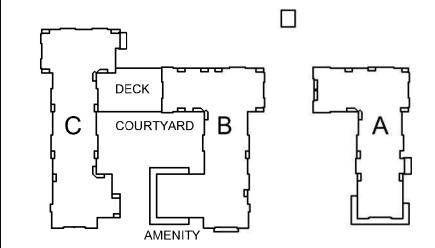

Project Name:

ALTA AT RIVER'S **EDGE**

490, 492, 494 BOSTON POST RD WAYLAND, MA 01778

Sheet Name:

GRADING & DRAINAGE PLAN

Project Number:

1670-09A


Issue Date:

SEPTEMBER 23, 2020

Sheet Number:

UTILITY POLE #276/110

(IN FEET) 1 inch = 40 ft.

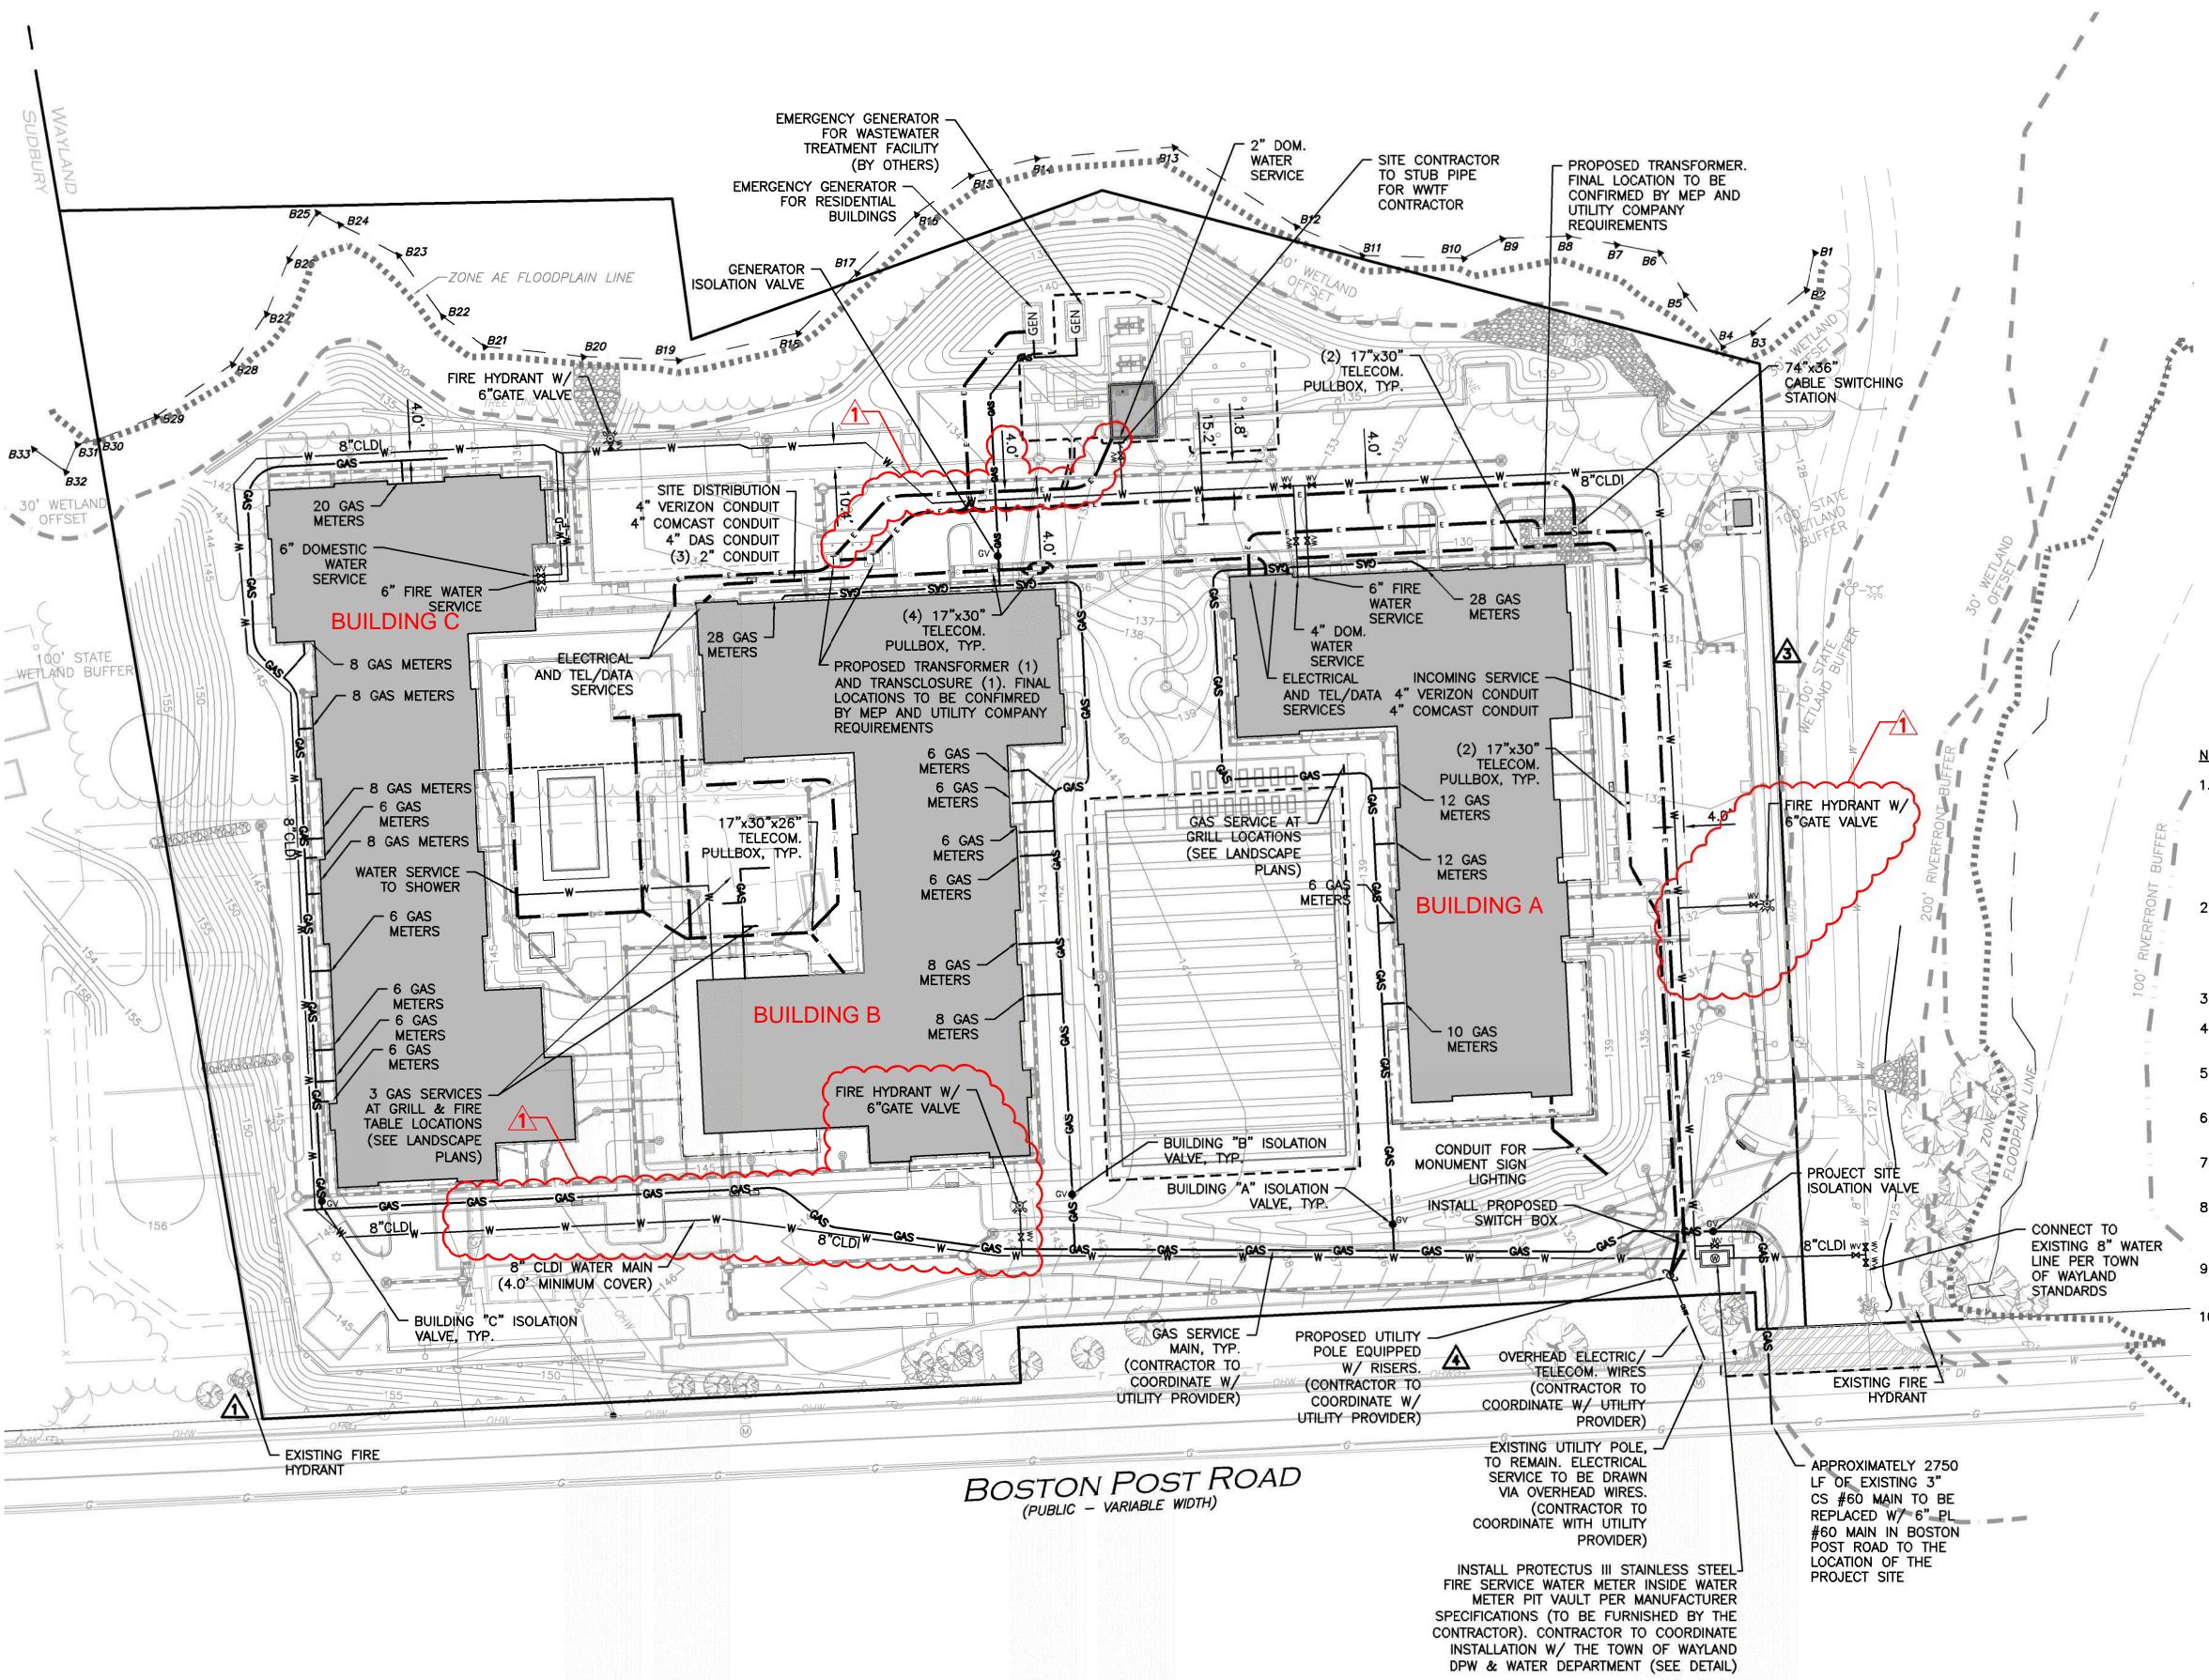

LEGEND SEWER MANHOLE SEWER CLEANOUT SEWER VENT SEWER LINE WATER LINE WATER VALVE HYDRANT WATER LINE REDUCER GAS LINE ——GAS —— GAS VALVE OVER HEAD WIRE —— онw ———— UTILILTY POLE НН HAND HOLE ELECTRICAL CONDUIT — E ——— E ———

NOTES:

1. THE LOCATIONS OF EXISTING UNDERGROUND UTILITIES ARE SHOWN IN AN APPROXIMATE WAY ONLY AND HAVE NOT BEEN INDEPENDENTLY VERIFIED BY THE OWNER OR IT'S REPRESENTATIVE. THE CONTRACTOR SHALL DETERMINE THE EXACT LOCATION OF ALL EXISTING UTILITIES BEFORE COMMENCING WORK, AND AGREES TO BE FULLY RESPONSIBLE FOR ANY AND ALL DAMAGES WHICH MIGHT BE OCCASIONED BY THE CONTRACTOR'S FAILURE TO EXACTLY LOCATE AND PRESERVE ANY AND ALL UNDERGROUND UTILITIES.


- 2. THE INFORMATION SHOWN ON THIS PLAN IS THE SOLE PROPERTY OF ALLEN & MAJOR ASSOCIATES, INC. IT'S INTENDED USE IS TO PROVIDE INFORMATION. ANY ALTERATION, MISUSE, OR RECALCULATION OF INFORMATION OR DATA WITHOUT THE EXPRESSED, WRITTEN CONSENT OF ALLEN & MAJOR ASSOCIATES, INC. IS STRICTLY PROHIBITED.
- 3. ALL C.L.D.I. WATER PIPE SHALL BE CLASS 52.
- 4. GAS AND ELECTRIC SERVICE SIZE AND LOCATION SHALL BE DETERMINED BY SERVICE PROVIDER.
- 5. FIRE & DOMESTIC WATER SERVICE SIZE & LOCATION TO BE CONFIRMED BY MEP ENGINEER.
- 6. THE PROPOSED IRRIGATION SYSTEM FOR THE DEVELOPMENT SHALL BE SUBMITTED TO WATER DEPARTMENT FOR APPROVAL PRIOR TO CONSTRUCTION.
- 7. HYDRANTS ARE TO BE INSTALLED PRIOR TO ANY COMBUSTIBLE MATERIALS BEING ON SITE.
- 8. PRIOR TO SUBMITTING FOR A BUILDING PERMIT, APPLICANT TO CONFIRM FINAL LOCATIONS OF FIRE HYDRANTS & FIRE DEPARTMENT CONNECTIONS WITH THE WAYLAND FIRE DEPARTMENT.
- 9. LOW VOLTAGE CONDUIT LOCATIONS TO BE CONFIRMED ON "LOW VOLTAGE SITE
- 10. THE CONTRACTOR SHALL CONTACT "DIGSAFE" AND THE TOWN OF WAYLAND DEPARTMENT OF PUBLIC WORKS AT LEAST 72 HOURS PRIOR TO ANY

DEPARTMENT OF PUBLIC WORKS AT LEAST 72 HOURS PRIOR TO ANY EXCAVATION WORK TO REQUEST THE LOCATION OF THE EXISTING UTILITIES.

DIGSAFE: 1-888-344-7233 WAYLAND DPW: 508-358-3672 WAYLAND WATER DEPT.: 508-358-3699

PLAN" BY OTHERS

BENCHMARK SUMMARY						
TBM #	DESCRIPTION	ELEV.				
\triangle	X—CUT ON HYDRANT FLANGE BOLT	116.23				
2	WESTERLY TOP CORNER OF JERSEY BARRIER	127.81				
3	RAILROAD SPIKE IN UTILITY POLE (NO #)	131.93				
A	RAILROAD SPIKE IN UTILITY POLE #276/110	135.95				

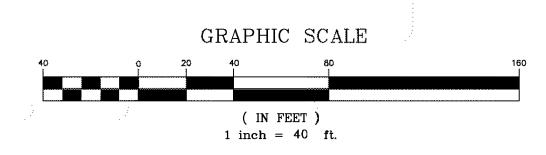

tat

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WOBURN, MA ◆ LAKEVILLE, MA ◆ MANCHESTER, NH

Revision:

1. 11/9/20 BULLETIN #1

Engineer of Record:

Drawn: SJL/ND

Checked: CMQ

Scale: 1" = 40'

Key Plan:

DECK DECK A

Project Name:

ALTA AT RIVER'S EDGE

490, 492, 494 BOSTON POST RD WAYLAND, MA 01778

Sheet Name:

UTILITIES PLAN

Project Number:

1670-09A

Issue Date:

SEPTEMBER 23, 2020

Sheet Number:


C-104E

LANDSCAPE MATERIAL NOTES

- 1. THE CONTRACTOR SHALL REVIEW ALL DRAWINGS AND SPECIFICATIONS TO DETERMINE THE TOTAL SCOPE OF WORK AND ALL REQUIRED COORDINATION.
- 2. THE CONTRACTOR IS RESPONSIBLE FOR A THOROUGH SITE EXAMINATION TO SATISFY THEMSELVES AS TO THE ACTUAL 7. SITE CONDITIONS BEFORE SUBMISSION OF BIDS.
- 3. CONTRACTOR SHALL VERIFY ALL EXISTING UTILITY LOCATIONS PRIOR TO EXCAVATION. 4. CONTRACTOR SHALL ARRANGE PRE-INSTALLATION CONFERENCES AT PROJECT SITE FOR WALLS AND PAVEMENT WORK. ATTENDEES SHALL INCLUDE OWNER'S REPRESENTATIVE, LANDSCAPE ARCHITECT, GENERAL CONTRACTOR AND ALL
- SUB-CONTRACTORS DIRECTLY CONCERNED WITH THE WORK. 5. CONTRACTOR SHALL PREPARE SUBMITTALS TO THE LANDSCAPE ARCHITECT FOR ALL COMPONENTS OF THE FINISHED 9. THE CONTRACTOR IS RESPONSIBLE FOR ALL DAMAGE INSIDE OR OUTSIDE OF LIMIT OF WORK LINE DUE TO THEIR
- WORK, INCLUDING SHOP DRAWINGS, PRODUCT DATA, MATERIAL CERTIFICATIONS, MIX DESIGNS AND SAMPLES. 6. CONTRACTOR SHALL FURNISH AND INSTALL CONSTRUCTED SAMPLES (MOCK-UPS) DEMONSTRATING ALL COMPONENTS 10. OF THE DESIGN, INCLUDING FINISHED EXPOSED EDGES AND SURFACES, COLORS AND JOINTING FOR REVIEW AND APPROVAL BY THE LANDSCAPE ARCHITECT PRIOR TO CONSTRUCTING FINAL WORK. MOCK-UPS MAY BE PART OF THE FINAL CONSTRUCTION. MOCK-UPS SHALL BE MAINTAINED AND PROTECTED THROUGHOUT THE DURATION OF THE

PROJECT AND WILL SERVE AS PROJECT STANDARD. CONTRACTOR SHALL DEMOLISH AND RECONSTRUCT MOCK-UP

- UNTIL APPROVAL FROM LANDSCAPE ARCHITECT. MOCK-UPS SHALL INCLUDE: 6'X6' MOCK UP OF EACH COLOR AND PATTERN TYPE FOR STAMPED AND COLORED CONCRETE.
- THE DIMENSIONS OF PAVEMENT JOINTS AS SHOWN ON THE DRAWINGS ARE TO THE CENTER LINE OF EACH TYPE OF JOINT EXCEPT WHERE PAVEMENT MEETS A VERTICAL FACE; AT THIS LOCATION DIMENSIONS ARE TO THE VERTICAL FACE. THE DIMENSIONS SHOWN ON DRAWINGS SHOW DESIGN INTENT AND MUST BE FIELD VERIFIED PRIOR TO PREPARATION OF SHOP DRAWINGS. ALL ALIGNMENTS SHALL BE INSTALLED AS SHOWN.
- THE CONTRACTOR SHALL BE RESPONSIBLE FOR DOCUMENTING THE LOCATIONS OF ALL EXISTING SITE ELEMENTS TO BE RESET IN THEIR SAME HORIZONTAL LOCATION.
- CONSTRUCTION OPERATIONS. STORAGE AREAS FOR THE GENERAL CONTRACTOR'S EQUIPMENT AND MATERIALS SHALL BE LOCATED WITHIN THE LIMITS
- OF WORK AS APPROVED BY THE LANDSCAPE ARCHITECT.
- WHERE NEW PAVING MEETS EXISTING PAVING, MEET LINE AND GRADE OF EXISTING WITH NEW CONSTRUCTION. 12. AT ALL LOCATIONS WHERE EXISTING BITUMINOUS CONCRETE PAVEMENT ABUTS NEW CONSTRUCTION, THE EDGE OF
- THE EXISTING PAVEMENT SHALL BE SAWCUT TO A CLEAN SMOOTH EDGE.

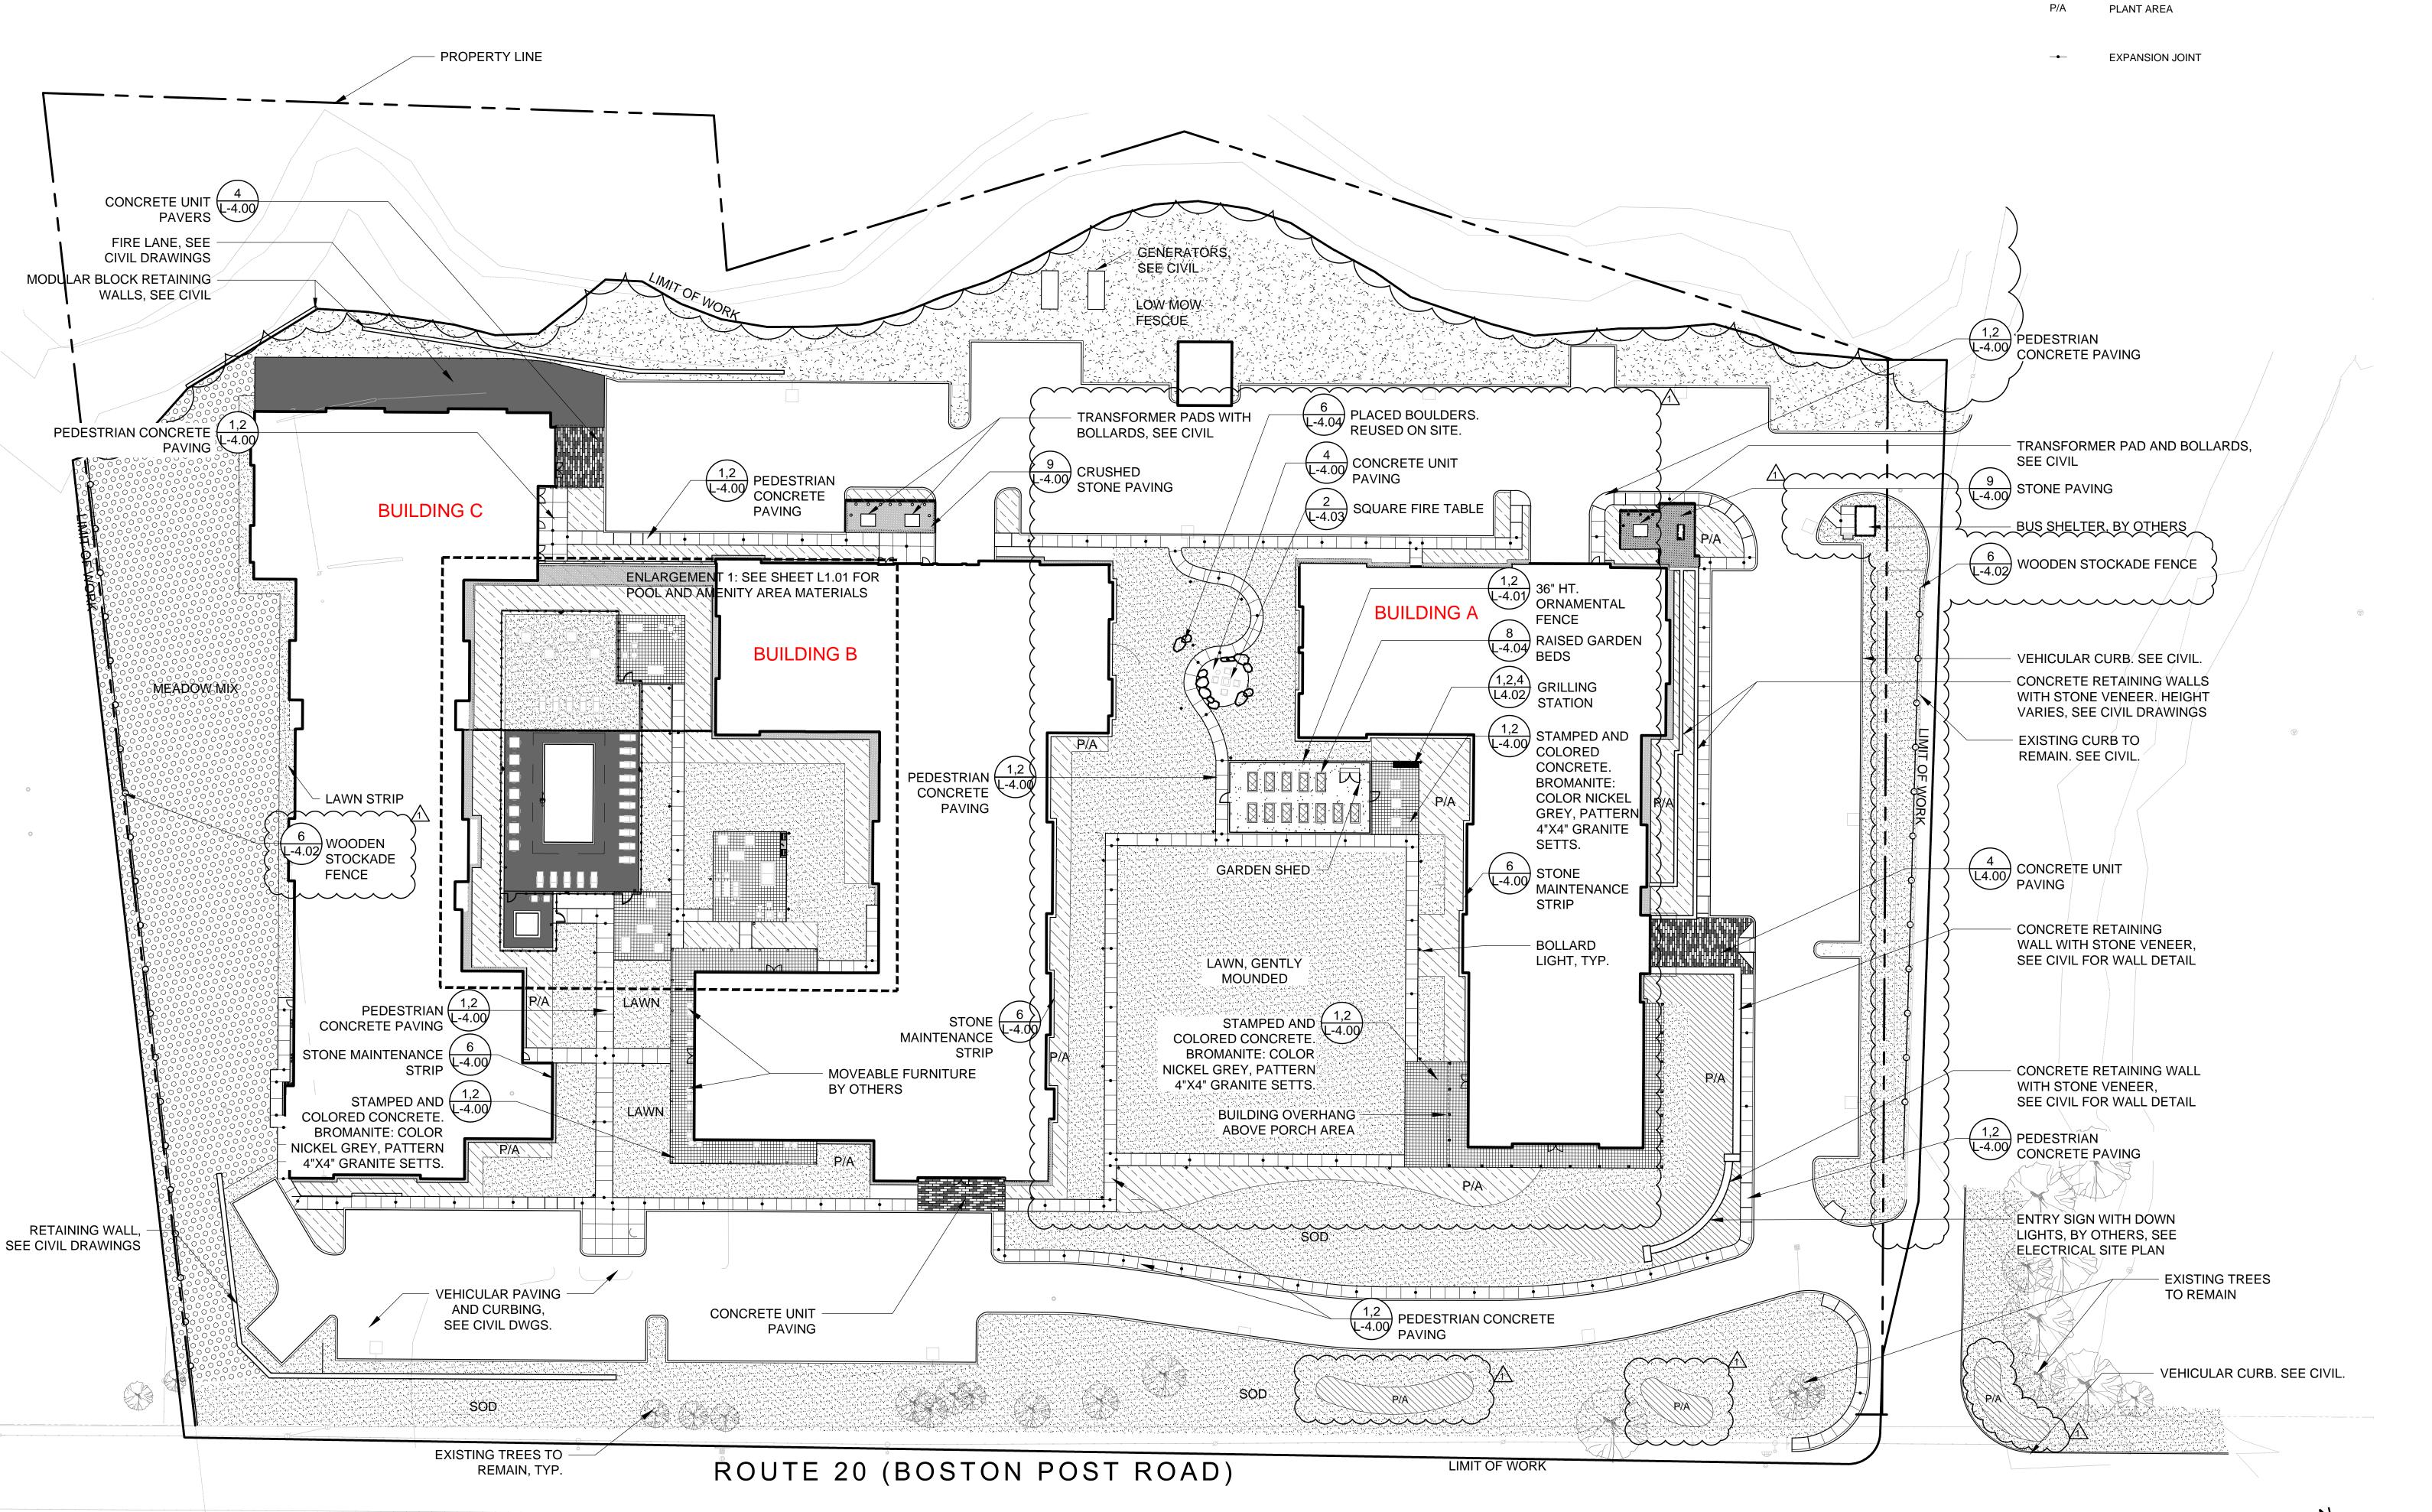



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MATERIALS LEGEND

CONCRETE PAVING

—O DOUBLE RAILING VINYL FENCING

ORNAMENTAL FENCE

PROPERTY LINE

LIMIT OF WORK

6' HT POOL FENCE

SCALE: 1"=30'

STAMPED AND COLORED CONCRETE (POOL) BROMANITE:

STAMPED AND COLORED CONCRETE (PATIO) BROMANITE:

COLOR NICKEL GREY, PATTERN 4"X4" GRANITE SETTS

PRECAST CONCRETE UNIT PAVING

COLOR COQUINA, PATTERN COQUINA FRAYED EDGE 4.5'X4.5'



Copley Wolff Design Group Landscape Architects & Planners

Revision:


11/09/20 BULLETIN #1

Architect of Record:



Drawn: SAS Checked: AA Scale: 1" = 30'-0"

Key Plan:

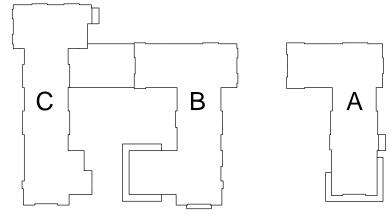

Project Name:

ALTA AT RIVER'S **EDGE**

490, 492, 494 BOSTON POST RD WAYLAND, MA 01778

Sheet Name:

Materials Plan

Project Number:

15151.00

Issue Date:


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Sheet Number:

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LANDSCAPE MATERIAL NOTES

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- 4. CONTRACTOR SHALL ARRANGE PRE-INSTALLATION CONFERENCES AT PROJECT SITE FOR WALLS AND PAVEMENT WORK. ATTENDEES SHALL INCLUDE OWNER'S REPRESENTATIVE, LANDSCAPE ARCHITECT, GENERAL CONTRACTOR AND ALL SUB-CONTRACTORS DIRECTLY CONCERNED WITH THE WORK.
- 5. CONTRACTOR SHALL PREPARE SUBMITTALS TO THE LANDSCAPE ARCHITECT FOR ALL COMPONENTS OF THE FINISHED 9. THE CONTRACTOR IS RESPONSIBLE FOR ALL DAMAGE INSIDE OR OUTSIDE OF LIMIT OF WORK LINE DUE TO THEIR WORK, INCLUDING SHOP DRAWINGS, PRODUCT DATA, MATERIAL CERTIFICATIONS, MIX DESIGNS AND SAMPLES.
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- UNTIL APPROVAL FROM LANDSCAPE ARCHITECT. MOCK-UPS SHALL INCLUDE: 6'X6' MOCK UP OF EACH COLOR AND PATTERN TYPE FOR STAMPED AND COLORED CONCRETE.
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- CONSTRUCTION OPERATIONS. STORAGE AREAS FOR THE GENERAL CONTRACTOR'S EQUIPMENT AND MATERIALS SHALL BE LOCATED WITHIN THE LIMITS
- OF WORK AS APPROVED BY THE LANDSCAPE ARCHITECT.
- WHERE NEW PAVING MEETS EXISTING PAVING, MEET LINE AND GRADE OF EXISTING WITH NEW CONSTRUCTION. 12. AT ALL LOCATIONS WHERE EXISTING BITUMINOUS CONCRETE PAVEMENT ABUTS NEW CONSTRUCTION, THE EDGE OF
- THE EXISTING PAVEMENT SHALL BE SAWCUT TO A CLEAN SMOOTH EDGE.



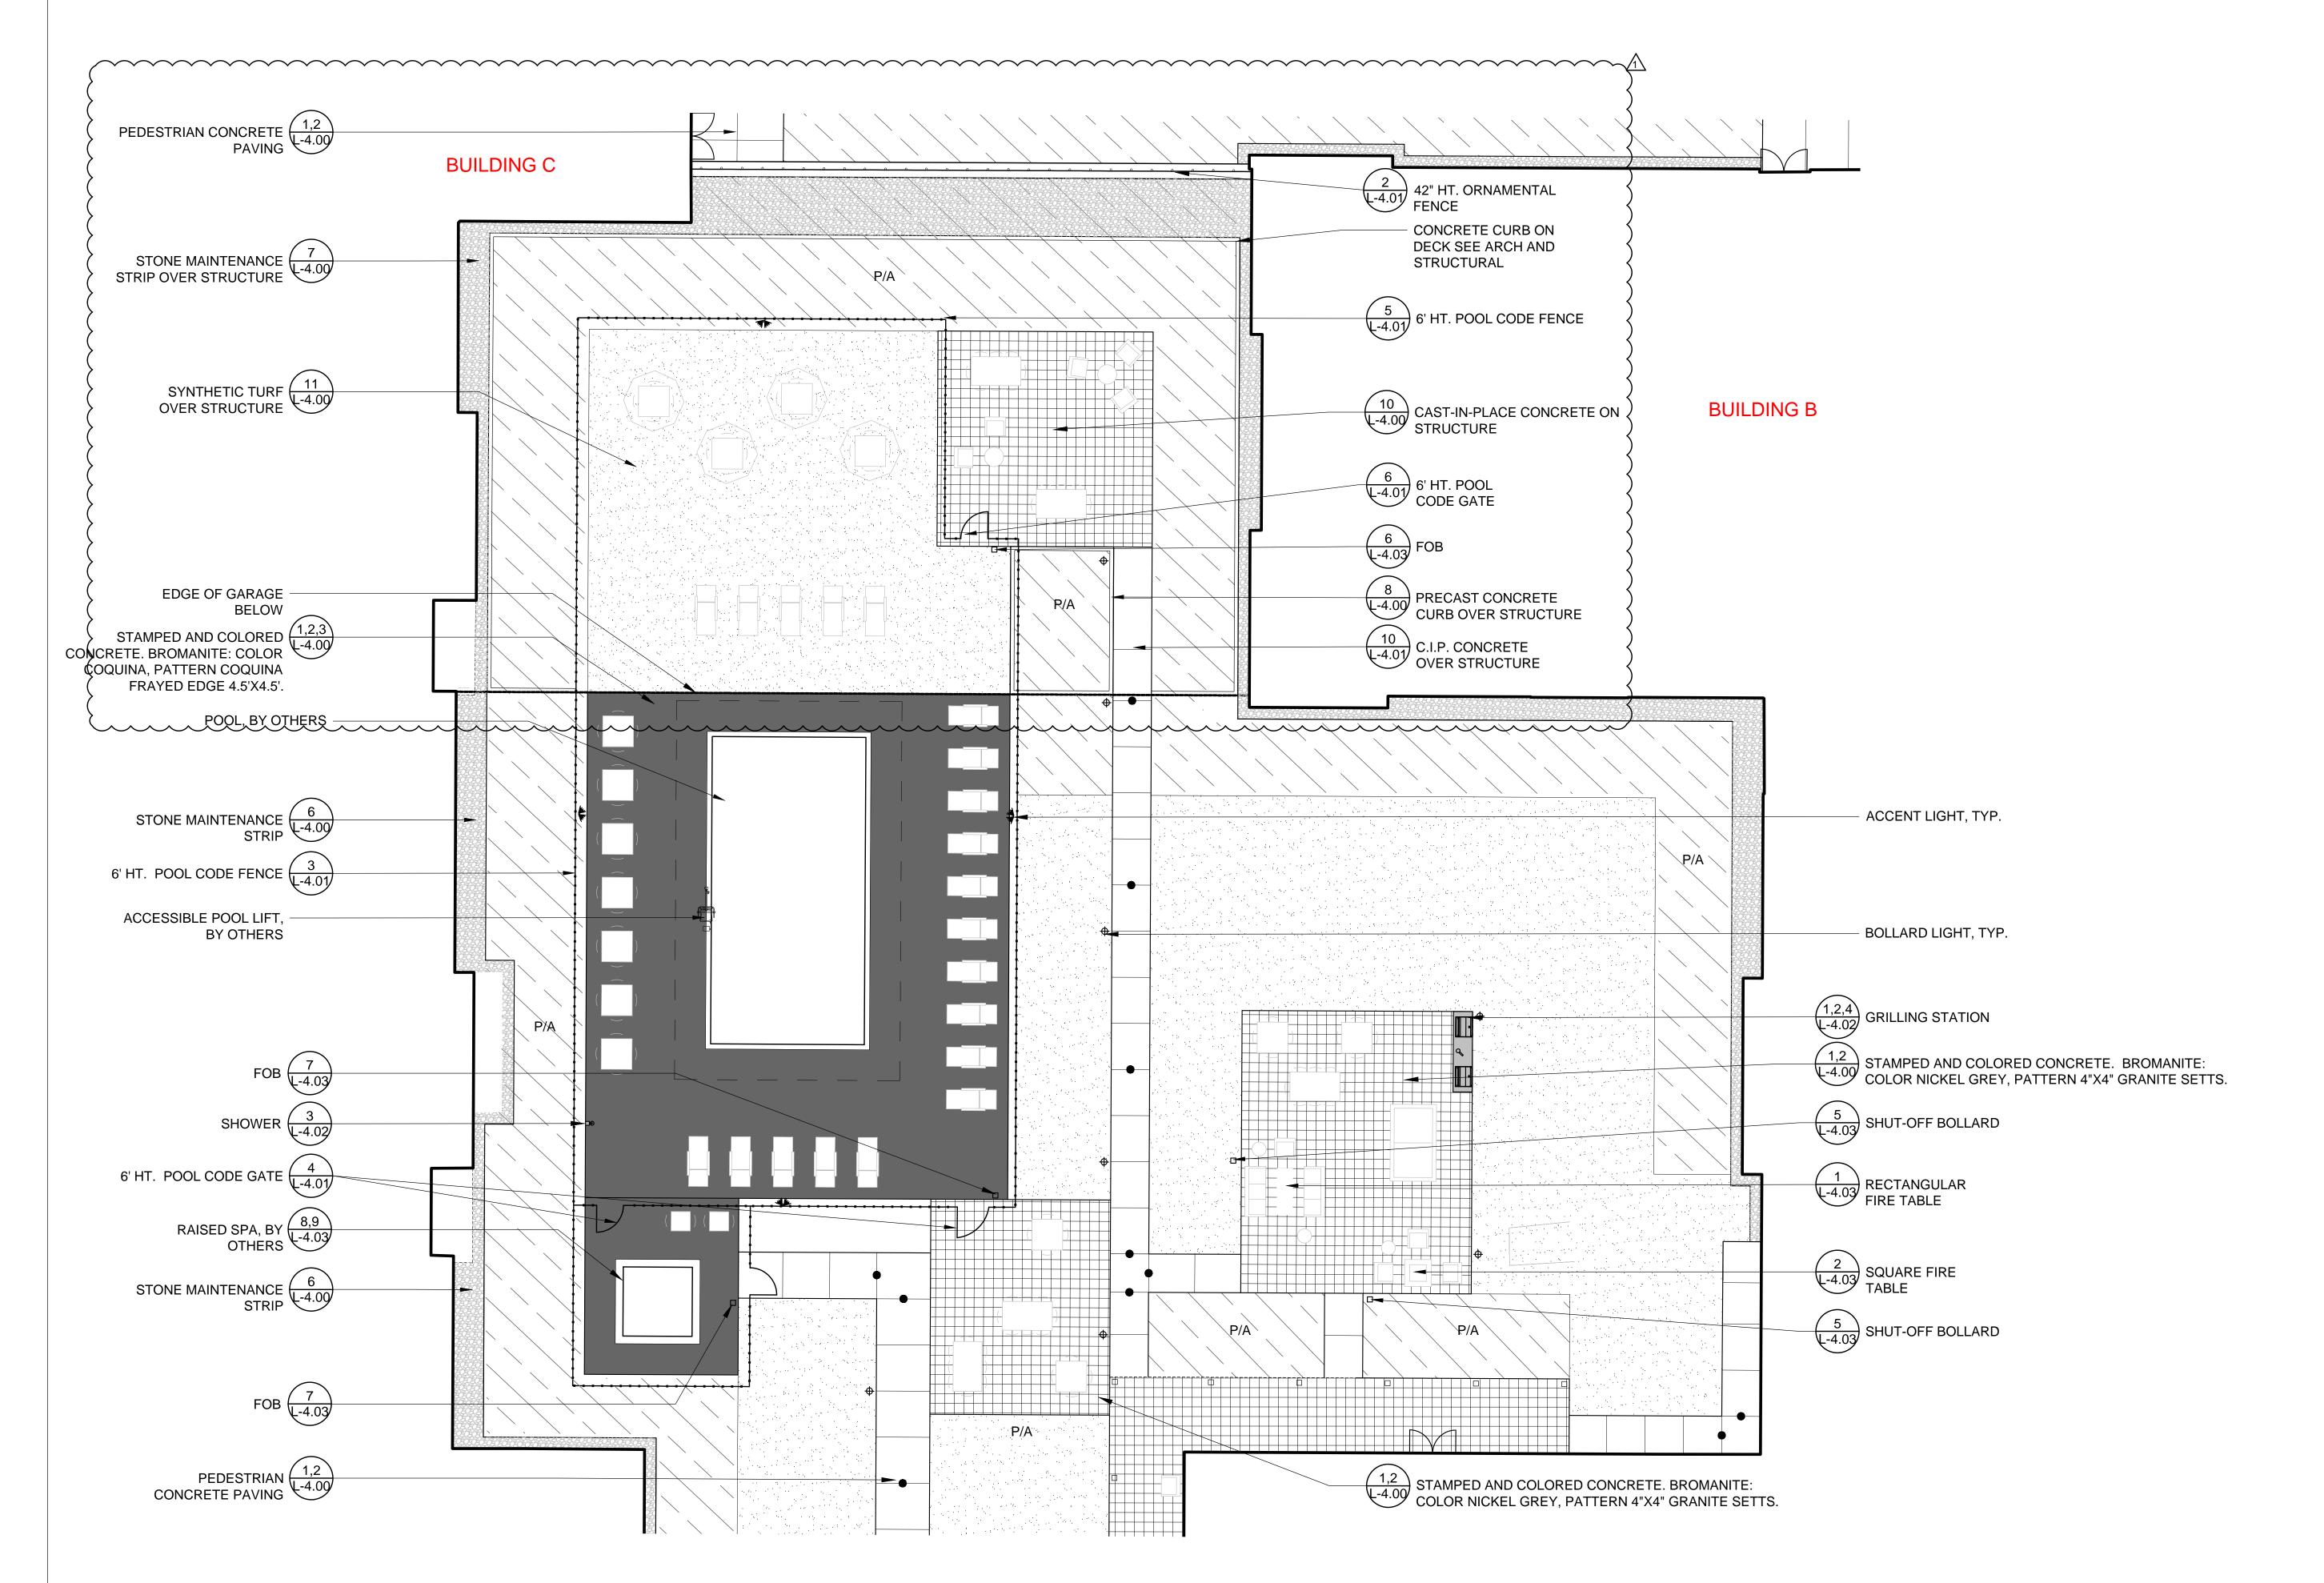

CONCRETE PAVING



STAMPED AND COLORED CONCRETE (PATIO) BROMANITE: COLOR NICKEL GREY, PATTERN 4"X4" GRANITE SETTS

PRECAST CONCRETE UNIT PAVING

ORNAMENTAL FENCE

PROPERTY LINE

—O DOUBLE RAILING VINYL FENCING

6' HT POOL FENCE

---- LIMIT OF WORK

PLANT AREA

EXPANSION JOINT



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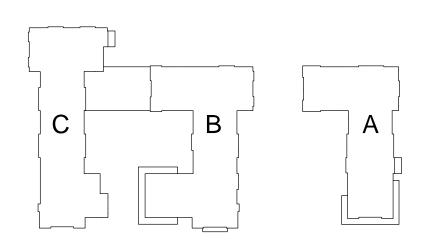
11/09/20 BULLETIN #1

Architect of Record:

Drawn: SAS

Checked: AA Scale: 1" = 10'-0"

Key Plan:



Project Name:

ALTA AT RIVER'S **EDGE**

490, 492, 494 BOSTON POST RD WAYLAND, MA 01778

Sheet Name:

Materials Plan: Enlargement 1

Project Number:

15151.00

Issue Date:

SEPTEMBER 23, 2020

Sheet Number:

L 1.01

PLANTING AND SOIL NOTES

- 1. IF DISCREPANCIES EXIST BETWEEN THE NUMBER OF PLANTS DRAWN ON THE PLANTING PLAN AND THE NUMBER OF PLANTS 11. ALL PLANT BEDS TO RECEIVE UN-DYED, AGED AND SHREDDED BARK MULCH AS PER SPECIFICATIONS. IN THE PLANT LIST, THE PLANTING PLAN SHALL GOVERN.
- 2. ALL NEW PLANT MATERIAL SHALL CONFORM TO THE MINIMUM GUIDELINES ESTABLISHED FOR NURSERY STOCK PUBLISHED BY THE AMERICAN ASSOCIATION OF NURSERYMEN, INC. IN ADDITION, ALL NEW PLANT MATERIAL FOR THE PROJECT SHALL
- 3. THE LANDSCAPE ARCHITECT SHALL ONLY REVIEW TREES THAT ARE IN THE GROUND AT THE NURSERY. NO PRE-DUG TREES WILL BE ACCEPTED. THEREFORE TIMING OF IN-GROUND REVIEWS MUST BE COORDINATED WITH EXPECTED INSTALLATION
- 4. ALL NEW PLANTS TO BE BALLED & BURLAPPED OR CONTAINER GROWN, UNLESS OTHERWISE NOTED ON THE PLANT LIST.
- 5. THE CONTRACTOR SHALL SUPPLY ALL NEW PLANT MATERIAL IN QUANTITIES SUFFICIENT TO COMPLETE THE PLANTING SHOWN ON THE DRAWINGS.
- 6. ANY PROPOSED SUBSTITUTIONS OF PLANT SPECIES SHALL BE MADE WITH PLANTS OF EQUIVALENT OVERALL FORM, HEIGHT, 18. WHERE A SOIL PROFILE ENCROACHES WITHIN THE DRIP LINE OF EXISTING TREES, CONSULT WITH LANDSCAPE ARCHITECT BRANCHING HABIT, FLOWER, LEAF, COLOR, FRUIT AND CULTURE, AND ONLY AFTER WRITTEN APPROVAL OF THE LANDSCAPE ARCHITECT.
- 7. ALL NEW PLANTS SHALL BE TAGGED AND APPROVED BY THE LANDSCAPE ARCHITECT AT THE NURSERY PRIOR TO DIGGING 20. SCARIFY SUBGRADE AS SPECIFIED BEFORE PLACEMENT OF ANY PLANTING SOILS.
- 8. CONTRACTOR SHALL LOCATE AND VERIFY ALL EXISTING UTILITY LINES PRIOR TO PLANTING AND SHALL REPORT ANY CONFLICTS TO THE LANDSCAPE ARCHITECT.
- 9. STAKE LOCATION OF ALL PROPOSED PLANTING FOR APPROVAL BY LANDSCAPE ARCHITECT PRIOR TO THE COMMENCEMENT
- OF PLANTING.
- 10. NEW SHRUBS AND GROUNDCOVER SHALL BEAR THE SAME RELATIONSHIP TO GRADE AS IT BORE TO PREVIOUS GRADE. TREES SHALL BE SET 3" HIGHER THAN PREVIOUS GRADE. NO TREES SHALL BE PLANTED BEFORE ACCEPTANCE OF ROUGH GRADING.


- 12. ALL EXISTING TREES TO REMAIN SHALL BE PROPERLY PROTECTED DURING CONSTRUCTION. PROTECTION TECHNIQUES SHALL BE REVIEWED AND APPROVED BY THE LANDSCAPE ARCHITECT.
- 13. PRUNE TREES IN ACCORDANCE WITH THE SPECIFICATIONS. 14. ALL PLANT MATERIAL SHALL BE MAINTAINED BY CONTRACTOR UNTIL FINAL ACCEPTANCE AND GUARANTEED FOR 1
- CALENDAR YEAR. 15. CONFIRM ALL QUANTITIES AGAINST PLANTING PLANS, GRADING PLANS, AND SPECIFICATIONS, INCLUDING SITE
- DISTURBANCE OUTSIDE OF THE LIMIT OF GRADING NECESSITATED TO FACILITATE CONSTRUCTION. 16. WHERE SAND AND GRAVEL ARE SPECIFIED FOR A DRAINAGE LAYER, EXTEND DRAINAGE LAYER TO ASSOCIATED DRAIN LINES, DRAINAGE AREAS, OR DAYLIGHT
- 17. WHERE ONE SOIL TYPE MEETS ANOTHER SOIL TYPE, FORM A 1:1 SLOPED BOUNDARY TRANSITION. PRIOR TO COMMENCING EXCAVATION.
- 19. ALL EXCAVATION AND PLACEMENT OF SOILS WITHIN THE DRIP LINE OF EXISTING TREES TO BE PERFORMED BY HAND.
- 21. DO NOT PLACE OR HANDLE SOILS THAT ARE WET.
- 22. PROTECT ALL EXISTING SOILS AGAINST COMPACTION, CONTAMINATION WITH CONSTRUCTION MATERIALS, AND ALL
- 23. CONTRACTOR IS RESPONSIBLE FOR ACTUAL SITE CONDITIONS, COORDINATION OF SOILS PLACEMENT, AND PLANTING **SUBDRAINAGE**
- 24. DO NOT PLACE ANY PLANTING SOIL PRIOR TO INSPECTION BY LANDSCAPE ARCHITECT.
- 25. EXTENTS OF SAND BASED STRUCTURAL SOIL (SBSS) ARE APPROXIMATE. PROVIDE A MINIMUM OF 1,000 C.F. OF SBSS FOR EACH TREE.

Symbol	Qty	Botanical Name	Common Name	Size	MBOT Spread	Comments
hade Tree	s			-		
AFA	1	Acer x freemanii "Armstrong'	Arm strong Maple	3-3.5" CAL	10-15'	
AR	11	Acer rubrum 'October Glory'	October Glory Red Maple	3-3.5" CAL	30-40'	
AS	2	Acer saccharum 'Legacy'	Legacy Sugar Maple	3-3.5" CAL	30-60'	
BN	5	Betula nigra 'Duraheat'	River Birch	2-2.5" CAL	25-35'	Single Stem
GBS	2	Gingko biloba 'JN9' Sky Tower	Fastigiate Gingko	3-3.5" CAL	10-15'	
LT	3	Liriodendron tulipifera	Tulip Tree	3-3.5" CAL	30-50'	
NS	1	Nyssa sylvatica	Black Tupelo	3-3.5" CAL	20-30'	
QB	8	Quercus bicolor	Swamp White Oak	3-3.5" CAL	50-60'	
QR	7	Quercus rub ra	Red Oak	3-3.5" CAL	50-60'	
UA	9	Ulmus americana 'Princeton'	Princeton American Elm	3-3.5" CAL	30-50'	
Prnamenta	I Tree	s			•	
AC	20	Amelanchier canadensis '	Shadblow Serviceberry	6-8' HT.	15-20'	Multi Stem
CA	4	Cornus alternifolia	Pagoda Dogwood	2-2.5" CAL	20-30'	Specimen
CF	3	Cornus 'Rutcan' Constellation	Constellation Dogwood	2-2.5" CAL	12-18'	Specimen
MSR	5	Magnolia stellata 'Royal Star'	Royal Star Magnolia	22.5"	8-15'	Specimen
vergreen	Trees				•	
AB	8	Abies balsamea	Balsam Fir	8-10' HT	15-25'	
JV	2	Juniperus virginiana	Eastern Red Cedar	8-10' HT	8-25'	
РВ	2	Pinus banksiana	Jack Pine	10-15' HT	20-30'	
PG	12	Picea glauca	White Spruce	8-10' HT	10-20'	

SCALE: 1"=30'




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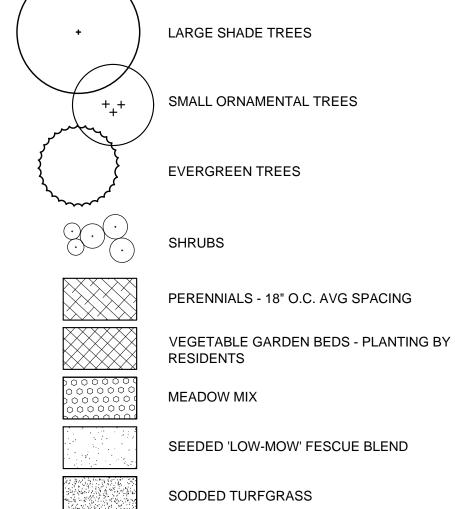
L 2.00

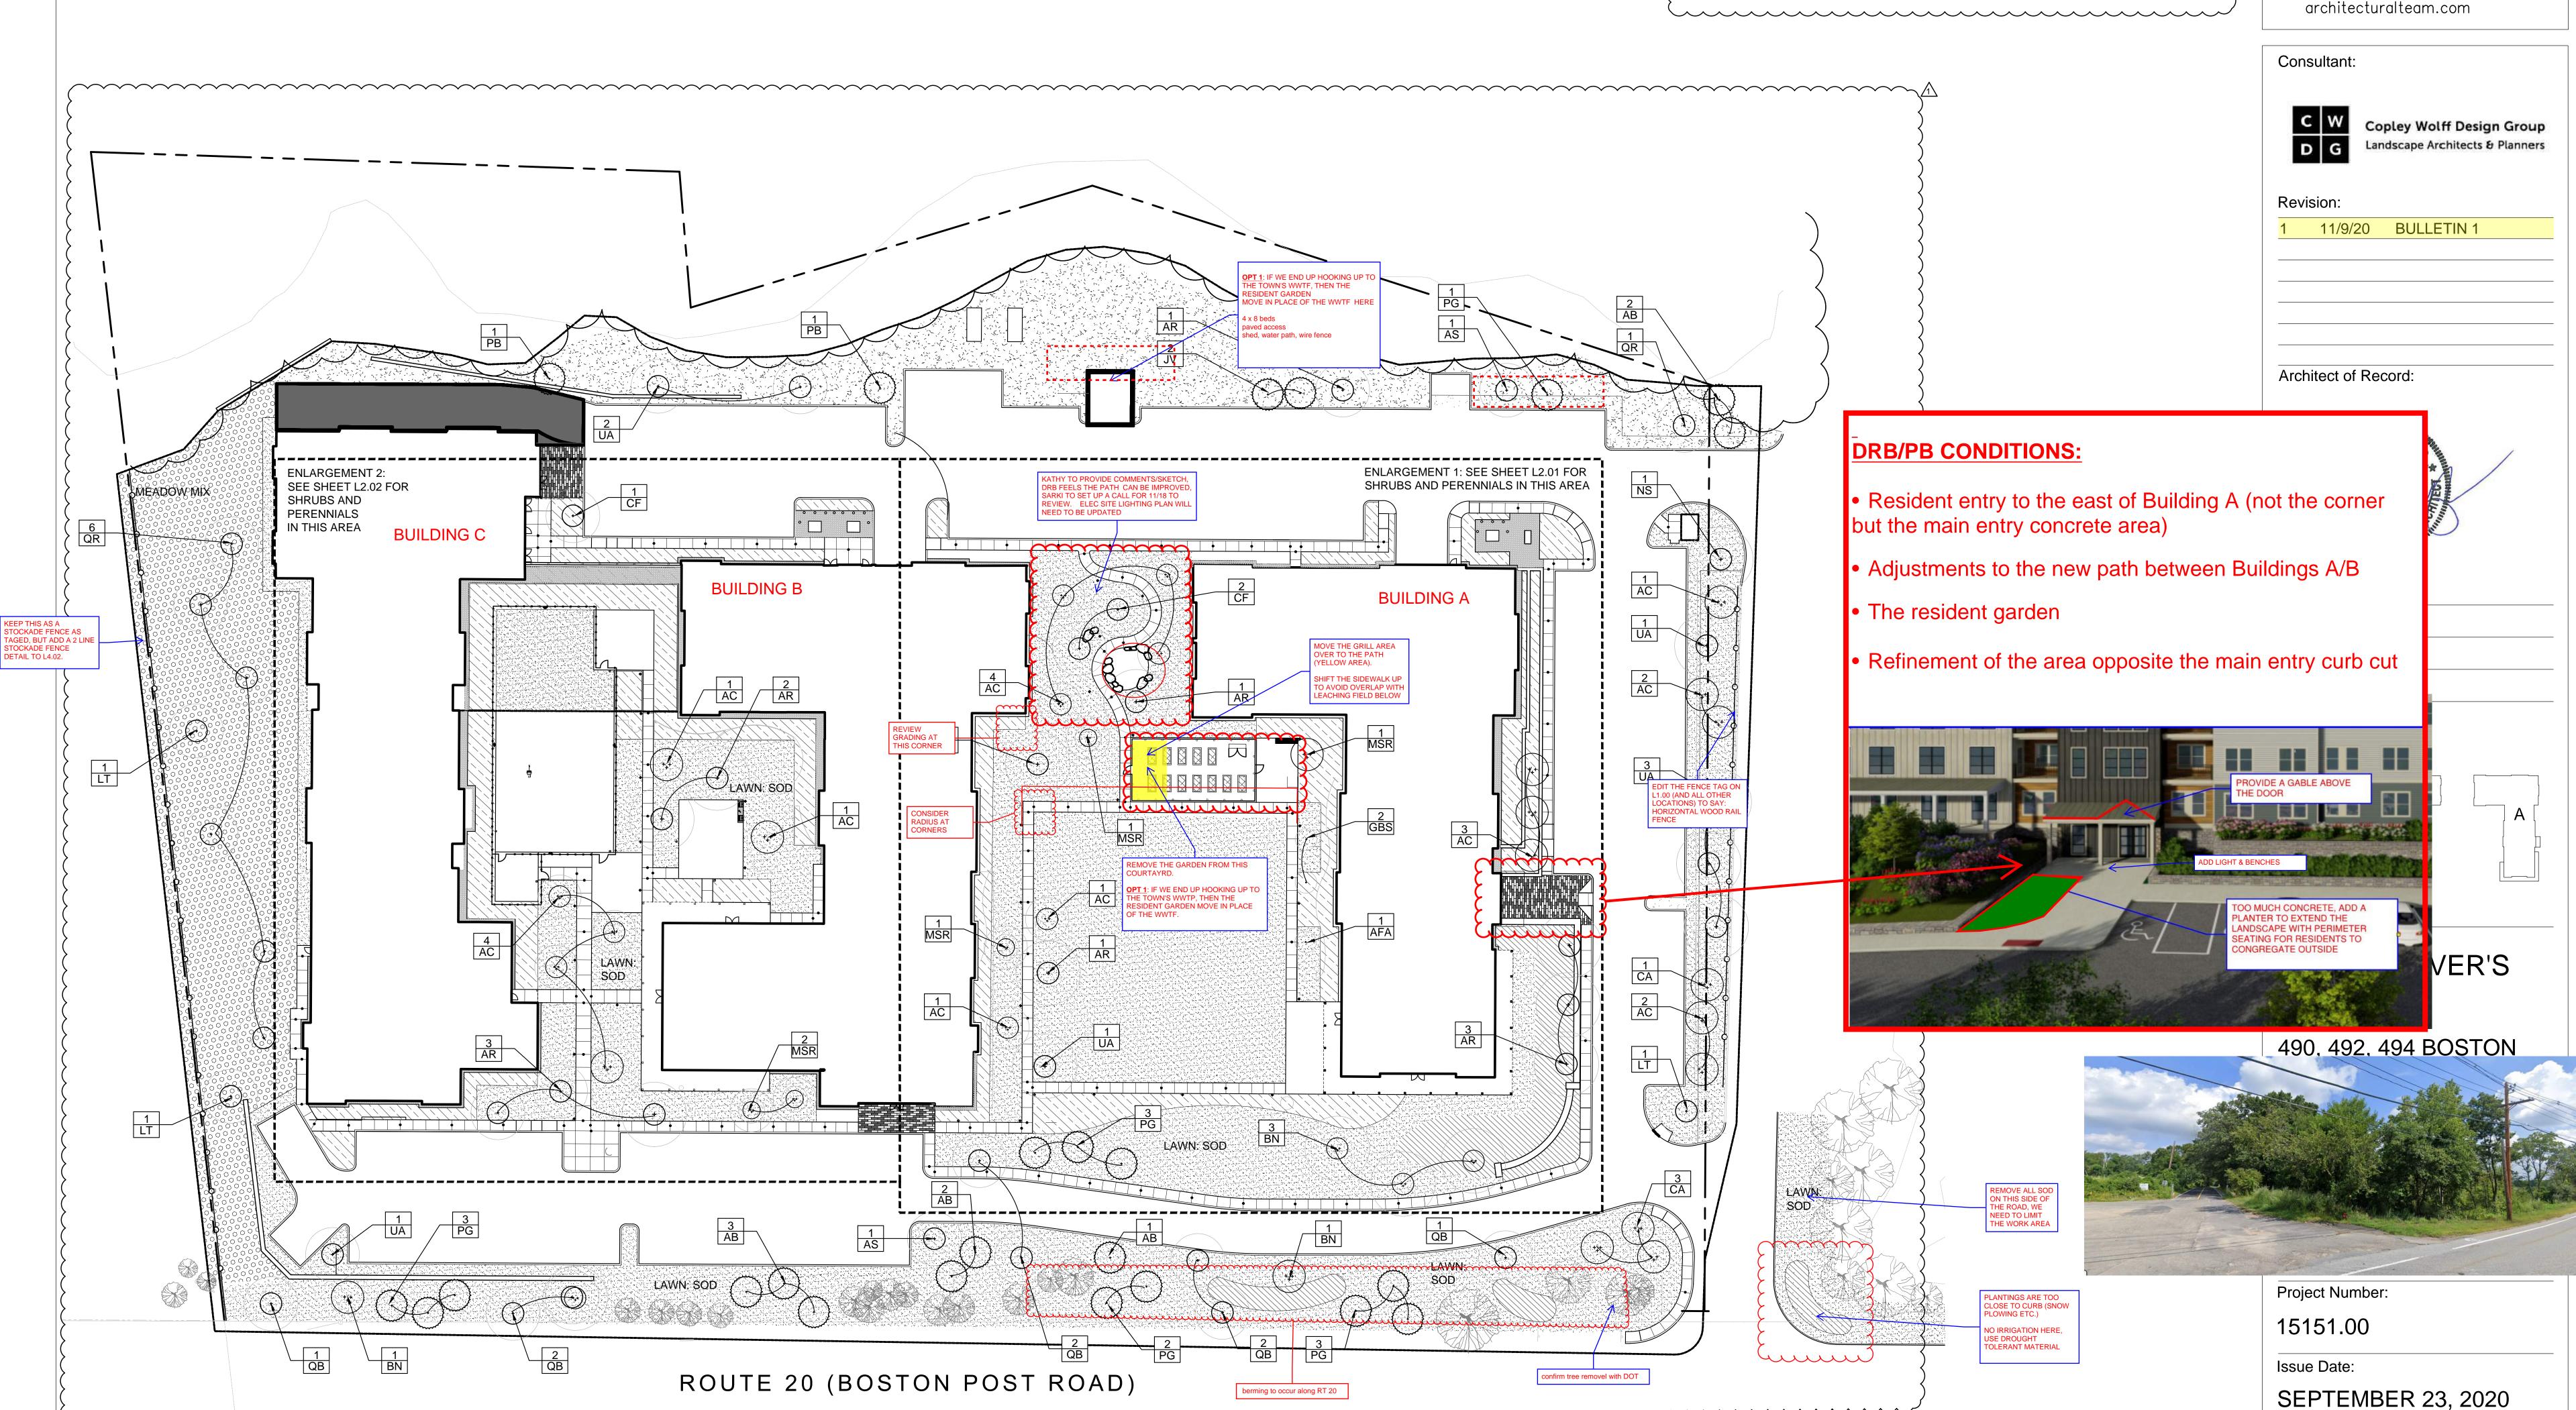

PLANT LIST: ENLARGEMENT 1

Symbol	Qty	Botanical Name	Common Name	Size	Spacing	Comments	MBOT Spre
hrubs an	d Grou	ndcover	_				
CAH	9	Clethra alnifolia 'Hummingbird'	Hummingbird Sweet Pepperbush	24-30" ht.			3-5'
СР	33	Comptonia peregrina	Sweet Fern	24-36" ht.	36" O.C.		4-8'
CAS	37	Cornus sericea 'Farrow' Arctic Fire	Dwarf Red Twig Dogwood	24-36" ht.	42" O.C.		3-4'
CSF	10	Cornus sericea 'Flaviramea'	Yellow Twig Dogwood	36-42" ht.			5-6'
FGM	35	Fothergilla gardenii 'Mount Airy'	Mount Airy Dwarf Fothergilla 24-36" ht. 36" O.C.			3-5'	
HPL	11	Hydrangea paniculata 'Little Lime'	Little Lime Panicle Hydrangea	24-30" ht.	42" O.C.		3-5'
HQA	4	Hydrangea quercifolia 'Alice'	Alice Oakleaf Hydrangea	24-36" ht.	5' O.C.		5-8'
HQS	12	Hydrangea quercifolia 'Snow Queen'	Snow Queen Oakleaf Hydrangea	30-42" ht.	5' O.C.		6-8'
HQP	10	Hydrangea quercifolia 'Pee Wee'	Dwarf Oakleaf Hydrangea	18-24" ht.	36" O.C.		2.5-3'
IGS	29	llex glabra 'Shamrock'	Dwarf Inkberry	24-36" ht.	42" O.C.		3-4'
IVH	27	Itea virginiana 'Sprich' Little Henry	Little Henry Virginia Sweetspire	18-24" ht.	36" O.C.		2-2.5'
IVR	52	Ilex verticillata 'Nana' Red Sprite	Red Sprite Winterberry	24-32" ht.	36" O.C.		2.5-3'
JPS	6	Juniperus x pfitzeriana 'Sea Green'	Sea Green Chinese Juniper	30-42" ht.	6' O.C.		6-8'
MP	4	Myrica pensylvanica	Northern Bayberry	36-48" ht.	6' O.C.		5-10'
RAG	85	Rhus aromatica 'Gro Low'	Grow Low Fragrant Sumac	18-24" ht.	36" O.C.		6-8'
RDV	24	Rhododendron 'Delaware Valley White'	Delaware Valley White Azalea	18-24" ht.	36" O.C.		3-4'
RPD	37	Rhododendron 'Pink Discovery'	Pink Discovery Azalea	18-24" ht.	36" O.C.		3-4'
RMA	3	Rhododendron maximum	Rosebay Rhododendron	36-48" ht.	As shown		5-12'
TCA	10	Taxus canadensis	Canada Yew	30-42" ht.			25-35'
VAC	1	Viburnum acerifolium	Maple Leaf Viburnum	24-36" ht.	36" O.C.		2-4'
VDA	3	Viburnum dentatum 'Autumn Jazz'	Autumn Jazz Arrowwood	36-48" ht.			8-12'
erennials	/ Orna	mental Grasses / Groundcover	•				
ALM	36	Alchemilla molis	Lady's Mantle	#1 Cont.	18" O.C.		1.5'-2.5'
AUM	27	Arctostaphylos uva-ursi 'Massachusetts'	Common Bearberry	#1 Cont.	24" O.C.		3'-6'
ADE	27	Astilbe chinensis 'Deutschland'	Deutschland Astibe	#1 Cont.	18" O.C.		
AVP	28	Astilbe 'Visions in Pink'	Visions in Pink Astilbe	#1 Cont.	18" O.C.		
AVR	27	Astilbe 'Visions in Red'	Visions in Red Astilbe	#1 Cont.	18" O.C.		
CKF	82	Calamagrostis x acutiflora 'Karl Foerster'	Karl Foerster Grass	#2 Cont.	18" O.C.		2-3'
DP	242	Dennstaedtia punctilobula	Hay-Scented Fern	#1 Cont.	18" O.C.		2-3'
DC DC	277	Deschampsia cespitosa	Tufted Hair Grass	9-12" ht.	18" O.C.		1-2'
EPK	46	Echinacea purpurea 'Kim's Knee High'	 	#1 Cont.	18" O.C.		1-2'
GO	76	Galium odoratum	Sweet Woodruff	#1 Cont.	12" O.C.		9"-1.5"
GBV	35	Gernanium macrorrhiz um 'Bevan's Variety'	Bigroot Geranium	#1 Cont.	12 0.0.		9"-1.5"
LS	333	Liriope spicata	Creeping Liriope	Plug	9" O.C.		1-2'
LSB	37	Leucanthemum x superbum 'Becky'	Becky Shasta Daisy	#1 Cont.	24" O.C.		
MSM	90	Miscanthus sinensis 'Morning Light'	Morning Light Miscanthus	#1 Cont.	36" O.C.		2.5-4'
NWL	46	Nepeta x faassenii 'Walkers Low'	Walkers Low Catmint	#1 Cont.	24" O.C.		2.5-7
OC	217	Osmundastrum cinnamomeum	Cinnamon Fern	#1 Cont.	24" O.C.		2-3'
PPF	198	Panicum 'Prairie Fire'	Prairie Fire Switch Grass	#1 Cont.	18" O.C.		1.5-2'
PVS	140	Panicum Prame Fire Panicum virgatum 'Squaw'	Squaw Switch Grass	#2 Cont.	18" O.C.		1.5-2'
1. 19		-	<u> </u>	+			2-4'
פסס	31	Perovskia atriplicifolia	Russian Sage	#1 Cont.	24" O.C.		
PRS		Schizachyrum Scoparium	Little Bluestem	#2 Cont.	12" O.C.		1.5-2'
ss	454	011	D-4	440 .			14 5 01
	39 361	Stachys officinalis 'Hummelo' Vinca minor	Betony Periwinkle	#1 Cont. #1 Cont.	18" O.C.		1.5-2'

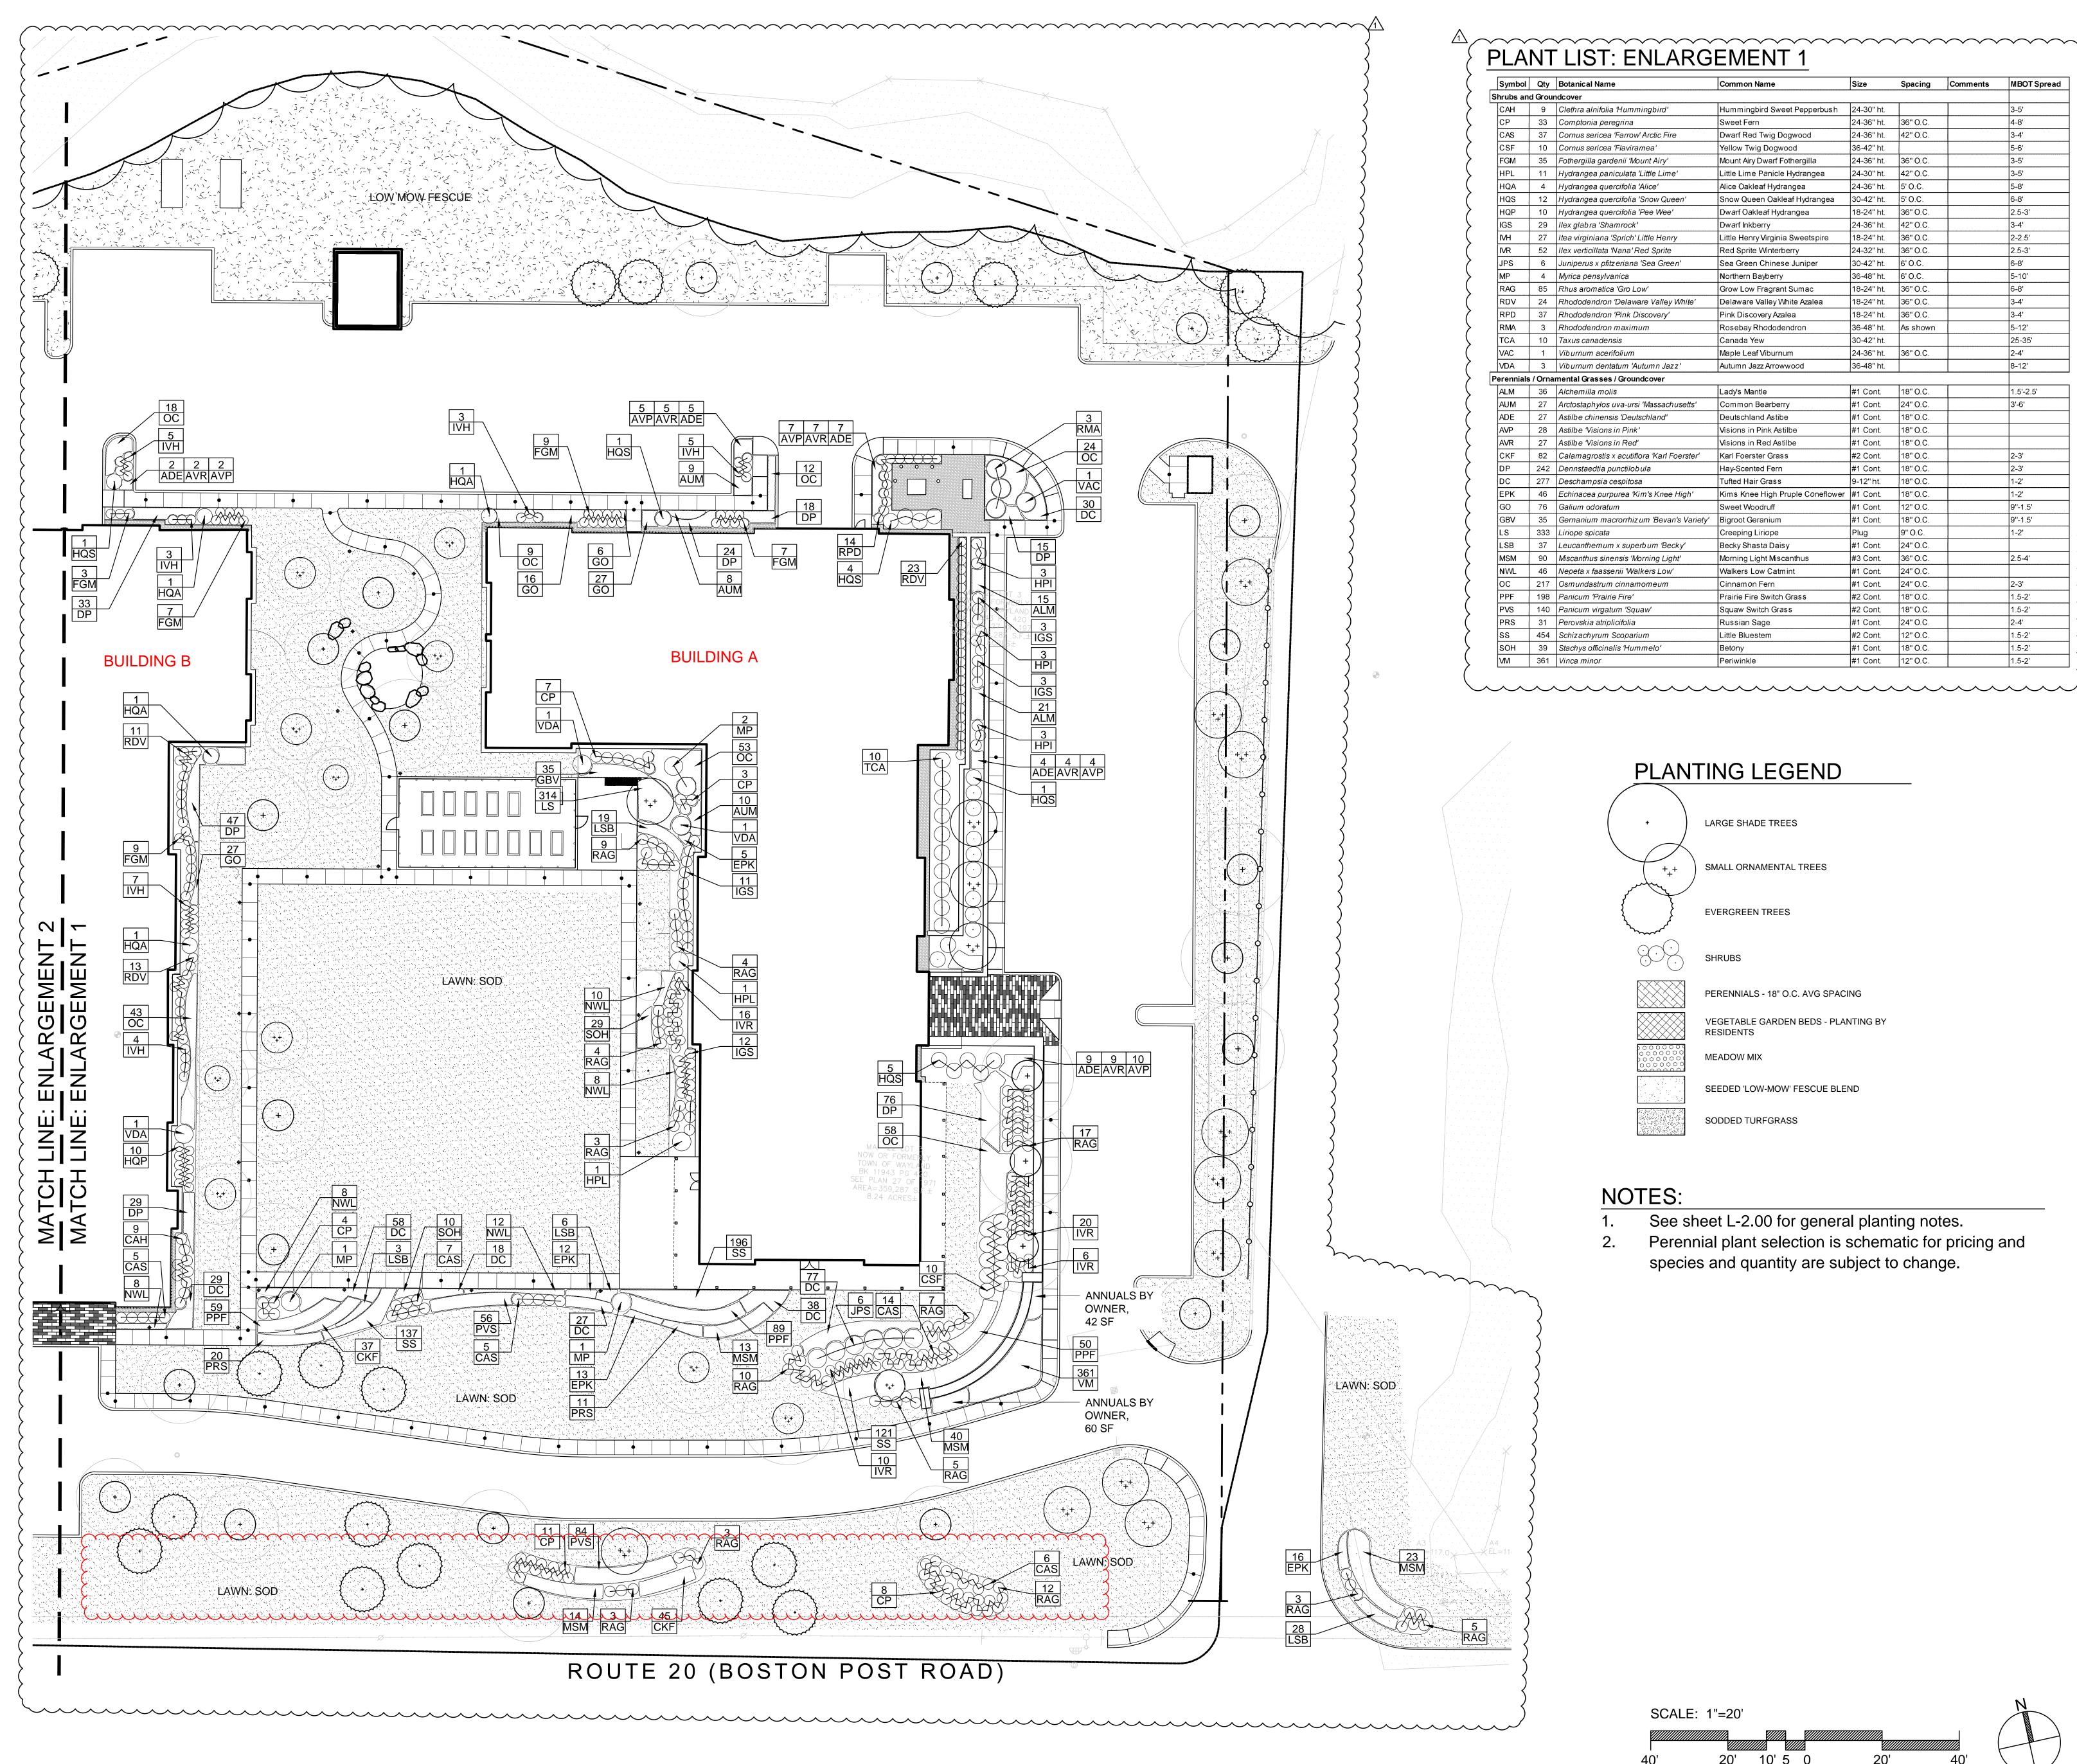PLANTING LEGEND



NOTES:

SCALE: 1"=20'

- See sheet L-2.00 for general planting notes.
- Perennial plant selection is schematic for pricing and species and quantity are subject to change.

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Consultant:



Copley Wolff Design Group Landscape Architects & Planners

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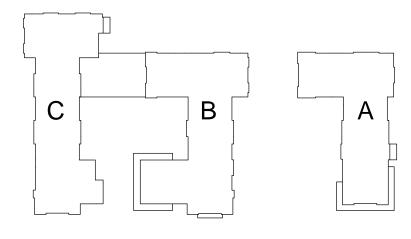
Architect of Record:



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Scale: 1" = 20'-0"

Key Plan:



Project Name:

ALTA AT RIVER'S **EDGE**

490, 492, 494 BOSTON POST RD WAYLAND, MA 01778

Sheet Name:

Planting Plan: Enlargement 1

Project Number:

15151.00


Issue Date:

SEPTEMBER 23, 2020

Sheet Number:

L 2.01

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PLANT LIST: ENLARGEMENT 2

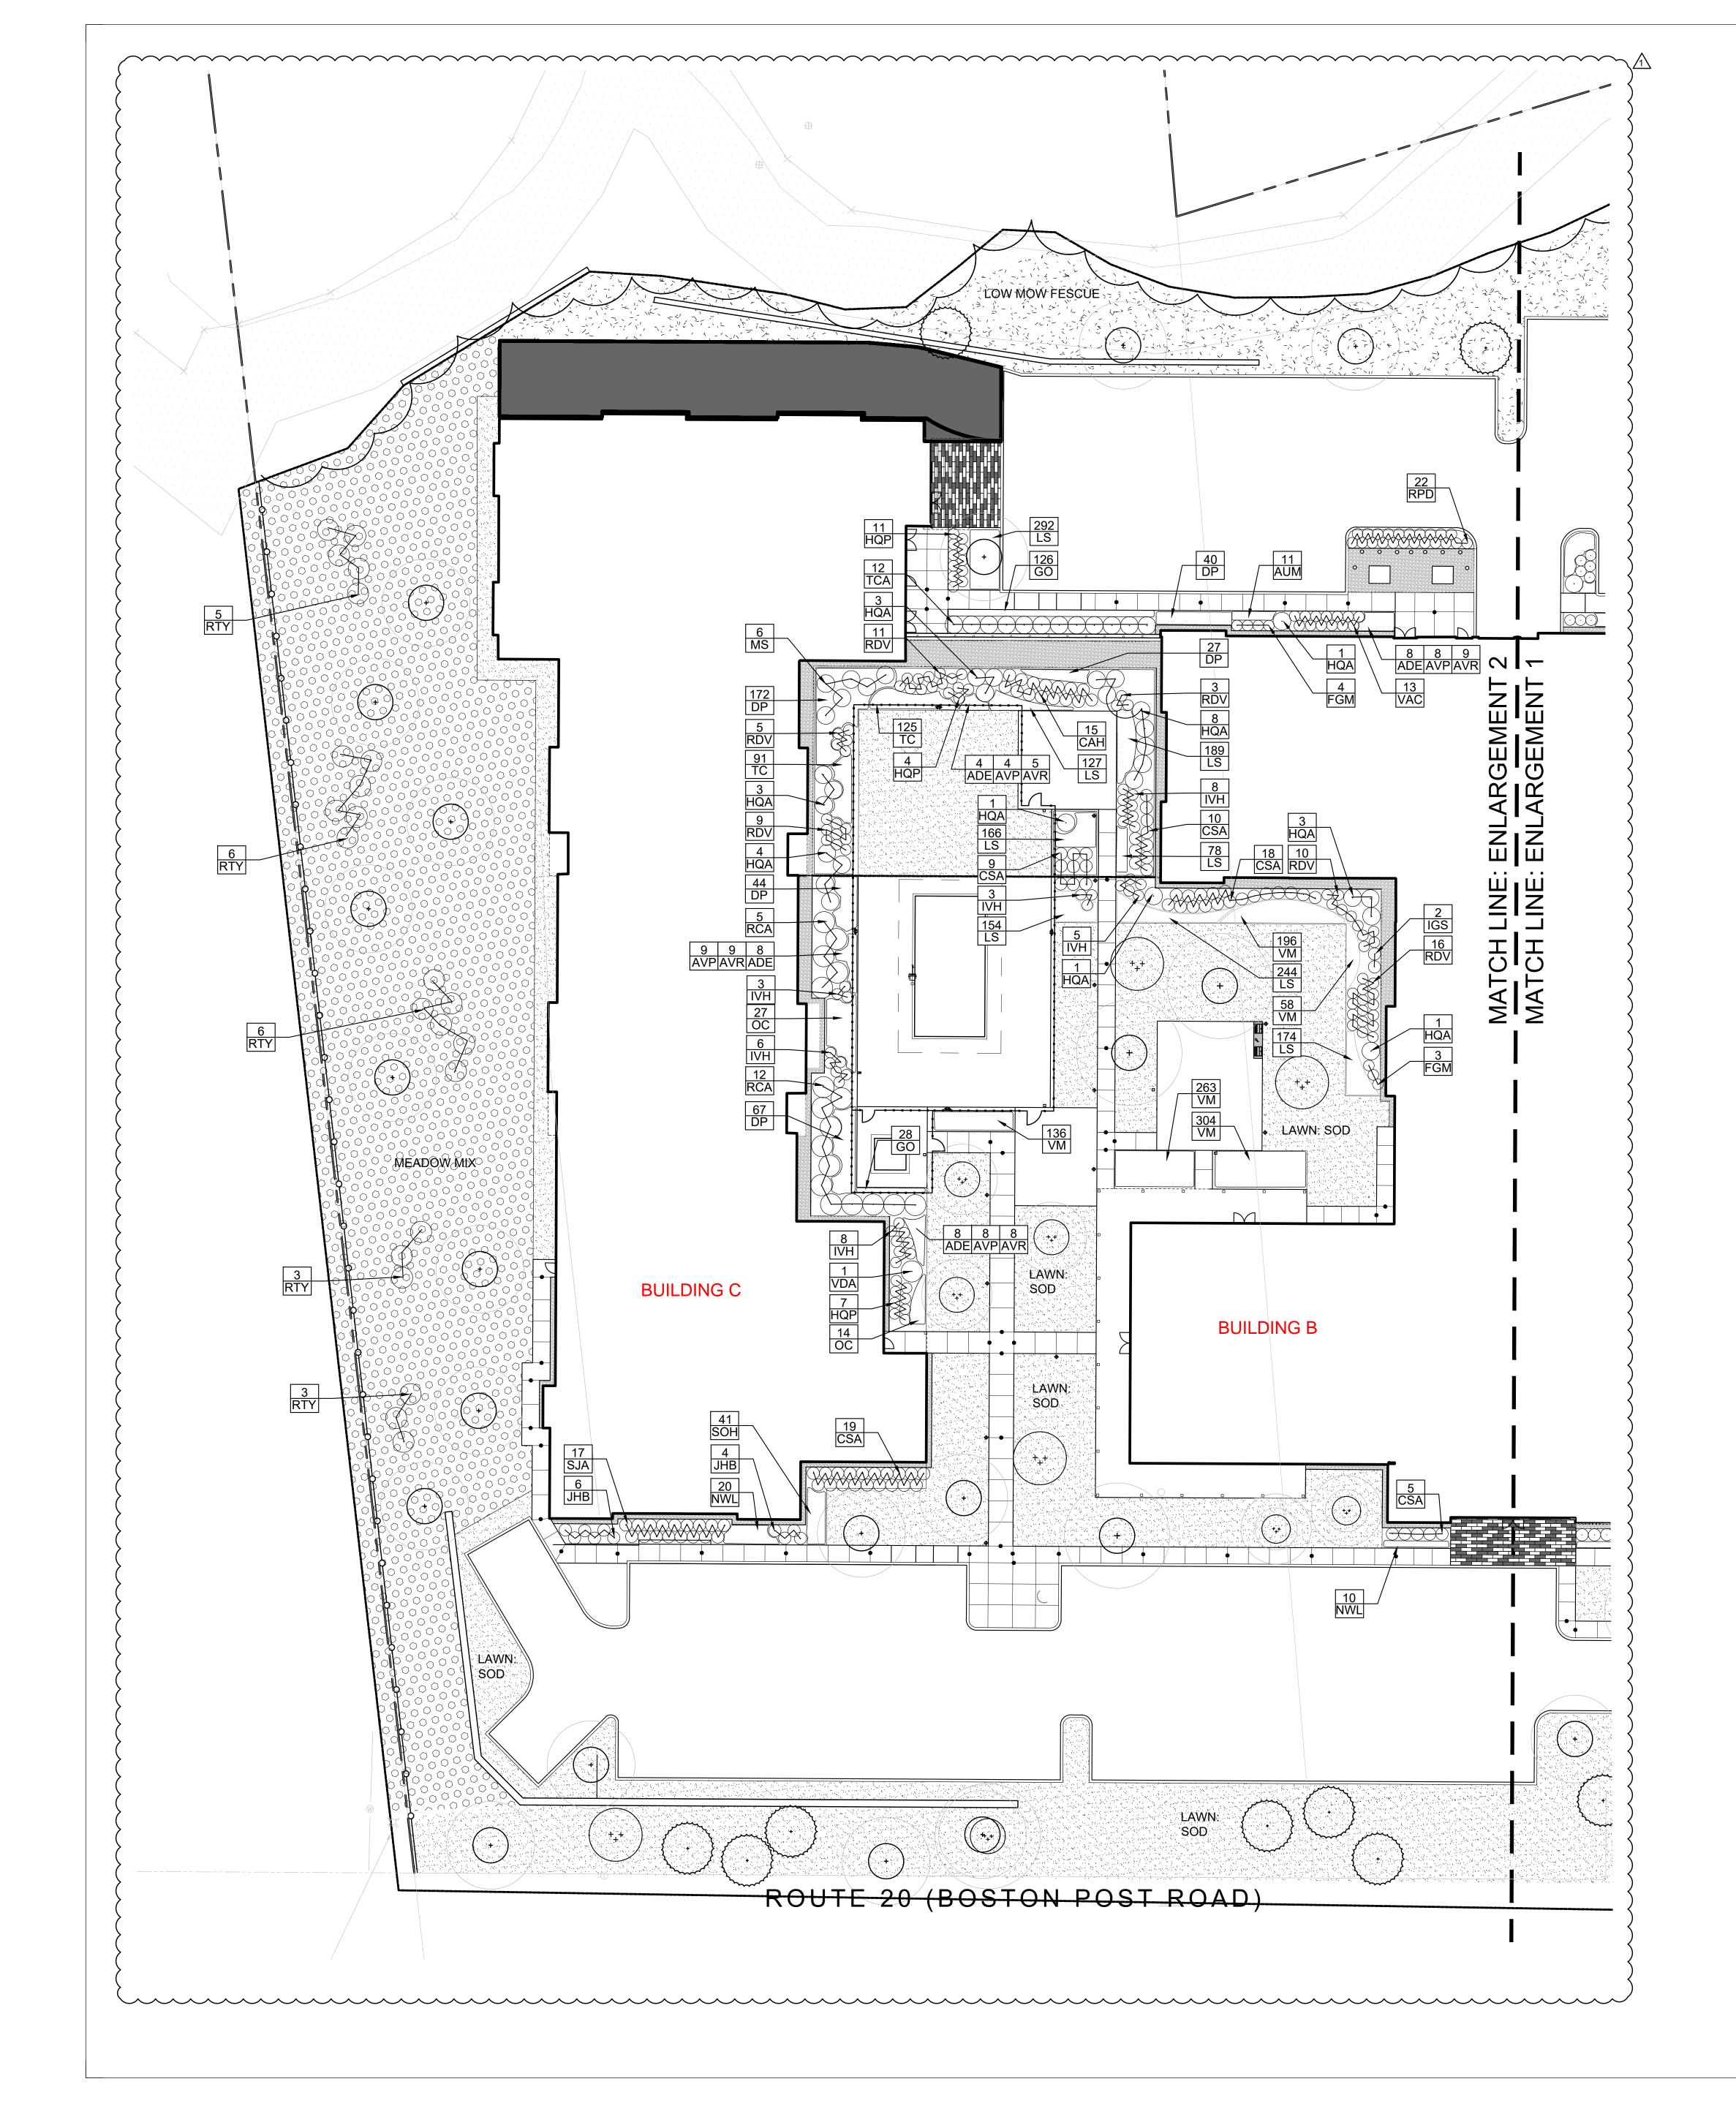Symbol	Qty	Botanical Name	Common Name	Size	MBOT Spread	Root Size	Comn
hrubs an	d Grour	ndcover					
CAH	15	Clethra alnifolia 'Hummingbird'	Hummingbird Sweet Pepperbush	24-30" ht.			3-5'
CSA	61	Cornus sericea 'Farrow' Arctic Fire	Dwarf Red Twig Dogwood	24-36" ht.	42" O.C.		3-4'
FGM	7	Fothergilla gardenii 'Mount Airy'	Mount Airy Dwarf Fothergilla	24-36" ht.	36" O.C.		3-5'
HQA	25	Hydrangea quercifolia 'Alice'	Alice Oakleaf Hydrangea	24-36" ht.	5' O.C.		5-8'
HQP	22	Hydrangea quercifolia 'Pee Wee'	Dwarf Oakleaf Hydrangea	18-24" ht.	36" O.C.		2.5-3'
IGS	2	Ilex glabra 'Shamrock'	Dwarf Inkberry	24-36" ht.	42" O.C.		3-4'
IVH	33	Itea virginiana 'Sprich' Little Henry	Little Henry Virginia Sweetspire	18-24" ht.	36" O.C.		2-2.5'
JHB	10	Juniperus horizontalis 'Bar Harbor'	Bar Harbor Creeping Juniper	24-36" spd.	36" O.C.		5-6'
MP	6	Myrica pensylvanica	Northern Bayberry	36-48" ht.	6' O.C.		5-10'
RDV	54	Rhododendron 'Delaware Valley White'	Delaware Valley White Azalea	18-24" ht.	36" O.C.		3-4'
RPD	22	Rhododendron 'Pink Discovery'	Pink Discovery Azalea	18-24" ht.	36" O.C.		3-4'
RCA	17	Rhododendron catawbinse 'Album'	Catawaba Rhododendron	18-24" ht.	5' O.C.		5-6'
RTY	23	Rhus typhina	Staghorn Sumac	42-52" ht.	As shown		20-30
TCA	12	Taxus canadensis	Canada Yew	30-42" ht.			25-35
VAC	13	Viburnum acerifolium	Maple Leaf Viburnum	24-36" ht.	36" O.C.		2-4'
VDA	1	Viburnum dentatum 'Autumn Jazz'	Autumn Jazz Arrowwood	36-48" ht.			8-12'
	/ Orna	mental Grasses / Vines			T		1
AUM	11	Arctostaphylos uva-ursi 'Massachusetts'	Common Bearberry	#1 Cont.	24" O.C.		3'-6'
ADE	28	Astilbe chinensis 'Deutschland'	Deutschland Astibe	#1 Cont.	18" O.C.		
AVP	29	Astilbe 'Visions in Pink'	Visions in Pink Astilbe	#1 Cont.	18" O.C.		
AVR	31	Astilbe 'Visions in Red'	Visions in Red Astilbe	#1 Cont.	18" O.C.		
DP	350	Dennstaedtia punctilobula	Hay-Scented Fern	#1 Cont.	18" O.C.		2-3'
GO	154	Galium odoratum	Sweet Woodruff	#1 Cont.	12" O.C.		9"-1.5
LS	1424	Liriope spicata	Creeping Liriope	Plug	9" O.C.		1-2'
NWL	30	Nepeta x faassenii 'Walkers Low'	Walkers Low Catmint	#1 Cont.	24" O.C.		
ОС	41	Osmundastrum cinnamomeum	Cinnamon Fern	#1 Cont.	24" O.C.		2-3'
SOH	41	Stachys officinalis 'Hummelo'	Betony	#1 Cont.	18" O.C.		1.5-2'
TC	216	Tilarella cordifolia	Foamflower	#1 Cont.	12" O.C.		1.5-2'
VM	957	Vinca minor	Periwinkle	#1 Cont.	12" O.C.		1.5-2'

LARGE SHADE TREES SMALL ORNAMENTAL TREES EVERGREEN TREES SHRUBS PERENNIALS - 18" O.C. AVG SPACING VEGETABLE GARDEN BEDS - PLANTING BY RESIDENTS MEADOW MIX SEEDED 'LOW-MOW' FESCUE BLEND SODDED TURFGRASS

NOTES:

1. See sheet L-2.00 for general planting notes.

SCALE: 1"=20'

2. Perennial plant selection is schematic for pricing and species and quantity are subject to change.



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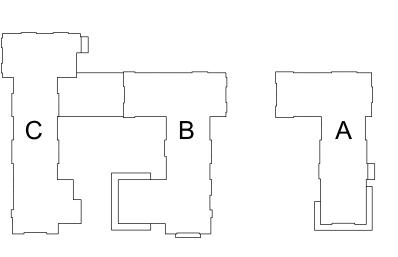
Revision:

1	11/9/20	BULLETIN 1	

Architect of Record:



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Checked:	AA	
Scale:	1" = 20'-0"	



Project Name:

Key Plan:

ALTA AT RIVER'S EDGE

490, 492, 494 BOSTON POST RD WAYLAND, MA 01778

Sheet Name:

Planting Plan: Enlargement 2

Project Number:


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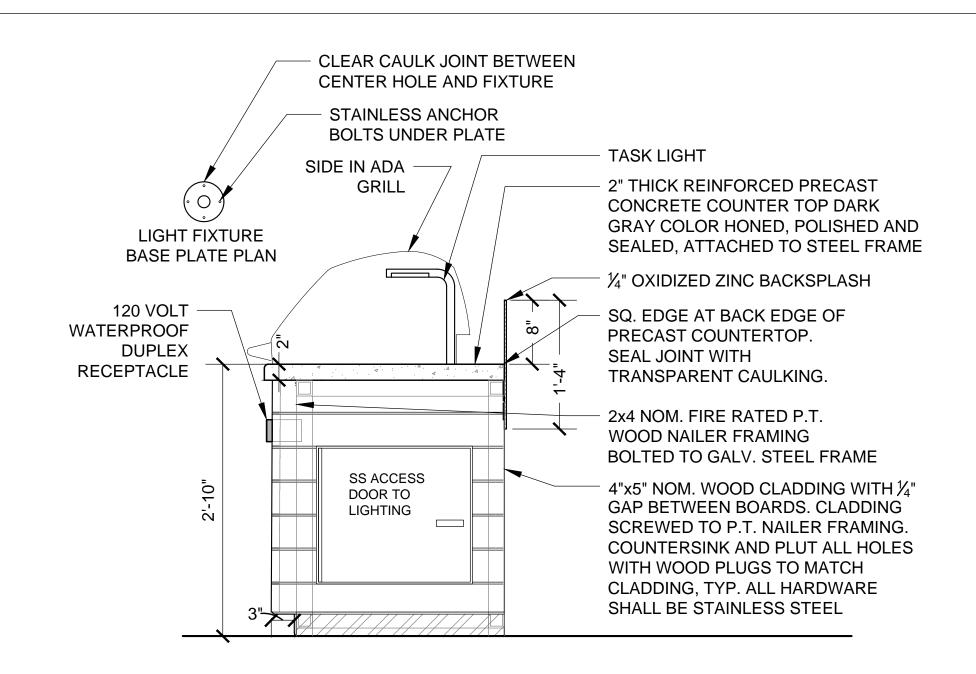
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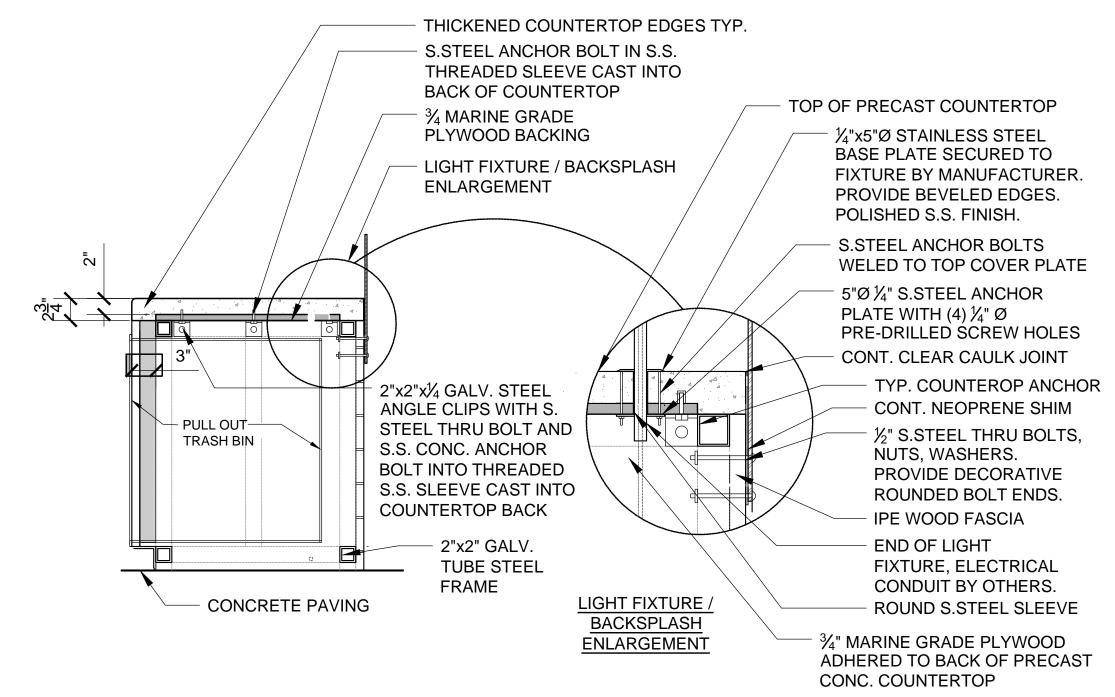
Sheet Number:

L 2.02






GRILLING STATION - SIDE ELEVATION

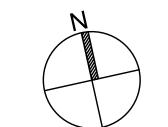


2 GRILLING STATION: SECTION AT TRASH


SCALE: 1" = 1'-0"

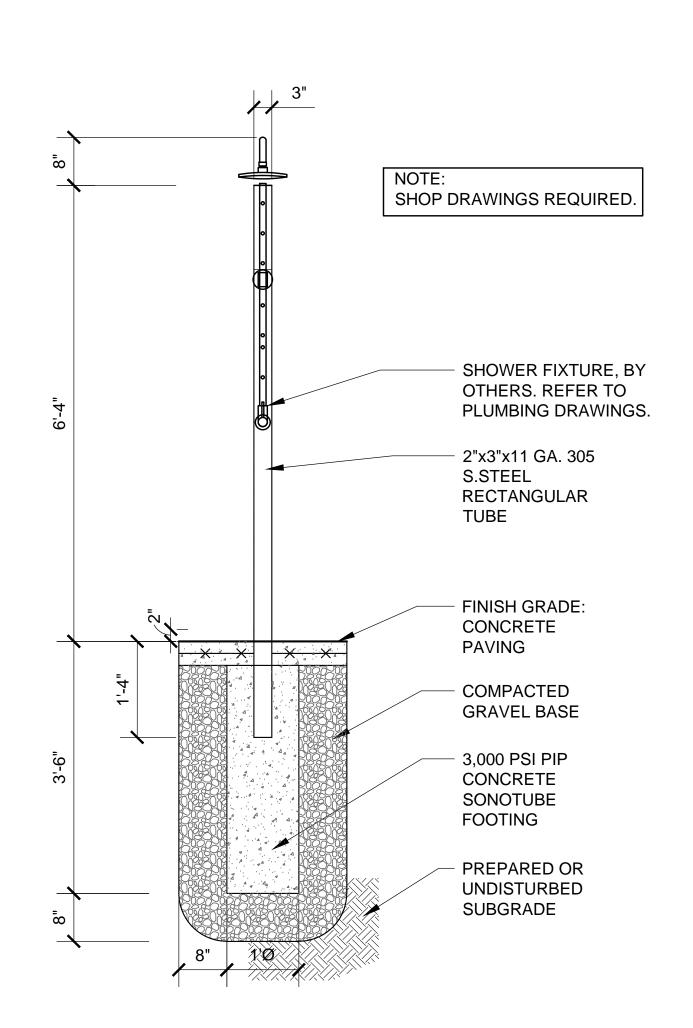

3 SHOWER

SCALE: 3/4" = 1'-0"

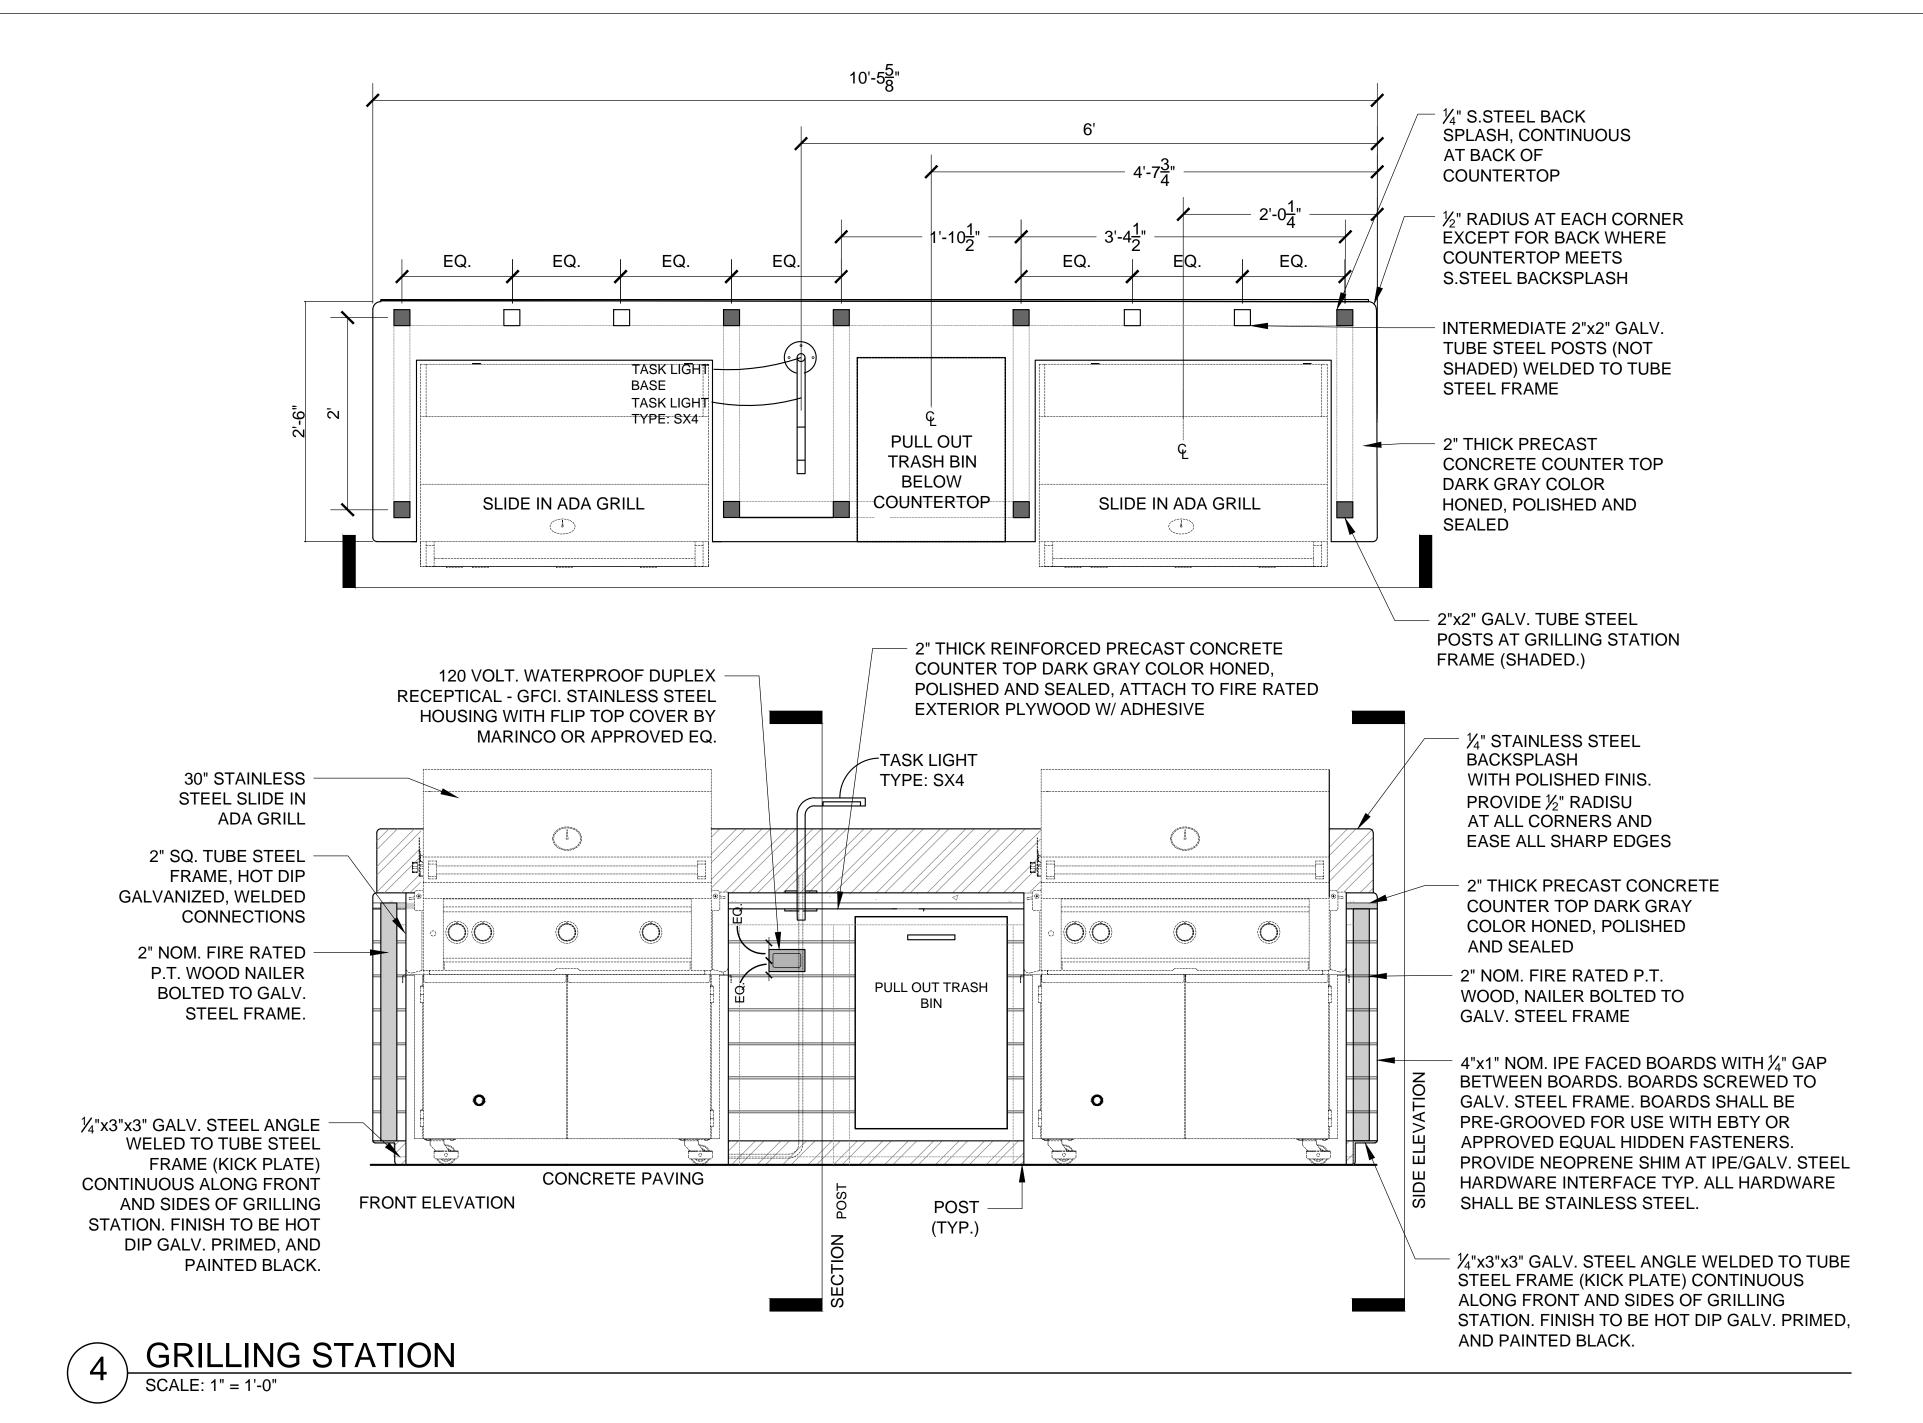

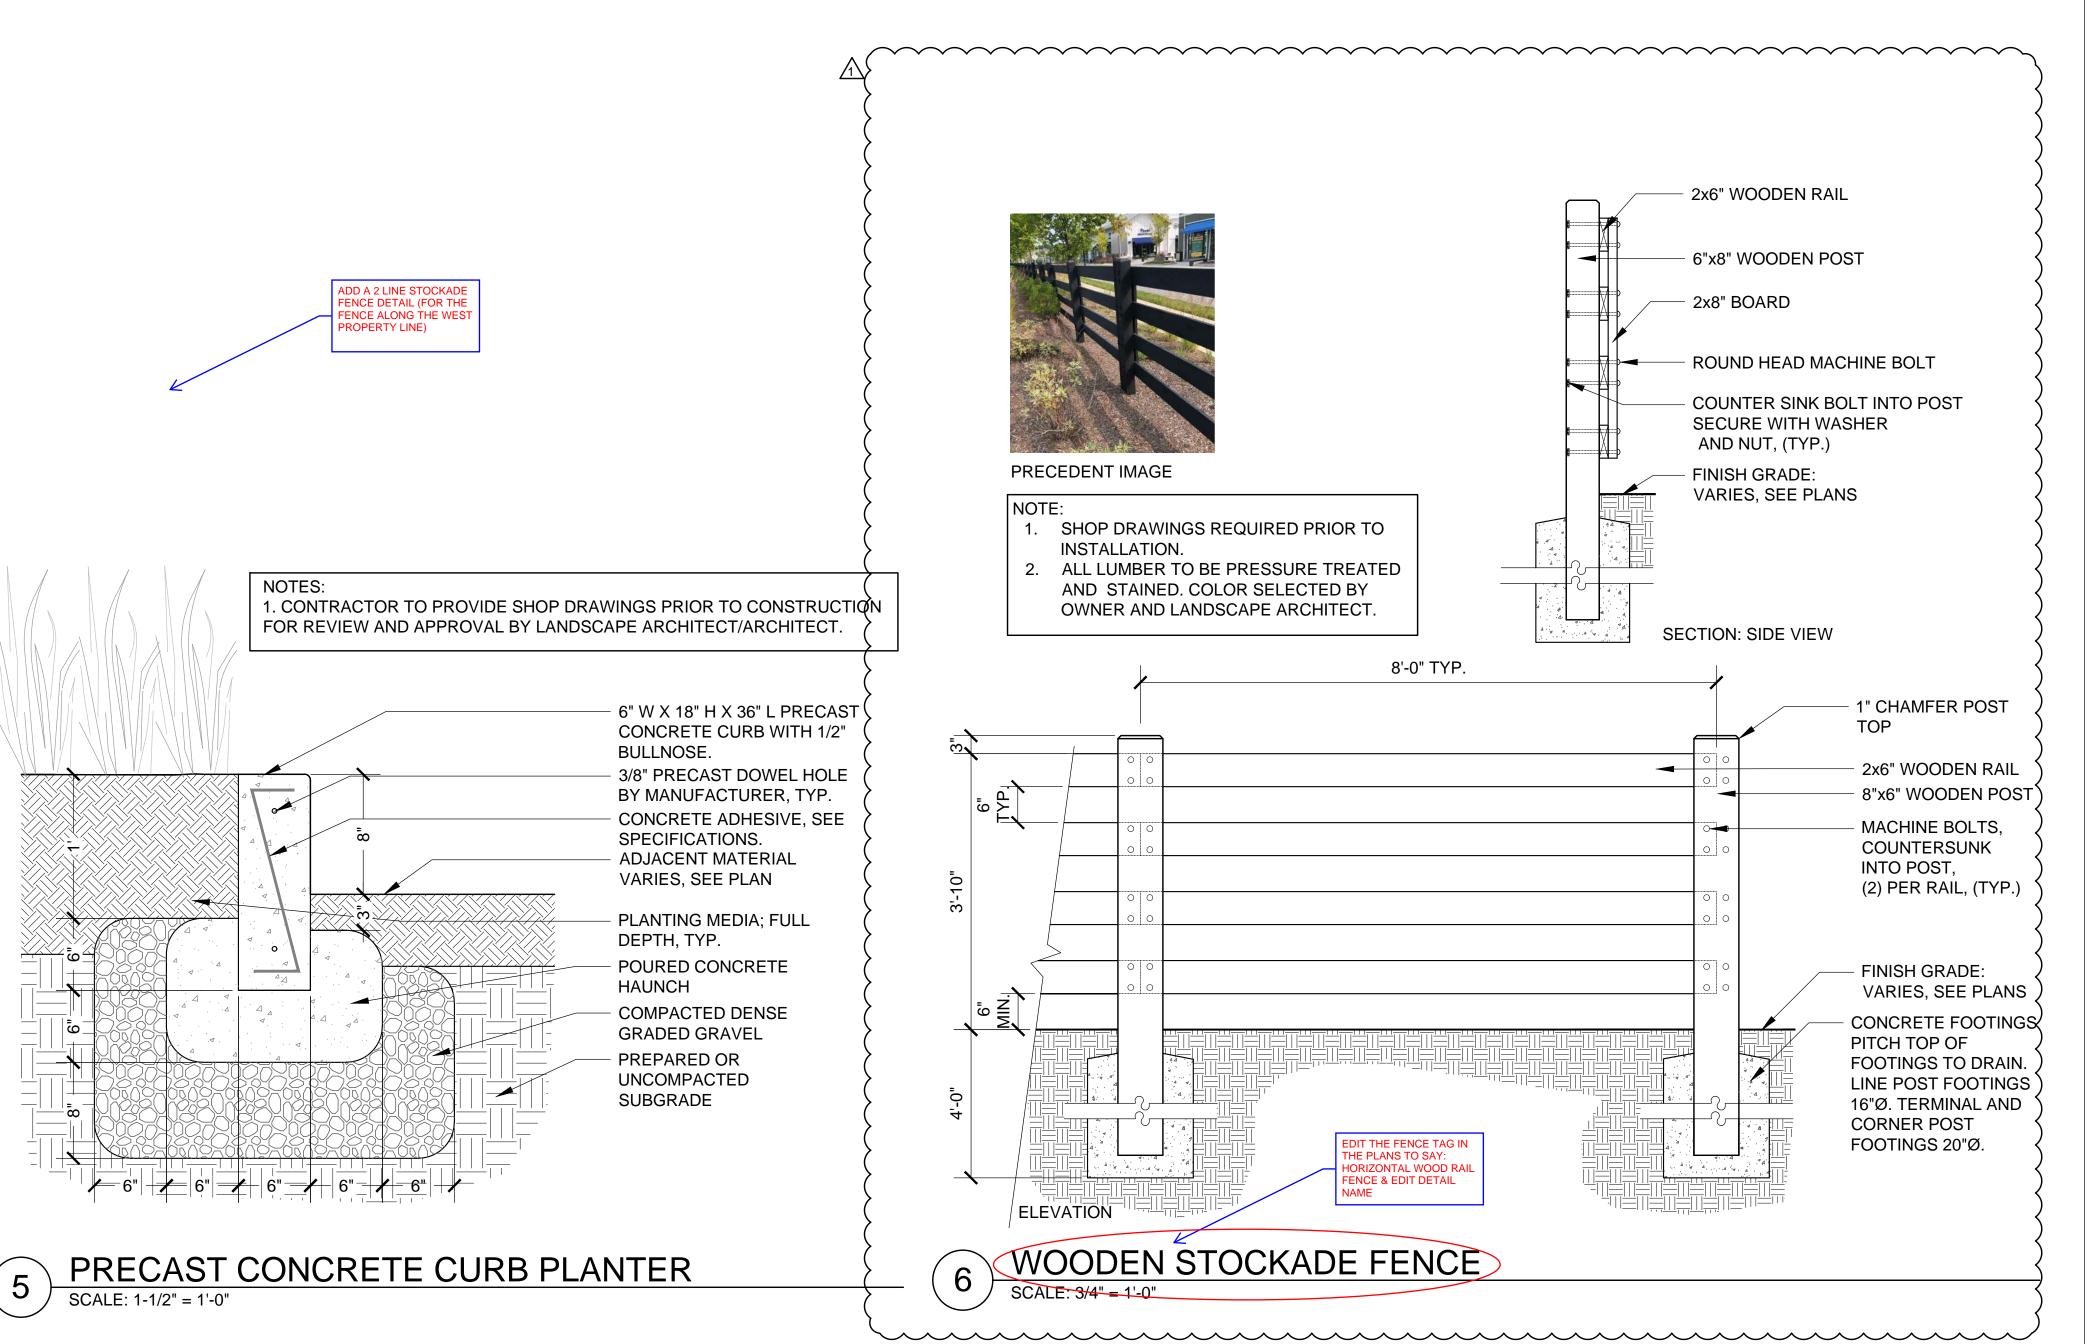

tat

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C	W
7	G

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Revision:

11/09/20	BULLETIN #1	

Architect of Record:



Drawn:	SAS	
Checked:	AA	
Scale:	AS NOTED	
Key Plan:		
C	В	

Project Name:

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Sheet Name:

LANDSCAPE DETAILS

Project Number:


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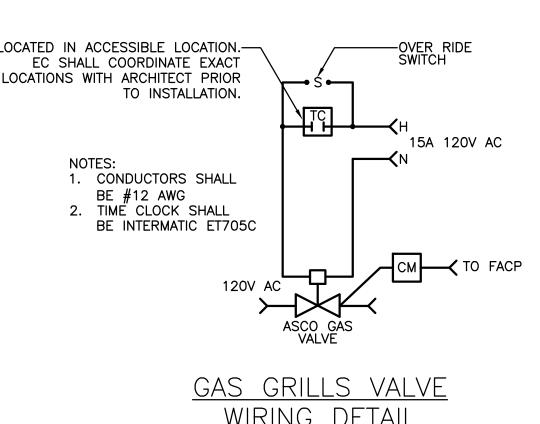
Sheet Number:

L4.02



LIGHTING	LIGHTING SCHEDULE								
TYPE	QTY	PART NUMBER	мн	LUMENS	LLF	DESCRIPTION			
А	2	PCADL-136LED-4K-3	20'	15677	0.950	136W 4000K LED URBAN TYPE 3			
В	9	PCADL-136LED-4K-4	20'	16048	0.950	136W 4000K LED URBAN TYPE 4			
С	5	PCPAL-135LED-4K-4W	20'	15573	0.950	135W 4000K LED VIPER TYPE 4W			
D	4	PCADS-55LED-4K-3	20'	6250	0.950	55W 4000K LED URBAN TYPE 3			
E	31	PCBOR-ASY-4K	3' GRD	941	0.950	31W 4000K ROUND LED BOLLARD ASYMMETRICAL			
F	5	P5635-2030K9	7'	352	0.950	9W LED CORNICE WALL SCONCE			
UL	2	PCOLF-15LED-3K-KM-BZ	GRD	1507	0.950	15W 3000K LED FLOOD LIGHT			

		BUS SHELTER	LIGHTIN	G FIXTURE	SCHEDU	LE	
MOUNTING		FLUORESCENT	INCANDESCENT/HID		EXIT		
	RECESSED	FR		R	XR		
	CEILING/SURFACE	FC		С		XC	
F	PENDANT/SUSPENDED	FP		Р		XP	
	WALL	FW		W		XW	
	TRACK	FT		T			
TYPE	DESCRIPTION	MANUFACTURER & CATALOG NUMBER	NUMBER	TYPE	VOLTS	WATTS	REMARKS
BW1	ONE LIGHT LED SMALL WALL LANTERN	PROGRESS LIGHTING P560136-031-30	-	LED	120	11	EC SHALL CONFIRM EXACT LOCATION AND FINAL SELECTION WITH ARCHITECT PRIOR TO PURCHASE AND INSTALLATION. FIXTURE SHALL BE ON 24/7
BC1	INTERIOR CEILING MOUNTED PUCK LIGHT	LITON LCMPD7R (FINISH) T30	-	LED	120	-	EC SHALL CONFIRM EXACT LOCATION AND FINAL SELECTIO WITH ARCHITECT PRIOR TO PURCHASE AND INSTALLATION. CONTROLLED VIA OCCUPANCY SENSOR

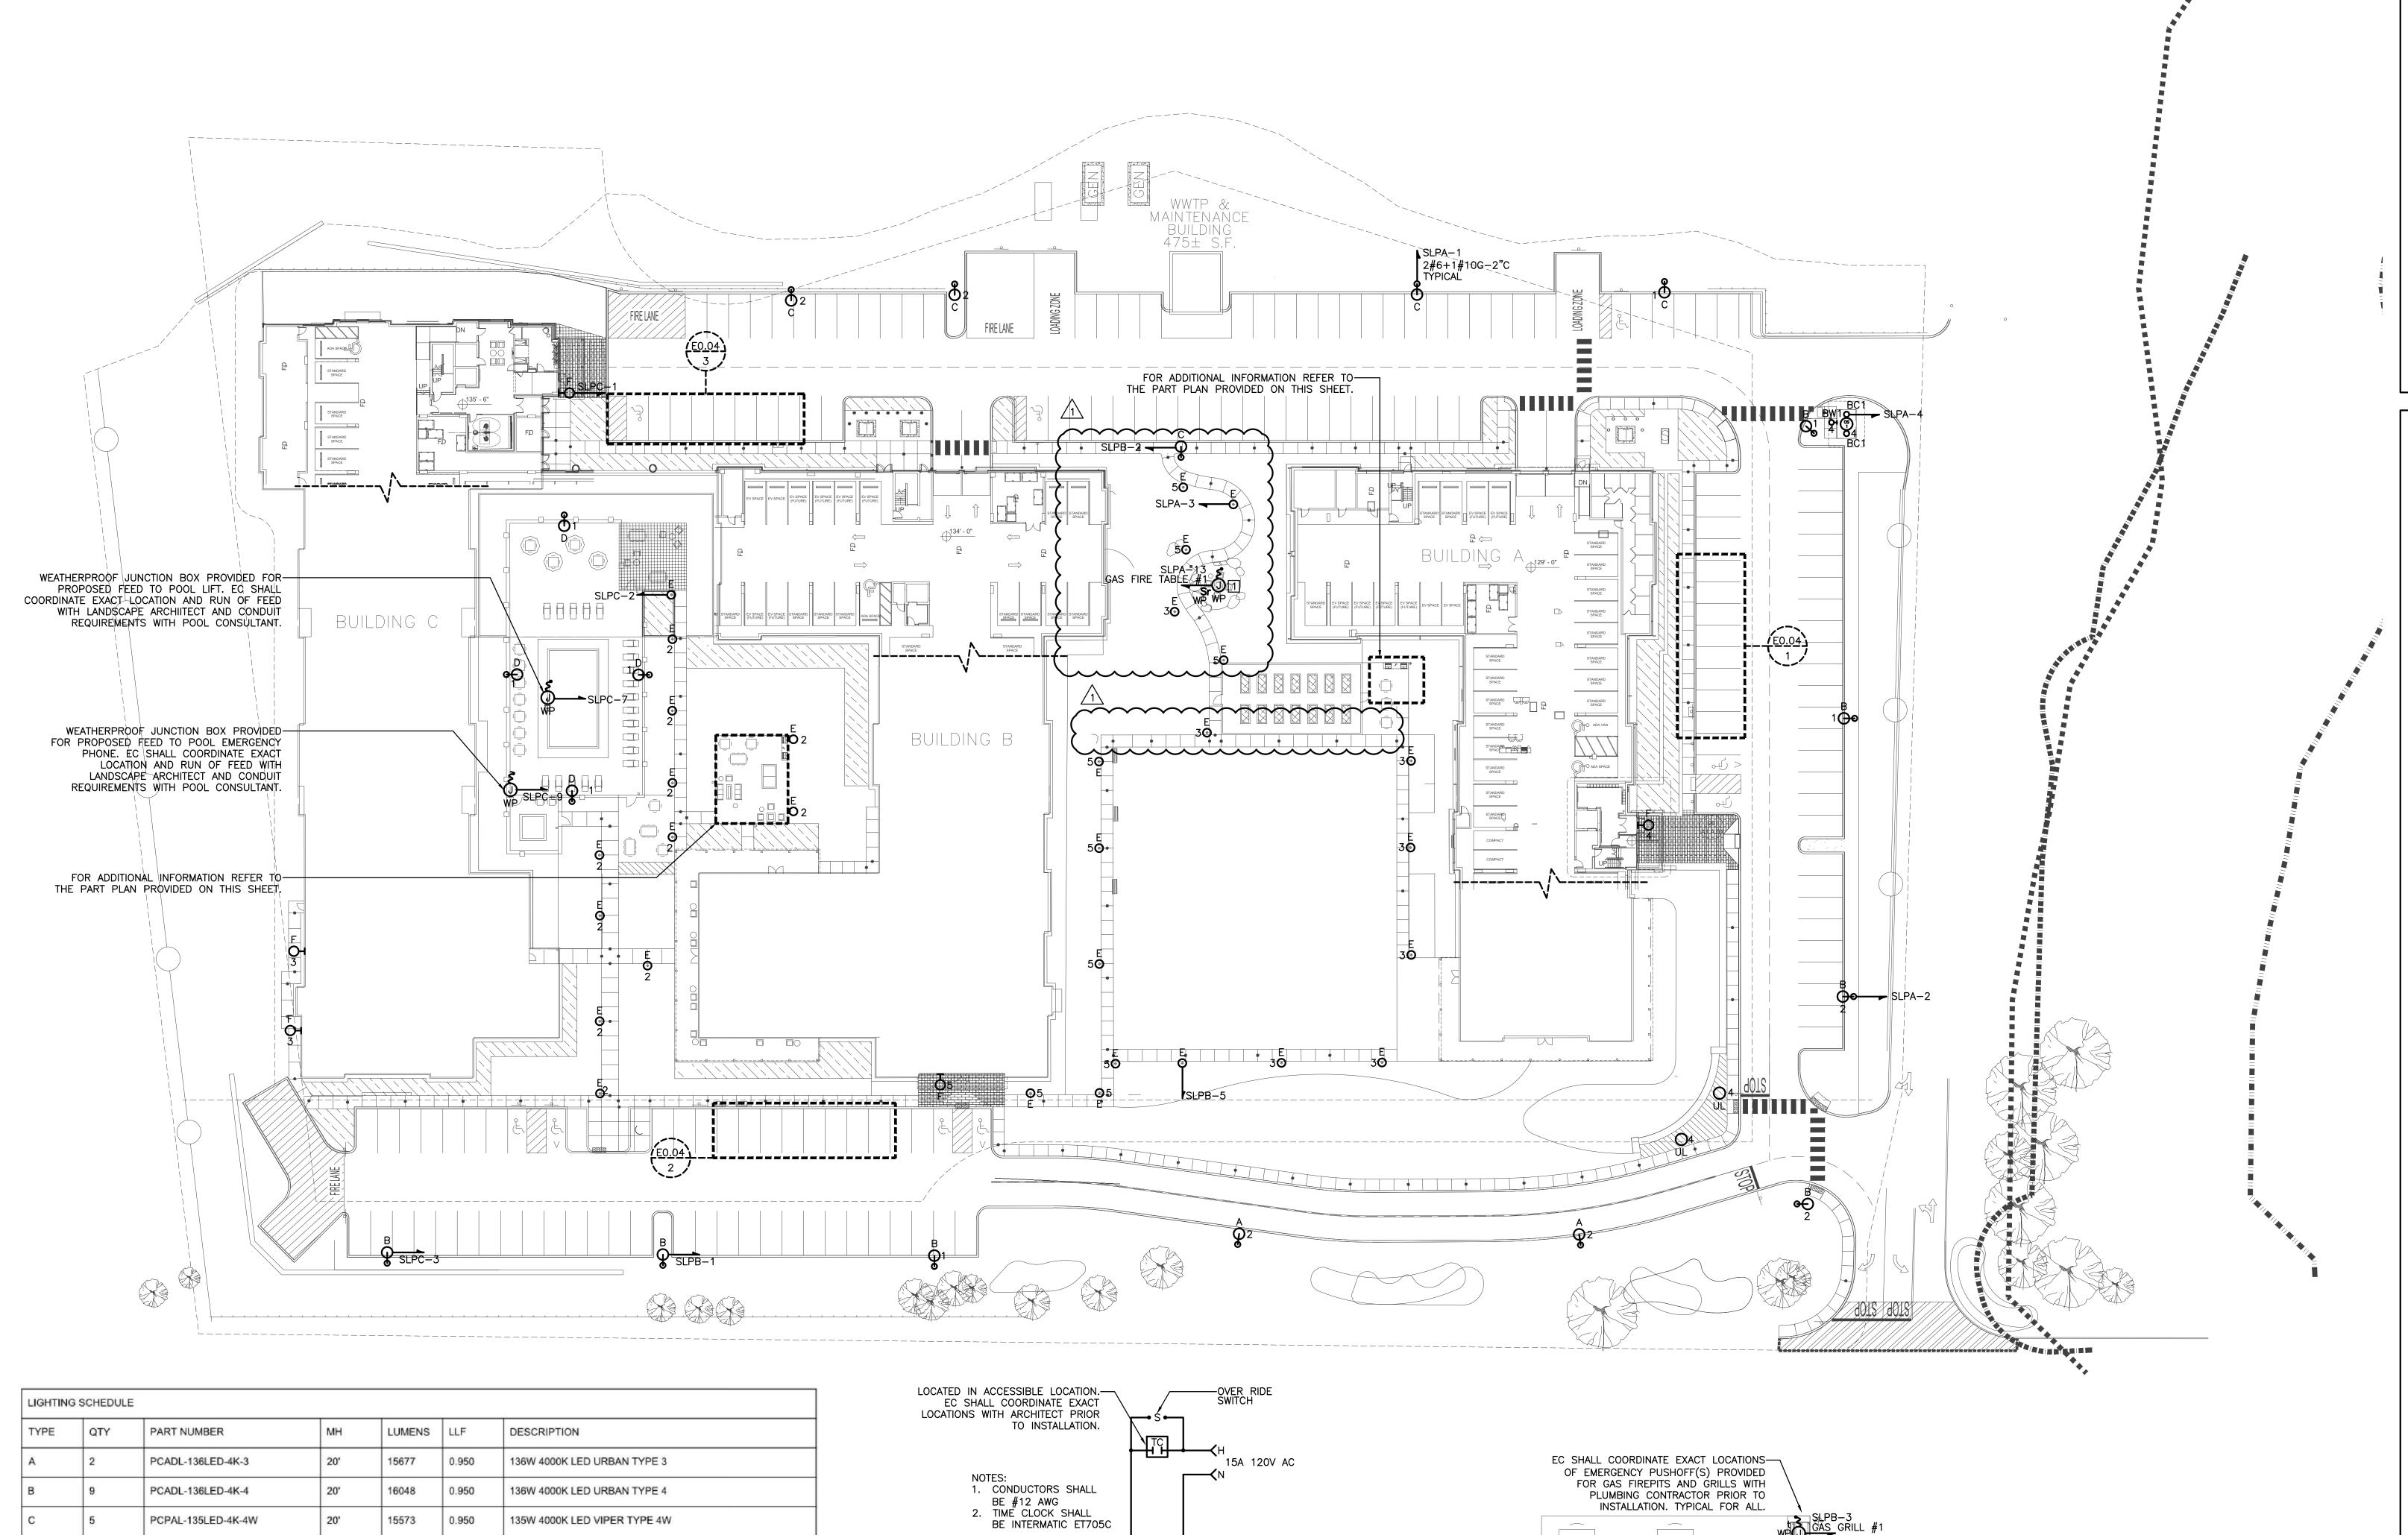

WIRING DETAIL SCALE: NONE


ELECTRICAL KEYED NOTES:

1 ELECTRICAL CONTRACTOR SHALL PROVIDE WEATHERPROOF JUNCTION BOXES AND IGNITION SWITCH FOR INDOOR/OUTDOOR FIREPLACE. COORDINATE WITH PLUMBING CONTRACTOR AND ARCHITECT FOR EXACT LOCATION PRIOR TO INSTALLATION. ALSO PROVIDE CONTROL MODULE TIED INTO FIRE ALARM SYSTEM FOR GAS SOLENOID SHUT-OFF TYPICAL. REFER TO GAS FIRE PIT/GRILL VALVE WIRING DETAIL PROVIDED ON THIS

IMAGE OF SITE LIGHT FIXTURE TYPE A & B



SLPB-7
GAS FIRE PIT #1 Electrical Courtyard Part Plan Scale: 1/8"=1'-0"

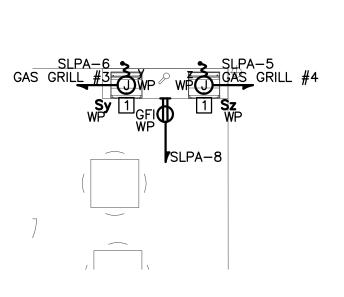

Electrical Courtyard Part Plan Scale: 1/8"=1'-0"

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Consultant:

Hanover, MA 02339 3rd Floor Tel: (781) 826-4144 Pawtucket, RI 02860 Fax: (781) 924-5792 www.wbaengineers.com

Revision:

11/09/20 Bulletin #1

Architect of Record:

DJQ Drawn:

Checked: SA

1" = 30'-0" Scale: Key Plan:

Project Name:

ALTA AT RIVER'S **EDGE**

490, 492, 494 BOSTON POST RD WAYLAND, MA 01778

Sheet Name: ELECTRICAL SITE LIGHTING & POWER PLAN

Project Number:

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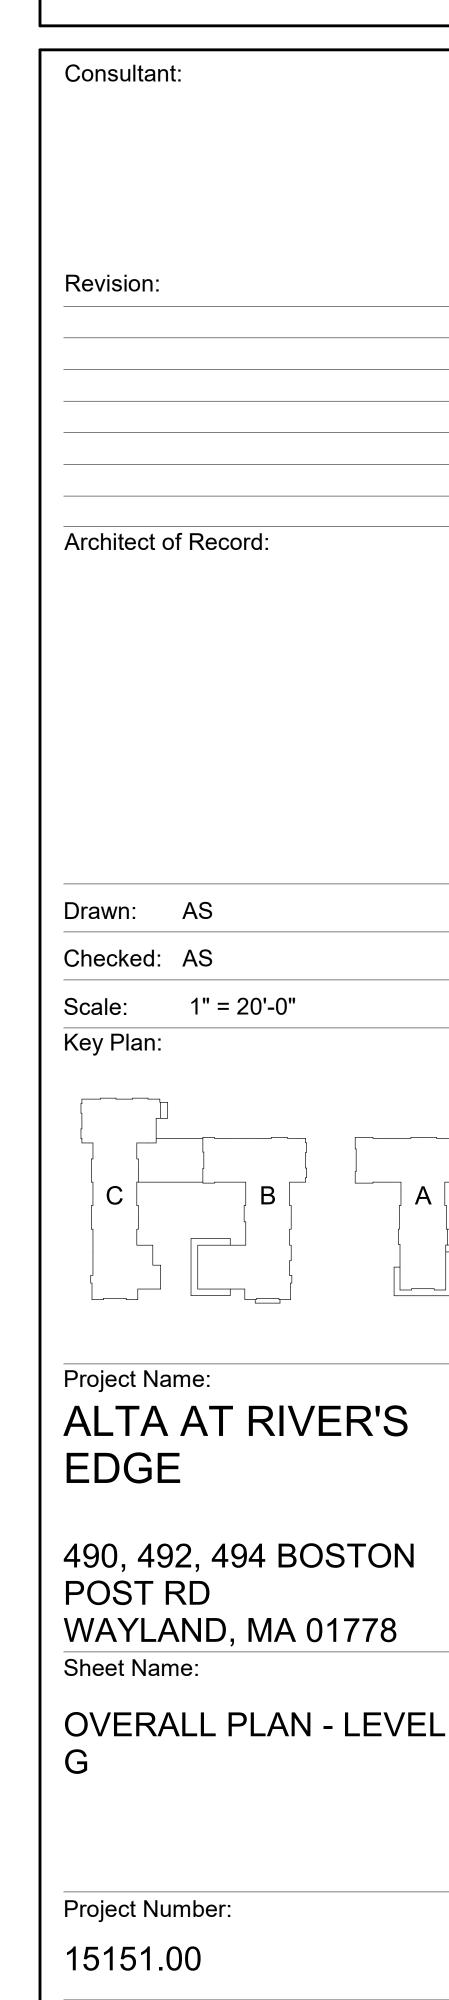
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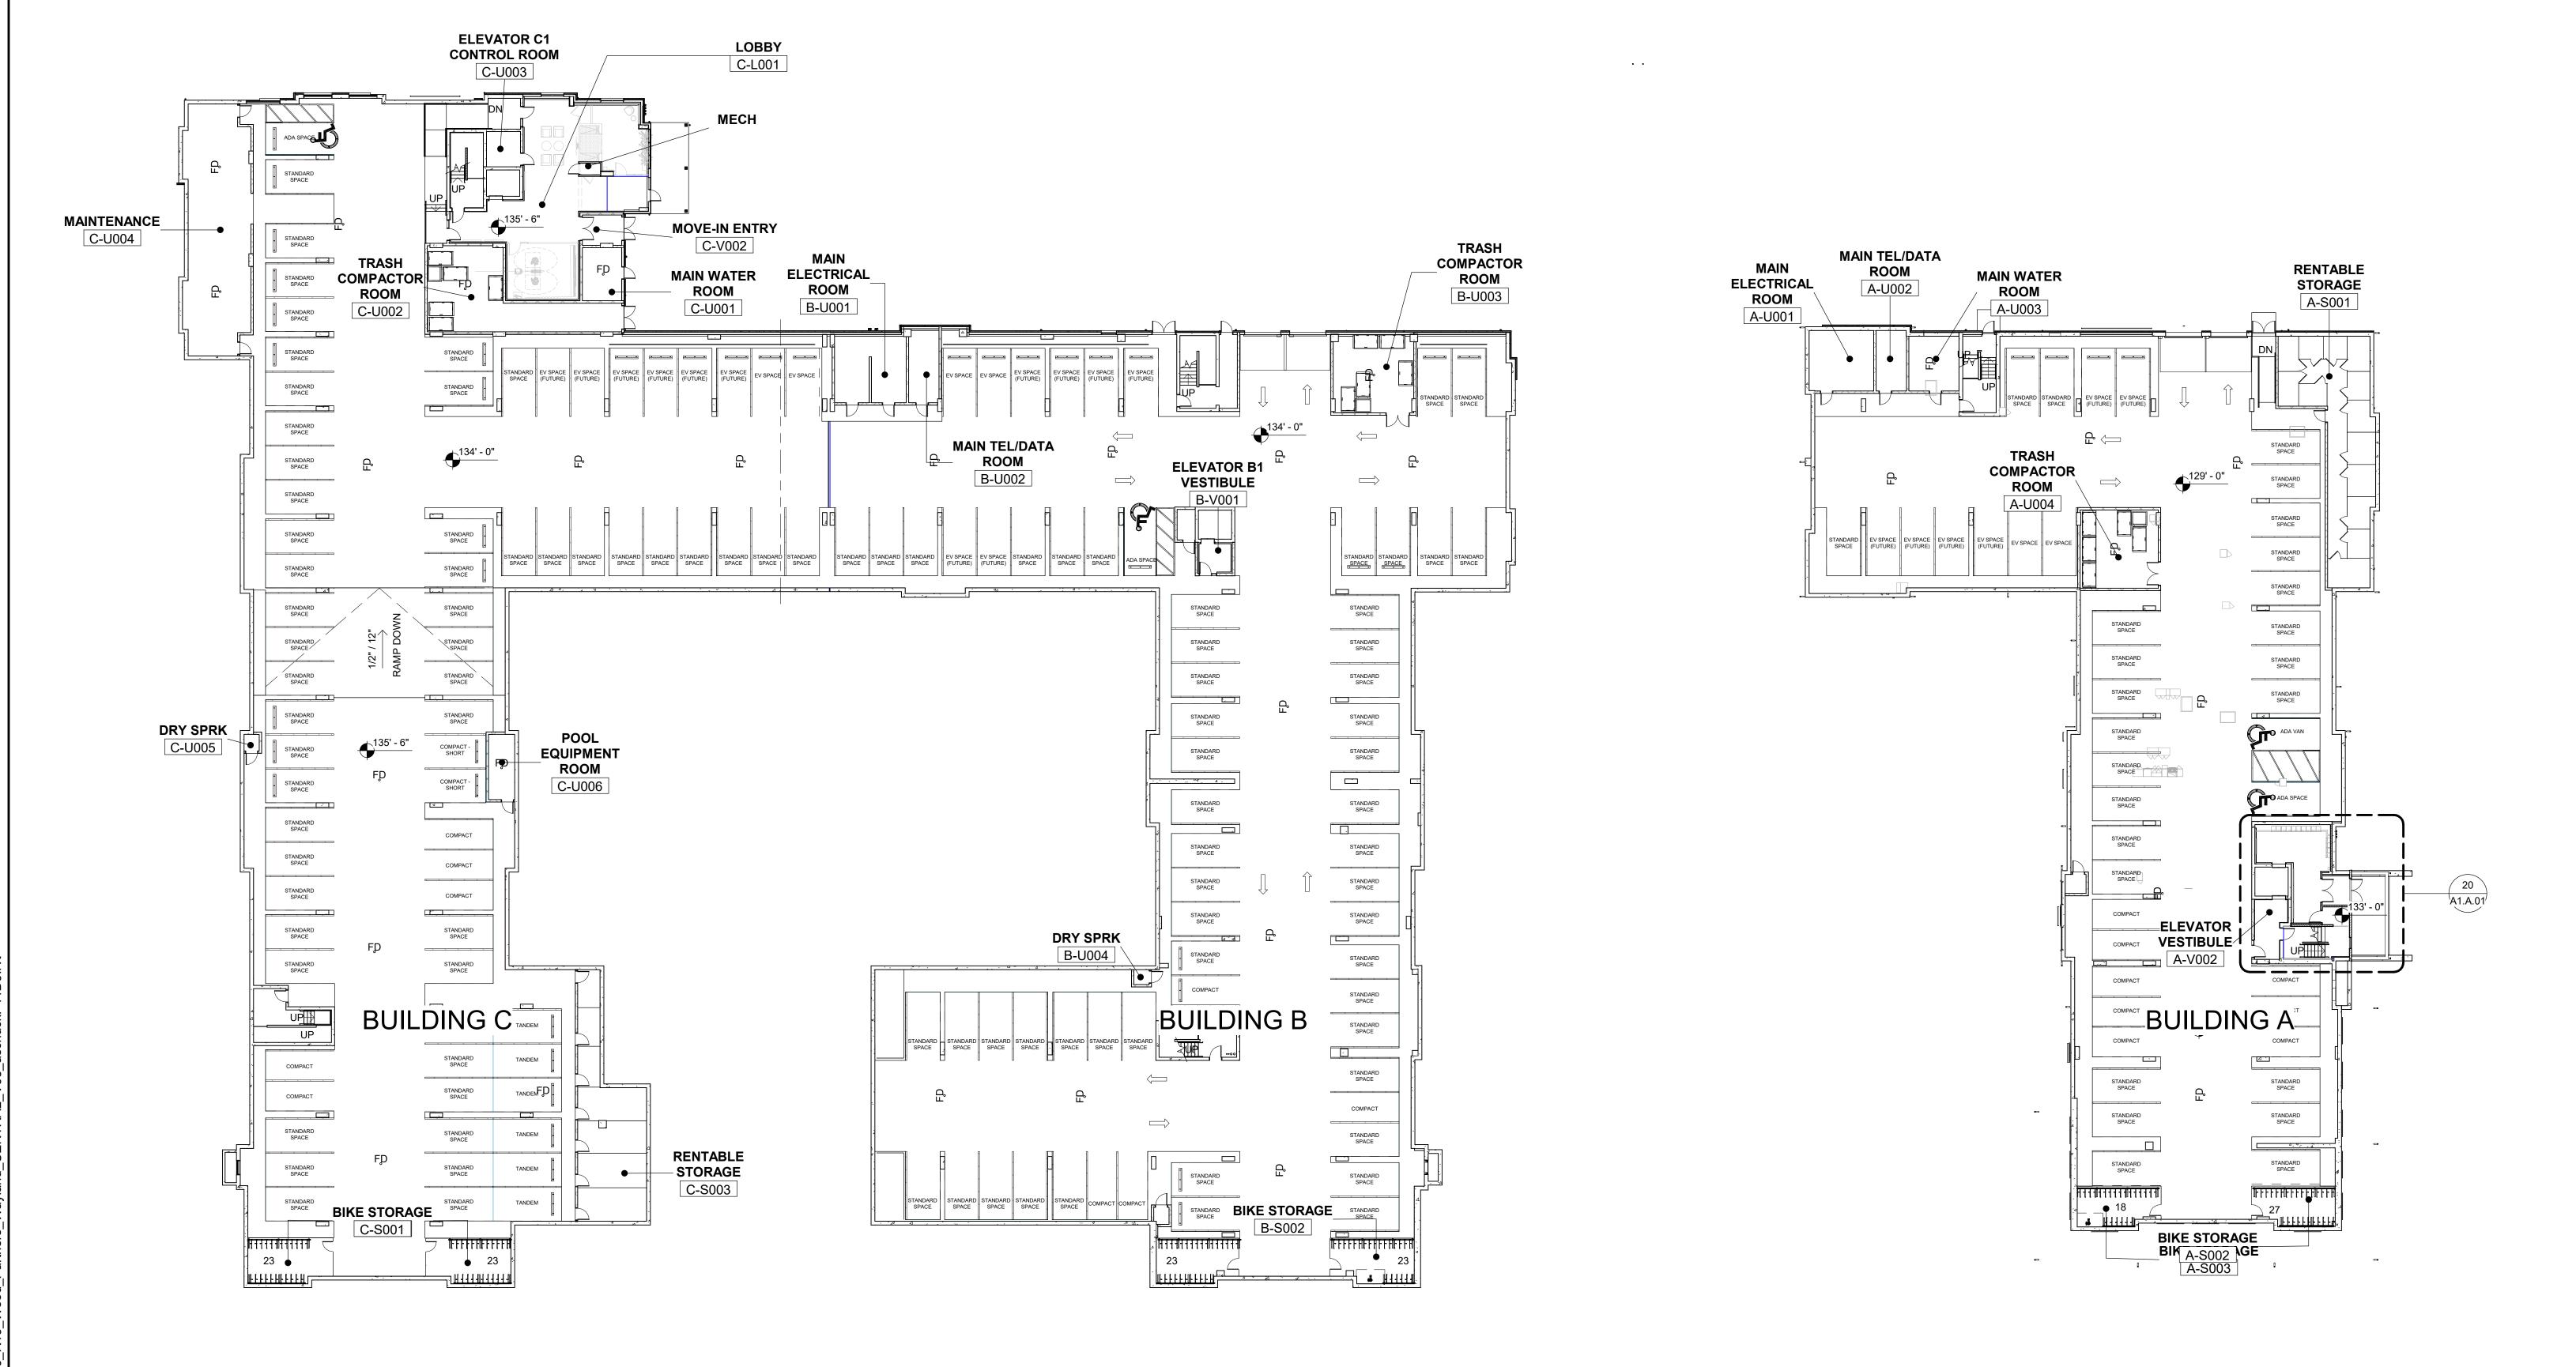
GARAGE PARKING SCHEDULE # of SPACES BLDG A - LEVEL G ADA SPACE COMPACT **EV SPACE EV SPACE (FUTURE)** STANDARD SPACE BLDG B - LEVEL G ADA SPACE COMPACT **EV SPACE** EV SPACE (FUTURE) STANDARD SPACE BLDG C - LEVEL G ADA SPACE COMPACT COMPACT - SHORT STANDARD SPACE TANDEM

494 BOSTON POST ROAD

OVERALL PLANS - GARAGE
Scale: 1" = 20'-0"

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492 BOSTON POST ROAD

PROJECT N


490 BOSTON POST ROAD SEPTEMBER 23, 2020

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EDGE POST RD

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Sheet Name:

OVERALL PLAN - LEVEL

Project Number:

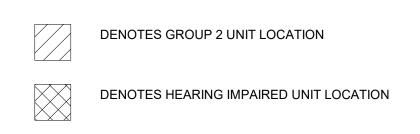
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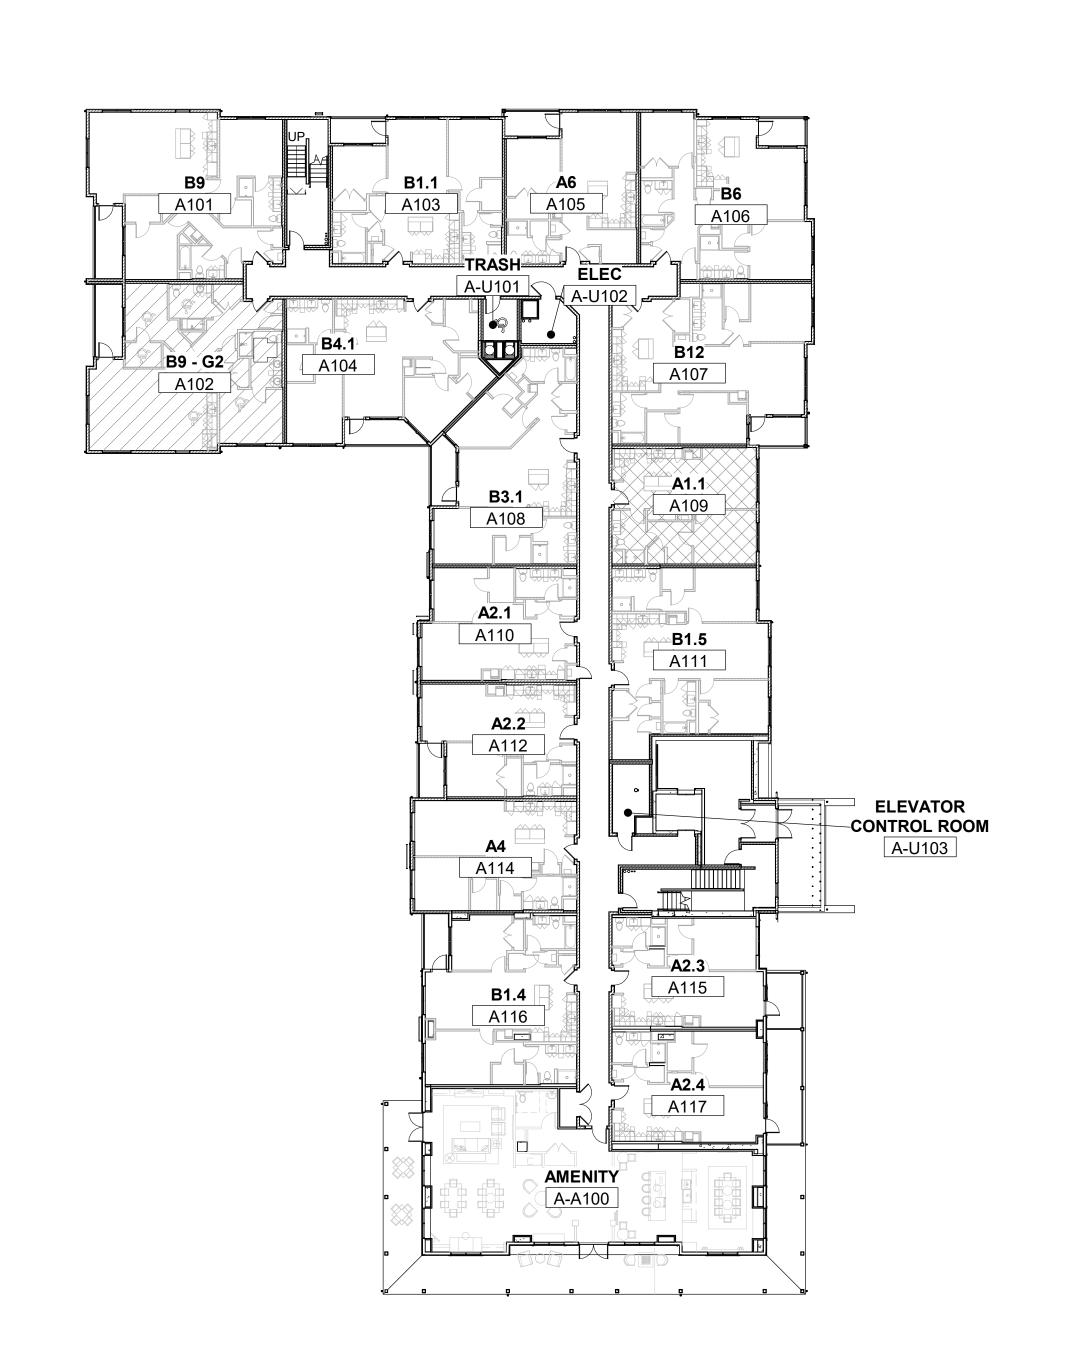
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Sheet Number:

PROJECT NORTH N





BUILDING A 490 BOSTON POST ROAD

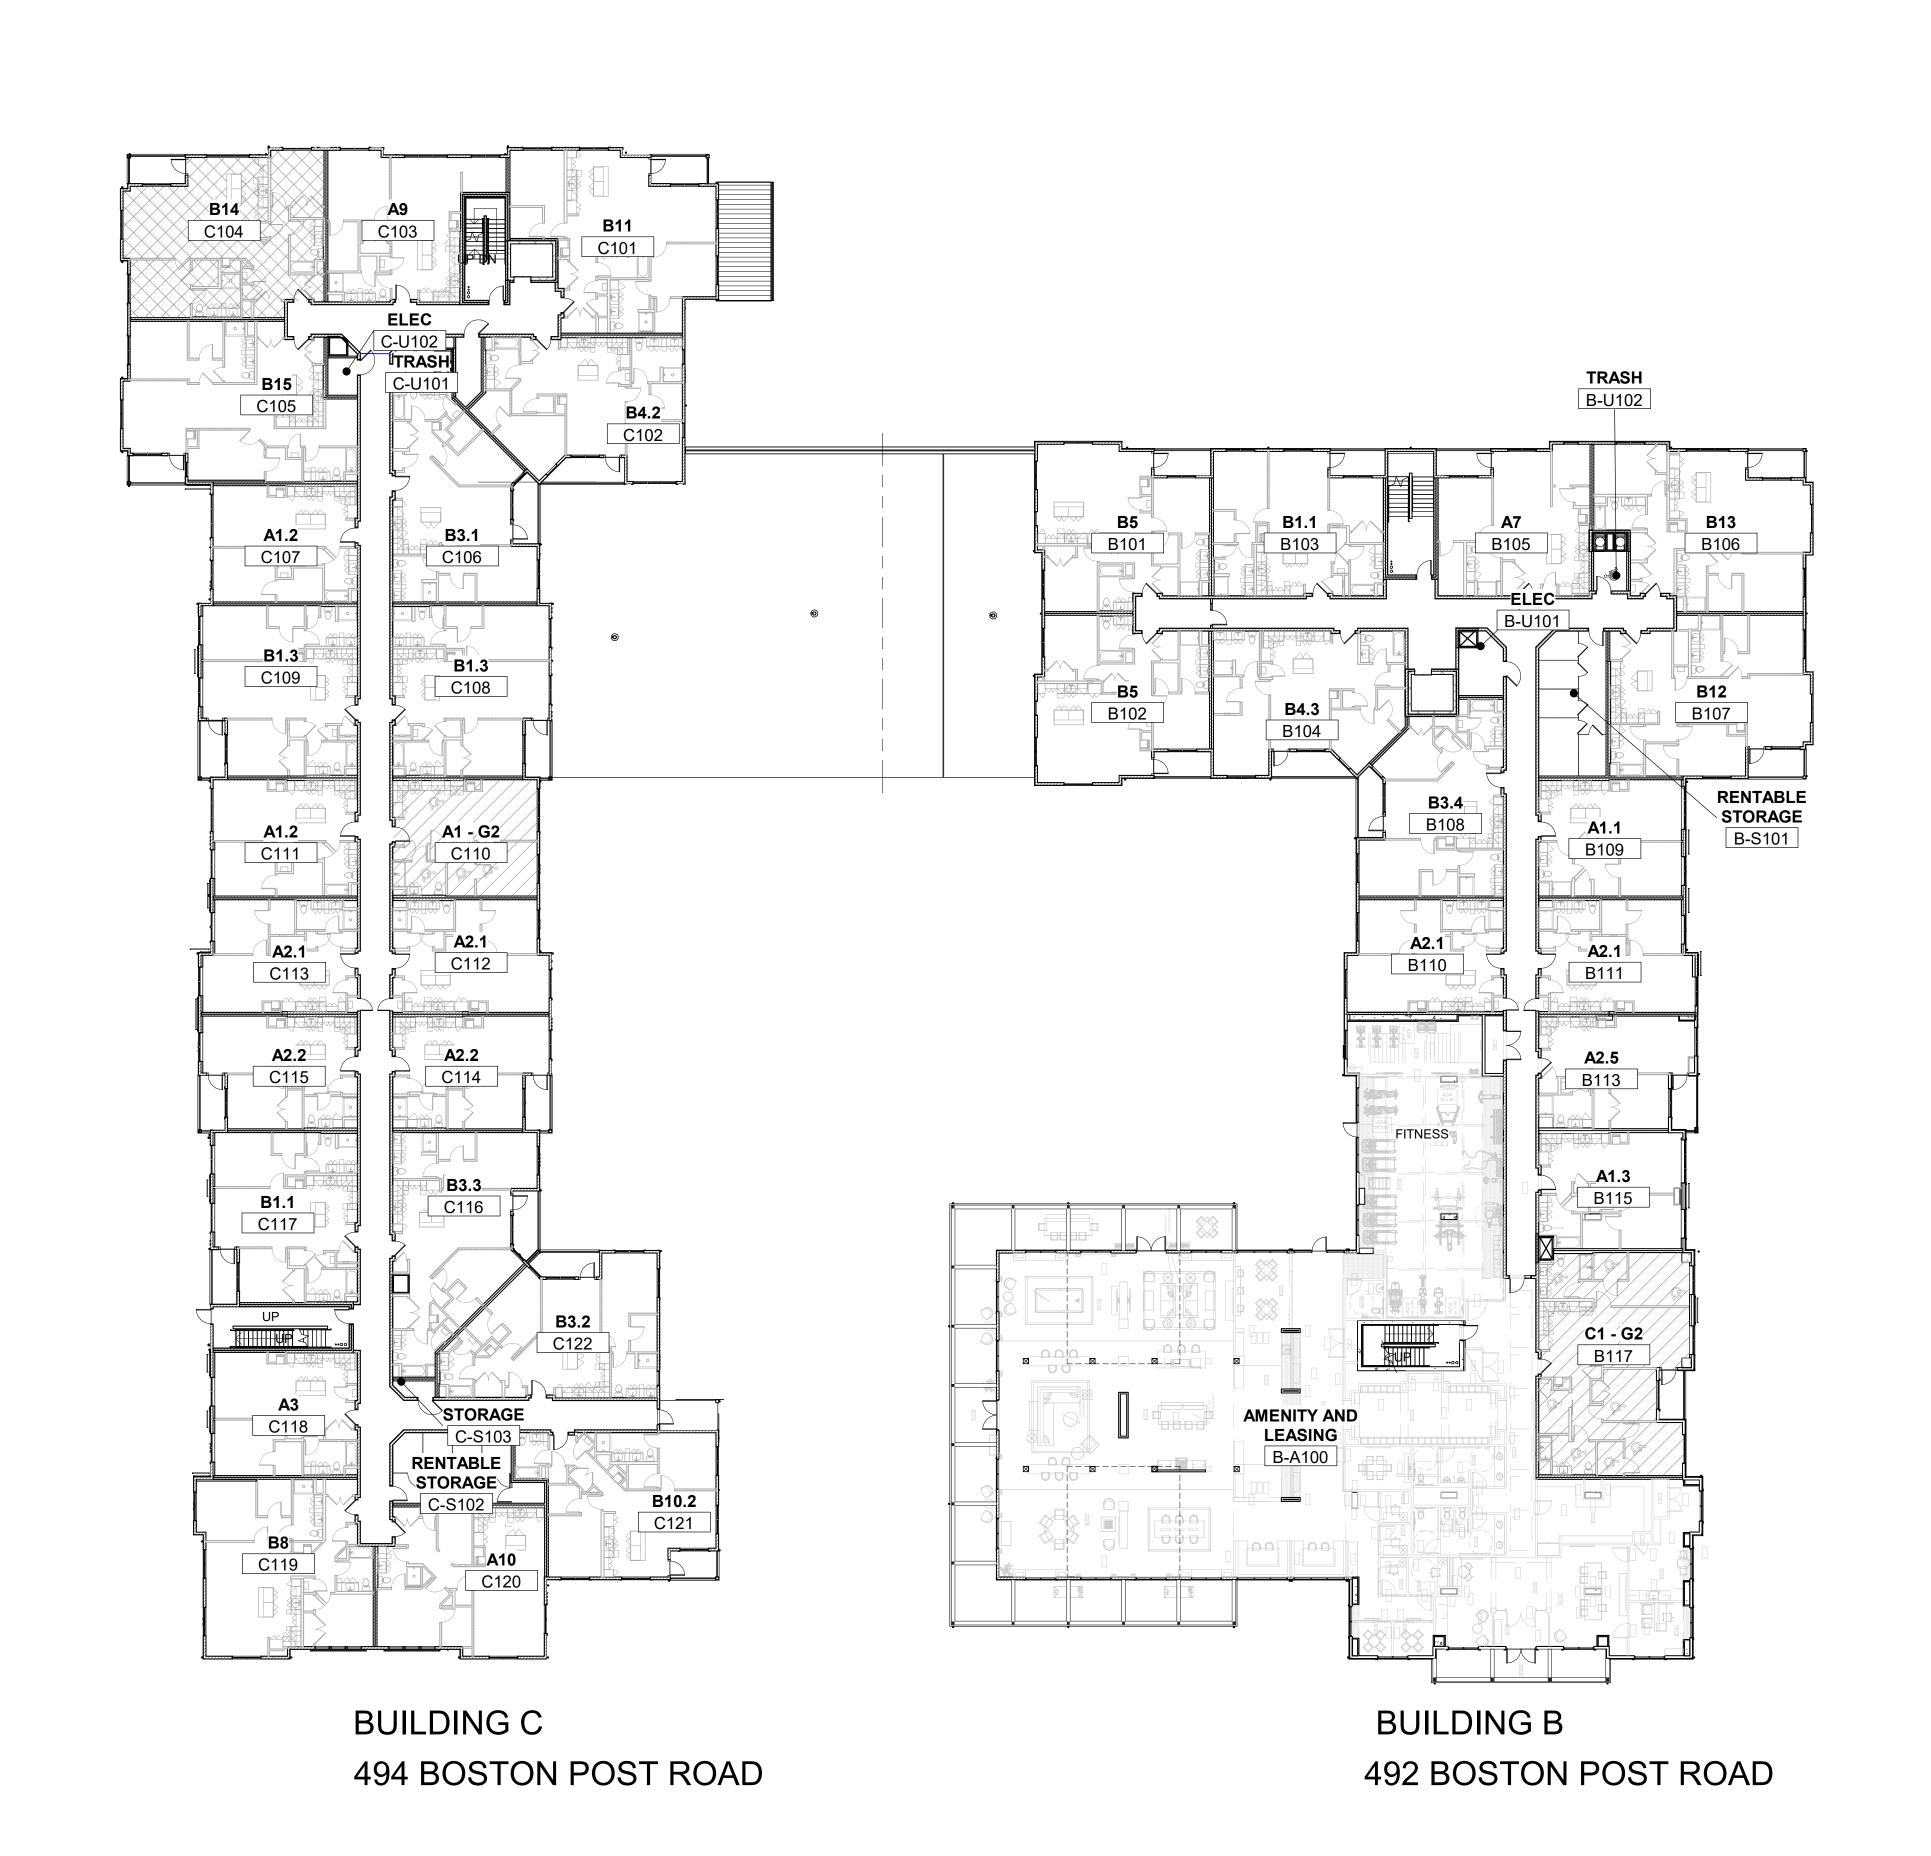OVERALL PLANS - LEVEL 01
Scale: 1" = 20'-0"

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Checked: AS

Scale: As indicated

Key Plan:

C B A

Project Name:

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Sheet Name:

OVERALL PLAN - LEVEL

Project Number:


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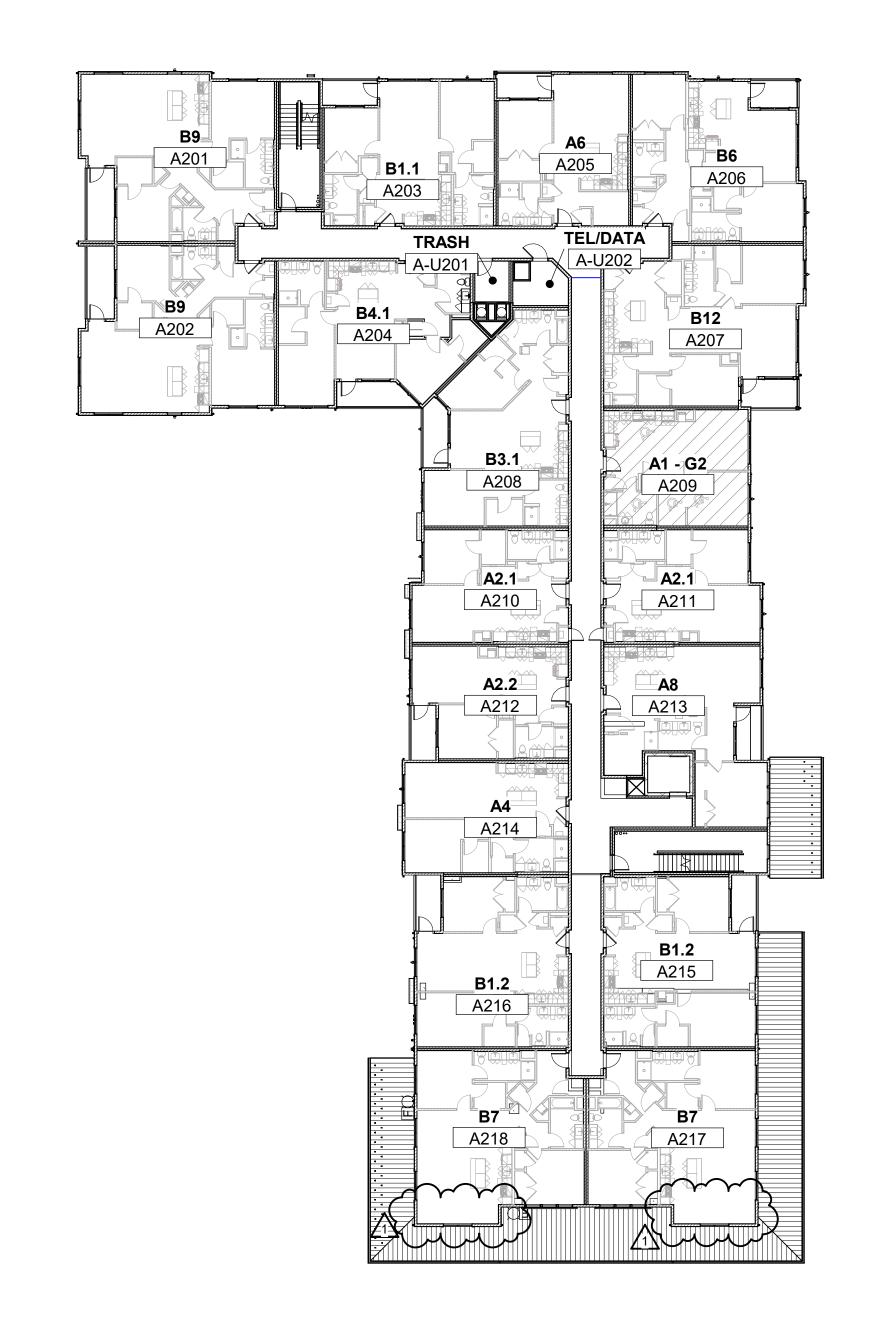
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Sheet Number:

A1 02





BUILDING A 490 BOSTON POST ROAD

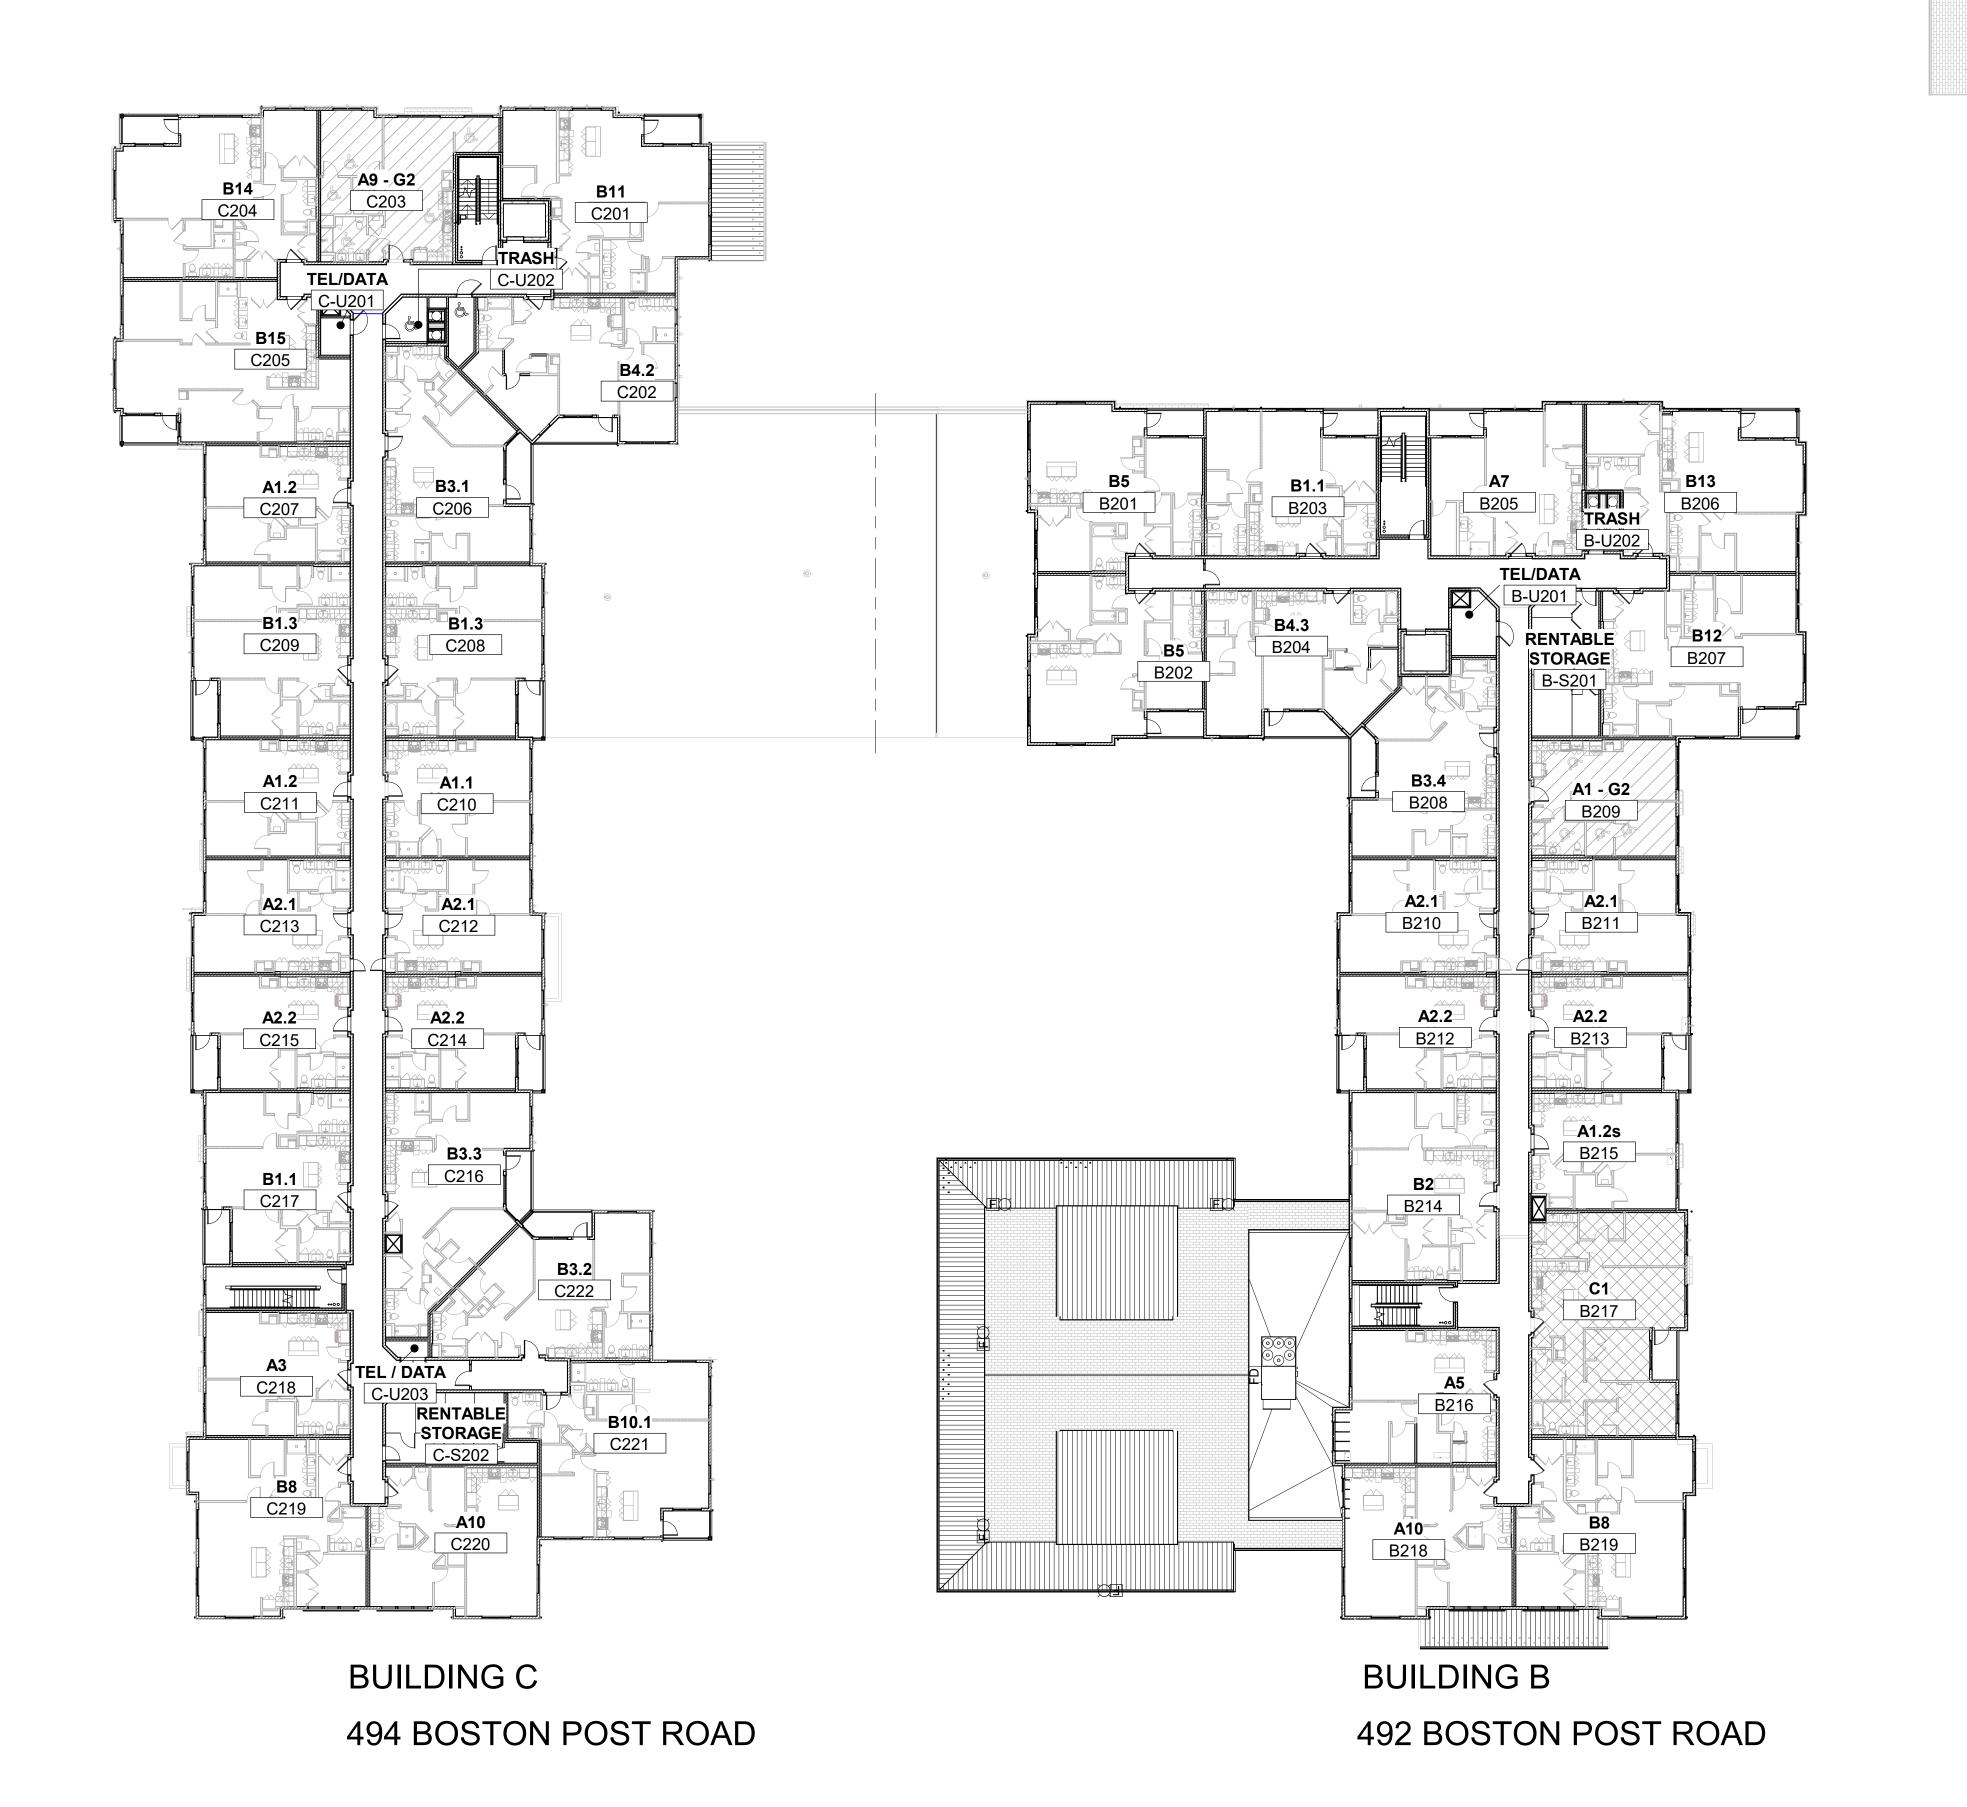10 OVERALL PLANS - LEVEL 02
Scale: 1" = 20'-0"

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Scale: As indicated

Key Plan:

Project Name:

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Sheet Name:

OVERALL PLAN - LEVEL 3

Project Number:

15151.00


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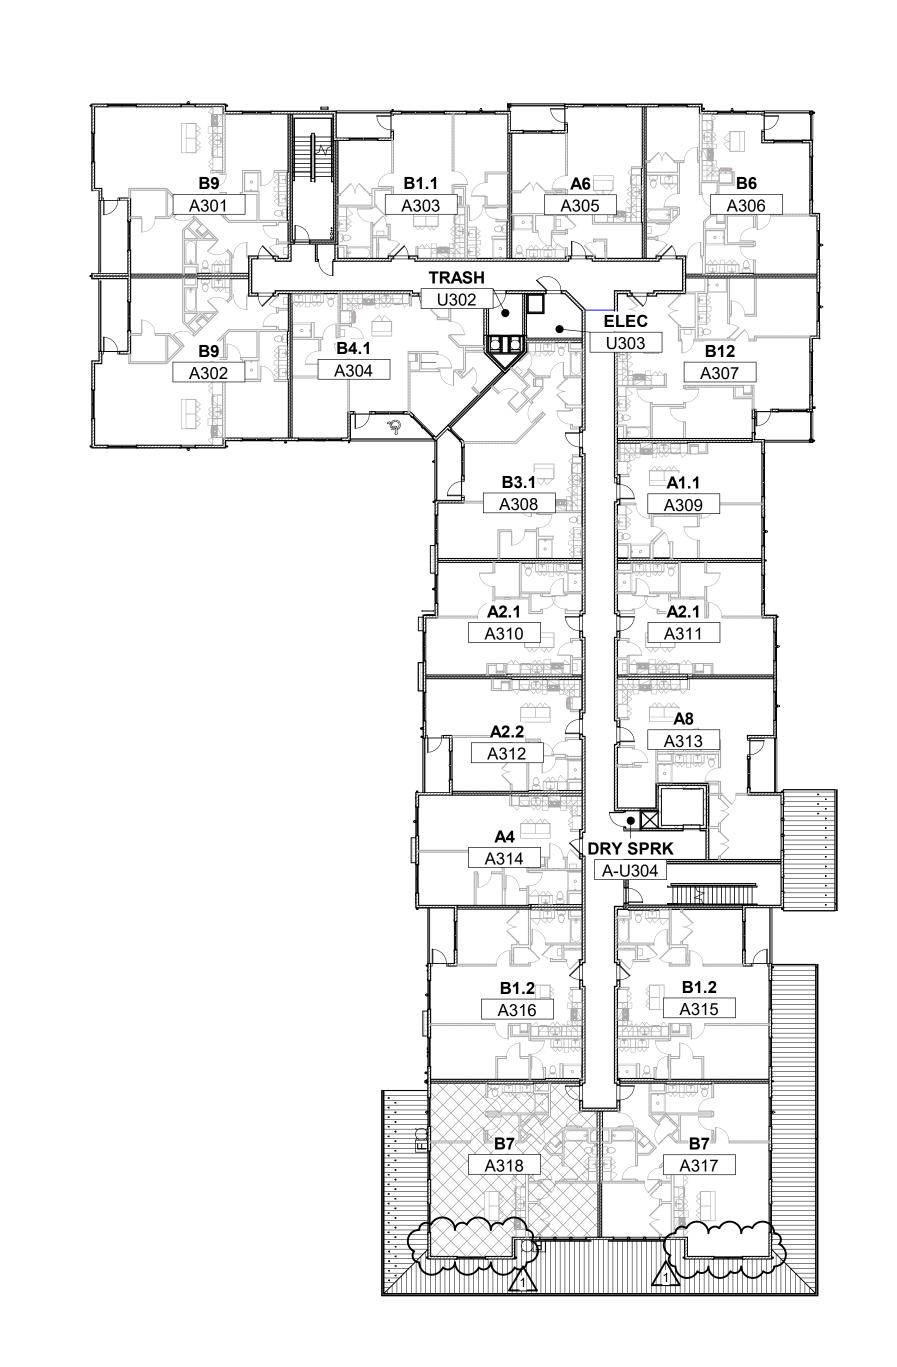
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41.03





BUILDING A 490 BOSTON POST ROAD

OVERALL PLANS - LEVEL 03
Scale: 1" = 20'-0"

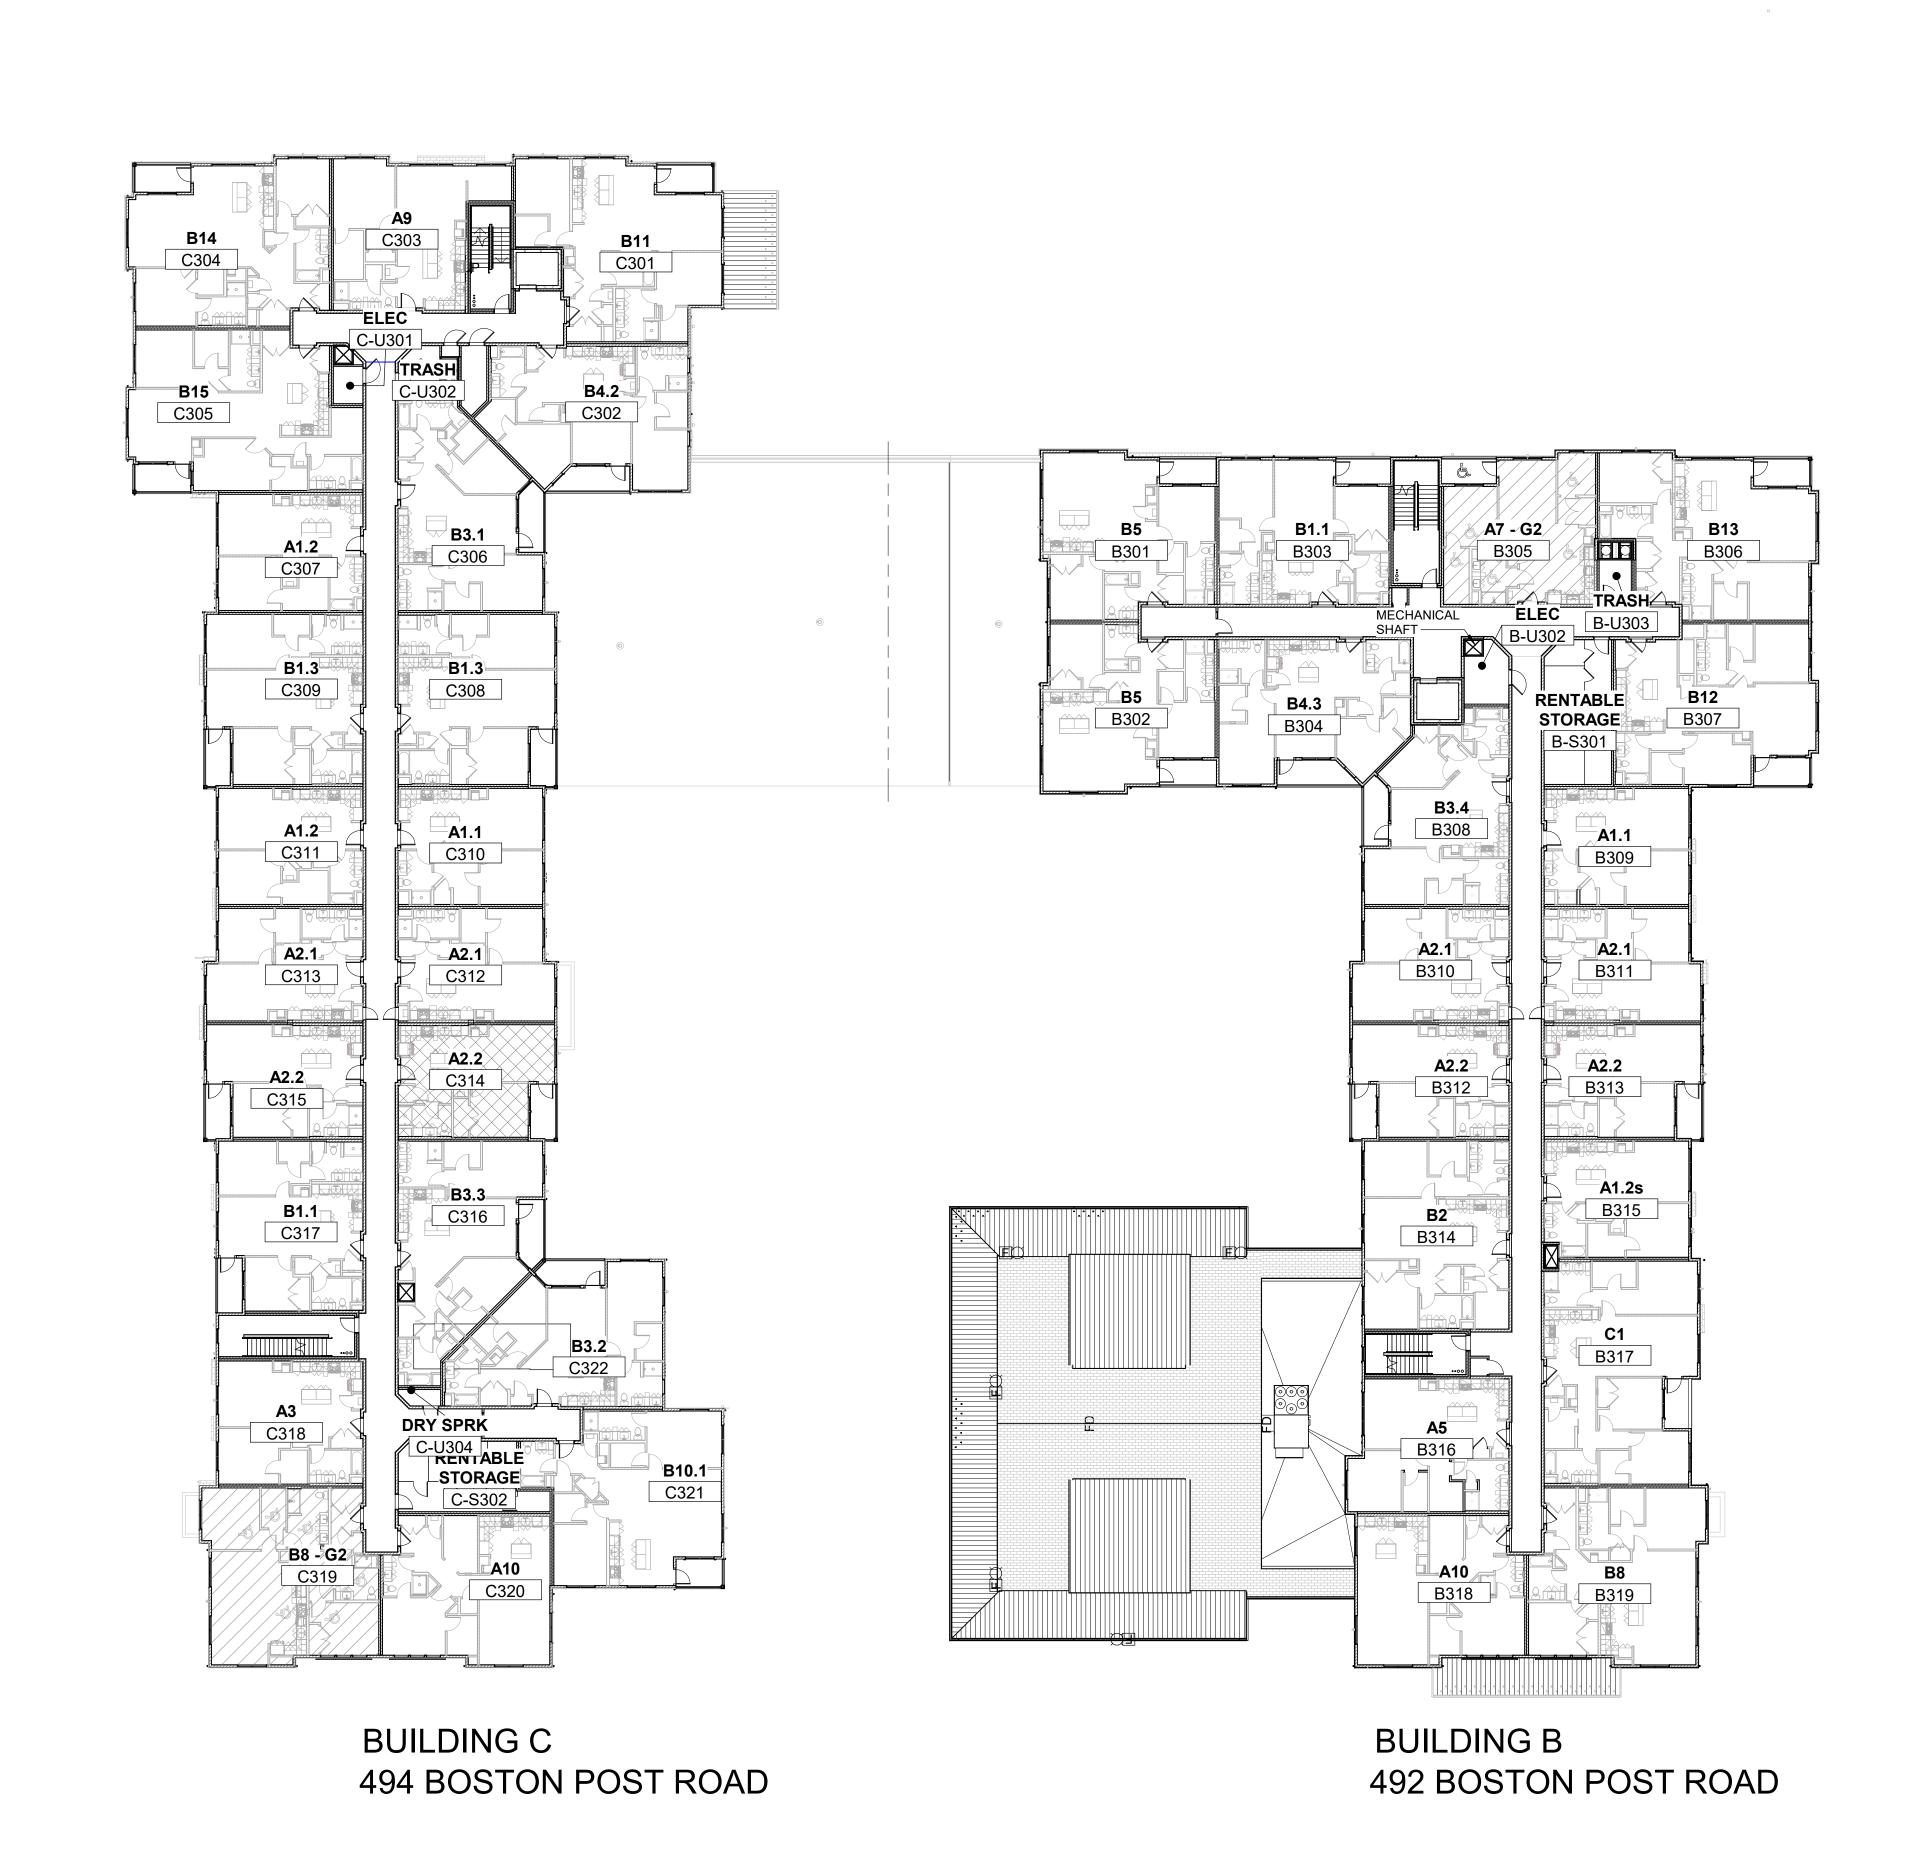

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Key Plan:

As indicated

Checked: AS

Scale:

Project Name: ALTA AT RIVER'S

490, 492, 494 BOSTON POST RD WAYLAND, MA 01778

Sheet Name: **OVERALL PLAN - LEVEL**

Project Number:

15151.00

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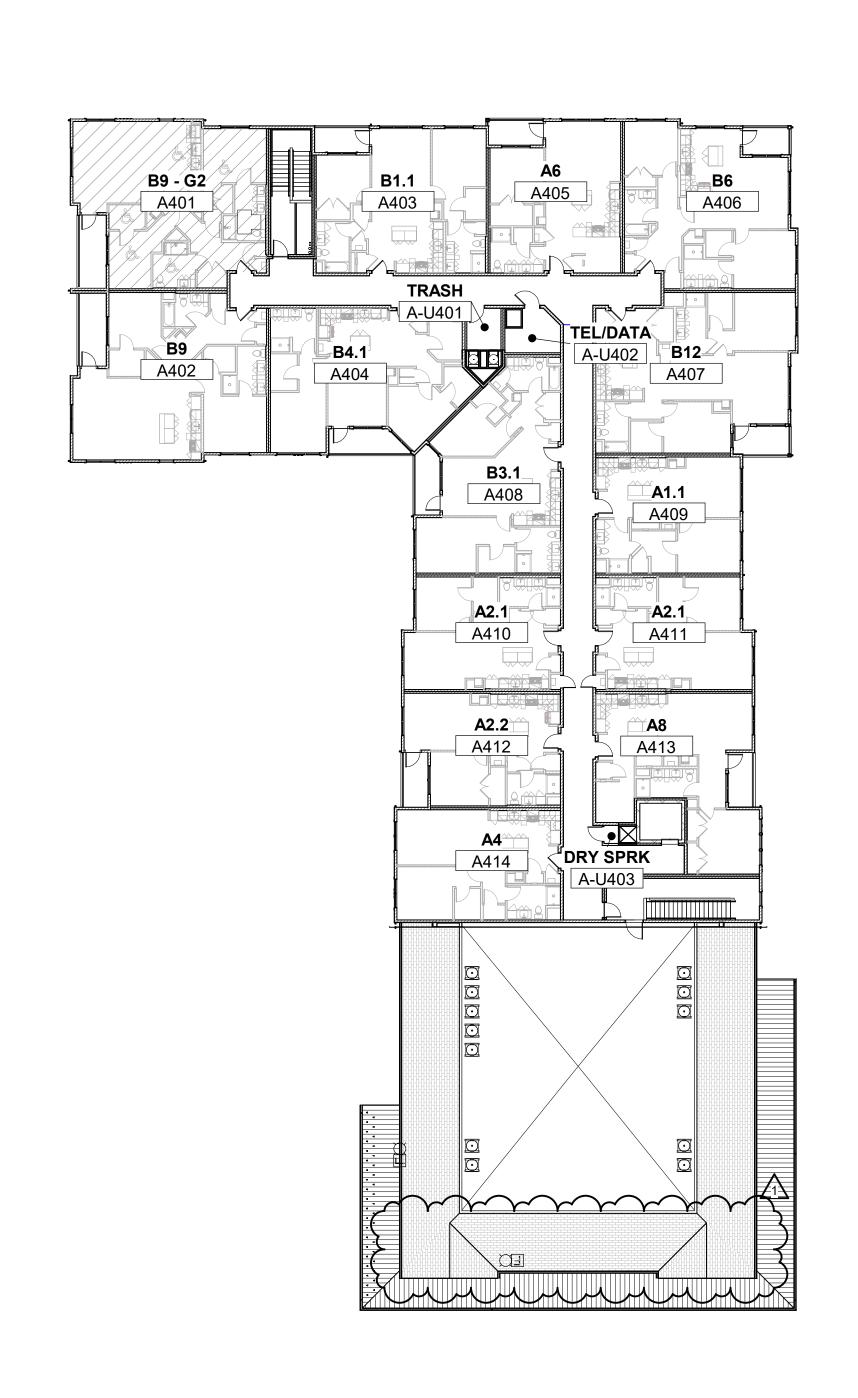
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PROJECT NORTH N

SEPTEMBER 23, 2020

Sheet Number:





BUILDING A 490 BOSTON POST ROAD

10 OVERALL PLANS - LEVEL 04
Scale: 1" = 20'-0"

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BUILDING B

492 BOSTON POST ROAD

Revision: 1 11/10/20 ISSUED FOR CONSTR.

Architect of Record:

Consultant:

Drawn: AS Checked: AS 1" = 20'-0" Scale: Key Plan:

> Project Name: ALTA AT RIVER'S

490, 492, 494 BOSTON POST RD WAYLAND, MA 01778

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OVERALL PLAN - ROOF

Project Number:

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BUILDING A


490 BOSTON POST ROAD

SEPTEMBER 23, 2020

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BUILDING C

494 BOSTON POST ROAD

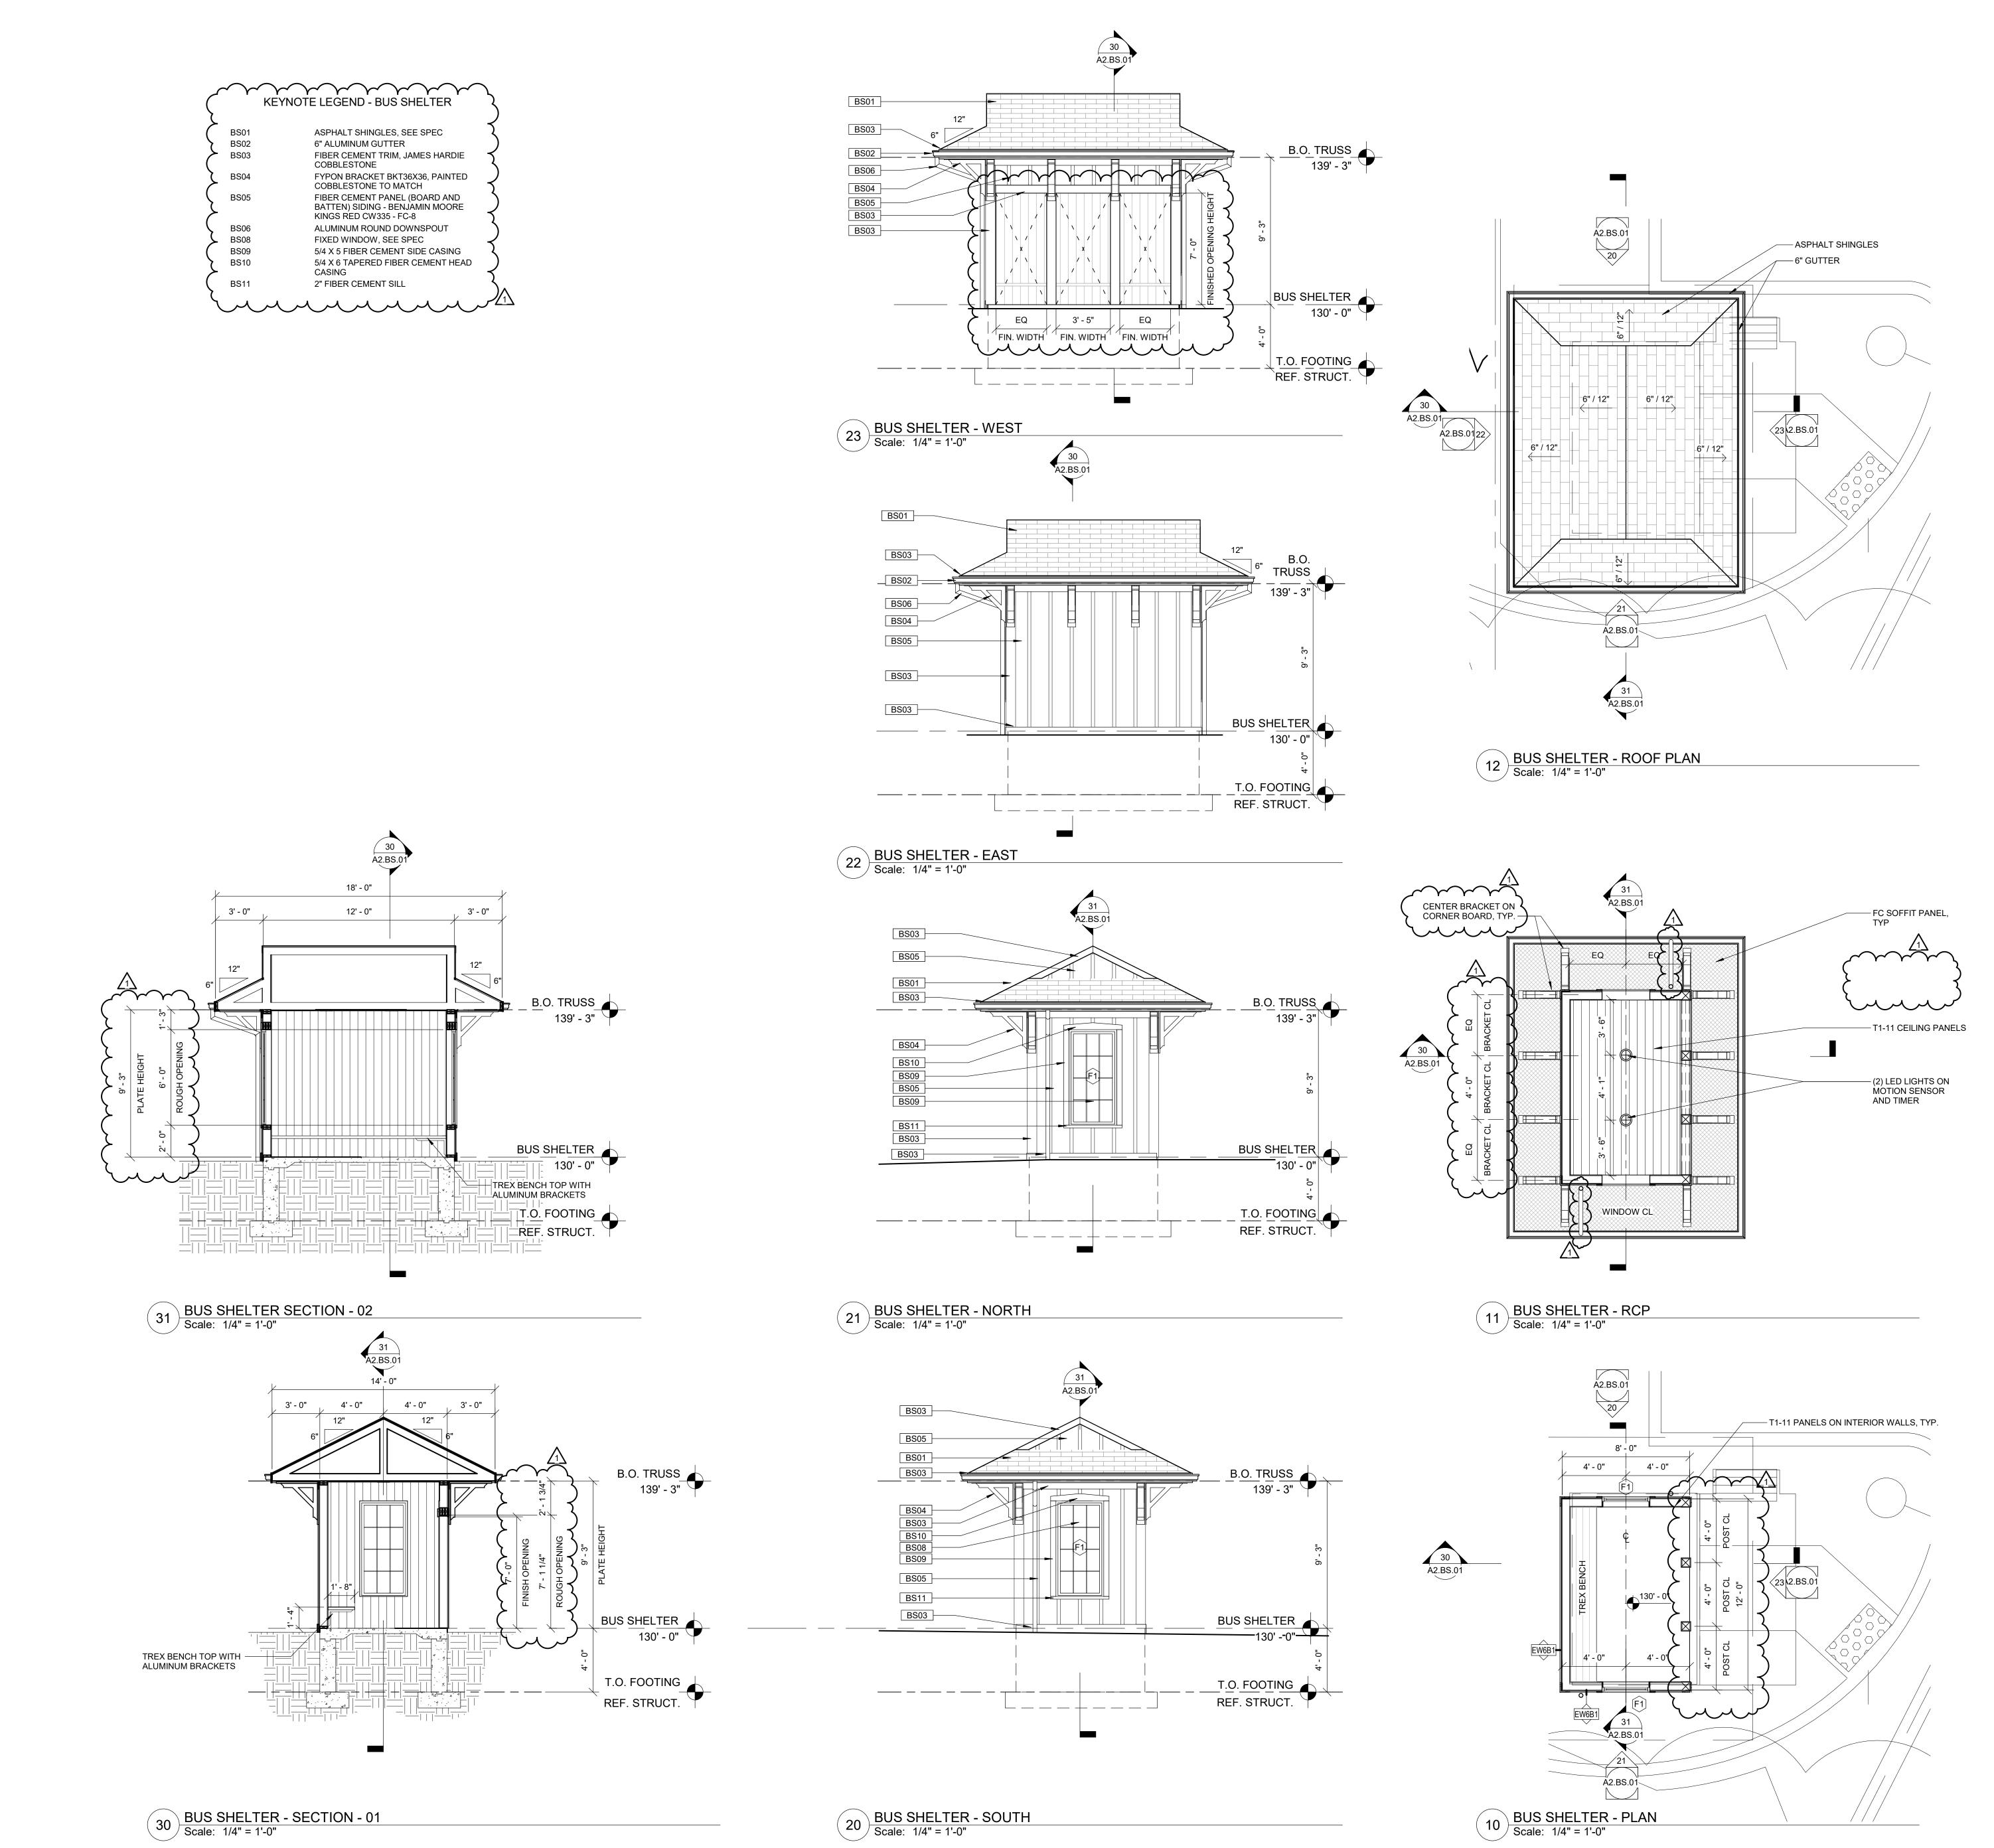

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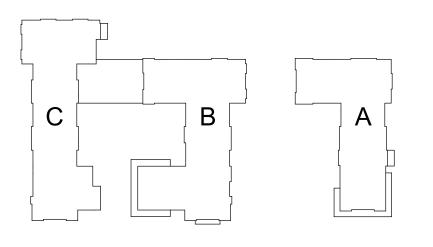
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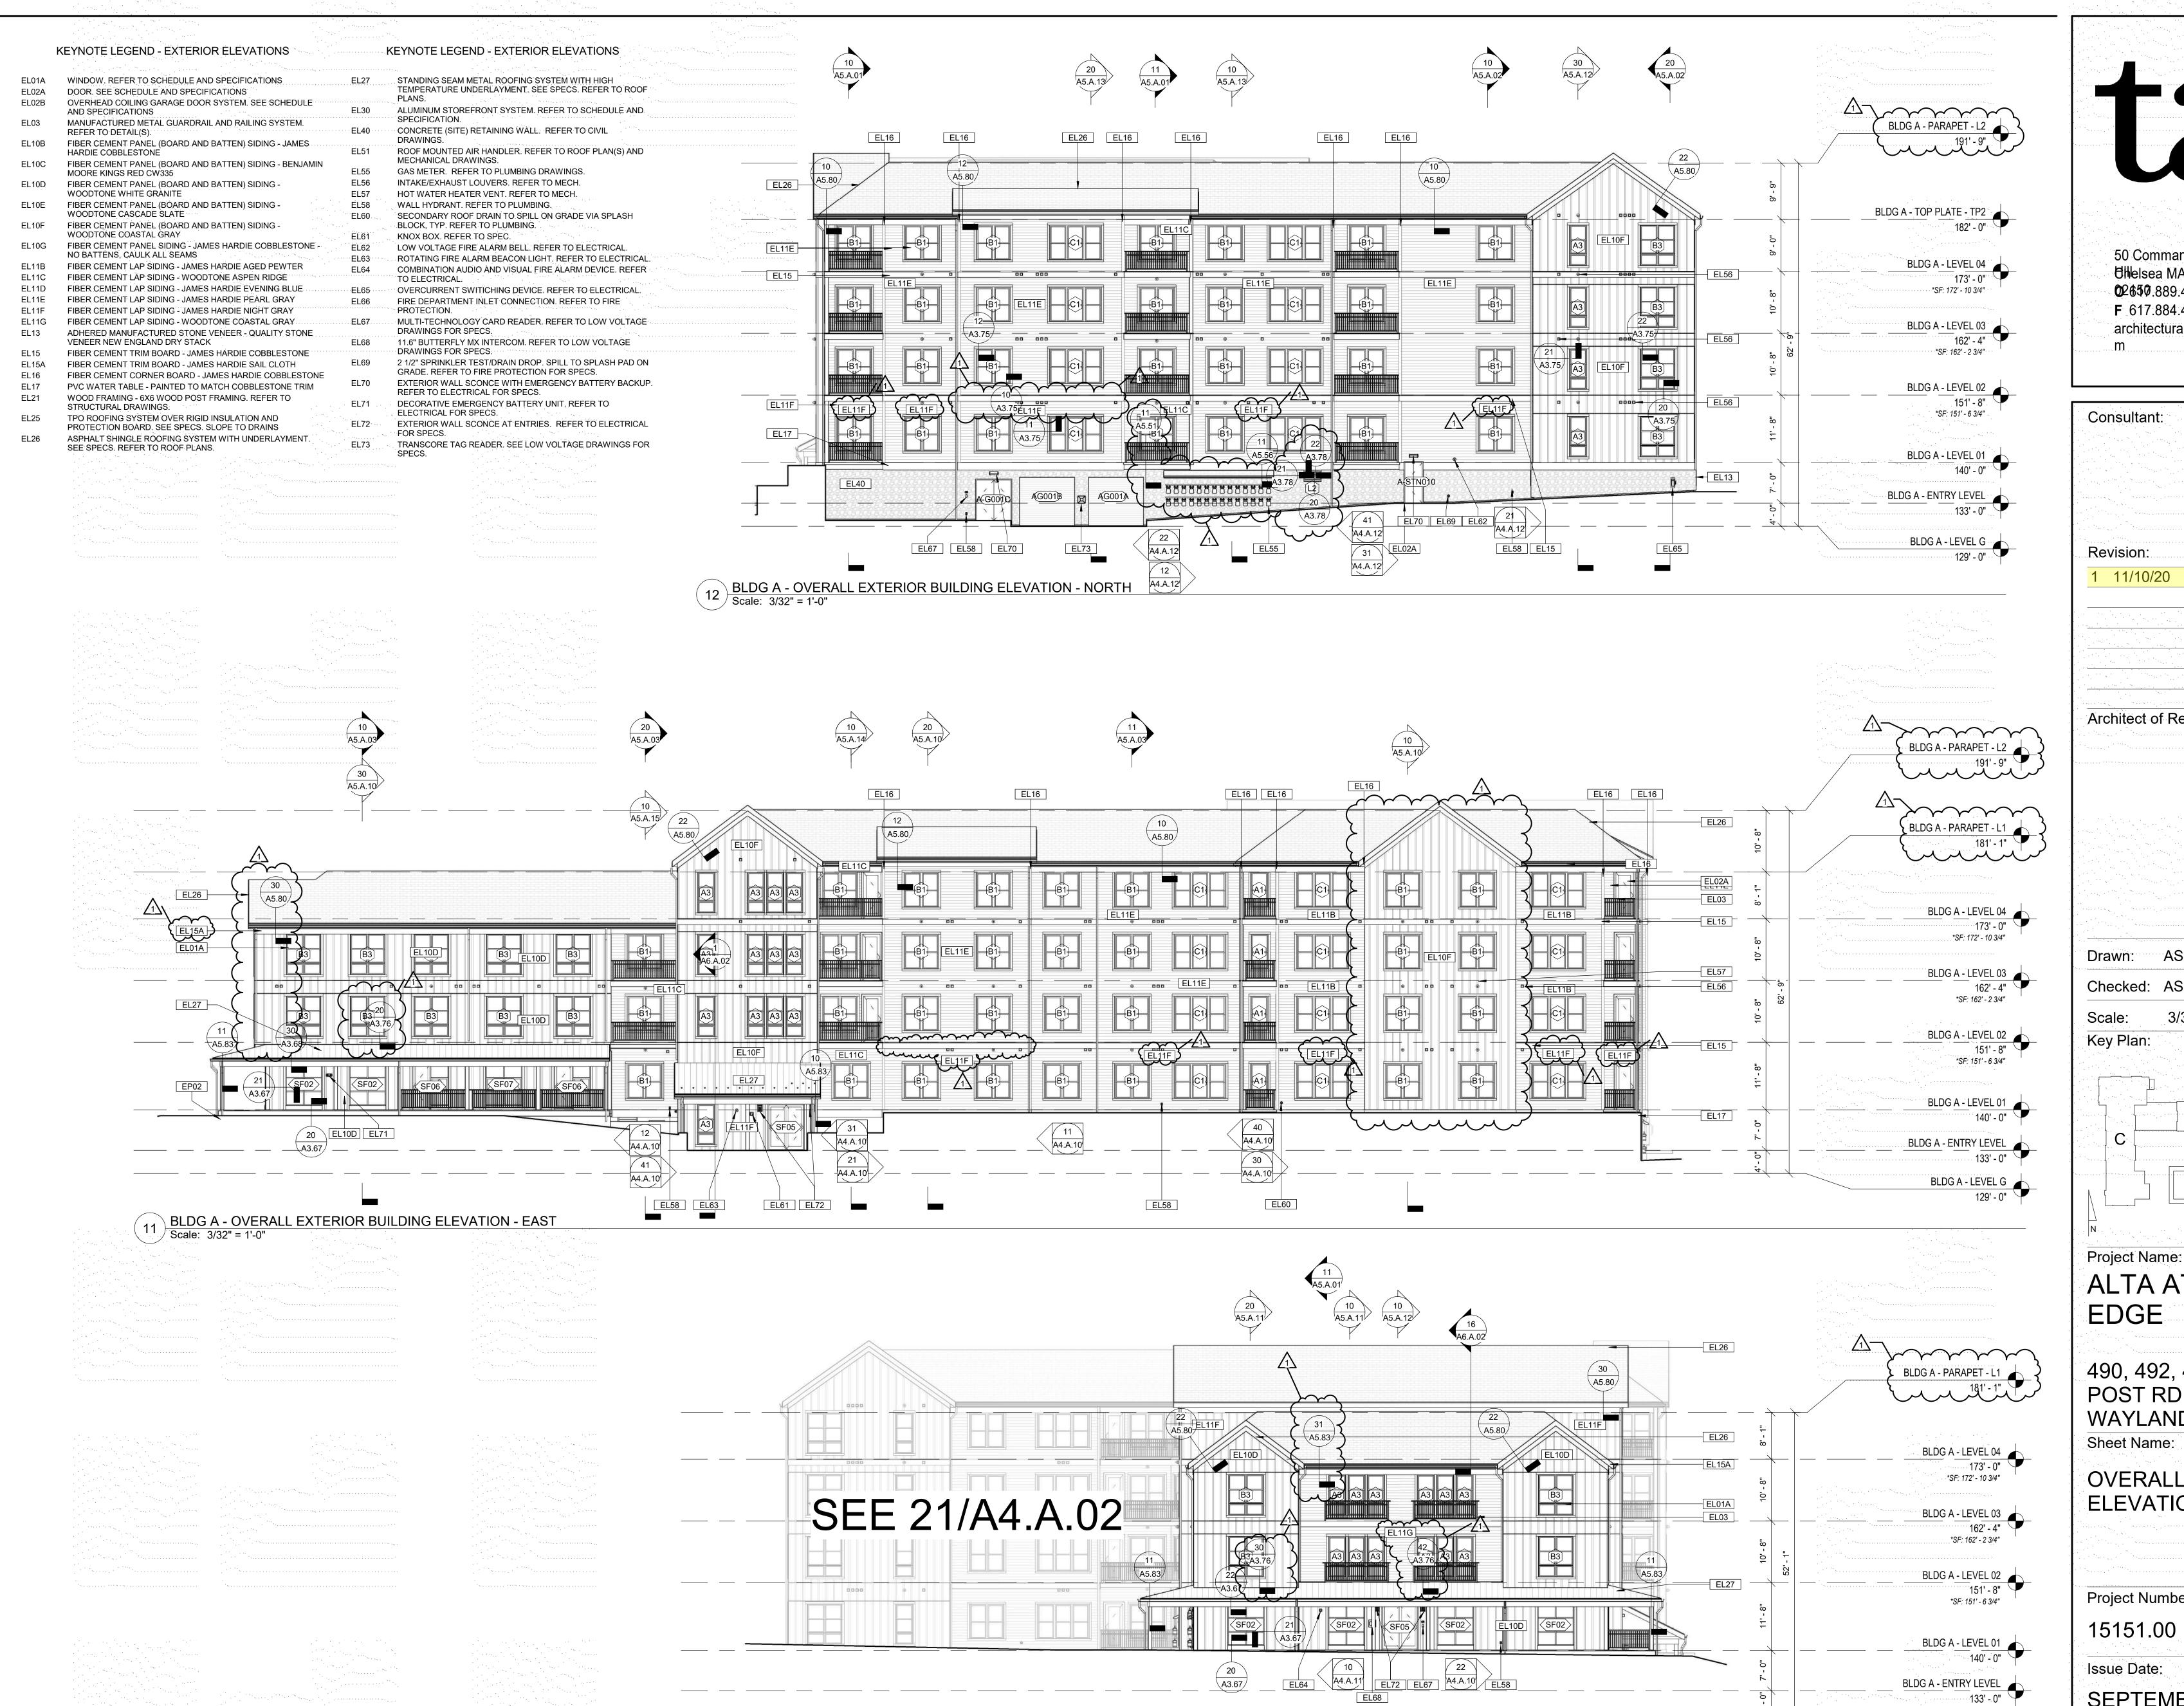
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SEPTEMBER 23, 2020

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BLDG A - OVERALL EXTERIOR BUILDING ELEVATION - SOUTH
Scale: 3/32" = 1'-0"

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Consultant: Revision: 1 11/10/20 ISSUED FOR CONSTR. Architect of Record Drawn: AS Checked: AS 3/32" = 1'-0" Scale: Key Plan: Project Name: ALTA AT RIVER'S

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490, 492, 494 BOSTON POST RD WAYLAND, MA 01778

OVERALL EXTERIOR ELEVATIONS


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Issue Date: **SEPTEMBER 23, 2020**


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BLDG A - ENTRY LEVEL 133' - 0"

BLDG A - LEVEL G 129' - 0"



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50 Commandant's Way at Admiral's

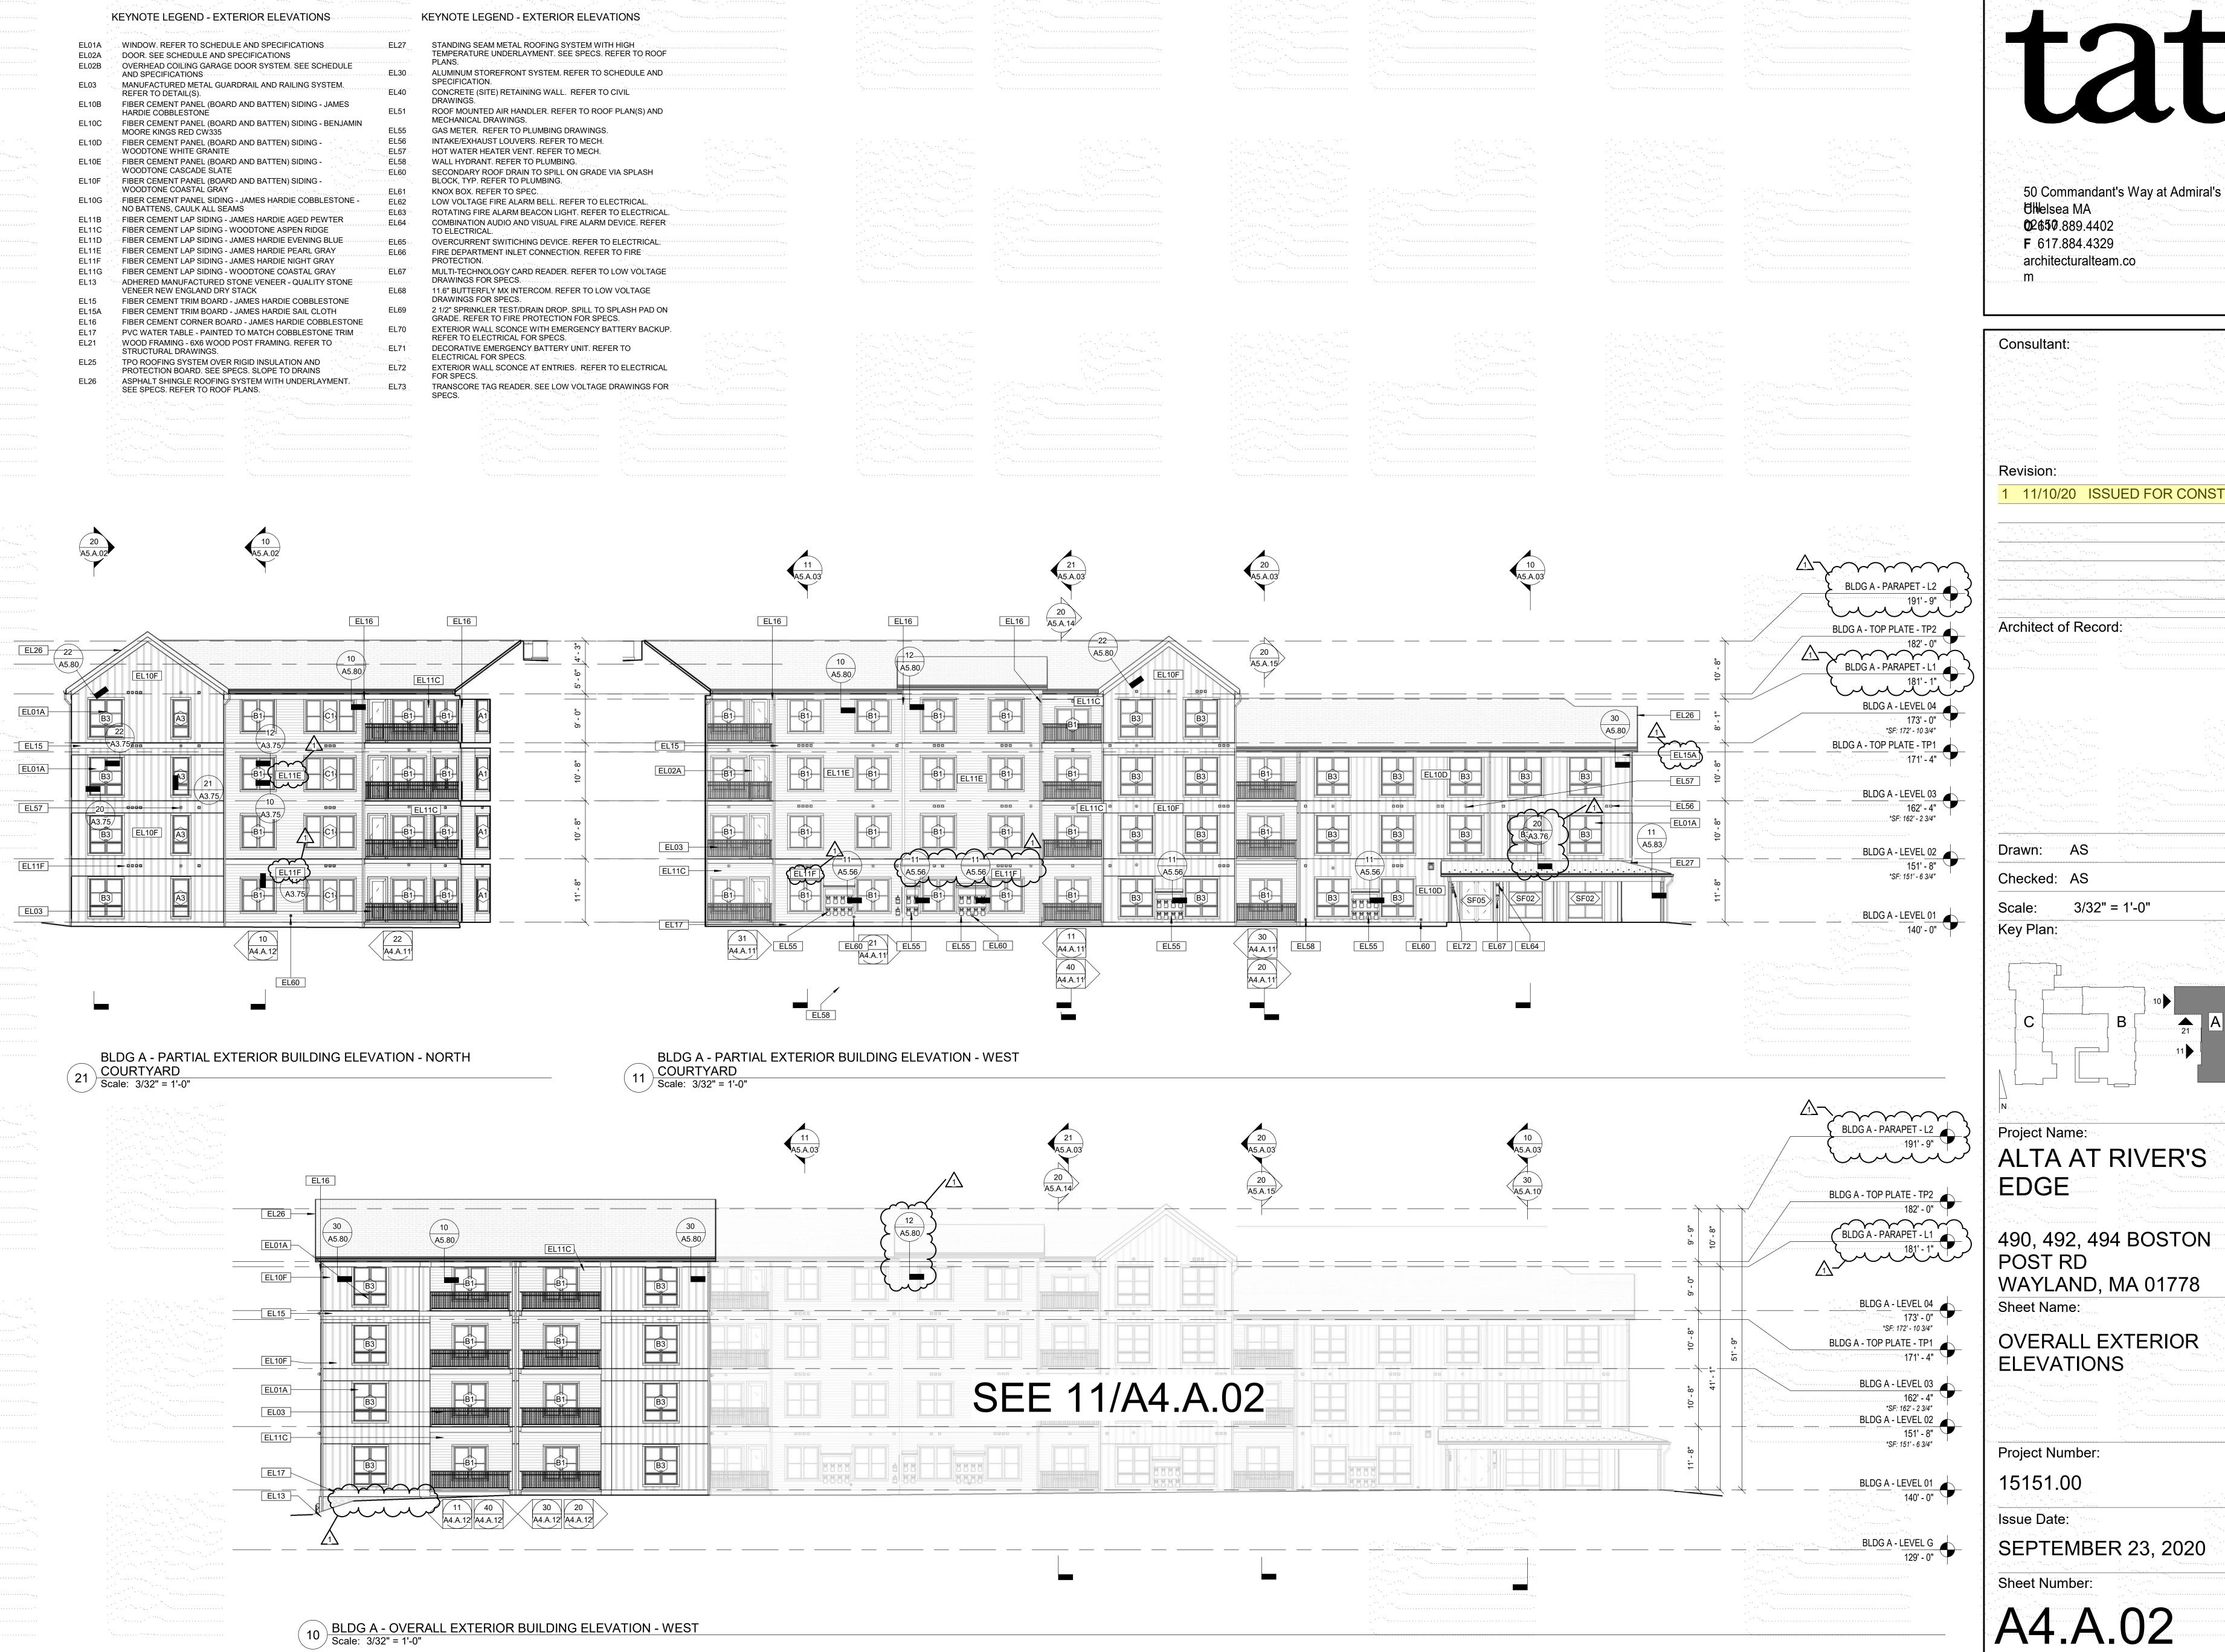
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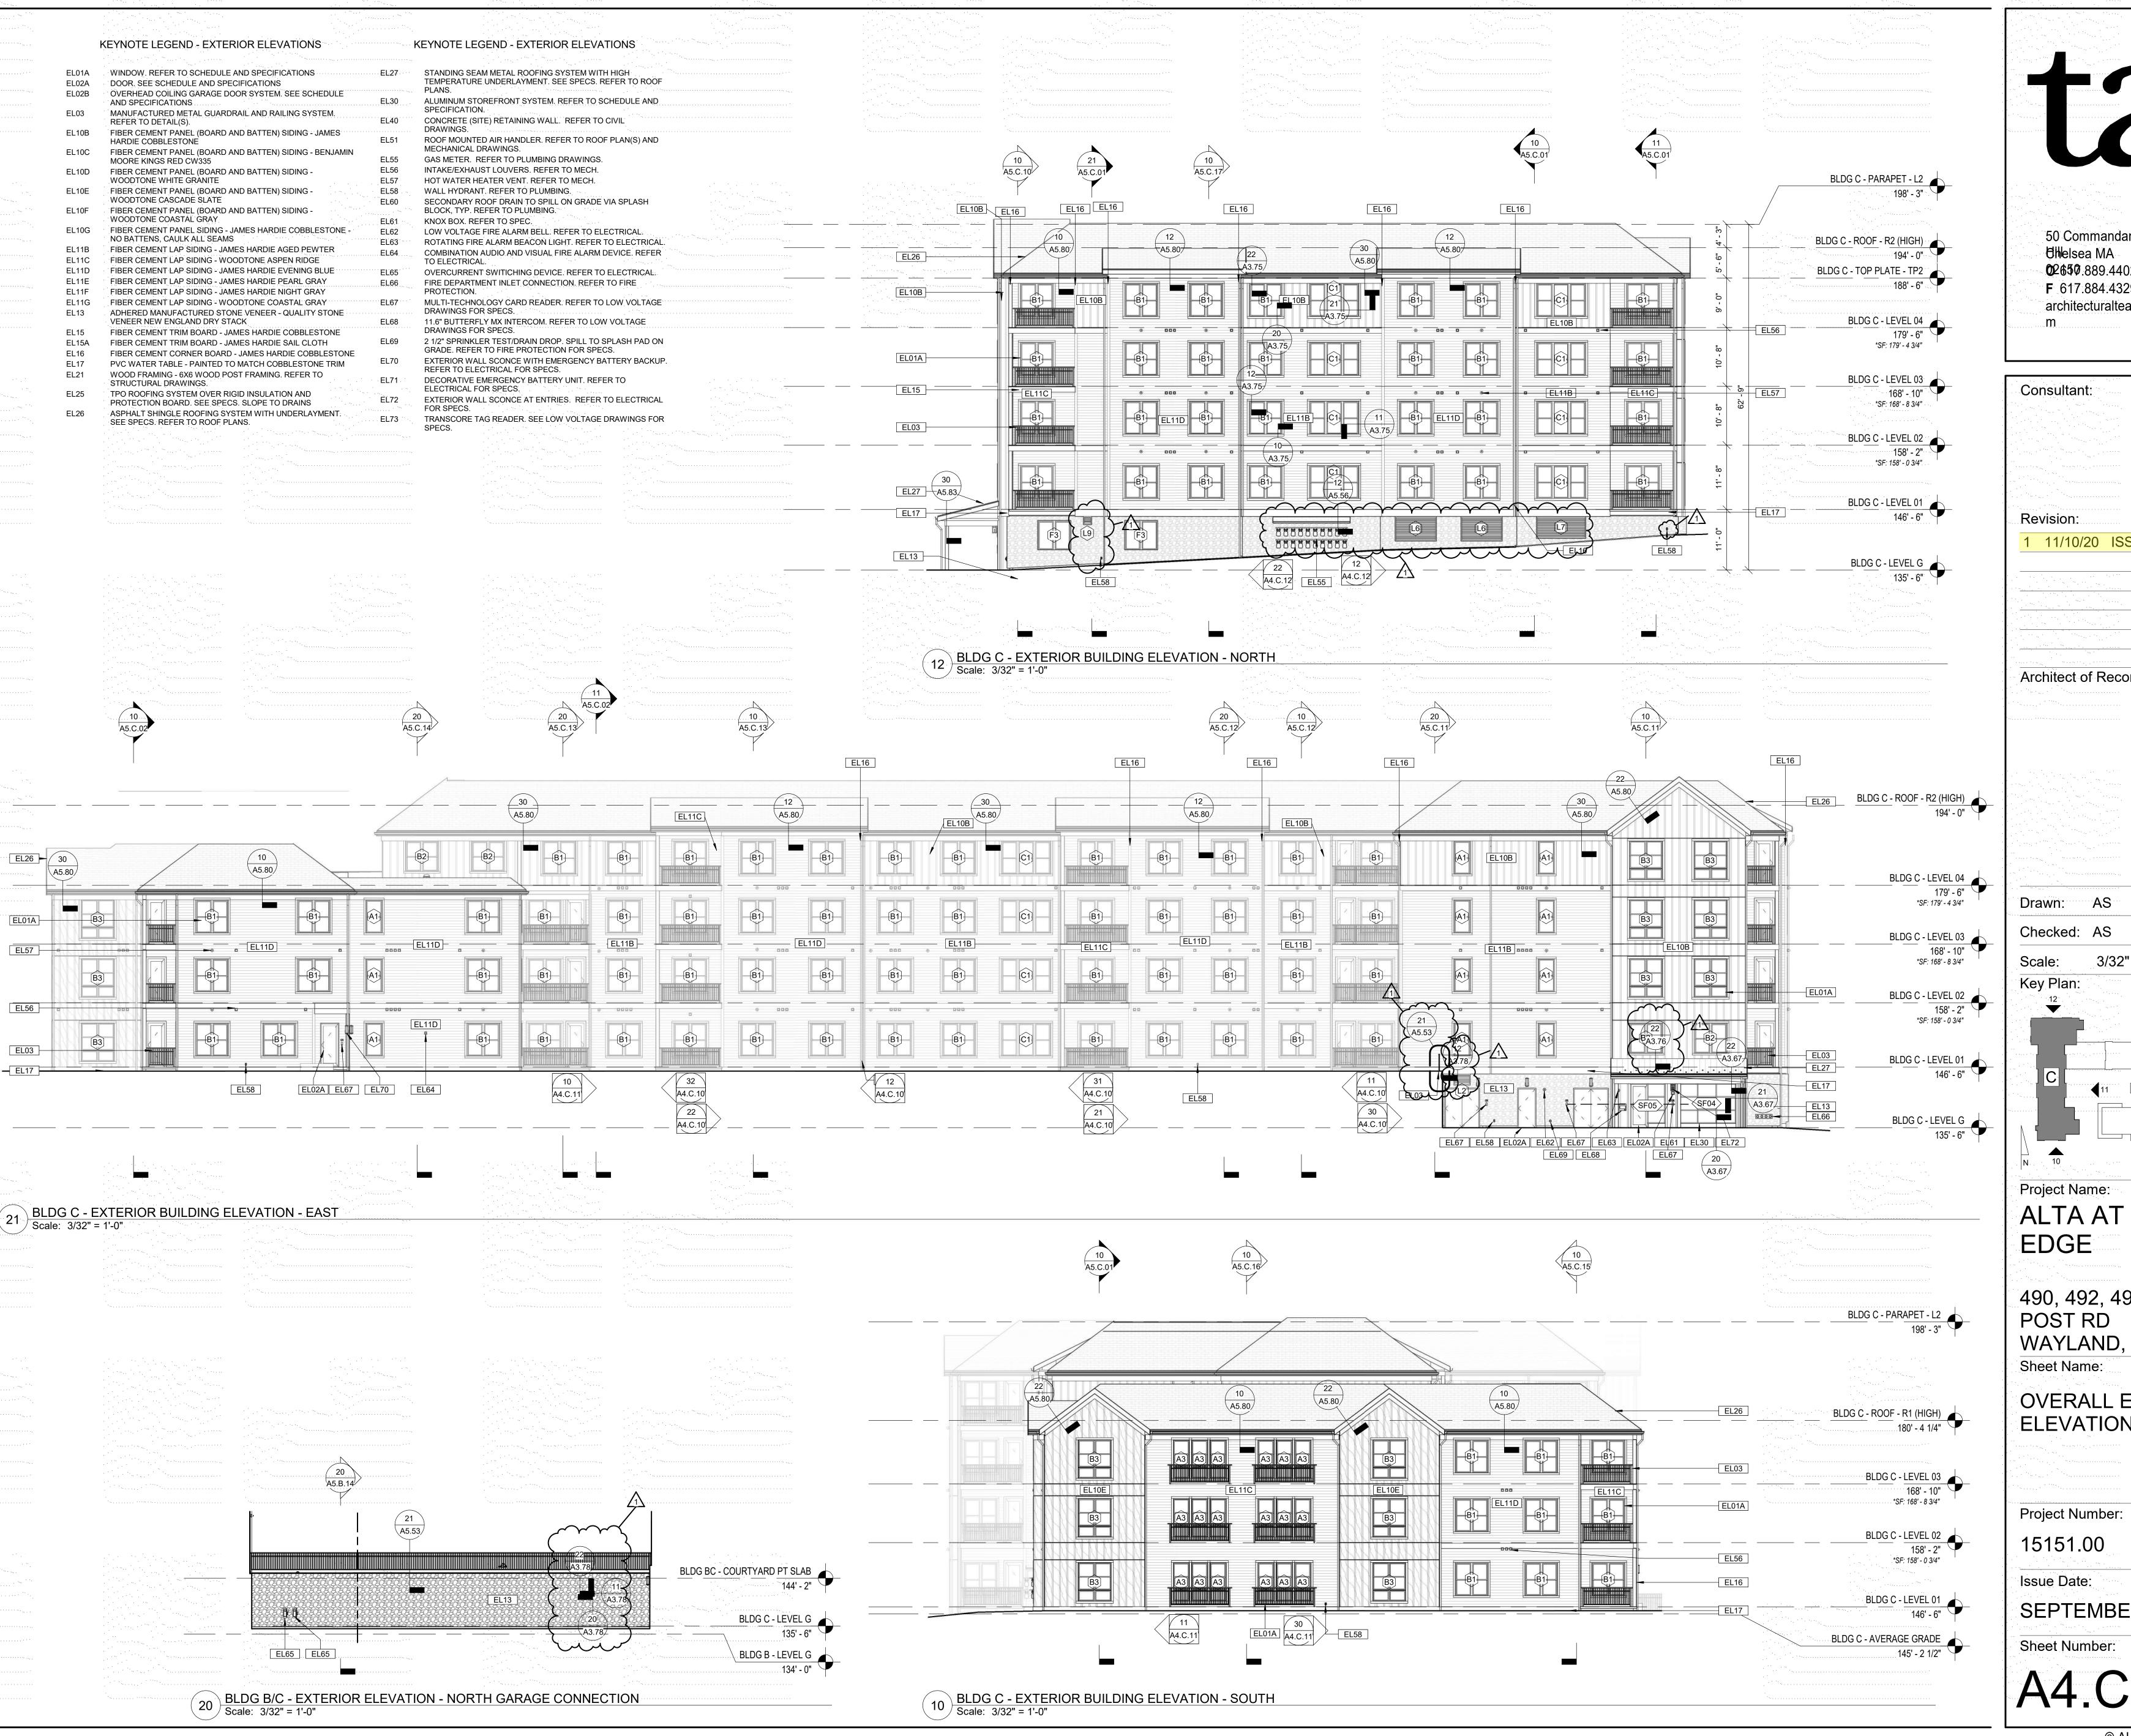
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OVERALL EXTERIOR

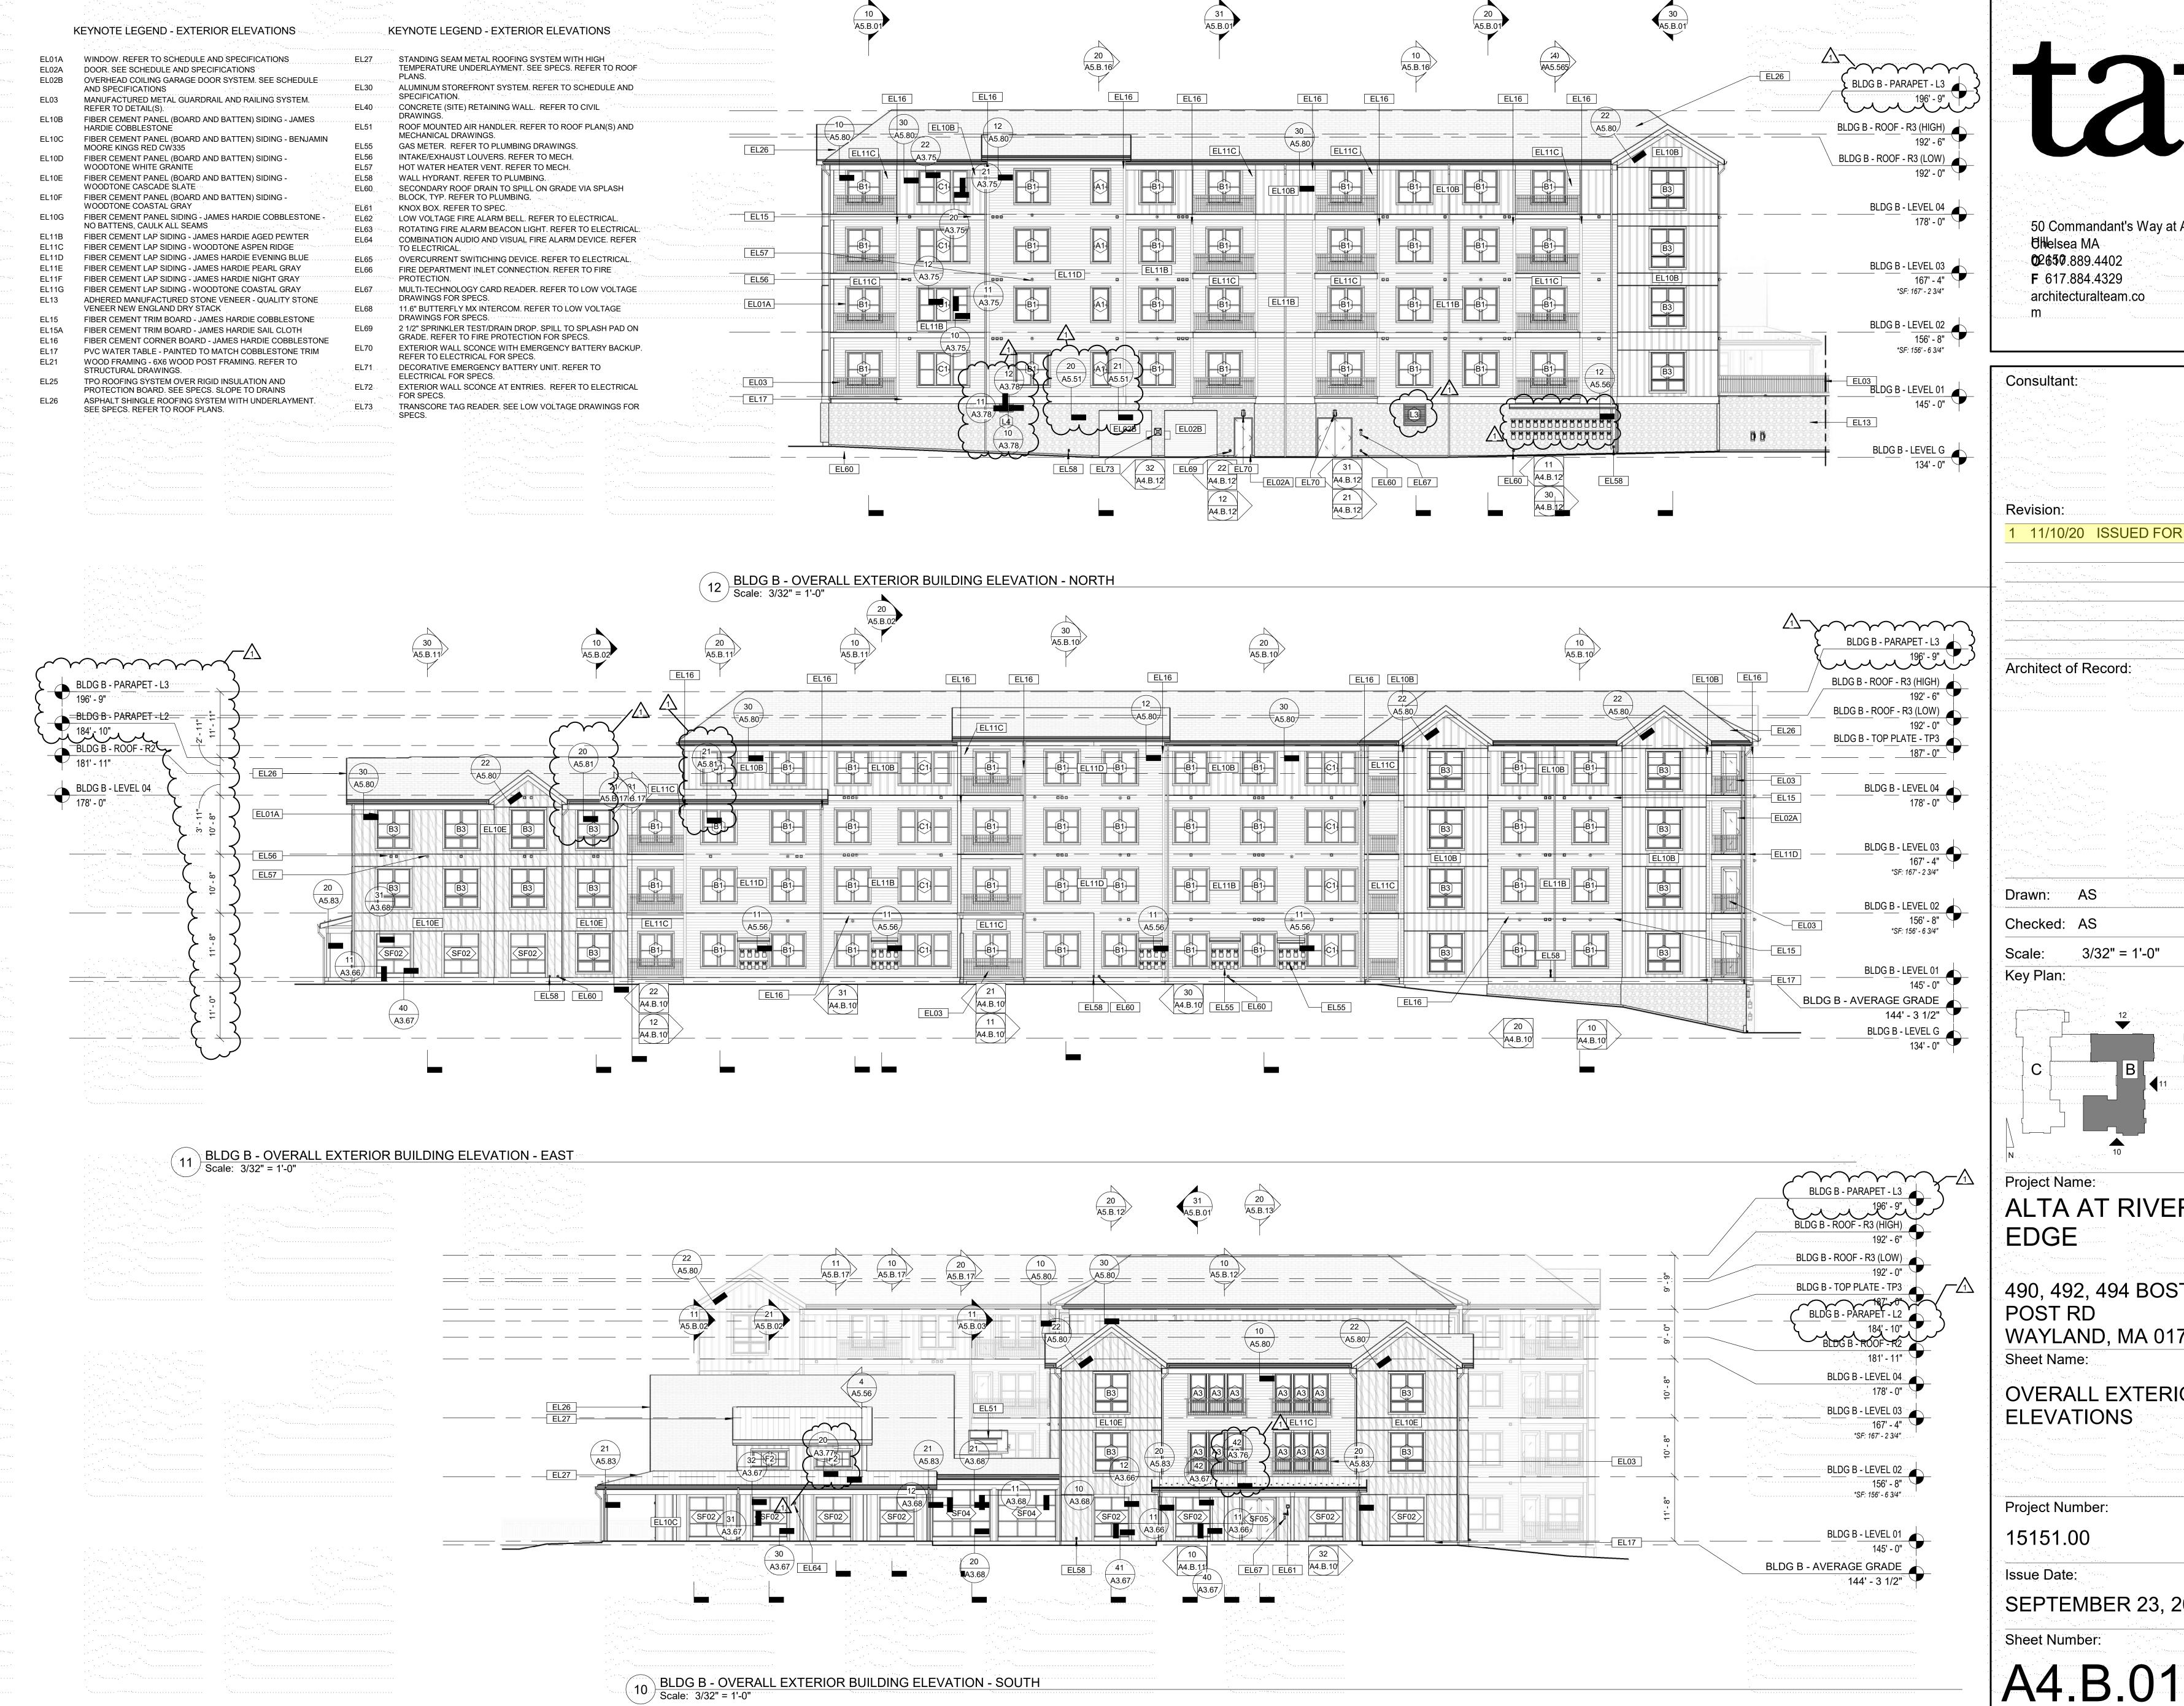SEPTEMBER 23, 2020



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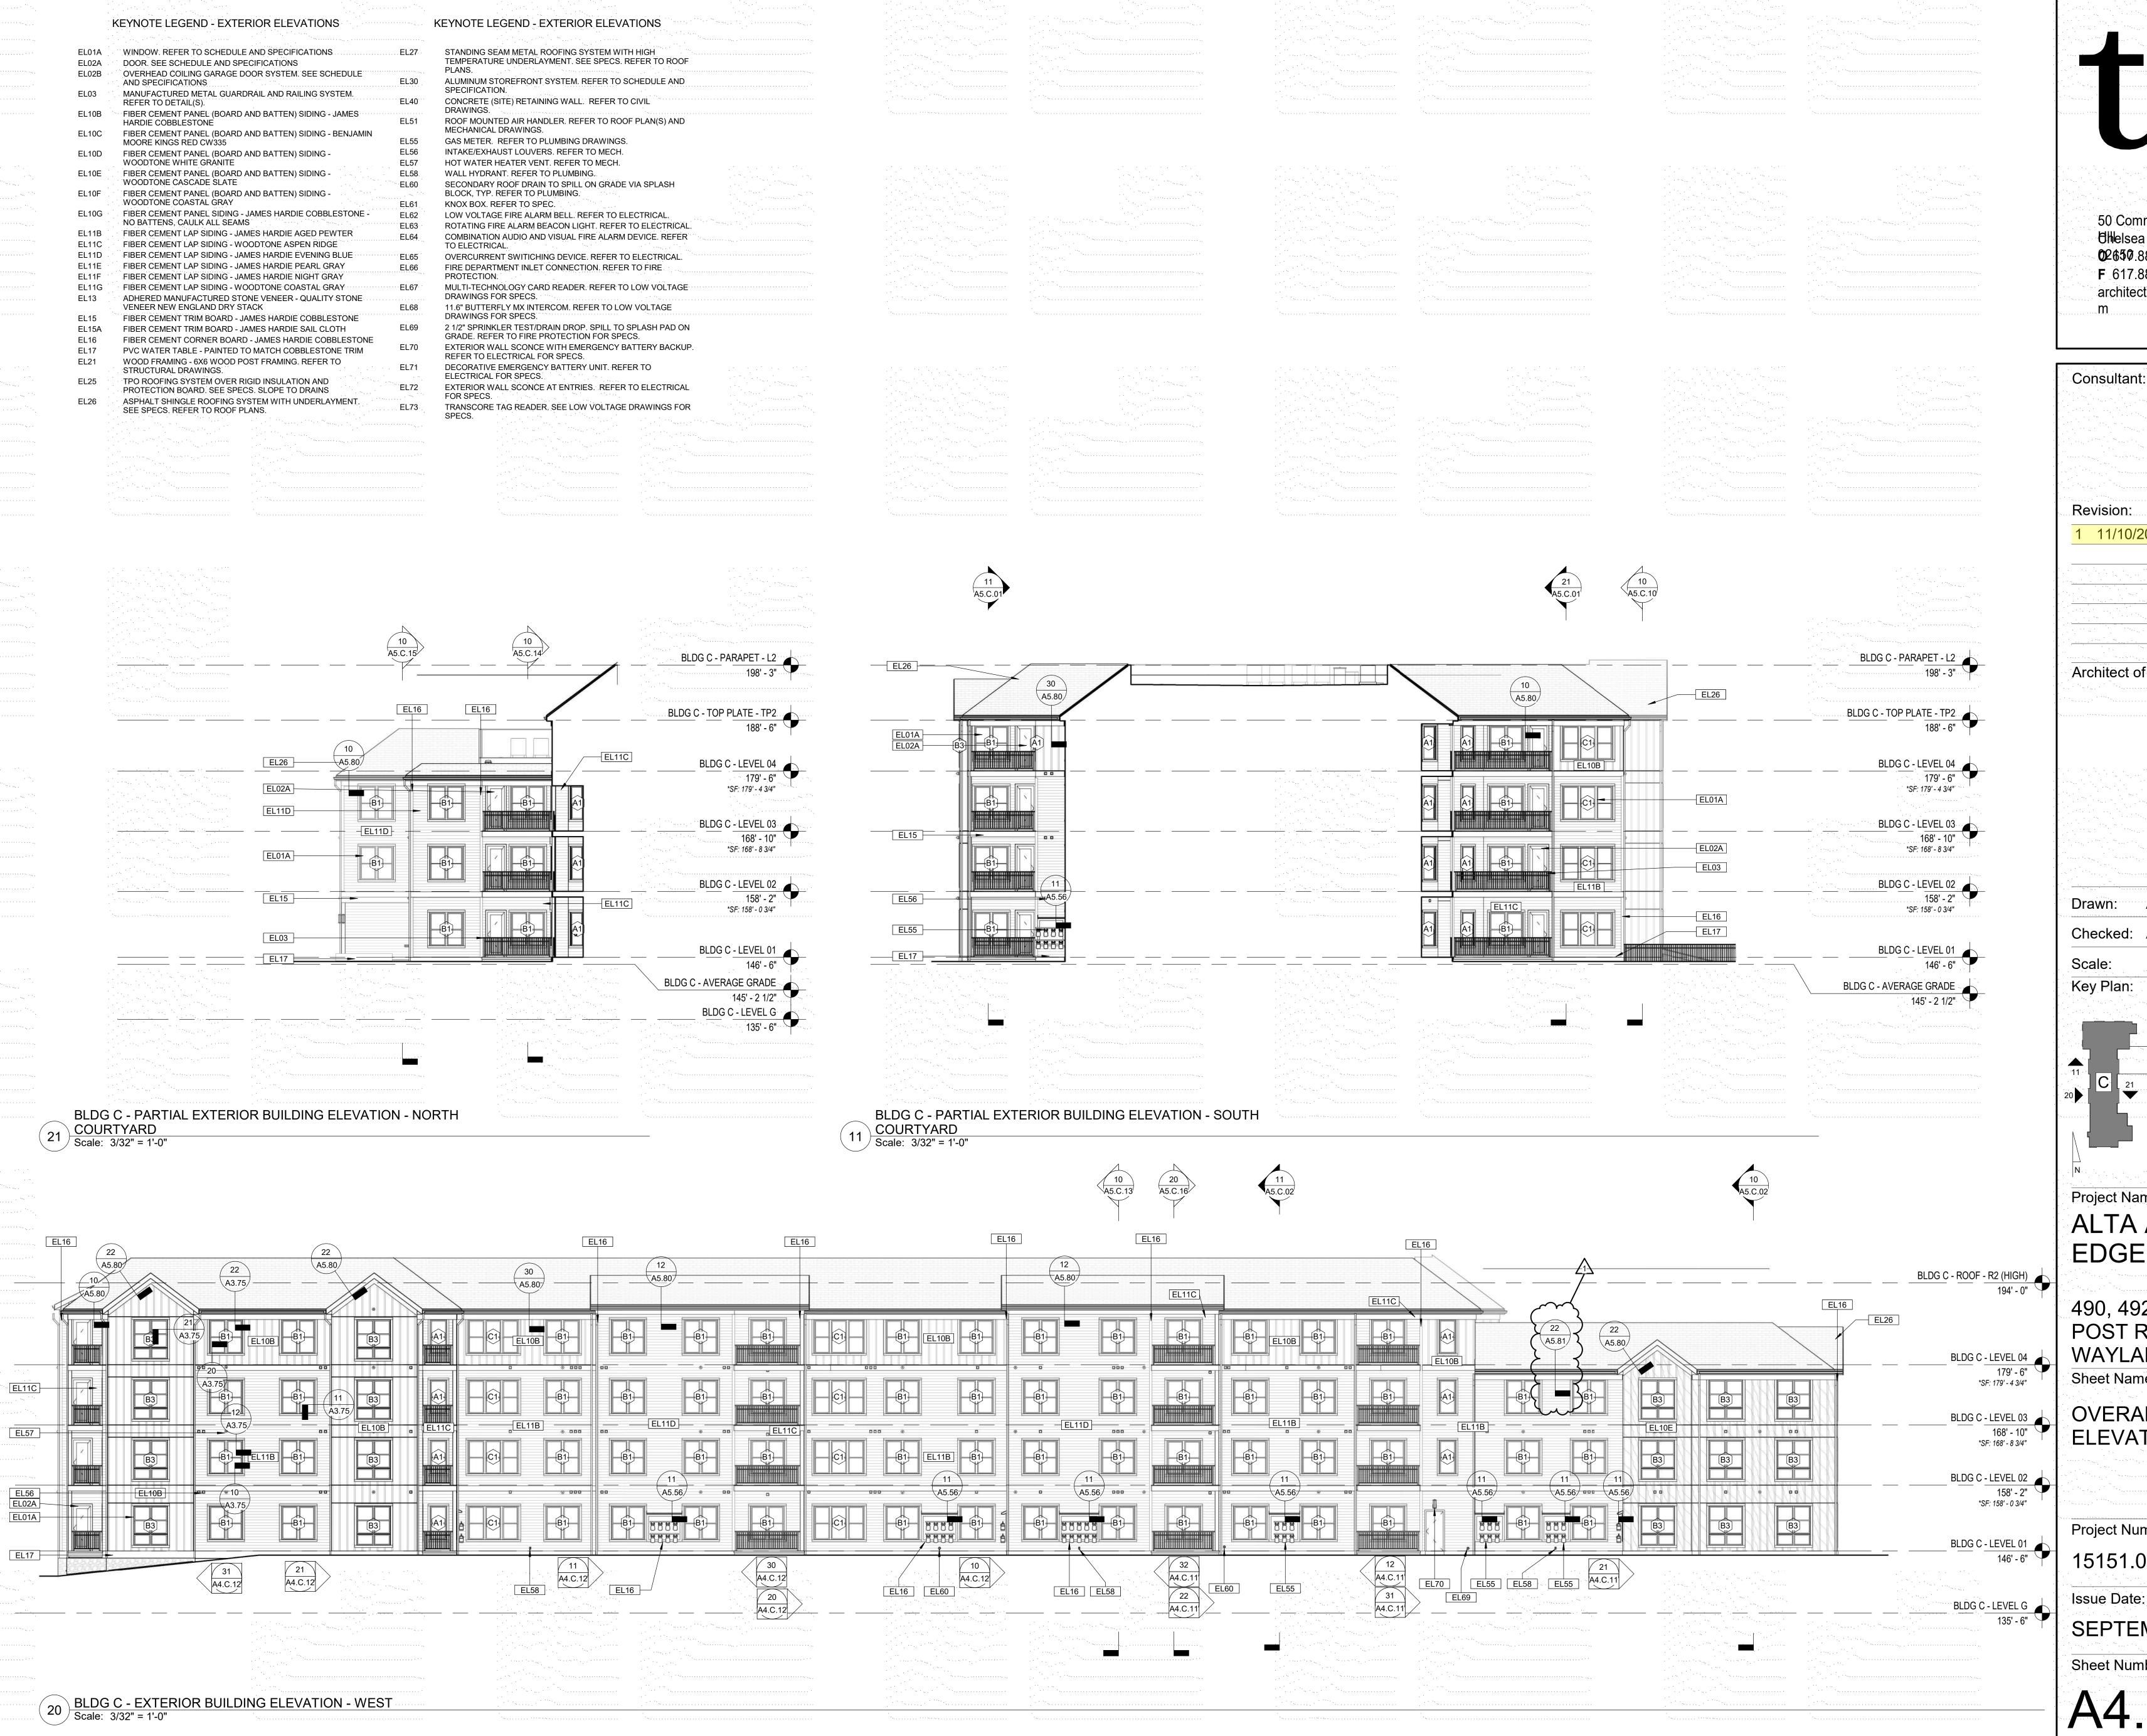
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ALTA AT RIVER'S

490, 492, 494 BOSTON WAYLAND, MA 01778

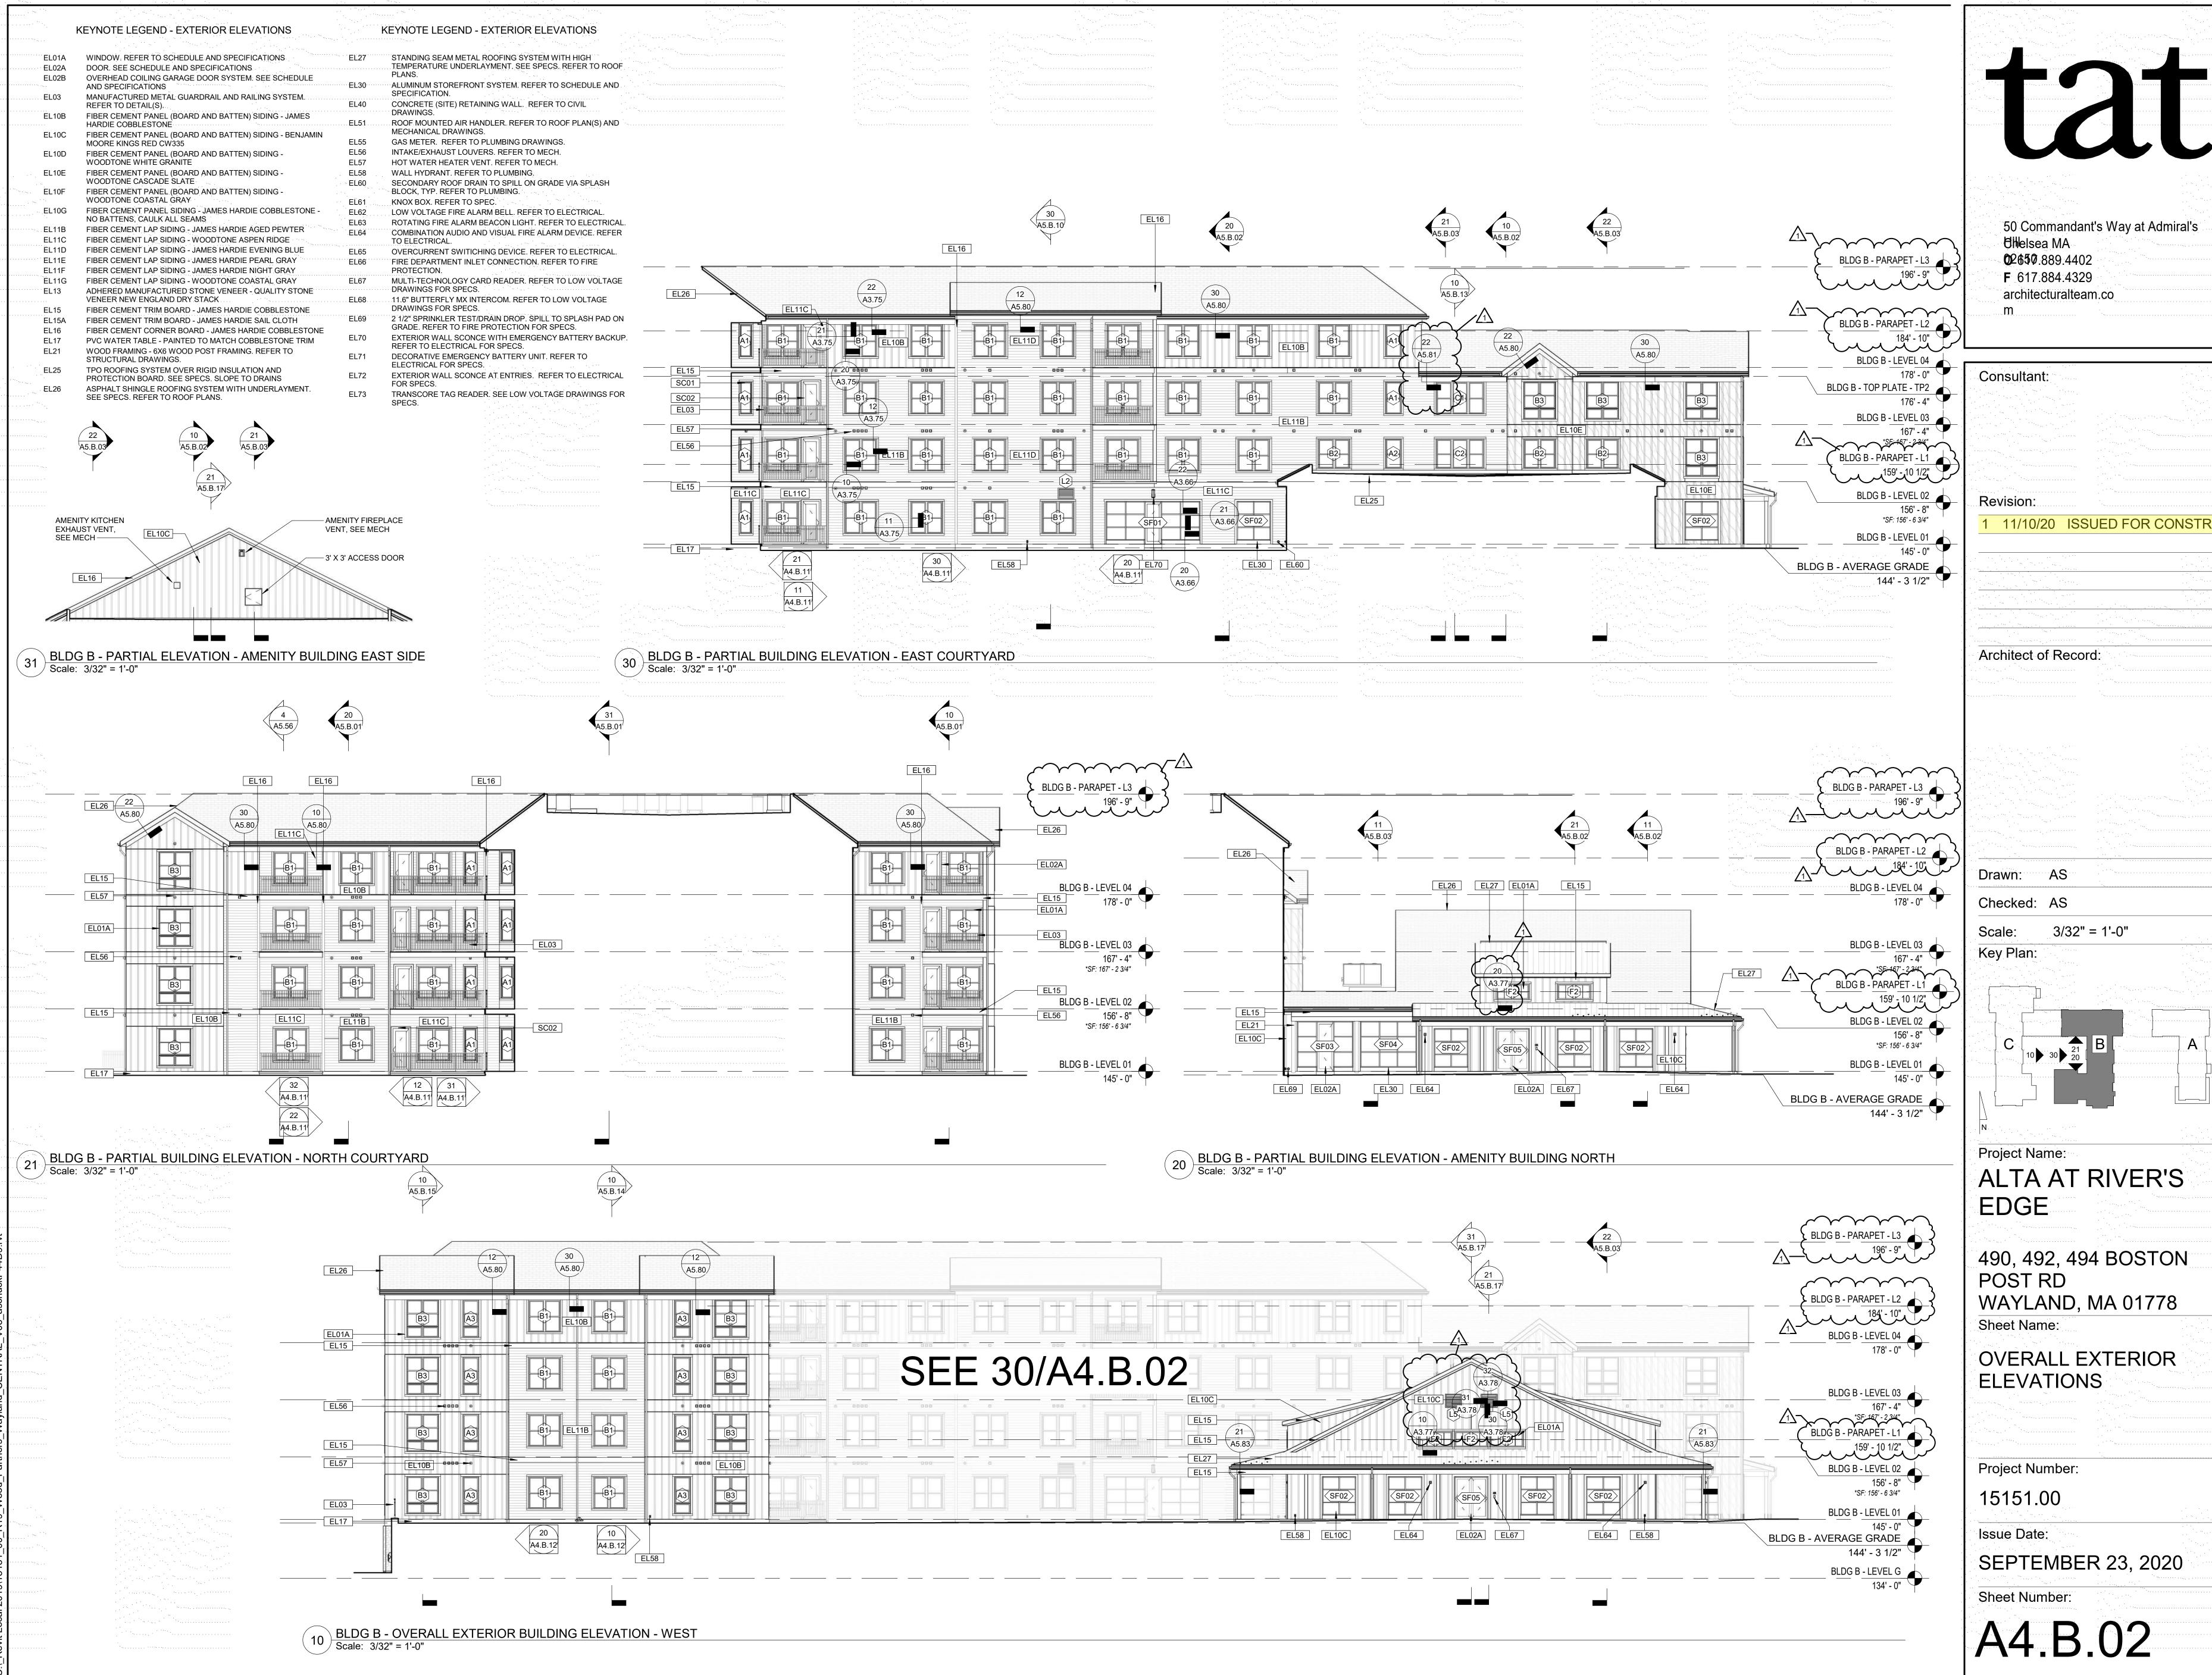OVERALL EXTERIOR ELEVATIONS

SEPTEMBER 23, 2020



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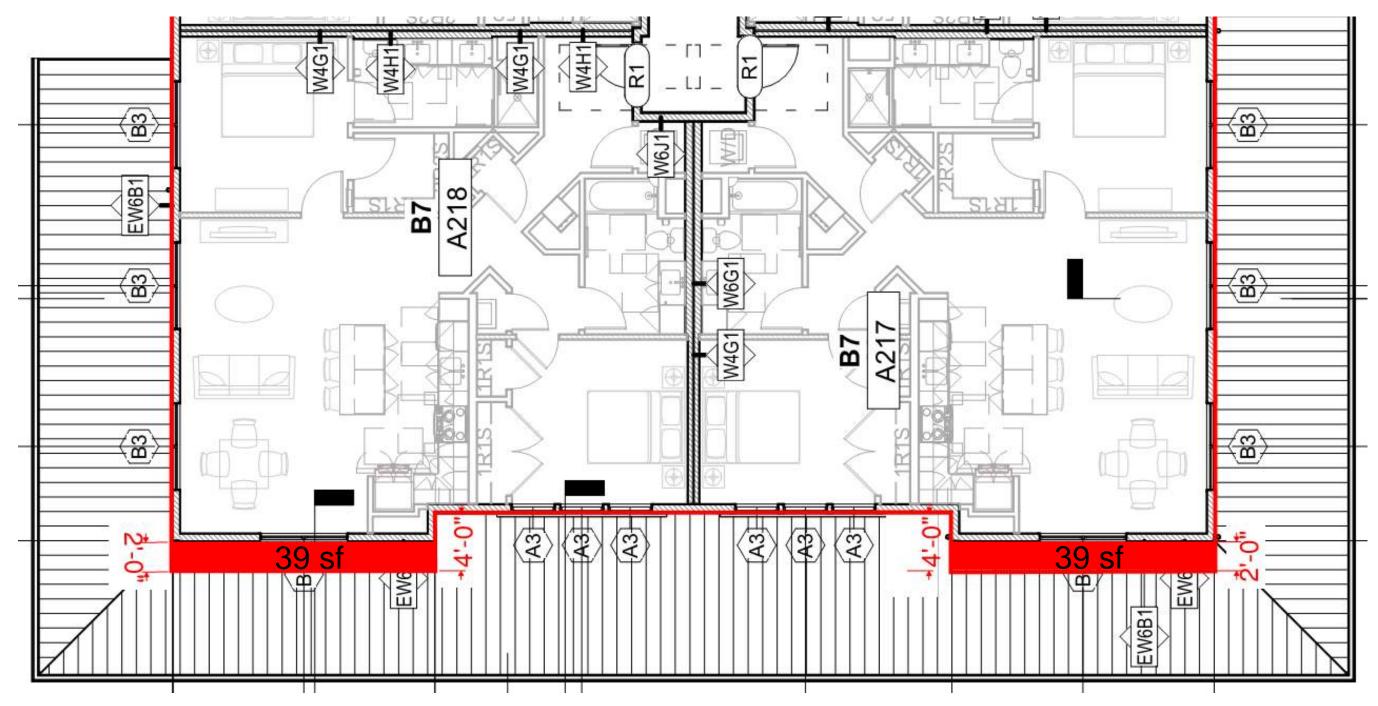
OVERALL EXTERIOR ELEVATIONS

Project Number:

15151.00

SEPTEMBER 23, 2020

Sheet Number:



Building A: South Elevation modifications

Corners bumped out by 2'-0" per DRB request = 156 SF total

Alta at River's Edge, Wayland, MA.

DRB: Proposed Building A Edits 10.13.20



Building A: Main Entry View (8/27/20 DRB meeting)



Building A: Main Entry View (10/1/20 DRB Meeeting)



Building A: Main Entry View (revised 10.13.20)




FINAL: (revised 10.23.20)
Building A: Main Entry View




FINAL: (revised 10.23.20)
Building A: East Facade View



FINAL: (revised 10.23.20)
Building A: North East Corner

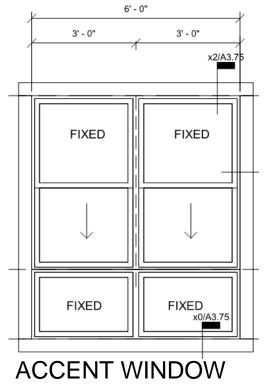



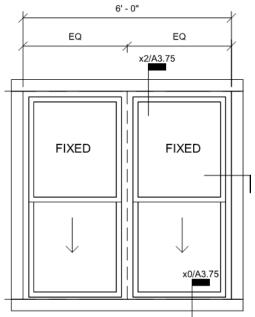







U-Value: .28

SHGC: .28

Low-E w/ Argon



ALTA UNION HOUSE_FRAMINGHAM, MA



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