

LOCUS MAP
NOT TO SCALE

APPLICANT:
WP EAST ACQUISITIONS, LLC
91 HARTWELL AVENUE
LEXINGTON, MA 02421

OWNER: THE TOWN OF WAYLAND 41 COCHITUATE ROAD WAYLAND, MA (508) 358-3627

SITE ENGINEER:
ALLEN & MAJOR ASSOCIATES, INC.
100 COMMERCE WAY, SUITE #5
WOBURN, MA 01801
(781) 935-6889


LAND SURVEYOR:
ALLEN & MAJOR ASSOCIATES, INC.
100 COMMERCE WAY, SUITE #5
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AT ADMIRAL'S HILL
CHELSEA, MA 02150
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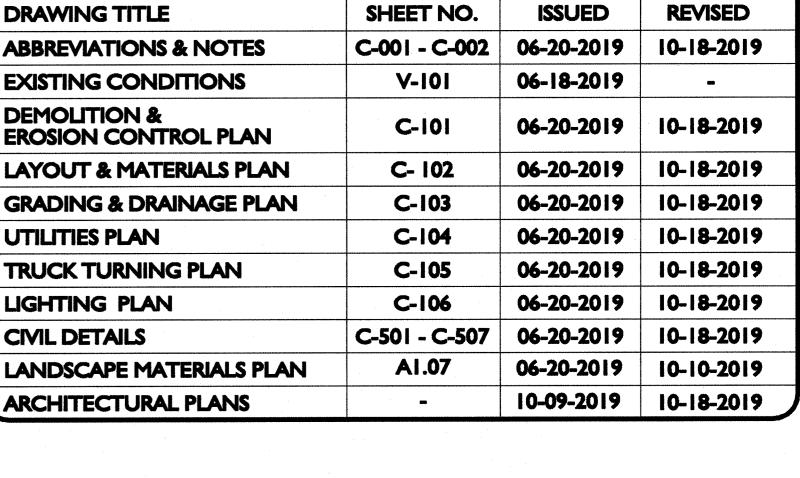
LANDSCAPE ARCHITECT:
COPLEY WOLFF DESIGN GROUP, INC.
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BOSTON, MA 02109
(617) 654-9000

SITE DEVELOPMENT PLANS FOR ALTA at RIVER'S EDGE #490 BOSTON POST ROAD

WAYLAND, MA



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LIST OF DRAWINGS

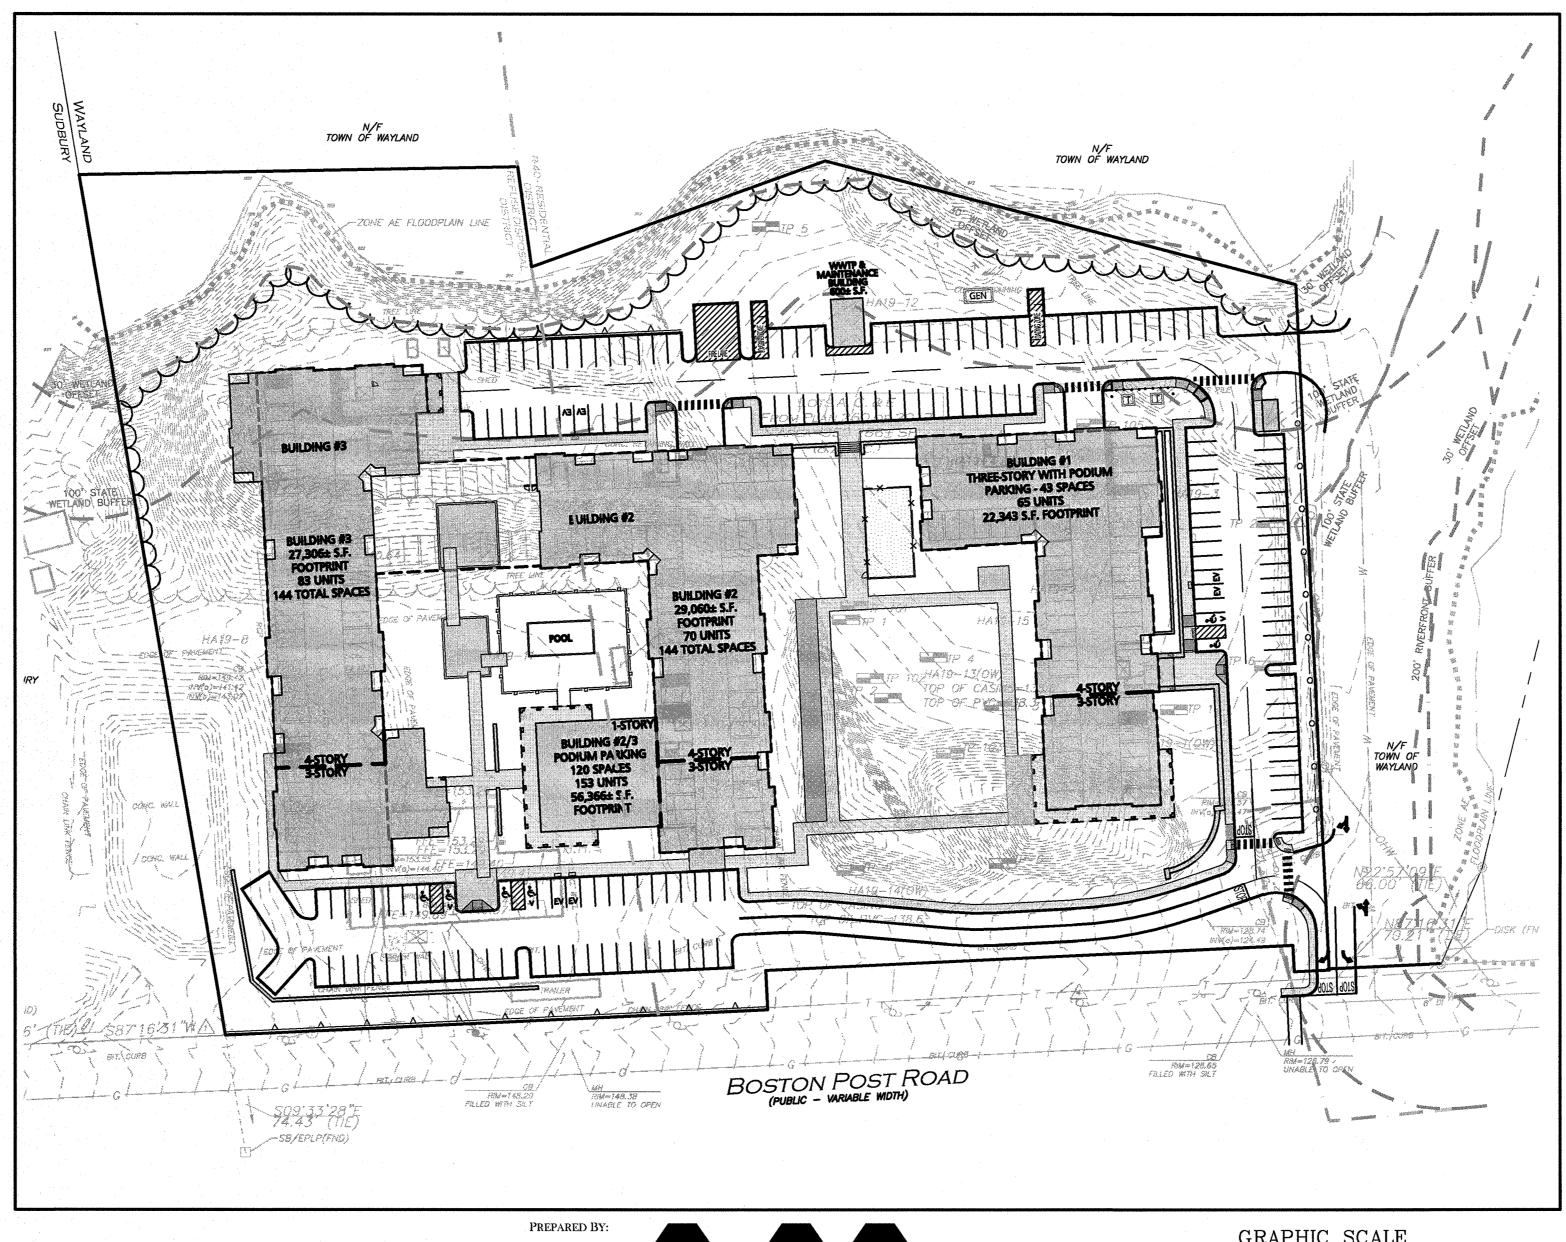

civil & structural engineering ◆ land surveying environmental consulting ◆ landscape architecture w w w w . a l l e n m a j o r . c o m


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WOBURN, MA ◆ LAKEVILLE, MA ◆ MANCHESTER, NH

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ISSUED FOR APPROVAL: JUNE 20, 2019
ISSUED FOR NOTICE OF INTENT: JULY 3, 2019
REVISED PER TOWN COMMENTS: SEPTEMBER 27, 2019
REVISED PER TOWN COMMENTS: OCTOBER 10, 2019
REVISED PER TOWN COMMENTS: OCTOBER 18, 2019

N:\PROJECTS\1670-09A\CIVIL\DRAWINGS\CURRENT\C-1670-09A - COVER.DWG

- 2. ZONING DISTRICT IS RESIDENTIAL ZONE (R40), REFUSE DISPOSAL DISTRICT (REF) WITH RIVER'S EDGE HOUSING OVERLAY DISTRICT (REHOD).
- 3. OVERALL LOT SIZE: 8.25± ACRES OR 359.286± S.F.
- 4. DURING CONSTRUCTION, ALL VEHICLES MUST BE PARKED ON SITE.
- 5. DURING CONSTRUCTION, ALL STAGING AND DELIVERIES WILL OCCUR ON
- THIS PROJECT WILL BE SERVED BY PUBLIC WATER AND PRIVATE NATURAL GAS, TELEPHONE, CABLE AND ELECTRIC. SANITARY SEWER SHALL DISCHARGE TO AN ON-SITE WASTEWATER TREATMENT FACILITY WHICH IS PART OF THE PROPOSED PROJECT. ALL UTILITY LINES WILL BE INSTALLED UNDERGROUND UNLESS OTHERWISE NOTED.
- THE CONTRACTOR IS SPECIFICALLY CAUTIONED THAT THE LOCATION AND/OR ELEVATION OF EXISTING UTILITIES AND STRUCTURES AS SHOWN ON THESE PLANS IS BASED ON RECORDS OF VARIOUS UTILITY COMPANIES AND WHERE POSSIBLE, MEASUREMENTS TAKEN IN THE FIELD. THIS INFORMATION IS NOT TO BE RELIED ON AS BEING EXACT OR COMPLETE. THE LOCATION OF ALL UNDERGROUND UTILITIES AND STRUCTURES SHALL BE VERIFIED IN THE FIELD BY THE CONTRACTOR PRIOR TO THE START OF CONSTRUCTION. THE CONTRACTOR MUST CONTACT THE APPROPRIATE UTILITY COMPANY, ANY GOVERNING PERMITTING AUTHORITY, AND "DIGSAFE" AT LEAST 72 HOURS PRIOR TO ANY EXCAVATION WORK TO REQUEST EXACT FIELD LOCATION OF UTILITIES AND THE ENGINEER SHALL BE NOTIFIED IN WRITING OF ANY UTILITIES INTERFERING WITH THE PROPOSED CONSTRUCTION AND APPROPRIATE REMEDIAL ACTION TAKEN BEFORE PROCEEDING WITH THE WORK. IT SHALL BE THE RESPONSIBILITY OF THE CONTRACTOR TO RELOCATE ALL EXISTING UTILITIES WHICH CONFLICT WITH THE PROPOSED IMPROVEMENTS SHOWN ON THE PLANS AT NO ADDITIONAL COST.
- 8. ALL PROPOSED MAIN BUILDING ENTRANCES AND WALKS SHALL BE HANDICAP ACCESSIBLE PER FEDERAL ADA & MA AAB REGULATIONS.
- 9. ALL SITE WORK DONE FOR THIS PROJECT SHALL BE IN STRICT ACCORDANCE WITH THE SITE PLANS AND SITE WORK SPECIFICATIONS FOR CONSTRUCTION. ONCE PROJECT SPECIFICATIONS ARE AVAILABLE, THE DPW SHALL BE ALLOWED TO REVIEW AND APPROVE THE DOCUMENT.
- 10. ANY DAMAGE TO PRIVATE OR PUBLIC PROPERTIES DUE TO THE CONTRACTOR'S ACTIVITIES SHALL BE REPAIRED AND RESTORED BY THE CONTRACTOR AT THEIR OWN EXPENSE.
- 11. ALL PROPERTY MARKERS AND STREET LINE MONUMENTS SHALL BE PROPERLY PROTECTED DURING CONSTRUCTION. ANY DAMAGE TO THESE ITEMS SHALL BE REPAIRED AND RESTORED BY A SURVEYOR REGISTERED IN THE STATE OF MASSACHUSETTS AT THE CONTRACTOR'S EXPENSE.
- 12. ALL APPLICABLE PERMITS AND AN APPROVED SET OF PLANS SHALL BE AVAILABLE AT THE CONSTRUCTION SITE.
- 13. THE CONTRACTOR IS RESPONSIBLE FOR SCHEDULING A PRE—CONSTRUCTION MEETING THE WITH THE APPROPRIATE TOWN DEPARTMENTS, THE APPROPRIATE UTILITY COMPANIES, THE OWNER AND OWNER'S REPRESENTATIVE. THE MEETING SHALL TAKE PLACE PRIOR TO THE START OF CONSTRUCTION AND THE CONTRACTOR MUST PROVIDE 48 HOURS NOTICE TO ALL ATTENDEES PRIOR TO THE START OF THE MEETING.
- 14. APPROPRIATE WARNING SIGNS, MARKERS, BARRICADES AND/OR FLAG MEN SHALL BE PROVIDED TO REGULATE TRAFFIC. CONSTRUCTION TRAFFIC CONTROLS SHALL BE IMPLEMENTED AND OPERATED ACCORDING TO THE MASS DEPARTMENT OF TRANSPORTATION, THE MANUAL ON UNIFORM TRAFFIC CONTROL DEVICES (MUTCD) AND THE LOCAL AUTHORITY. THE CONTRACTOR SHALL COORDINATE WITH THE MASS—DOT AND THE WAYLAND POLICE DEPARTMENT REGARDING THE USE OF FLAG—MEN IN THE RIGHT—OF—WAY.
- 15. THE CONTRACTOR IS RESPONSIBLE FOR OBTAINING ADDITIONAL BENCHMARK INFORMATION IF REQUIRED. THE CONTRACTOR IS RESPONSIBLE FOR LOCATING AND PROTECTING ALL EXISTING BENCHMARKS. IF IT IS NECESSARY TO RELOCATE A BENCHMARK, IT SHALL BE RELOCATED BY A MASSACHUSETTS PROFESSIONAL LAND SURVEYOR AND DONE SO AT THE CONTRACTOR'S EXPENSE.
- 16. ALL BUILDING DIMENSIONS ARE MEASURED TO THE OUTSIDE FACE OF THE
- 17. ALL RADII ARE 3 FEET UNLESS OTHERWISE NOTED.
- 18. ALL PARKING LOT AND AISLE DIMENSIONS ARE TAKEN FROM THE FACE OF CURB AND INDICATE EDGE OF PAVEMENT.
- 19. CONSTRUCTION DURING WET WEATHER OR WINTER CONDITIONS IS TO BE ANTICIPATED AND PROVISIONS TO ADEQUATELY ADDRESS THESE CONDITIONS SHALL BE THE RESPONSIBILITY OF THE CONTRACTOR AT NO ADDITIONAL COST.
- 20. THE CONTRACTOR IS RESPONSIBLE FOR OBTAINING AND PAYING FOR ANY PERMITS AND/OR CONNECTION FEES REQUIRED TO CARRY OUT THE WORK INCLUDING BUT NOT LIMITED TO DEMOLITION.
- 21. DISPOSAL OF ALL DEMOLISHED MATERIALS INCLUDING EXISTING MISC.
 CONSTRUCTION DEBRIS IS THE RESPONSIBILITY OF THE CONTRACTOR AND
 MUST BE DISPOSED OF OFF—SITE IN ACCORDANCE WITH ALL FEDERAL,
 STATE, AND LOCAL MUNICIPAL REQUIREMENTS AT NO ADDITIONAL COST.
- 22. ALL DISTURBED AREAS NOT NOTED TO RECEIVE OTHER TREATMENT ARE TO RECEIVE SIX INCHES (6") MINIMUM OF TOPSOIL & SEED, AND BE MAINTAINED UNTIL ESTABLISHED & ACCEPTED.
- 23. EXISTING STRUCTURES WITHIN CONSTRUCTION LIMITS ARE TO BE PROTECTED, ABANDONED, REMOVED OR RELOCATED AS NECESSARY.
- 4. CONTRACTOR SHALL BE RESPONSIBLE FOR ALL RELOCATIONS, INCLUDING BUT NOT LIMITED TO, ALL UTILITIES, STORM DRAINAGE, SIGNS, & POLES, ETC. AS REQUIRED. ALL WORK SHALL BE IN ACCORDANCE WITH THE LOCAL MUNICIPALITY'S GOVERNING AUTHORITY'S SPECIFICATIONS AND SHALL BE APPROVED BY SAME.
- 25. THE CONTRACTOR SHALL COORDINATE WITH ALL UTILITY COMPANIES TO DETERMINE EXACT POINT OF SERVICE CONNECTION AND DISCONNECTION AT EXISTING UTILITY.
- 26. ALL ELEVATIONS SHOWN ARE IN REFERENCE TO THE BENCHMARKS SHOWN ON THE EXISTING CONDITIONS SITE PLAN AND MUST BE VERIFIED BY THE GENERAL CONTRACTOR AT GROUNDBREAKING.

- 27. CONTRACTOR IS RESPONSIBLE FOR DIGGING TEST HOLES AND VERIFYING ANY EXISTING UTILITY OR STRUCTURE PRIOR TO CONSTRUCTION.

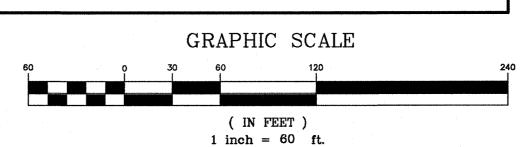 CONTRACTOR SHALL VERIFY THAT BASED ON EXACT LOCATION OF EXISTING UTILITIES, THERE ARE NO CONFLICTS BETWEEN THE EXISTING AND THE PROPOSED UTILITIES/DRAINAGE STRUCTURES.
- 28. THE CONTRACTOR SHALL ADHERE TO ALL PERMIT CONDITIONS PROVIDED BY ALL GOVERNING AGENCIES AT NO ADDITIONAL COSTS. THIS INCLUDES BUT IS NOT LIMITED TO BUILDING PERMITS, DEMOLITION PERMITS, PLUMBING, GAS, AND ELECTRICAL PERMITS. PERMITS FROM THE PLANNING BOARD OR TOWN COUNCIL.
- 29. DURING EXCAVATION, ANY EXISTING EARTH CUT MATERIALS THAT DO NOT MEET THE "ORDINARY FILL" SPECIFICATIONS OR "LOAM" SPECIFICATIONS AND CANNOT BE REUSED SHALL BE REMOVED OFFSITE BY THE CONTRACTOR AT NO ADDITIONAL COST TO THE OWNERS. MATERIAL WHICH DOES NOT MEET THE SPECIFICATION INCLUDES ALL BOULDERS, ROCKS, CONSTRUCTION DEBRIS, AND MISC. MATERIAL. PRIOR TO REUSE, CONTRACTOR TO PROVIDE TESTING REPORT OF SIEVE ANALYSIS TO ENGINEER FOR APPROVAL. CONTRACTOR CAN AMEND MATERIALS AND CONTINUE TO RETEST AS NECESSARY AT NO ADDITIONAL COST TO OWNER. AFTER AMENDING, IF MATERIAL STILL DOES NOT MEET THE SPECIFICATIONS, IT IS TO BE REMOVED FROM SITE AT NO ADDITIONAL COST TO THE OWNER AND IN ACCORDANCE WITH ALL FEDERAL, STATE, AND LOCAL LAWS AND REGULATIONS.
- 30. ANY PROPOSED SIGNAGE SHALL BE APPROVED BY SEPARATE APPLICATION TO THE APPROPRIATE MUNICIPAL AUTHORITY INCLUDING BUT NOT LIMITED TO THE ZONING BOARD OF APPEALS AND TOWN COUNCIL, ALL PROPOSED SIGNAGE MUST MEET THE REQUIREMENTS OF THE LOCAL ZONING CODE.

GRADING & DRAINAGE NOTES:

- 1. EXISTING PAVEMENT SHALL BE SAW—CUT AND PAVEMENT JOINT SHALL BE INSTALLED WHERE NECESSARY TO ENSURE A SMOOTH CONTINUOUS GRADE.
- 2. ALL GRADING OPERATIONS SHALL BE COORDINATED WITH THE APPROPRIATE UTILITY COMPANIES.
- 3. IN LANDSCAPED AREAS THE TOP ELEVATION OF MANHOLES SHALL MATCH THE FINISH GRADE OF THE TOPSOIL. IN PAVED AREAS THE TOP ELEVATIONS OF MANHOLES SHALL MATCH FINISH GRADE.
- 4. ALL AREAS DISTURBED DURING CONSTRUCTION SHALL BE STABILIZED AS SOON AS POSSIBLE UPON COMPLETION OF CONSTRUCTION WORK IN THE
- 5. TEMPORARY TUBULAR BARRIER PROTECTION AND/OR SILT SACKS SHALL BE INSTALLED AND MAINTAINED AT EXISTING DRAINAGE STRUCTURES DURING CONSTRUCTION, TO PREVENT SEDIMENT LADEN RUNOFF FROM ENTERING THE DRAINAGE SYSTEM.
- 6. CONTRACTOR IS RESPONSIBLE FOR DEMOLITION OF EXISTING STRUCTURES INCLUDING REMOVAL OF ANY EXISTING UTILITIES SERVING THE STRUCTURE PER DEMOLITION PLAN.
- 7. ALL CATCH BASINS, MANHOLES, INFILTRATION SYSTEMS, AND WATER QUALITY STRUCTURES ARE TO BE CLEANED TO REMOVE ALL CONSTRUCTION SILT AND DEBRIS PRIOR TO FINAL APPROVAL.
- 8. IF ANY EXISTING UTILITY STRUCTURES TO REMAIN ARE DAMAGED DURING CONSTRUCTION, IT SHALL BE THE CONTRACTOR'S RESPONSIBILITY TO REPAIR AND/OR REPLACE THE EXISTING STRUCTURE AS NECESSARY TO RETURN IT TO EXISTING CONDITIONS OR BETTER AT NO ADDITIONAL COST.
- 9. ALL STORM PIPES ENTERING STRUCTURES SHALL BE GROUTED TO ENSURE CONNECTION AT STRUCTURE IS WATERTIGHT.
- 10. ALL STORM DRAIN MANHOLES SHALL HAVE TRAFFIC BEARING RING & COVERS & SHALL BE LABELED "DRAIN".
- 11. THE CONTRACTOR SHALL ADHERE TO ALL TERMS & CONDITIONS AS OUTLINED IN THE GENERAL N.P.D.E.S. PERMIT FOR STORM WATER DISCHARGE ASSOCIATED WITH CONSTRUCTION ACTIVITIES.
- 12. CONTRACTOR SHALL ENSURE POSITIVE DRAINAGE AWAY FROM BUILDINGS FOR ALL NATURAL AND PAVED AREAS.
- 13. CONTRACTOR SHALL APPLY STABILIZATION FABRIC TO ALL SLOPES STEEPER
- 14. ALL DRAINAGE SYSTEM COMPONENTS SHALL CONFORM TO LOCAL REQUIREMENTS.

UTILITY NOTES:

- 1. THE LATEST STANDARDS OF THE LOCAL MUNICIPALITY SHALL BE FOLLOWED WHEN INSTALLING ANY STORM DRAIN WORK. STORM DRAIN WORK WILL BE INSPECTED BY THE LOCAL GOVERNING AUTHORITY PERSONNEL AND ALL COSTS SHALL BE THE RESPONSIBILITY OF THE CONTRACTOR.
- 2. WHERE AN EXISTING UTILITY IS FOUND TO CONFLICT WITH THE PROPOSED WORK, THE LOCATION, ELEVATION AND SIZE OF THE UTILITY SHALL BE ACCURATELY DETERMINED WITHOUT DELAY BY THE CONTRACTOR, AND THE INFORMATION FURNISHED TO THE ENGINEER FOR RESOLUTION.
- 3. ABANDONED EXISTING UTILITIES AND UTILITIES TO BE ABANDONED SHALL EITHER BE ABANDONED IN PLACE AS NOTED OR SHALL BE REMOVED AND DISPOSED OF AS SPECIFIED. ALL UTILITIES SCHEDULED FOR ABANDONMENT OR REMOVAL AND DISPOSAL MUST BE COORDINATED BY THE CONTRACTOR WITH THE RESPECTIVE UTILITY OWNER. WHEN ABANDONED UTILITIES ARE TO BE LEFT IN PLACE, PLUG OR CAP THE ENDS OF THE CONDUITS AND PIPES. REMOVE ABANDONED UTILITY MANHOLES, JUNCTION BOXES AND SIMILAR STRUCTURES TO A MINIMUM DEPTH OF 4 FEET BELOW FINISHED GRADE AND PUNCTURE OR BREAK THE BOTTOM SLABS OF MANHOLES AND SIMILAR STRUCTURE TO ALLOW DRAINAGE. BACKFILL AND COMPACT EXCAVATIONS RESULTING FROM REMOVAL OF UTILITY FACILITATES, AS REQUIRED TO RESTORE THE ORIGINAL GRADE.
- 4. THE CONTRACTOR SHALL MAKE ARRANGEMENTS FOR THE ALTERATION AND ADJUSTMENTS OF NATURAL GAS, ELECTRIC, TELEPHONE AND ANY OTHER UTILITY BY THE UTILITY OWNER.
- THE CONTRACTOR SHALL USE THE FOLLOWING PIPE MATERIALS:
 DRAIN HDPE (HIGH DENSITY CORRUGATED POLYETHYLENE PIPE WITH SMOOTH INNER WALL), ASTM D2321 (UNLESS OTHERWISE SPECIFIED ON PLAN)
- SEWER PVC (POLYVINYL CHLORIDE), SDR 35
 WATER C.L.D.I. (CEMENT-LINED DUCTILE IRON)
- 8. BEFORE UTILITY WORK BEGINS, THE CONTRACTOR WILL COORDINATE WITH THE LOCAL MUNICIPALITY FOR THE APPROPRIATE PERMIT AND INSPECTION FEES

9. A MINIMUM OF 10 FEET CLEAR HORIZONTALLY SHALL BE MAINTAINED BETWEEN WATER MAINS AND SANITARY SEWER MAINS AND/OR STORM DRAINS. WHENEVER CONDITIONS PREVENT A LATERAL SEPARATION OF 10 FEET TO A WATER MAIN, THE WATER MAIN SHALL BE LAID IN A SEPARATE TRENCH AND THE DIFFERENCE IN ELEVATION BETWEEN THE WATER MAIN

10. ALL FILL MATERIAL IS TO BE IN PLACE, AND COMPACTED BEFORE INSTALLATION OF PROPOSED UTILITIES.

AND THE SEWER MAIN SHALL BE AT LEAST 18 INCHES.


- 11. CONTRACTOR SHALL NOTIFY THE UTILITY AUTHORITY'S INSPECTORS 72 HOURS BEFORE CONNECTING TO ANY EXISTING LINE.
- 12. MINIMUM TRENCH WIDTH SHALL BE 2 FEET.
- 13. CONTRACTOR SHALL MAINTAIN A MINIMUM OF 5'-0" COVER AND A MAXIMUM OF 8'-0" COVER ON ALL WATERLINES.
- 14. IN THE EVENT OF A VERTICAL CONFLICT BETWEEN WATERLINES, SANITARY LINES, STORM LINES AND GAS LINES (EXISTING AND PROPOSED), THE SANITARY LINE SHALL BE DUCTILE IRON PIPE WITH MECHANICAL JOINTS AT LEAST 10 FEET ON BOTH SIDES OF CROSSING, THE WATERLINE SHALL HAVE MECHANICAL JOINTS WITH APPROPRIATE THRUST BLOCKING AS REQUIRED TO PROVIDE A MINIMUM OF 18" CLEARANCE BETWEEN THE PIPES. WHERE THE WATERLINE IS LESS THAN THE 18" VERTICAL CLEARANCE AND MEETING 10' HORIZONTAL CLEARANCE CANNOT BE MET, THE WATER MUST BE ENCASED IN CONCRETE.
- 15. ALL CONCRETE FOR ENCASEMENTS SHALL HAVE A MINIMUM 28 DAY COMPRESSION STRENGTH OF 3000 P.S.I.
- 16. CONTRACTOR IS RESPONSIBLE FOR COMPLYING WITH THE SPECIFICATIONS OF THE LOCAL AUTHORITIES WITH REGARDS TO MATERIALS AND INSTALLATION OF THE WATER, SEWER, GAS AND ELECTRICAL AND TELECOMMUNICATIONS LINES.
- 17. ALL NECESSARY INSPECTIONS AND/OR CERTIFICATIONS REQUIRED BY CODES AND/OR UTILITY SERVICE COMPANIES SHALL BE PERFORMED PRIOR TO ANNOUNCED BUILDING POSSESSION AND THE FINAL CONNECTION OF SERVICE
- 18. DRAWINGS DO NOT NECESSARILY SHOW ALL EXISTING UTILITIES.

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ABAN ADJ	ABANDON ADJUST	L LB LP	LENGTH LEACHING BASIN LIGHT POLE
B BC BIT BCB BLDG BM BOS BOW	BORING BOTTOM OF CURB BITUMINOUS BITUMINOUS CONCRETE BERM BUILDING BENCH MARK BOTTOM OF SLOPE BOTTOM OF WALL	MAT MAX MH MIN MISC MTD MW	MATERIAL MAXIMUM MANHOLE MINIMUM MISCELLANEOUS MOUNTED MONITORING WELL
BRK BV&B BVW	BRICK BUTTERFLY VALVE & BOX BORDERING VEGETATED WETLAND	N NIC NO NTS	NORTH NOT IN CONTRACT NUMBER NOT TO SCALE
CATV CB CF CFS CI CL CLDI	CABLE TELEVISION CATCH BASIN CUBIC FEET CUBIC FEET PER SECOND CAST IRON (PIPE) CENTERLINE CEMENT LINED DUCTILE IRON (PIPE)	OC OD OHW OVHD OW	ON CENTER OUTSIDE DIAMETER OVERHEAD WIRE OVERHEAD OBSERVATION WELL
CM CMP CO CONC CONST CONT CRD CPP CUL CY	CONSTRUCTION MANAGER CORRUGATED METAL PIPE CLEAN OUT CONCRETE CONSTRUCTION CONTRACTOR COORDINATE CORRUGATED POLYETHYLENE PIPE CULVERT CUBIC YARD	PC PCC PI PKG PL PLMB POC POT PRC PROP, P PT PVC	POINT OF CURVATURE PRECAST CONCRETE CURB POINT OF INTERSECTION PARKING PROPERTY LINE PLUMBING POINT ON CURVATURE POINT ON TANGENT POINT OF REVERSE CURVATURE PROPOSED POINT (OR POINT OF TANGENT) POLYVINYL CHLORIDE (PIPE)
DB DBL DEM DET DI DIA DIM DMH DW DWG DYCL	DISTRIBUTION BOX DOUBLE DEMOLISH DETENTION DUCTILE IRON (PIPE) DIAMETER DIMENSION DRAIN MANHOLE DOMESTIC WATER (OR DRY WELL) DRAWING DOUBLE YELLOW CENTERLINE	R&R R&S RCP RD RED RELOC REM RET ROW RR RWL RWY	REMOVE & RESET/REPLACE REMOVE & STACK REINFORCED CONCRETE PIPE ROAD (OR ROOF DRAIN) REDUCER RELOCATE REMOVE RETAIN, RETAINING OR RETENTION RIGHT OF WAY RAILROAD RAIN WATER LEADER ROADWAY
EHH EL ELEC EMH EOP EOR EOW ETC EXIST EXT		SD SF SGC SMH SP SPEC STA STC STD STRTL SWEL SW	SUBDRAIN SQUARE FEET SLOPED GRANITE CURB SEWER MANHOLE STANDPIPE SPECIFICATION STATION STORMCEPTOR STANDARD STRUCTURAL SOLID WHITE EDGE LINE SIDEWALK
FCC FES FFE FLNP FPS	FLUSH CONCRETE CURB FLARED END SECTION FINISH FLOOR ELEVATION FIRE LANE NO PARKING FEET PER SECOND	SWLL SYCL TB TC	SOLID WHITE LANE LINE SOLID YELLOW CENTERLINE TEST BORING TOP OF CURB
FS FT GC GEN GG GR GRAN	FIRE SERVICE FOOT/FEET GENERAL CONTRACTOR GENERAL GAS GATE GUIDE RAIL GRANITE	TD TEL, T TMH TOS TOW TP TS&V TYP	TRENCH DRAIN TELEPHONE TELEPHONE MANHOLE TOP OF SLOPE TOP OF WALL TEST PIT TAPPING SLEEVE & VALVE TYPICAL
GV GV&B GW	GATE VALVE GATE VALVE & BOX GROUND WATER	UD UL UP	UNDERDRAIN UNDERWRITERS LABORATORY UTILITY POLE
HCR HOR HT HW	HANDICAP RAMP HORIZONTAL HEIGHT HEADWALL	VCP VERT VGC	VITRIFIED CLAY PIPE VERTICAL VERTICAL GRANITE CURB
HWY HYD ID IN INCL INST	HIGHWAY HYDRANT INSIDE DIAMETER INCHES INCLUDE INSTALLED	WD WG WM WMH WSO	WOOD WATER GATE WATER MAIN WATER MANHOLE WATER SHUTOFF
INV. I.F.	INVERT ELEVATION		

INVERT, INVERT ELEVATION

INV, I.E.

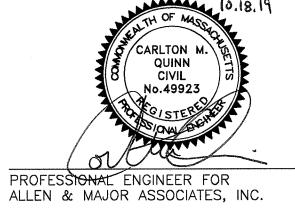

D.	10/18/2019	REVISED PER TOWN COMMENT
C.	10/10/2019	REVISED PER TOWN COMMENT
В.	09/27/2019	REVISED PER TOWN COMMENT
A.	07/03/2019	ISSUED FOR NOTICE OF INTENT
REV	DATE	DESCRIPTION

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PROJEC

ALTA AT RIVER'S EDGE 490 BOSTON POST ROAD WAYLAND, MA

PROJECT NO.	1670-09A	DATE:	06-20-2019
SCALE:	N/A	DWG. NAME:	1670-09A
DESIGNED BY:	SJL	CHECKED BY:	CMQ



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ABBREVIATIONS & NOTES

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- 3. IF DISTURBED AREAS DO NOT RECEIVE FINAL SEEDING BY OCTOBER 1ST OF THE CONSTRUCTION YEAR. THEN ALL DISTURBED AREAS SHALL BE SEEDED WITH A WINTER COVER CROP AT THE RATE OF 3 LBS PER 1,000 SQUARE FEET, WINTER SEEDING SHALL BE COVERED WITH EROSION CONTROL MESH (MULCH AND NETTING). HEAVY GRADE MATS SHALL BE USED IN THE BASE OF ALL GRASSED WATERWAYS ON VEGETATED SLOPES IN EXCESS OF 15%, AND ANY DISTURBED AREAS WITHIN 100 FEET OF WETLANDS OR STREAMS. MULCH AND NETTING SHALL ALSO BE PROVIDED FOR ADDITIONAL WINTER PROTECTION.
- ALL TOPSOIL SHALL BE COLLECTED, STOCKPILED, SEEDED WITH RYE AT 3LBS PER 1.000 SQUARE FOOT AND MULCHED, AND REUSED AS REQUIRED. TUBULAR BARRIERS SHALL BE PLACED DOWN GRADIENT FROM STOCKPILED LOAM. LOAM SHALL BE STOCKPILED AT LOCATIONS DESIGNATED BY THE OWNER AND ENGINEER.
- ALL TUBULAR BARRIERS. SILT SACKS. AND EROSION CONTROL BERMS SHALL BE INSTALLED ACCORDING TO THE SITE PREPARATION PLAN. THESE SHALL BE MAINTAINED DURING DEVELOPMENT TO REMOVE SEDIMENT FROM RUNOFF WATER. ALL THE FILTER BARRIERS AND EROSION CONTROL BERMS SHALL BE INSPECTED AFTER ANY RAINFALL OR RUNOFF EVENT. MAINTAINED AND CLEANED UNTIL ALL AREAS HAVE AT LEAST 85-90% VIGOROUS PERENNIAL COVER OF GRASSES.
- ADJACENT ROADS SHALL BE PERIODICALLY SWEPT OR WASHED TO AVOID TRACKING MUD. DUST OR DEBRIS FROM THE CONSTRUCTION AREA AS OFTEN AS NECESSARY (WHICH COULD BE ON A DAILY BASIS) TO REMOVE ANY SOIL OR SEDIMENTS AT NO ADDITIONAL COST TO THE OWNER. A WATERING TRUCK WILL BE USED TO PERIODICALLY SPRINKLE CONSTRUCTION AREAS IN ORDER TO KEEP THE LEVEL OF DUST TO A MINIMUM DURING THE DRY MONTHS AT NO ADDITIONAL COST TO THE OWNER.
- THE CONTRACTOR SHALL USE EXTREME CAUTION TO AVOID ALLOWING SEDIMENTS TO ENTER THE STORM DRAIN SYSTEM DURING CONSTRUCTION. BOTH EXISTING AND PROPOSED CATCH BASIN INLETS SHALL BE PROTECTED DURING CONSTRUCTION BY THE USE SILT SACKS AND/OR TUBULAR BARRIERS AROUND EACH INLET AS NOTED ON THE PLANS. INLET PROTECTION MAY BE REMOVED ONLY AFTER FINISHED AREAS ARE PAVED AND THE VEGETATED SLOPES ARE ESTABLISHED WITH AT LEAST 85-90% OF VIGOROUS
- AS APPLICABLE, EROSION CONTROL MESH SHALL BE APPLIED IN ACCORDANCE WITH THE PLANS OVER ALL FINISHED SEEDED AREAS AS SPECIFIED ON THE DESIGN PLANS.
- AT A MINIMUM, ALL TUBULAR BARRIERS AND FILTER FABRIC SHALL REMAIN IN PLACE UNTIL SEEDINGS OR PLANTINGS HAVE BECOME 85-90% ESTABLISHED. THE LOCAL CONSERVATION COMMISSION MUST APPROVE THE REMOVAL OR RELOCATION OF ANY OF THE TUBULAR BARRIERS AND FILTER FABRIC. ONCE THE TUBULAR BARRIERS ARE REMOVED THE AREAS ARE TO BE LOAMED AND SEEDED TO ACHIEVE FULL STABILIZATION.
- AT THE OWNER'S DISCRETION ADDITIONAL EROSION CONTROL MEASURES MAY BE REQUIRED TO MAINTAIN STABILITY OF EARTHWORKS AND FINISHED GRADED AREAS. THE CONTRACTOR, AT HIS EXPENSE, WILL BE RESPONSIBLE FOR PROVIDING AND INSTALLING ANY ADDITIONAL MEASURES AS SPECIFIED BY THE OWNER. THIS INCLUDES BUT IS NOT LIMITED TO REQUESTS BY MA DEP, THE ENGINEER AND THE LOCAL MUNICIPALITY, AS AUTHORIZED BY THE OWNER. FAILURE TO COMPLY WITH THE OWNER'S DIRECTIONS WILL RESULT IN DISCONTINUATION OF CONSTRUCTION ACTIVITIES.
- INSPECTIONS AND MONITORING MAINTENANCE MEASURES SHALL BE APPLIED AS NEEDED DURING THE ENTIRE CONSTRUCTION CYCLE. WEEKLY INSPECTIONS SHALL BE HELD THROUGH THE DURATION OF CONSTRUCTION ACTIVITY. WEEKLY INSPECTION REPORTS SHALL BE MAINTAINED BY THE CONTRACTOR AND LOCATED IN THE CONTRACTORS FIELD OFFICE ONSITE. IN ADDITION TO THE NORMAL WEEKLY INSPECTIONS, THE CONTRACTOR SHALL PERFORM AN INSPECTION OF ALL EROSION CONTROL MEASURES AFTER EACH RAINFALL OR RUNOFF EVENT, AND PERFORM THE NECESSARY REPAIRS. THE INSPECTIONS SHALL INCLUDE BUT NOT BE LIMITED TO THE SITE'S DOWN STREAM DISCHARGE POINTS.
- 12. IF ANY EVIDENCE OF SEDIMENTATION IS OBSERVED AT THE STORMWATER MANAGEMENT AREA INLETS. THE CONTRACTOR SHALL, AT HIS OWN EXPENSE, PROVIDE A PLAN TO THE ENGINEER TO REMOVE ANY ACCUMULATED SEDIMENT IN THESE AREAS. THE CONTRACTOR SHALL ALSO IMMEDIATELY PROVIDE ADDITIONAL ON SITE EROSION AND SEDIMENTATION CONTROL MEASURES TO PREVENT FURTHER DEGRADATION OF THE AREA.
- FOLLOWING THE TEMPORARY OR FINAL SEEDINGS. THE CONTRACTOR SHALL INSPECT THE WORK AREA SEMI-MONTHLY TO ENSURE THE AREAS HAVE A MINIMUM OF 85-90% VEGETATED VIGOROUS GROWTH, RE-SEEDING SHALL BE CARRIED OUT BY THE CONTRACTOR WITH FOLLOW UP INSPECTIONS IN THE EVENT OF ANY FAILURES UNTIL VEGETATION IS ADEQUATELY ESTABLISHED.
- 14. CONTRACTOR & ALL SITE SUBCONTRACTORS SHALL BE FAMILIAR WITH & FOLLOW ALL APPROVED PERMITS AND CONDITIONS. CONTRACTOR SHALL MAINTAIN A COPY OF ALL APPROVED PERMITS ONSITE, ALL CONDITIONS & RECOMMENDATIONS WITHIN THE APPROVED PERMITS SHALL BE COMPLETED.
- 15. ALL EROSION MEASURES SHALL BE INSTALLED PRIOR TO CONSTRUCTION AND SHALL BE ADEQUATE TO MAINTAIN SEDIMENT ON SITE. ANY MODIFICATIONS SHALL BE INSTALLED AS DIRECTED BY THE ENGINEER OR THE LOCAL MUNICIPALITY.
- 16. EROSION AND SEDIMENTATION CONTROL MEASURES SHALL BE MAINTAINED DURING CONSTRUCTION. AND SHALL REMAIN IN PLACE UNTIL ALL SITE WORK IS COMPLETE AND GROUND COVER IS ESTABLISHED.
- 17. TOP OF STOCKPILES SHALL BE COVERED IN SUCH MANNER THAT STORMWATER DOES NOT INFILTRATE THE MATERIALS AND THEREBY RENDER THE SAME UNSUITABLE FOR FILL USE.

EROSION & SEDIMENTATION CONTROL NOTES (CONTINUED):

- 18. ALL DISTURBED OR EXPOSED AREAS SUBJECT TO EROSION SHALL BE STABILIZED WITH MULCH OR SEEDED FOR TEMPORARY VEGETATIVE COVER. NO AREA, SUBJECT TO EROSION SHALL BE LEFT DISTURBED AND UNSTABILIZED FOR PERIODS LONGER THAN IS ABSOLUTELY NECESSARY TO CARRY OUT THAT PORTION OF THE CONSTRUCTION WORK OR SIX MONTHS AFTER SOIL HAS BEEN DISTURBED WHICHEVER IS LESS.
- 19. CULVERT/PIPE INLETS AND OUTFALLS SHALL BE PROTECTED BY TUBULAR BARRIER FILTERS AND STONE CHECK DAMS UNTIL DISTURBED AREAS ARE PERMANENTLY STABILIZED.
- 20. TUBULAR BARRIER DIKES SHALL BE CONSTRUCTED AT ALL EXISTING & PROPOSED CATCH BASINS. NO SEDIMENTATION SHALL ENTER THE ON-SITE OR OFF-SITE DRAINAGE SYSTEMS AT ANY TIME.
- 21. ALL EROSION CONTROL MEASURES SHALL BE ROUTINELY INSPECTED, CLEANED AND REPAIRED OR REPLACED AS NECESSARY THROUGHOUT ALL PHASES OF CONSTRUCTION IN ADDITION, INSPECTIONS SHALL TAKE PLACE WEEKLY AND BEFORE AND AFTER EACH RAINFALL EVENT.
- 22. ALL PROPOSED SLOPES STEEPER THAN 3:1 SHALL BE STABILIZED WITH JUTE MESH AND PROTECTED FROM EROSION UNTIL WORK IS COMPLETE AND GROUND COVER IS ESTABLISHED.
- 23. THE CONTRACTOR SHALL KEEP ON SITE AT ALL TIMES ADDITIONAL TUBULAR BARRIERS FOR INSTALLATION AT THE DIRECTION OF THE ENGINEER OR THE TOWN ENGINEER TO MITIGATE ANY EMERGENCY CONDITION.
- 24. AS CONSTRUCTION DISTURBANCE IS GREATER THAN 1 ACRE, A NATIONAL POLLUTANT DISCHARGE ELIMINATION SYSTEM (NPDES) CONSTRUCTION GENERAL PERMIT NOI, AND STORM WATER POLLUTION PREVENTION PLAN (SWPPP) WILL NEED TO BE SUBMITTED TO THE EPA. THE NPDES PERMIT FOR STORM WATER DISCHARGE. & CONSTRUCTION GENERAL PERMIT NOI WILL BE REQUIRED TO BE SUBMITTED AT LEAST 14 DAYS PRIOR TO COMMENCING CONSTRUCTION BY THE CONTRACTOR.
- 25. OWNER AND CONTRACTOR ARE RESPONSIBLE FOR COMPLIANCE WITH THE CONSTRUCTION GENERAL PERMIT NOI. WEEKLY SWPPP INSPECTION REPORTS TO BE PERFORMED BY CONTRACTOR. COPIES OF ALL SWPPP INSPECTION REPORTS SHALL BE PROVIDED TO THE LOCAL MUNICIPALITY, EPA, DEP, OR ANY OTHER AUTHORITY REQUESTING WITHIN 3 DAYS OF EACH INSPECTION.
- 26. APPLICABLE WORK AND MATERIALS SHALL COMPLY WITH ALL LOCAL, MA DEP. EPA CONSTRUCTION GENERAL PERMIT STANDARDS. ALL CONSTRUCTION SHALL CONFORM TO THE APPLICABLE SITE PLAN REGULATIONS FROM THE LOCAL AND USDA SOIL CONSERVATION SERVICE VEGETATIVE PRACTICES IN SITE DEVELOPMENT.
- 27. A WATERING TRUCK SHALL BE USED TO PERIODICALLY SPRINKLE CONSTRUCTION AREAS IN ORDER TO KEEP THE LEVEL OF DUST TO A MINIMUM DURING THE DRY MONTHS AND AS REQUIRED.
- 28. IF DEWATERING IS NECESSARY IT SHALL ONLY BE COMPLETED AS FOLLOWS: THE DISCHARGE SHALL BE STOPPED IMMEDIATELY IF THE RECEIVING AREA SHOWS ANY SIGN OF INSTABILITY OR EROSION. ALL CHANNELS, SWALES, AND DITCHES DUG FOR DISCHARGING WATER FROM THE EXCAVATED AREA SHALL BE STABLE PRIOR TO DIRECTING DISCHARGE TO THEM. IF A CONSTRUCTION EQUIPMENT BUCKET IS USED. IT SHALL EMPTY THE MATERIAL TO A STABLE AREA. NO DEWATERING SHALL OCCUR DURING PERIODS OF INTENSE, HEAVY RAIN. FLOW TO THE SEDIMENT REMOVAL STRUCTURE SHALL NOT EXCEED THE STRUCTURE'S CAPATOWN TO SETTLE AND FILTER FLOW OR ITS VOLUME CAPATOWN. WHENEVER POSSIBLE, THE DISCHARGE FROM THE SEDIMENT REMOVAL STRUCTURE SHALL DRAIN TO A WELL-VEGETATED BUFFER BY SHEET FLOW WHILE MAXIMIZING THE DISTANCE TO THE NEAREST WATER RESOURCE AND MINIMIZING THE SLOPE OF THE BUFFER AREA. THERE SHALL BE NO DIRECT DISCHARGE TO EXISTING WETLANDS OR STREAMS. ALL DISCHARGE SHALL BE IN COMPLIANCE WITH STATE, LOCAL, AND FEDERAL REQUIREMENTS.
- 29. INITIATE STABILIZATION OF EXPOSED AREAS IMMEDIATELY IF CONSTRUCTION WORK TEMPORARILY OR PERMANENTLY CEASES.
- 30. ALL DISCHARGES FROM POLLUTION SOURCES ARE PROHIBITED ONSITE SUCH AS FUELS. WASTEWATER FROM WASH OUT OF CONCRETE, WASTEWATER FROM CLEAN OUT OF PAINTS, FORM RELEASE OILS, SOLVENTS, ADHESIVES, CURING COMPOUNDS, POLLUTANTS USED FOR MAINTENANCE OF VEHICLES AND EQUIPMENT, SOAPS & SOLVENTS, TOXIC OR HAZARDOUS SUBSTANCES. CHEMICALS AND OILS. IF A POLLUTANT IS DISCHARGED IT NEEDS TO BE IMMEDIATELY CLEANED UP BY REMOVING THE CHEMICAL AND AFFECTED SOIL OR AREA OF SPILL FROM THE SITE IN ACCORDANCE WITH BOTH THE MANUFACTURER RECOMMENDATIONS, FEDERAL, STATE, AND LOCAL REQUIREMENTS. DO NOT HOSE DOWN AND SPREAD SPILLED ITEM. ALL CHEMICALS USED ON THE SITE SHALL BE IN LEAK-PROOF CONTAINERS STORED AWAY FROM WETLANDS, SURFACE WATERS, STORMWATER INLETS, AND DRAINAGE MEASURES. SPILL KITS SHALL BE AVAILABLE ONSITE FOR EMERGENCY USE. THERE SHALL BE A SECONDARY CONTAINMENT MEASURE OF ALL CHEMICALS IN ADDITION TO SPILL-PROOF CONTAINERS.
- 31. PRIOR TO COMMENCEMENT OF CONSTRUCTION, APPLICABLE CONTRACTOR PERSONNEL MUST HAVE AN UNDERSTANDING OF THE EPA CONSTRUCTION GENERAL PERMIT REQUIREMENTS AND THEIR SPECIFIC RESPONSIBILITIES UNDER THE PERMIT. AT A MINIMUM, PERSONNEL MUST BE TRAINED AND UNDERSTAND THE FOLLOWING: LOCATION OF ALL STORMWATER CONTROLS AND HOW TO MAINTAIN THEM, PROCEDURES FOR COMPLYING WITH THE POLLUTION PREVENTION REQUIREMENTS. PROCEDURES FOR CONDUCTING INSPECTIONS, RECORDING FINDINGS, AND TAKING CORRECTIVE ACTION.
- 32. ALL SEDIMENT TRACKED ONTO ROADWAYS MUST BE REMOVED AT END OF EACH WORK
- 33. ALL USE OF CATIONIC TREATMENT CHEMICALS (EXAMPLES INCLUDE POLYMERS. CHITOSAN, CATIONIC PAM, FLOCCULANTS OR OTHER CHEMICAL UTILIZED FOR STABILIZATION) ARE PROHIBITED. IF ALL OTHER AVAILABLE STABILIZATION MEASURES ARE NOT POSSIBLÉ AND USE OF CATIONIC CHEMICALS IS ABSOLUTELY NECESSARY THE CONTRACTOR WILL NEED TO CONTACT THE EPA NEW ENGLAND OFFICE IN WRITING FOR APPROVAL AND SPECIFIC REQUIREMENTS (MAXIMUM DOSAGE RATE, RESIDUAL TESTING, SPECIFIC LIMITATIONS, ETC) PRIOR TO USE.
- 34. IF USING NON-VEGETATIVE STABILIZATION MEASURES, IT MUST BE COMPLETED NO LATER THAN 14 DAYS AFTER INITIATING STABILIZATION. ALL AREAS OF EXPOSED SOILS MUST BE COVERED.
- 35. INSPECTIONS OF EROSION CONTROL MEASURES SHALL BE AT LEAST ONCE EVERY 7 DAYS BY THE CONTRACTOR. AT A MINIMUM INSPECTIONS SHALL INCLUDE ALL DISTURBED AREAS, ALL STORMWATER CONTROLS AND POLLUTION PREVENTION MEASURES, ALL LOCATIONS WHERE STABILIZATION MEASURES HAVE BEEN IMPLEMENTED. EQUIPMENT AND MATERIAL STORAGE AREAS, ALL AREAS WHERE STORMWATER FLOWS AND ALL POINTS OF DISCHARGE. WHEN CORRECTIVE ACTIONS ARE REQUIRED. THE CONTRACTOR MUST IMMEDIATELY TAKE ALL STEPS TO PREVENT POLLUTANT DISCHARGES UNTIL A PERMANENT SOLUTION IS IMPLEMENTED. AS NECESSARY NEW OR MODIFIED CONTROLS MUST BE INSTALLED AND OPERATIONAL, THE REPAIR MUST BE COMPLETED WITHIN 7 DAYS FROM THE TIME OF DISCOVERY. WITHIN 24 HOURS OF A TRIGGERING CONDITION OCCURRING THAT REQUIRES A CORRECTIVE ACTION, A CORRECTIVE ACTION REPORT MUST BE COMPLETED.

MAINTENANCE:

ALL MEASURES STATED ON THE STORMWATER POLLUTION PREVENTION PLANS. SHALL BE MAINTAINED IN FULLY FUNCTIONAL CONDITION BY CONTRACTOR UNTIL NO LONGER REQUIRED FOR A COMPLETED PHASE OF WORK OR FINAL STABILIZATION OF THE SITE, ALL EROSION AND SEDIMENTATION CONTROL MEASURES SHALL BE CHECKED BY A QUALIFIED PERSON IN ACCORDANCE WITH THE CONTRACT DOCUMENTS OR THE APPLICABLE PERMIT, WHICHEVER IS MORE STRINGENT, AND REPAIRED IN ACCORDANCE WITH THE FOLLOWING:


- 1. INLET PROTECTION DEVICES AND BARRIERS SHALL BE REPAIRED OR REPLACED IF THEY SHOW SIGNS OF UNDERMINING, OR DETERIORATION.
- 2. ALL SEEDED AREAS SHALL BE CHECKED REGULARLY TO SEE THAT A HEALTHY STAND OF GRASS IS MAINTAINED. AREAS SHOULD BE FERTILIZED, WATERED, AND RESEEDED AS NEEDED.
- 3. ALL SEDIMENT CONTROLS SHALL BE REPAIRED TO THEIR ORIGINAL CONDITIONS IF DAMAGED, SEDIMENT SHALL BE REMOVED FROM THE TUBULAR SEDIMENT CONTROLS WHEN IT REACHES HALF THE HEIGHT OF THE CONTROL MEASURE OR AS REQUESTED BY THE OWNER OR ENGINEER.
- 4. THE CONSTRUCTION ENTRANCES SHALL BE MAINTAINED IN A CONDITION WHICH WILL PREVENT TRACKING OR FLOW OF MUD ONTO PUBLIC RIGHTS-OF-WAY. THIS MAY REQUIRE PERIODIC TOP DRESSING OF THE CONSTRUCTION ENTRANCES AS CONDITIONS DEMAND.
- THE TEMPORARY PARKING AND STORAGE AREA SHALL BE KEPT IN GOOD CONDITION (SUITABLE FOR PARKING AND STORAGE). THIS MAY REQUIRE PERIODIC TOP DRESSING OF THE TEMPORARY PARKING AS CONDITIONS DEMAND.
- 6. OUTLET STRUCTURES IN THE SEDIMENTATION BASINS SHALL BE MAINTAINED IN OPERATIONAL CONDITIONS AT ALL TIMES. SEDIMENT SHALL BE REMOVED FROM SEDIMENT BASINS OR TRAPS WHEN THE DESIGN CAPATOWN HAS BEEN REDUCED BY 50%.

CONSTRUCTION GENERAL PERMIT NOTES AND NARRATIVE:

NARRATIVE: THE STORMWATER POLLUTION PREVENTION PLANS CONSIST OF THE SITE PREPARATION PLAN TOGETHER WITH AN EXISTING CONDITIONS PLANS, GRADING PLANS, ABBREVIATIONS AND NOTES SHEETS, AND DETAIL SHEETS.

THE EROSION CONTROL PLAN WILL BE IMPLEMENTED TO:

- A. TREAT EROSION AS SOON AS POSSIBLE AFTER DISTURBANCE.
- PREVENT SEDIMENT FROM LEAVING THE CONSTRUCTION AREA AND ENTERING THE RECEIVING WATERS.
- C. CONSTRUCTION ACTIVITIES SHALL BE SCHEDULED TO MINIMIZE EROSION.
- D. ONLY DISTURB, CLEAR, OR GRADE AREAS NECESSARY FOR CONSTRUCTION

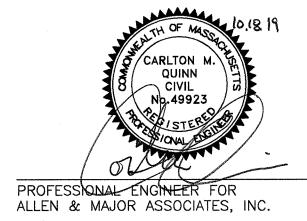

D. 10/18/2019 REVISED PER TOWN COMMENTS C. 10/10/2019 REVISED PER TOWN COMMENTS B. 09/27/2019 REVISED PER TOWN COMMENTS

|07/03/2019| ISSUED FOR NOTICE OF INTENT

REV DATE DESCRIPTION APPLICANT\OWNER:

> WP EAST ACQUISITIONS, LLC. 91 HARTWELL AVENUE LEXINGTON, MA 02421

PROJECT:

ALTA AT RIVER'S EDGE 490 BOSTON POST ROAD WAYLAND, MA

PROJECT NO. 1670-09A DATE: 06-20-2019 SCALE: N/A DWG. NAME: 1670-09/ **DESIGNED BY:** SJL CHECKED BY: CMQ



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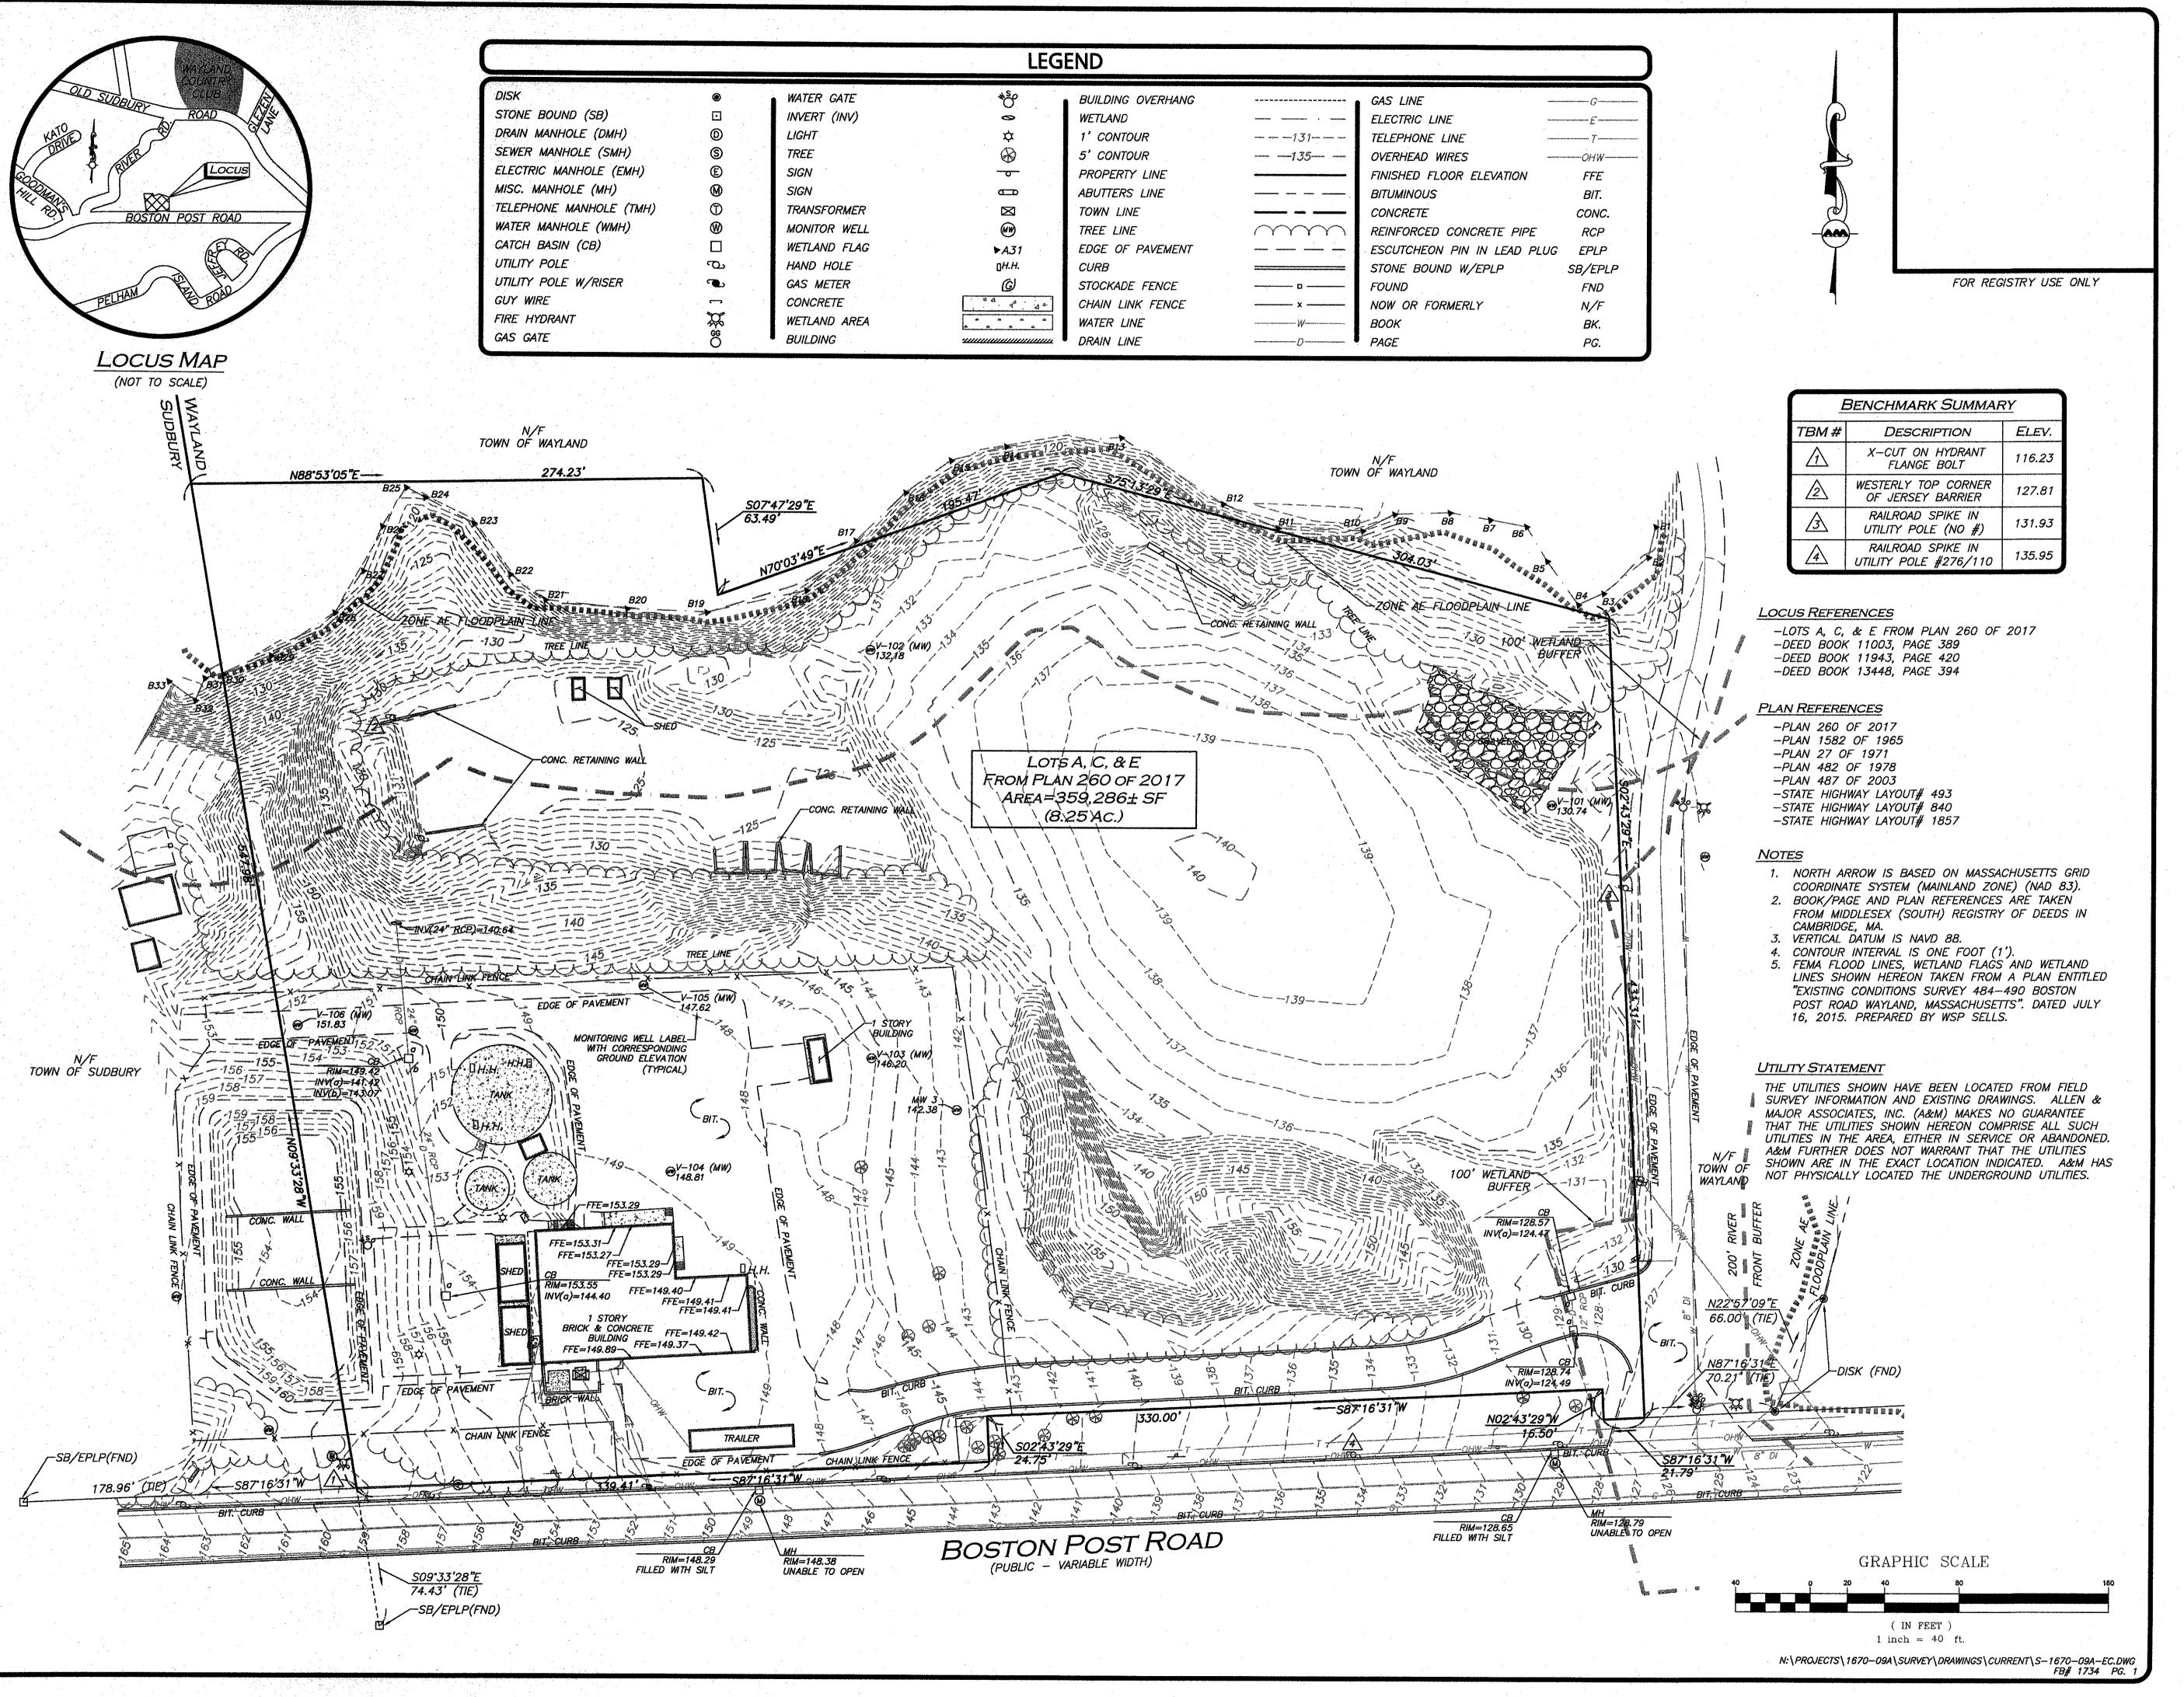
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ABBREVIATIONS & NOTES

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WE HEREBY CERTIFY THAT:


THIS PLAN IS THE RESULT OF AN ACTUAL ON THE GROUND SURVEY PERFORMED ON OR BETWEEN MARCH 27, 2019 AND MAY 9, 2019. THIS PLAN WAS PREPARED IN ACCORDANCE WITH THE RULES AND REGULATIONS OF THE REGISTERS OF DEEDS DATED JANUARY 1, 1976 AND REVISED JANUARY 12, 1988. ACCORDING TO DEEDS AND PLANS OF RECORD, THE PROPERTY LINES SHOWN ON THIS PLAN ARE THE LINES DIVIDING EXISTING OWNERSHIP, AND THE LINES OF THE STREETS OR WAYS SHOWN ARE THOSE OF PUBLIC OR PRIVATE STREETS AND WAYS ALREADY ESTABLISHED, AND THAT NO NEW LINES FOR THE DIVISION OF EXISTING OWNERSHIP OR FOR NEW WAYS ARE SHOWN.

THE ABOVE CERTIFICATION IS INTENDED TO MEET REGISTRY OF DEEDS REQUIREMENTS FOR THE RECORDING OF PLANS AND IS NOT A CERTIFICATION TO THE TITLE OR OWNERSHIP OF THE PROPERTY SHOWN. OWNERS OF ADJOINING PROPERTIES ARE SHOWN ACCORDING TO CURRENT TOWN OF WAYLAND AND TOWN OF SUDBURY ASSESSOR'S INFORMATION.

THE ABOVE IS CERTIFIED TO THE BEST OF MY PROFESSIONAL KNOWLEDGE, INFORMATION AND BELIEF.

ALLEN & MAJOR ASSOCIATES, INC.



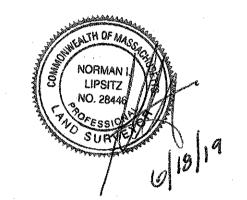

- 17	APPLICAN	T\OWNER:		.,,,,,,,,,,,,,,,,,,,,,,,,,,,,,,,,,,,,,,
L	REV	DATE	DESCRIPTION	
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WP EAST ACQUISITIONS, LLC 91 HARTWELL AVENUE – 3RD FLOOR LEXINGTON, MA 02421

PROJECT:

490 BOSTON POST ROAD WAYLAND, MA

	PROJECT NO.	1670-09A	DATE:	06/17/19
	SCALE:	1" - 40'	DWG. NAME:	S-1670-09A-EC
,	DRAFTED BY:	COB/KAC	CHECKED BY:	NIL



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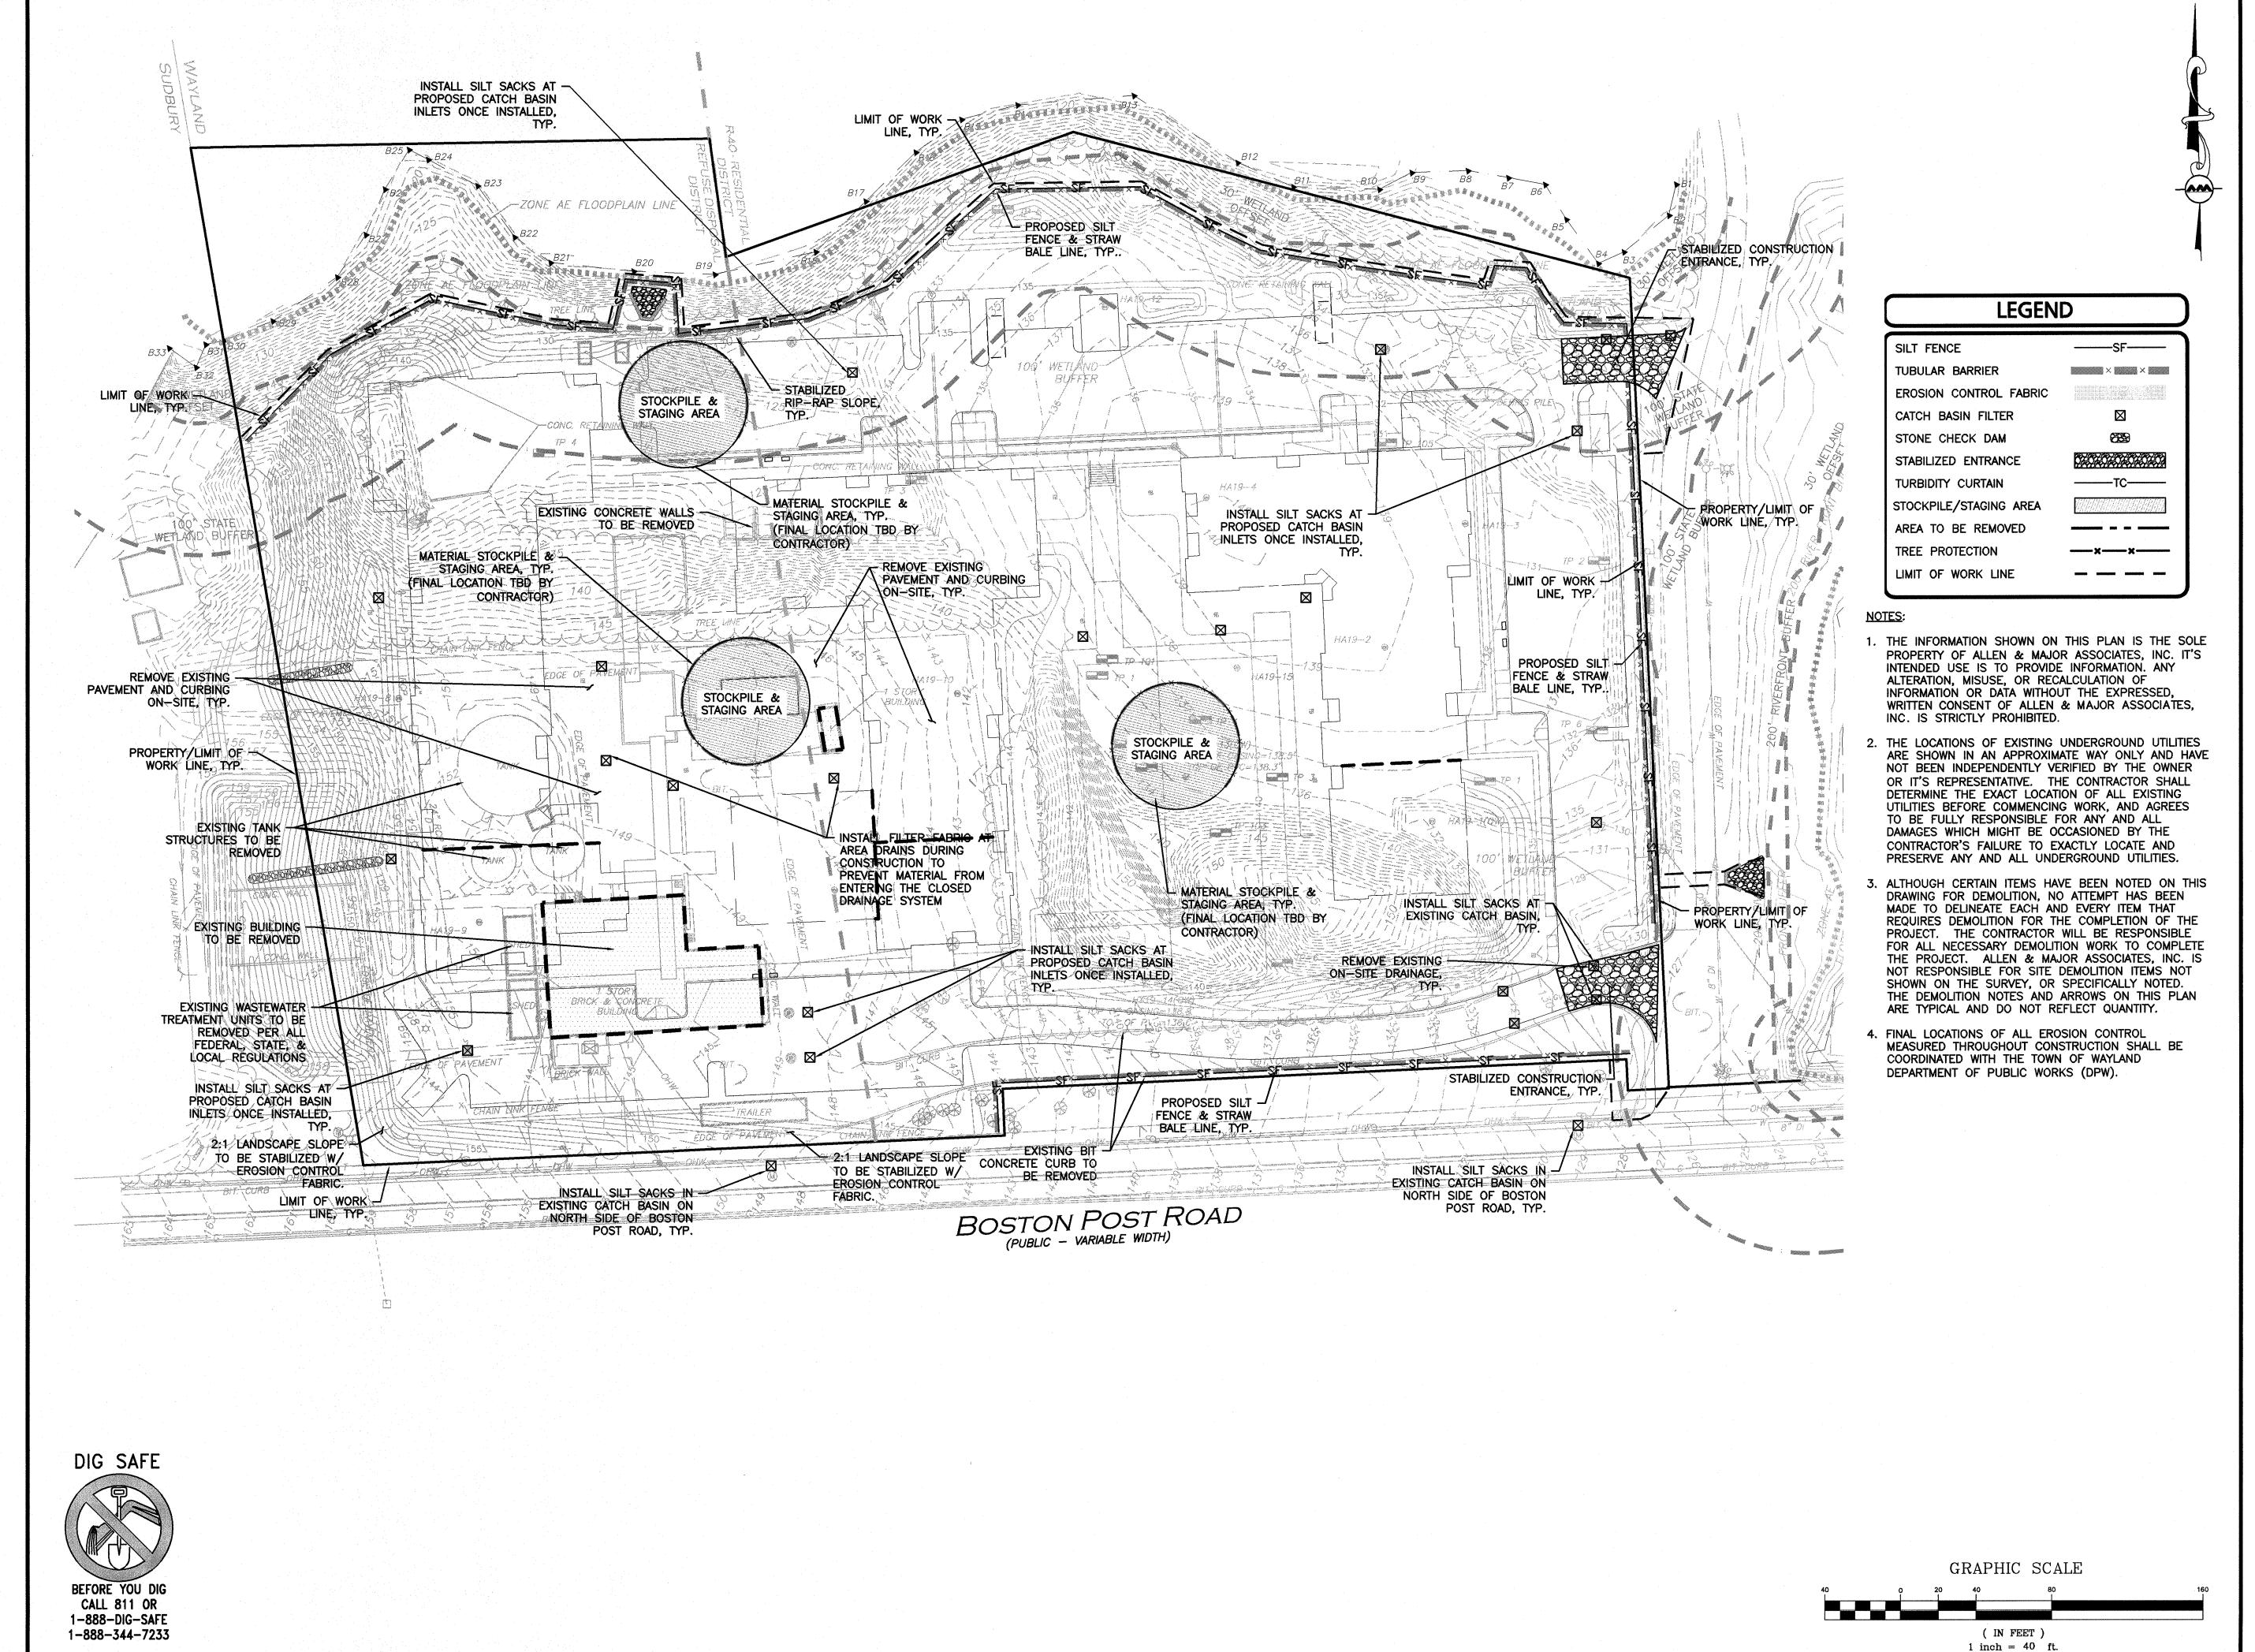
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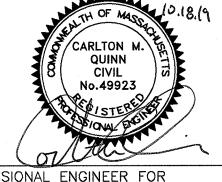
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EXISTING CONDITIONS

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PROFESSIONAL ENGINEER FOR ALLEN & MAJOR ASSOCIATES, INC.

D. | 10/18/2019 | REVISED PER TOWN COMMENTS C. |10/10/2019| REVISED PER TOWN COMMENTS B. 09/27/2019 REVISED PER TOWN COMMENTS A. |07/03/2019| ISSUED FOR NOTICE OF INTENT REV DATE DESCRIPTION

APPLICANT\OWNER:

WP EAST ACQUISITIONS, LLC. 91 HARTWELL AVENUE LEXINGTON, MA 02421

PROJECT:

ALTA AT RIVER'S EDGE **490 BOSTON POST ROAD** WAYLAND, MA

1670-09A DATE: 06-20-2019 PROJECT NO. 1" =40' DWG, NAME: **SCALE**: 1670-09A **DESIGNED BY:** SJL | CHECKED BY: CMQ



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C-101

DRAWING TITLE:

DEMOLITION & EROSION CONTROL PLAN

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ITEM	EXISTING	PROPOSED	REQUIRED/ALLOWED
MINIMUM LOT AREA	359,286± S.F.	359,286± S.F.	40,000 S.F.
MAXIMUM LOT COVERAGE (1)	3.8% ±	24.6%± ⁽⁴⁾ (8)	20%
MINIMUM FRONTAGE	691.2± FT	691.2± FT	180 FEET
MINIMUM BUILDING SETBACK (2)	12.1± FT	14.9± FT	50 FT
MINIMUM FRONT YARD (4)	12.1± FT	19.7 FT (8)	30 FT (5)
MIN. R.O.W. CENTER LINE SETBACK	84.7 FT	94.8 FT	55 FT (6)
MINIMUM REAR YARD (4)	23.7± FT	73.0 FT	30 FT (6)
MINIMUM SIDE YARD (4)	87.9± FT	20.6 FT (8)	75 FT (7)
MAXIMUM BUILDING HEIGHT (3)	21± FT	52'-7" (8)	45 FT
MAXIMUM BUILDING HEIGHT (3)	21± FT	51'-11"	58 FT
MAXIMUM BUILDING SIZE	13,757± GSF	56,366± GSF	150,000 GSF
MINIMUM PARKING AREA INTERIOR LANDSCAPING	TBD	10.0%	10%
MAXIMUM NUMBER OF DWELLING UNITS	N/A	218 (8)	190

MAXIMUM BUILDING HEIGHT SHALL NOT EXCEED 45 FEET FOR THE REMAINDER OF THE SITE, WITH THE EXCEPTION THAT THE MAXIMUM HEIGHT FOR THE NORTHWEST QUADRANT OF THE SITE SHALL BE 58 FEET IN HEIGHT FOR THIS QUADRANT ONLY. HEIGHT SHALL BE AS DEFINED IN \$198-701.1.2. HEIGHT SHALL BE MEASURED FROM THE AVERAGE GRADE OF THE LAND WHERE AVERAGE GRADE SHALL BE DETERMINED BY THE GRADE OF THE LAND IMMEDIATELY ADJACENT TO THE THREE SIDES OF THE BUILDING WHICH DO NOT FACE NORTH, TO REDUCE GRADING ON THE NORTH-FACING SIDES NEAR WETLANDS, AND TO ENCOURAGE UNDERGROUND PARKING IN THESE AREAS. ON THESE NORTH-FACING FACADES ONLY, NOT MORE THAN SIX FEET OF A PARKING LEVEL MAY BE EXPOSED AND ALLOW NATURAL VENTILATION AS LONG AS THIS FACADE AREA IS SCREENED AND BUFFERED WITH LANDSCAPE.

(4) FRONT, SIDE, AND REAR YARDS SHALL BE SPACE EXTENDING BETWEEN THE LOT LINE OF A GIVEN YARD AND THE NEAREST POINT OF THE BUILDING OR STRUCTURE. NOTE: STRUCTURES INCLUDE RETAINING

(5) MINIMUM DIMENSION NOTED INDICATES REQUIREMENTS FOR BOTH R-40 RESIDENTIAL DISTRICT AND REFUSE DISPOSAL DISTRICT. (6) MINIMUM DIMENSION NOTED INDICATED REQUIREMENTS FOR R-40 RESIDENTIAL DISTRICT ONLY.

(7) MINIMUM DIMENSION NOTED INDICATES REQUIREMENTS FOR REFUSE DISPOSAL DISTRICT ONLY.

(8) RELIEF FROM TOWN OF WAYLAND ZONING BYLAWS REQUIRED.

LEGEND

200' OUTER RIPARIAN

< 0° ZZ ADA DET. WARNING SURFACE MONO. PCC

THE LOCATIONS OF EXISTING UNDERGROUND UTILITIES ARE SHOWN AN APPROXIMATE WAY ONLY AND HAVE NOT BEEN independently verified by the owner or its representative. THE CONTRACTOR SHALL DETERMINE THE EXACT LOCATION OF ALL EXISTING UTILITIES BEFORE COMMENCING WORK, AND AGREES TO BE FULLY RESPONSIBLE FOR ANY AND ALL DAMAGES WHICH MIGHT BE OCCASIONED BY THE CONTRACTOR'S FAILURE TO EXACTLY LOCATE AND PRESERVE ANY AND ALL UNDERGROUND UTILITIES.

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3. THE CONTRACTOR SHALL CONTACT "DIGSAFE" AND THE CITY OF WAYLAND DEPARTMENT OF PUBLIC WORKS AT LEAST 72 HOURS PRIOR TO ANY EXCAVATION WORK TO REQUEST THE LOCATION OF

DIGSAFE: 1-800-344-7233 WAYLAND DEPT. OF PUBLIC WORKS: (508) 358-3672

4. SEE THE ABBREVIATIONS AND NOTES PLAN AND DETAILS FOR

5. ALL CURBING RADII SHALL BE 3' UNLESS OTHERWISE NOTED. ALL RADII AND DIMENSIONS MEASURED AT FACE OF CURB. 6. ALL ADA RAMPS ARE TO BE CONCRETE UNLESS SPECIFIED

7. EXISTING CONDITIONS BASE PLAN TAKEN FROM AN EXISTING CONDITIONS BASE PLAN ENTITLED "EXISTING CONDITIONS", PREPARED BY ALLEN & MAJOR ASSOCIATES, INC., ORIGINAL SCALE

8. RIVERFRONT FLAGGINGS (RA SERIES) AND A&B SERIES WETLANDS FLAGGINGS TAKEN FROM A PLAN ENTITLED "EXSITING CONDITIONS SURVEY - 484-490 BOSTON POST ROAD - WAYLAND, MASSACHUSETTS," PREPARED BY WSP SELLS DATED JULY 16,

9. ALL ELEVATIONS REFER TO NAVD88 DATUM.

PARKING SUMMARY CHART

PARKING SPACES SHALL BE PROVIDED AT A MINIMUM RATIO OF 1.25 PARKING

=273 SPACES =273 SPACES

THEREFORE, 273 PARKING SPACES ARE REQUIRED AT A MINIMUM RATIO OF 1.25

348 TOTAL PARKING SPACES ARE CURRENTLY PROPOSED, INCLUDING 180 SPACES WITHIN THE PODIUM PARKING AREAS AND 168 SURFACE PARKING STALLS, FOR A PROPOSED PARKING RATIO OF 1.60 SPACES PER 1 DWELLING UNIT.

1.60 > 1.25, THEREFORE PROPOSED PARKING COUNT MEETS/EXCEEDS MINIMUM

THERE ARE BETWEEN 301 AND 400 TOTAL PARKING SPACES

ADA PROVIDED: 12 ADA ACCESSIBLE SPACES, 6 OF WHICH SHALL BE VAN

SURFACE	PARKING	STRUCTURE	D PARKING	TOTAL	PARKING
STANDARD SPACES	ACCESSIBLE SPACES	STANDARD SPACES	ACCESSIBLE SPACES	TOTAL PROVIDED	TOTAL REQUIRED
162	6	174	6 ⁽²⁾	348	273

PARKING NOTES:

(1) ...AND MAXIMUM OF 15 PARKING SPACES FOR ANY ACCESSORY CAFE OR DINER IN ADDITION TO SAID DWELLING UNIT PARKING SPACES. IF OVER 50% OF THE TOTAL NUMBER OF DWELLING UNITS ARE AGE RESTRICTED AS SET FORTH IN \$ 198-2506.6 BELOW, PARKING MAY BE PROVIDED AT A MINIMUM OF 0.50 PARKING SPACE PER AGE-RESTRICTED DWELLING UNIT.

(2) INCLUDES 3 VAN ACCESSIBLE PARKING STALLS WITHIN STRUCTURED PODIUM PARKING.

GRAPHIC SCALE

(IN FEET 1 inch = 40 ft.



D. |10/18/2019| REVISED PER TOWN COMMENTS

C. 10/10/2019 REVISED PER TOWN COMMENTS B. |09/27/2019| REVISED PER TOWN COMMENTS A. 07/03/2019 ISSUED FOR NOTICE OF INTENT

DATE DESCRIPTION APPLICANT\OWNER:

> WP EAST ACQUISITIONS, LLC. 91 HARTWELL AVENUE **LEXINGTON, MA 02421**

PROJECT:

ALTA AT RIVER'S EDGE 490 BOSTON POST ROAD WAYLAND, MA

1670-09A DATE: 06-20-2019 1" =40' DWG. NAME: SCALE: **DESIGNED BY:** SJL | CHECKED BY:



ASSOCIATES, INC. civil & structural engineering • land surveying environmental consulting ♦ landscape architecture

www.allenmajor.com 100 COMMERCE WAY, SUITE 5 WOBURN MA 01801 TEL: (781) 935-6889 FAX: (781) 935-2896

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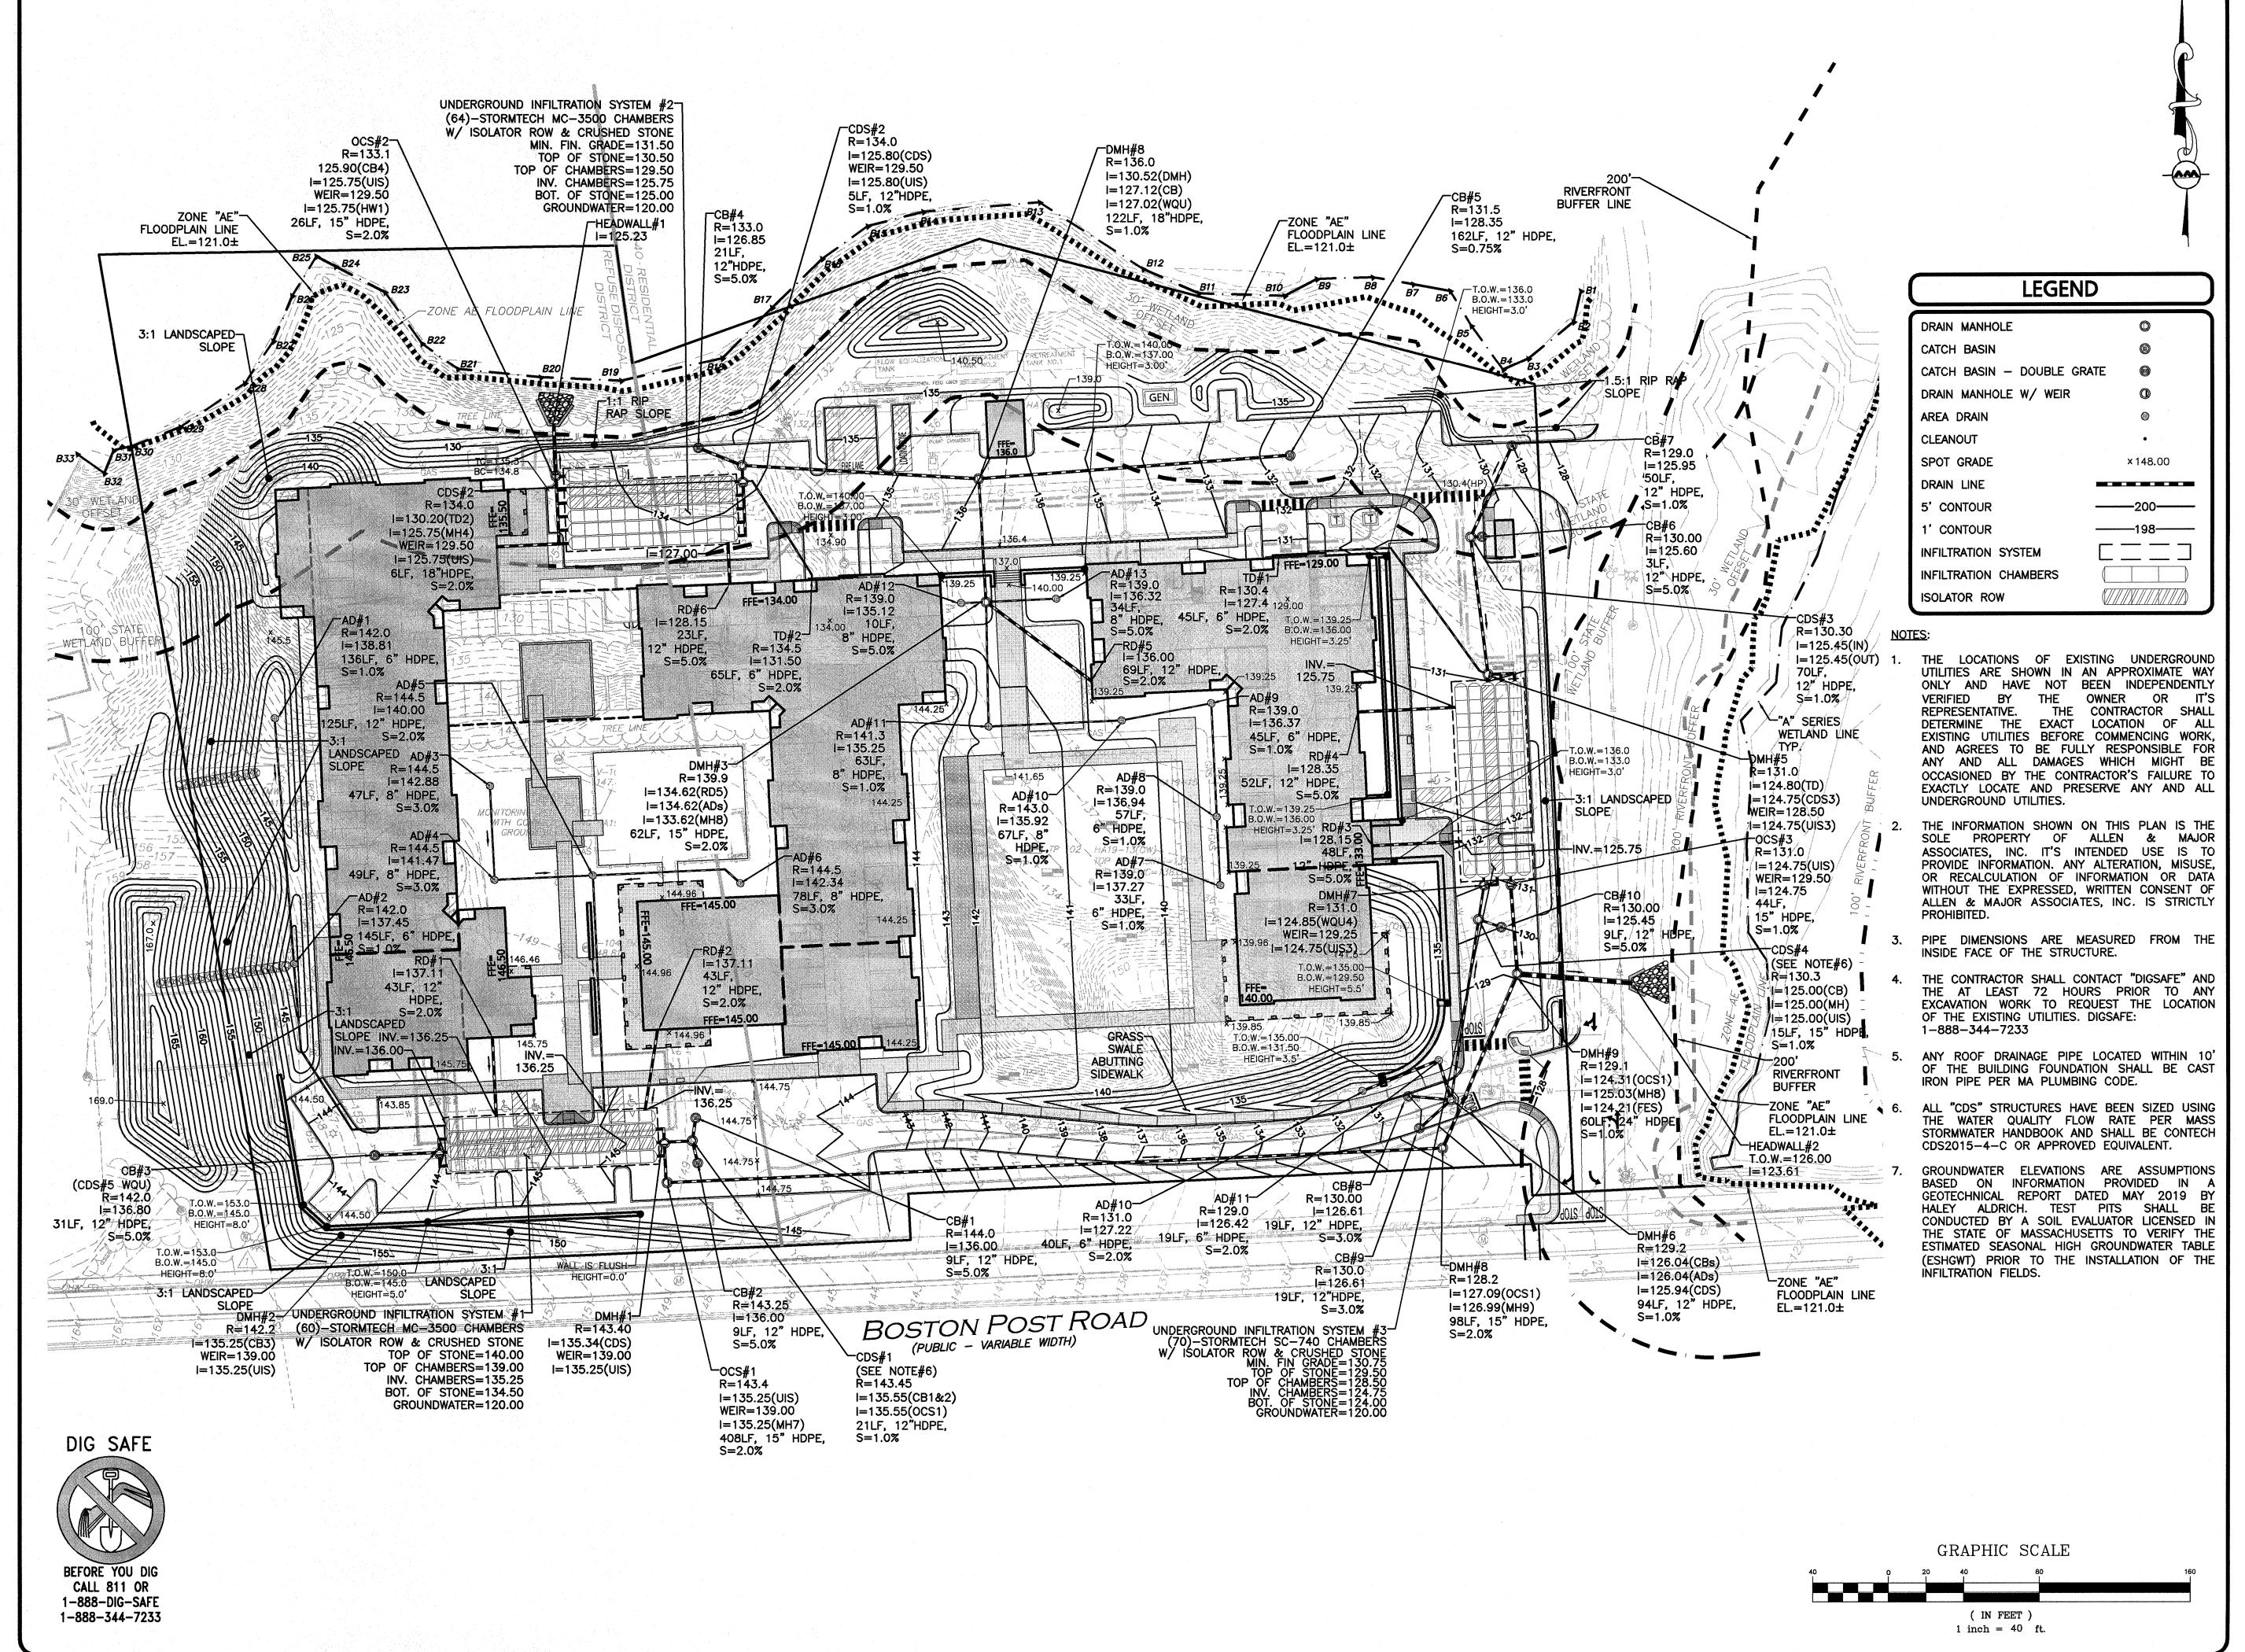
C-102

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LAYOUT & MATERIALS PLAN

BEFORE YOU DIG CALL 811 OR 1-888-DIG-SAFE 1-888-344-7233

DIG SAFE





ALLEN & MAJOR ASSOCIATES, INC.

	D.	10/18/2019	REVISED PER TOWN COMMENTS
	C.	10/10/2019	REVISED PER TOWN COMMENTS
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	A.	07/03/2019	ISSUED FOR NOTICE OF INTENT
ı	REV	DATE	DESCRIPTION

APPLICANT\OWNER:

WP EAST ACQUISITIONS, LLC. 91 HARTWELL AVENUE LEXINGTON, MA 02421

ALTA AT RIVER'S EDGE 490 BOSTON POST ROAD WAYLAND, MA

PROJECT NO.	1670-09A	DATE:	06-20-2019
SCALE:	1" =40'	DWG. NAME:	1670-09A
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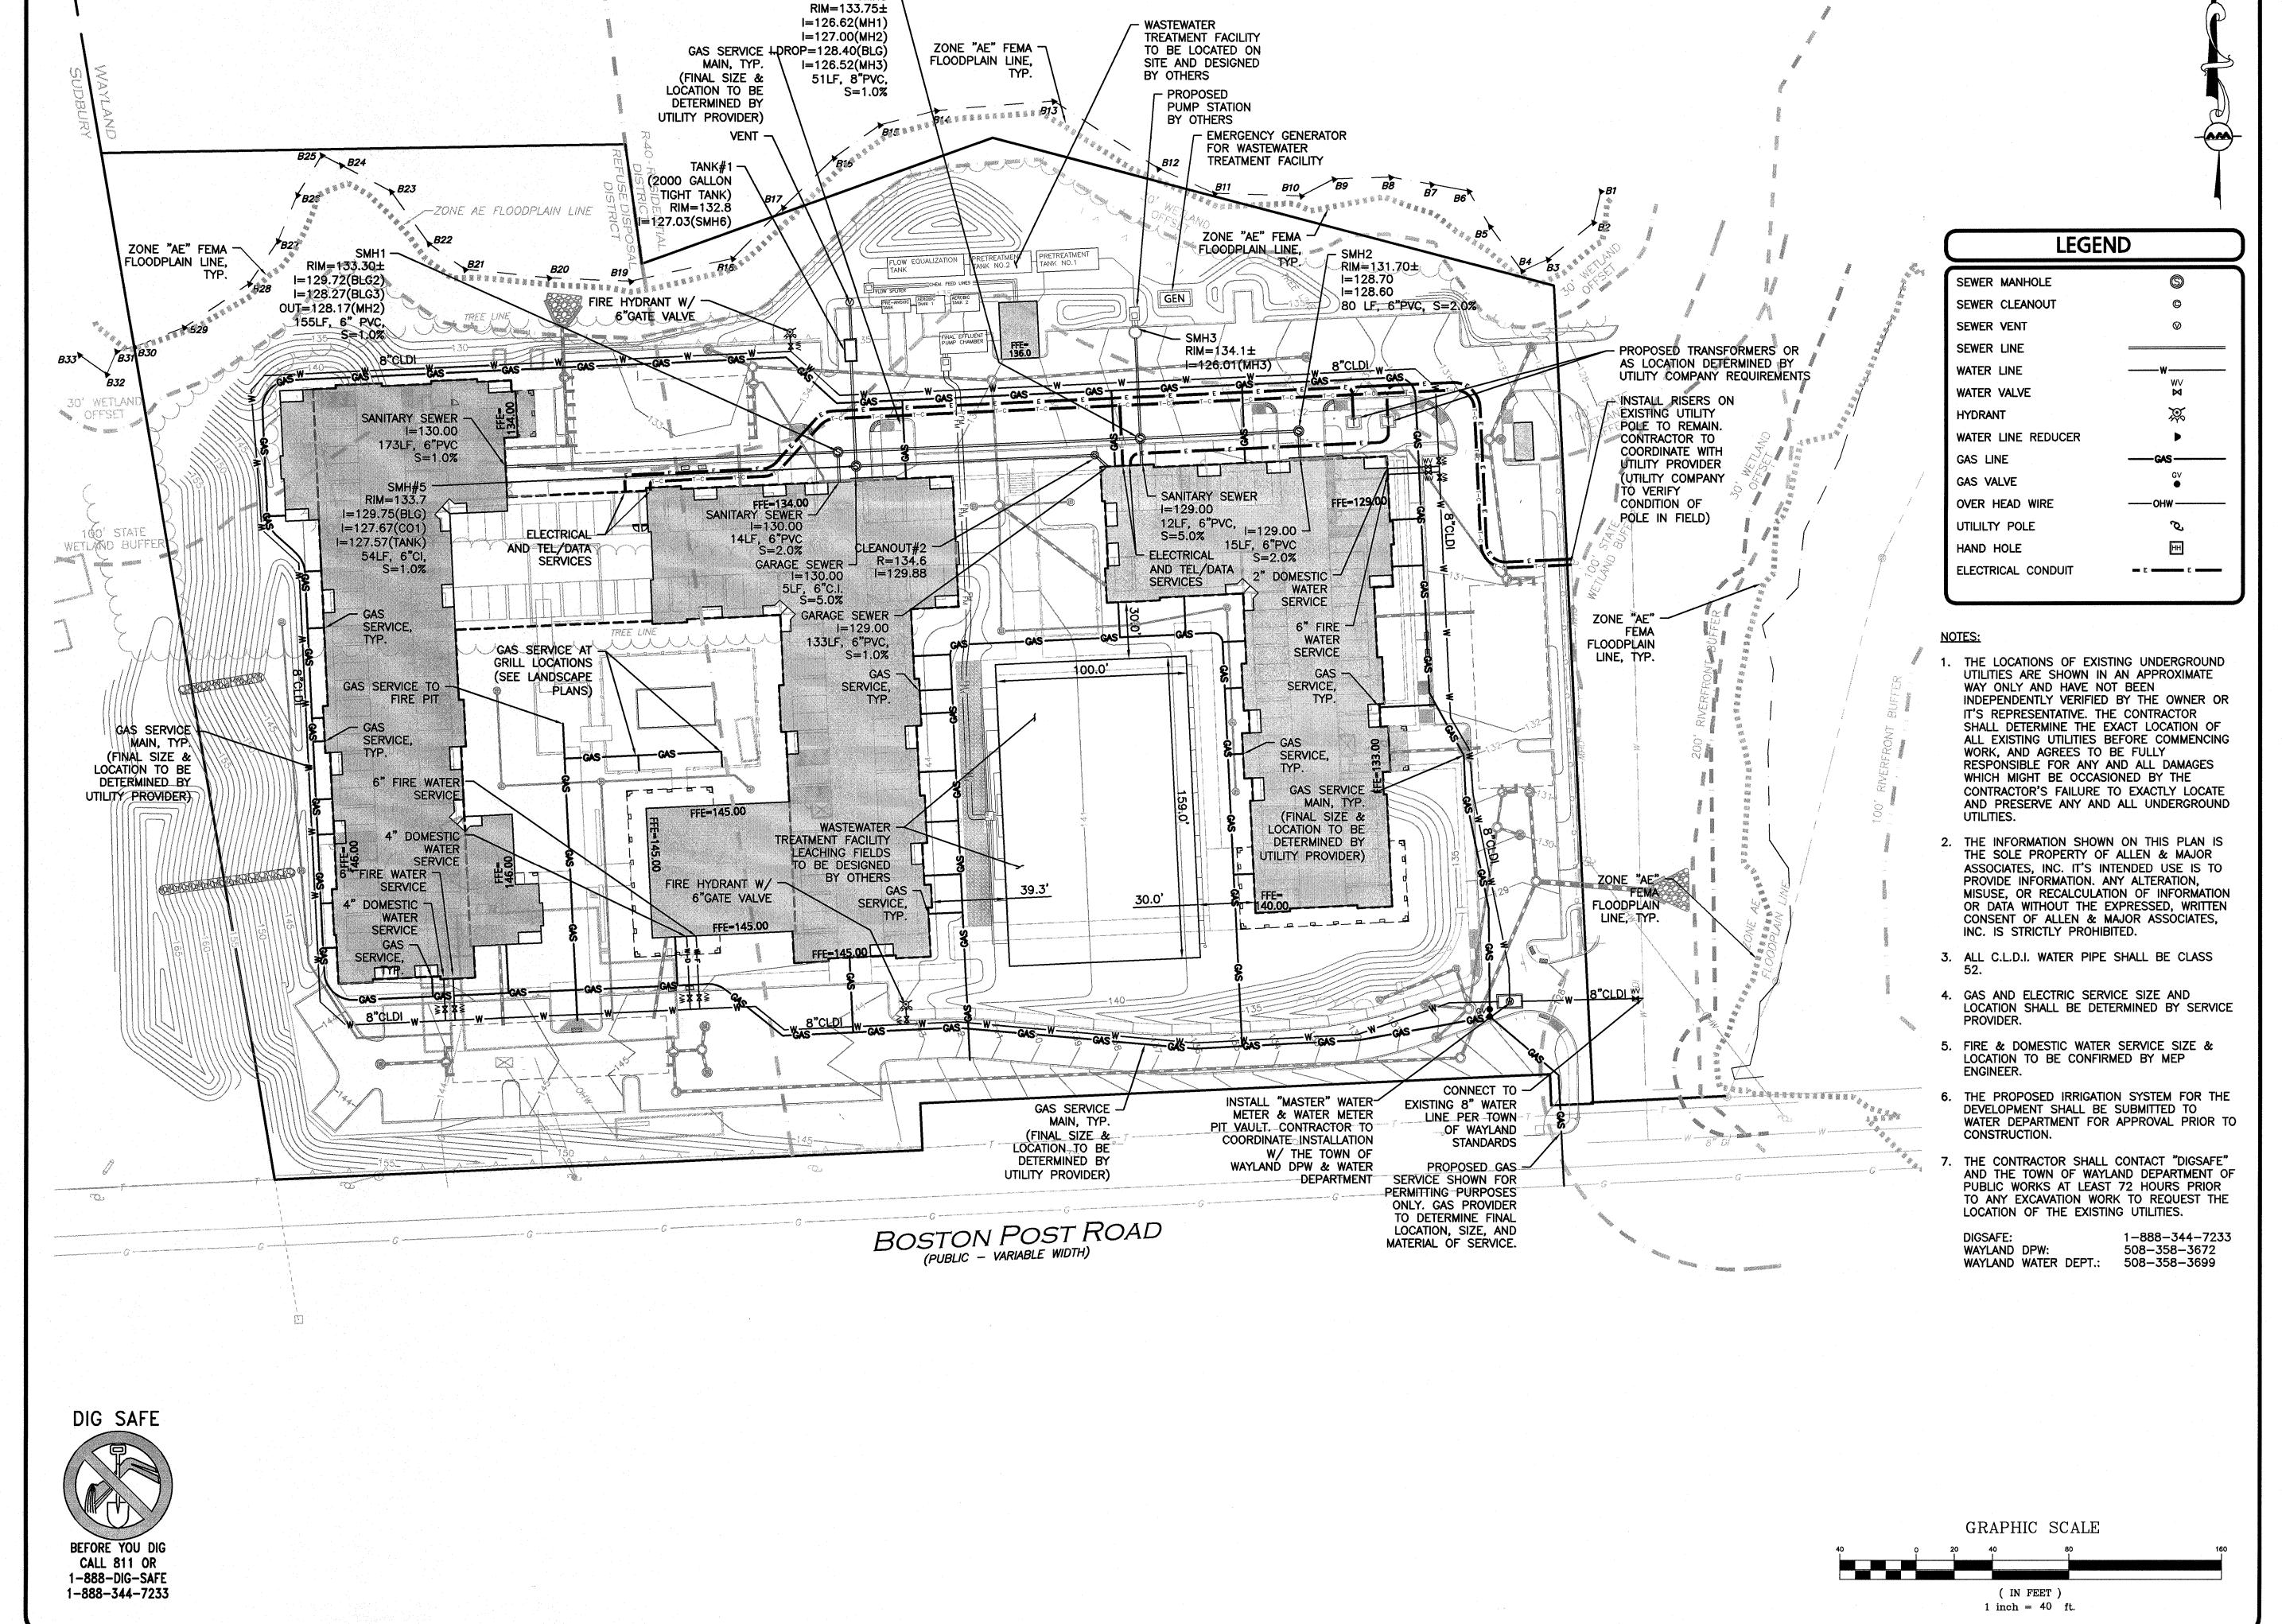
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GRADING & DRAINAGE PLAN | C-103





PROFESSIONAL ENGINEER FOR ALLEN & MAJOR ASSOCIATES, INC.

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C.	10/10/2019	REVISED PER TOWN COMMENTS
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A.	07/03/2019	ISSUED FOR NOTICE OF INTENT
REV	DATE	DESCRIPTION

APPLICANT\OWNER:

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PROJECT:

ALTA AT RIVER'S EDGE **490 BOSTON POST ROAD** WAYLAND, MA

PROJECT NO.	1670-09A	DATE:	06-20-201
SCALE:	1" =40'	DWG. NAME:	1670-09
DESIGNED BY:	SJL	CHECKED BY:	CMC



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SHEET No. **UTILITIES PLAN**

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C-104

N/F TOWN OF WAYLAND

FIRE APPARATUS

FIND

FI

TOWN OF WAYLAND

N88'53'05"E---


274.23

ZONE AE FLOODPLAIN LINE

619


PULL FORWARD TO -

THIS POINT

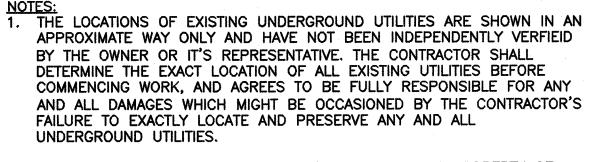

VEHICLE TO EXIT SITE AT THIS POINT

- 2. THE INFORMATION SHOWN ON THIS PLAN IS THE SOLE PROPERTY OF ALLEN & MAJOR ASSOCIATES, INC. IT'S INTENDED USE IS TO PROVIDE INFORMATION. ANY ALTERATION, MISUSE, OR RECALCULATION OF INFORMATION OR DATA WITHOUT THE EXPRESSED, WRITTEN CONSENT OF ALLEN & MAJOR ASSOCIATES, INC. IS STRICTLY PROHIBITED.
- FIRE APPARATUS MODEL OBTAINED FROM THE TOWN OF WAYLAND'S FIRE DEPARTMENT.

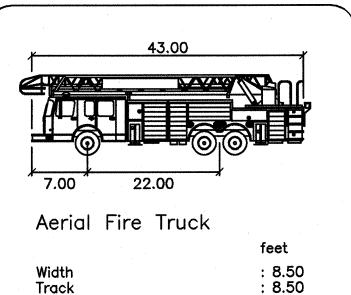

Width : 8.50
Track : 8.50
Lock to Lock Time : 6.0
Steering Angle : 33.3

- FIRE APPARATUS

MOVEMENT — BEGIN

APPLICANT\OWNER:

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REV DATE DESCRIPTION

PROFESSIONAL ENGINEER FOR ALLEN & MAJOR ASSOCIATES, INC.

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PROJECT:

ALTA AT RIVER'S EDGE 490 BOSTON POST ROAD WAYLAND, MA

PROJECT NO.	1670-09A	DATE:	06-20-2019
SCALE:	1" -40'	DWG. NAME:	1670-09/
DESIGNED BY:	SJL	CHECKED BY:	СМС



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DRAWING TITLE:

SHEET No.

FIRE TRUCK TURNING PLAN C-105

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N: (PROJECIS (10/0-034 CIVIL (DRAWINGS (CORREN) (C-10/0-034_FIRE TROCK MOVEMEN).DWG

GRAPHIC SCALE

O 20 40 80

(IN FEET)
1 inch = 40 ft.

MOUNTING HEIGHT = 20 FEET

MOUNTING HEIGHT

= 20 FEET

0 0 0.0 0.0 0.0 0.0


OFFSOT 0.0 0.0 0.1 1.0 5.1


100' STATE

0 0.0 0.0 0.1 0.5 3.0


0.0 0.0 0.1 0.1 1.0

0.0 0.0 0.0 0.1

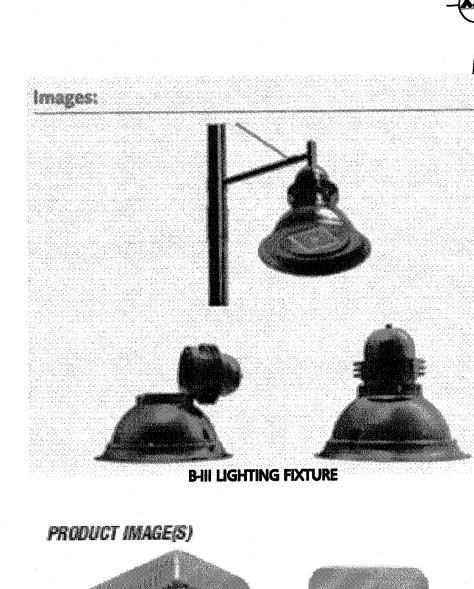

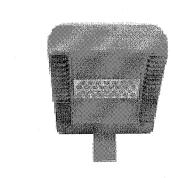



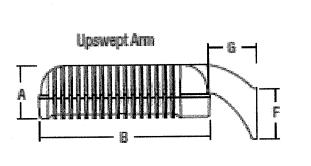


GRAPHIC SCALE

(IN FEET)


1 inch = 40 ft.


DRAWING TITLE:

LIGHTING PLAN

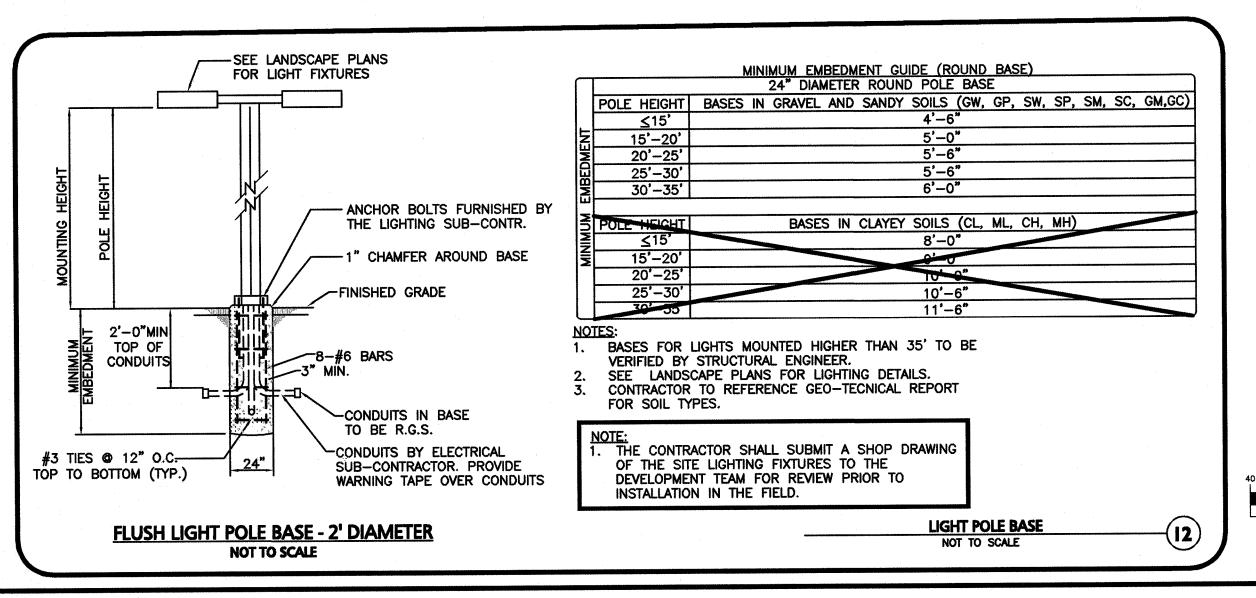

MOUNTING HEIGHT

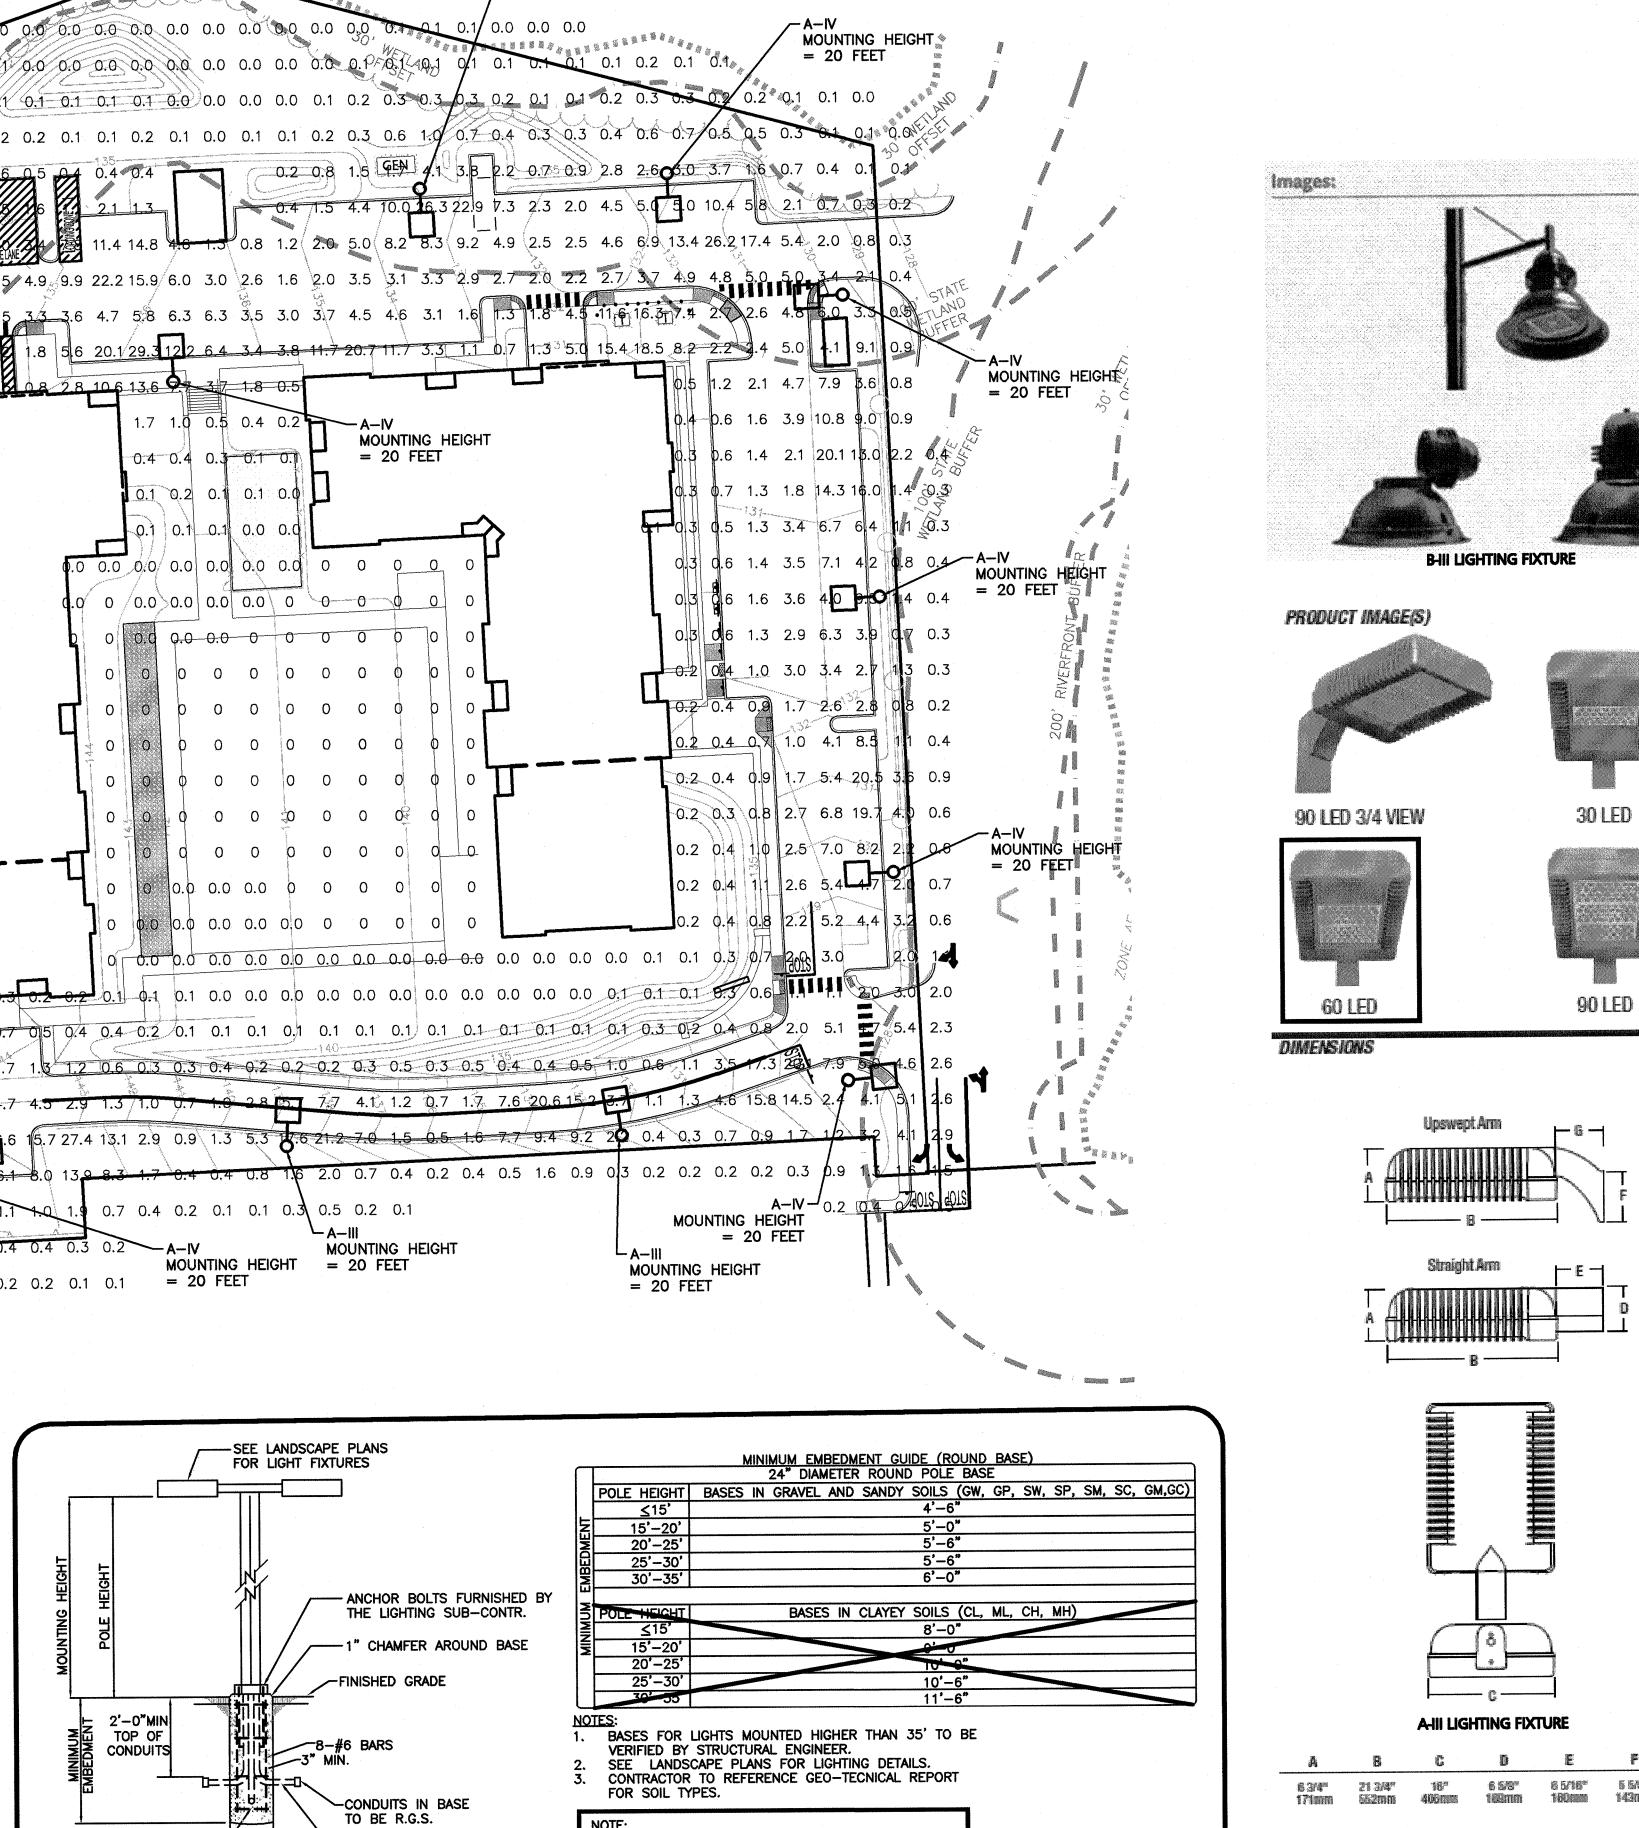

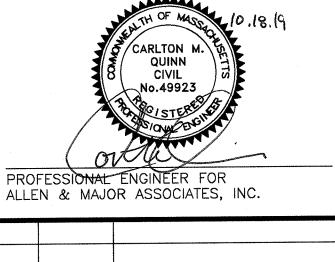

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ALTA AT RIVER'S EDGE 490 BOSTON POST ROAD WAYLAND, MA

06-20-2019 1670-09A DATE: PROJECT NO. SCALE: SJL CHECKED BY: **DESIGNED BY:**



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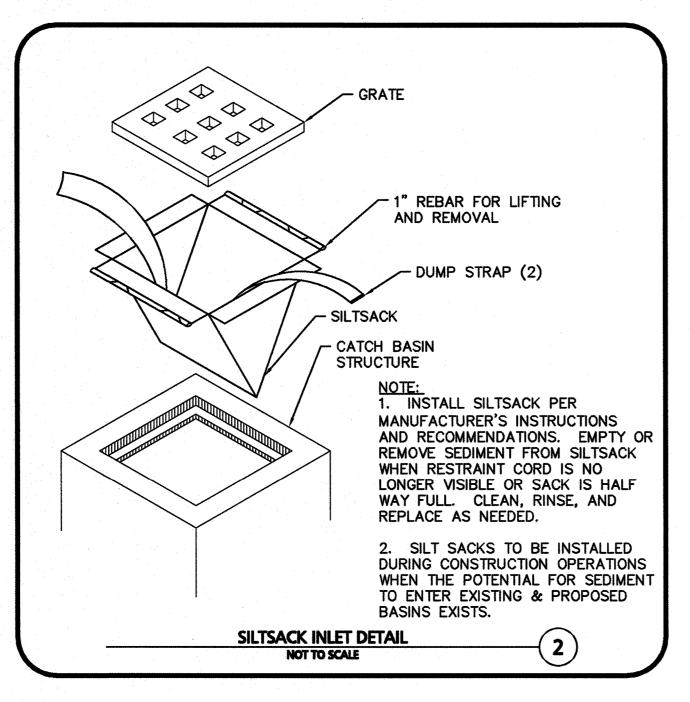
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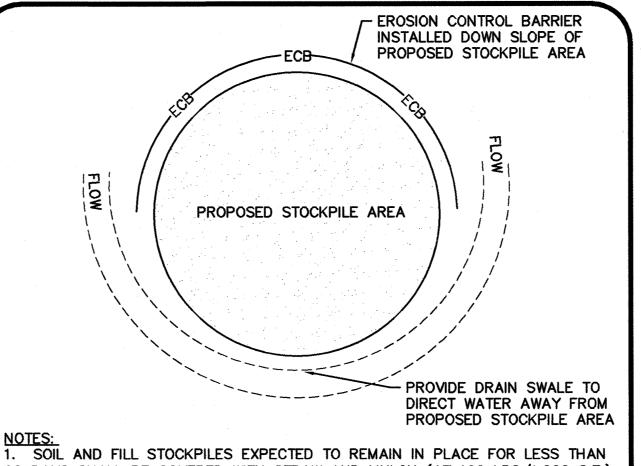
1. STRAW BALES SHALL BE POSITIONED IN A ROW SO THAT EACH END TIGHTLY ABUTTS THE ADJACENT BALE.

2. BALES SHALL BE SECURELY ANCHORED IN PLACE BY STAKES OR RE-BARS DRIVEN THROUGH THE BALES. THE FIRST STAKE IN EACH BALE SHALL BE ANGLED TOWARD PREVIOUSLY LAID BALE TO FORCE BALES TOGETHER.

3. FREQUENT INSPECTIONS SHALL BE CONDUCTED AND REPAIR OR REPLACEMENT SHALL BE MADE PROMPTLY IF NECESSARY.


TYPICAL CATCH BASIN FILTER






90 DAYS SHALL BE COVERED WITH STRAW AND MULCH (AT 100 LBS/1,000 S.F.) OR WITH AN ANCHORED TARP WITHIN 7 DAYS OR PRIOR TO ANY RAINFALL. 2. SOIL AND FILL STOCKPILES EXPECTED TO REMAIN IN PLACE FOR 90 DAYS OF MORE SHALL BE SEEDED WITH WINTER RYE (FOR FALL SEEDING AT 1LB/1,000 SF) OR OATS (FOR SUMMER SEEDING AT 2LB/1,000 SF) AND THEN COVERED WITH HAY MULCH (AT 100LB/1,000 SF) OR AN ANCHORED TARP WITHIN 7 DAYS OR PRIOR TO ANY RAINFALL.

STOCKPILE PROTECTION

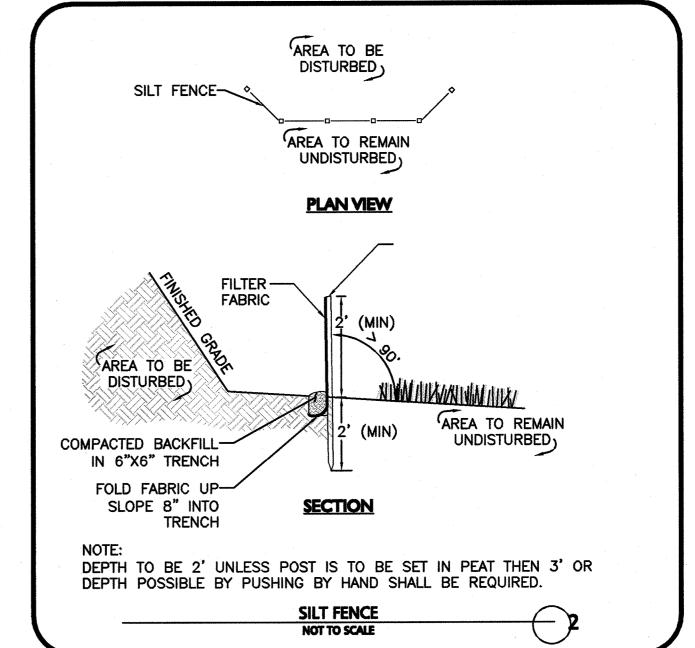

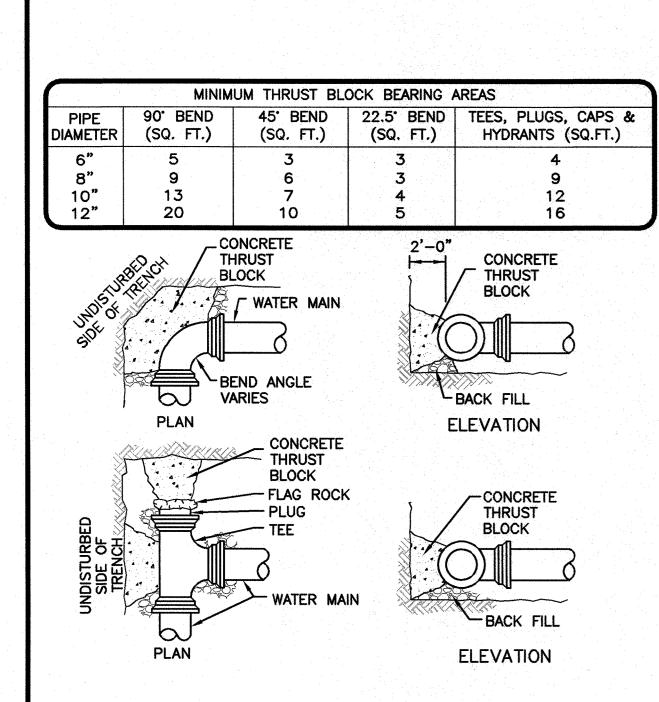

- ALL WATER MAIN FITTINGS, BENDS, TEES, PLUGS ETC. SHALL BE RESTRAINED WITH THRUST BLOCKS EXCEPT WHERE NOTED.
- ALL THRUST BLOCKS & COLLARS SHALL BE INSTALLED SO THAT THEY BEAR AGAINST UNDISTURBED EARTH.
- SIZE OF CONCRETE THRUST BLOCKS SHALL BE AS NOTED ABOVE.
- MINIMUM COMPRESSIVE STRENGTH OF THRUST BLOCK CONCRETE SHALL BE 3,000 P.S.I.
- KEEP CONCRETE CLEAR OF MECHANICAL JOINTS.
- THE BELOW PREDICATED ON A WATER PRESSURE OF 225 PSI AND A SOIL RESISTANCE OF 2000 PSF (TILL). FOR OTHER SOILS THE VALUES IN THE ABOVE TABLE SHALL BE MULTIPLIED BY:


SOFT CLAY 4


SAND & GRAVEL 1.33


ALL CAST-IN-PLACE THRUST BLOCKS SHALL BE FORMED UP WITH PLYWOOD SO THAT CONCRETE IS NOT CAST AROUND FITTINGS OR MECHANICAL JOINTS.


WATER THRUST BLOCKS


GATE VALVE NOT TO SCALE

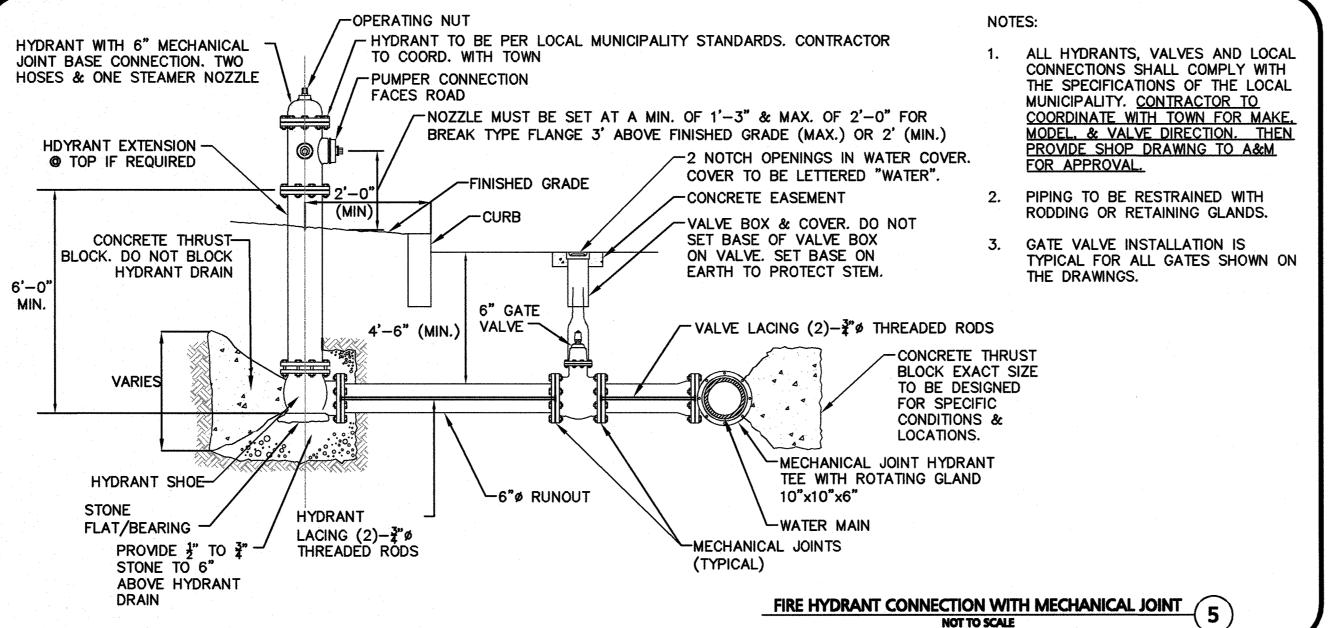

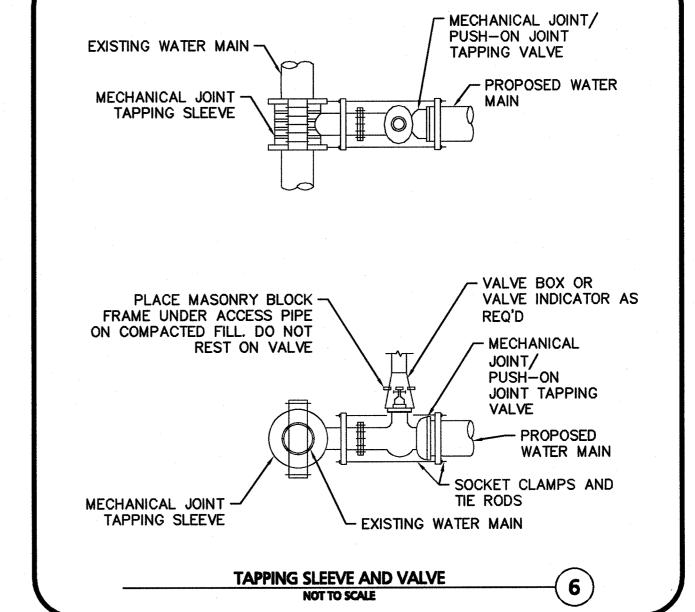

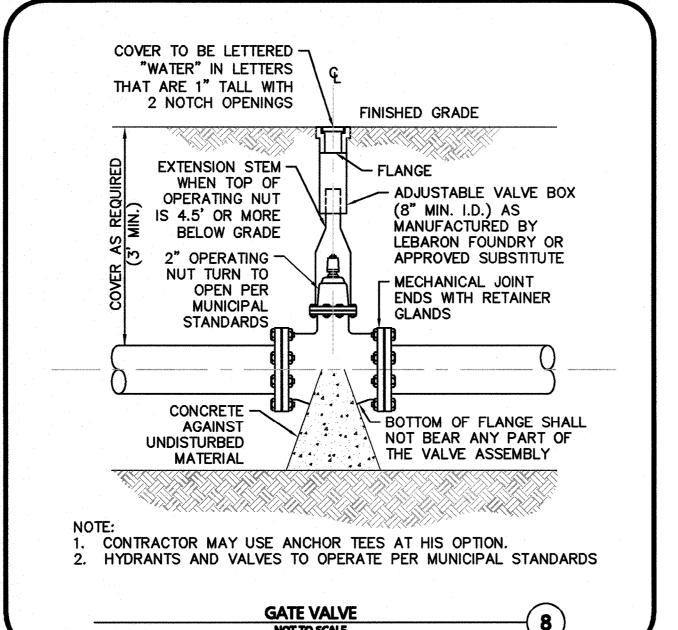

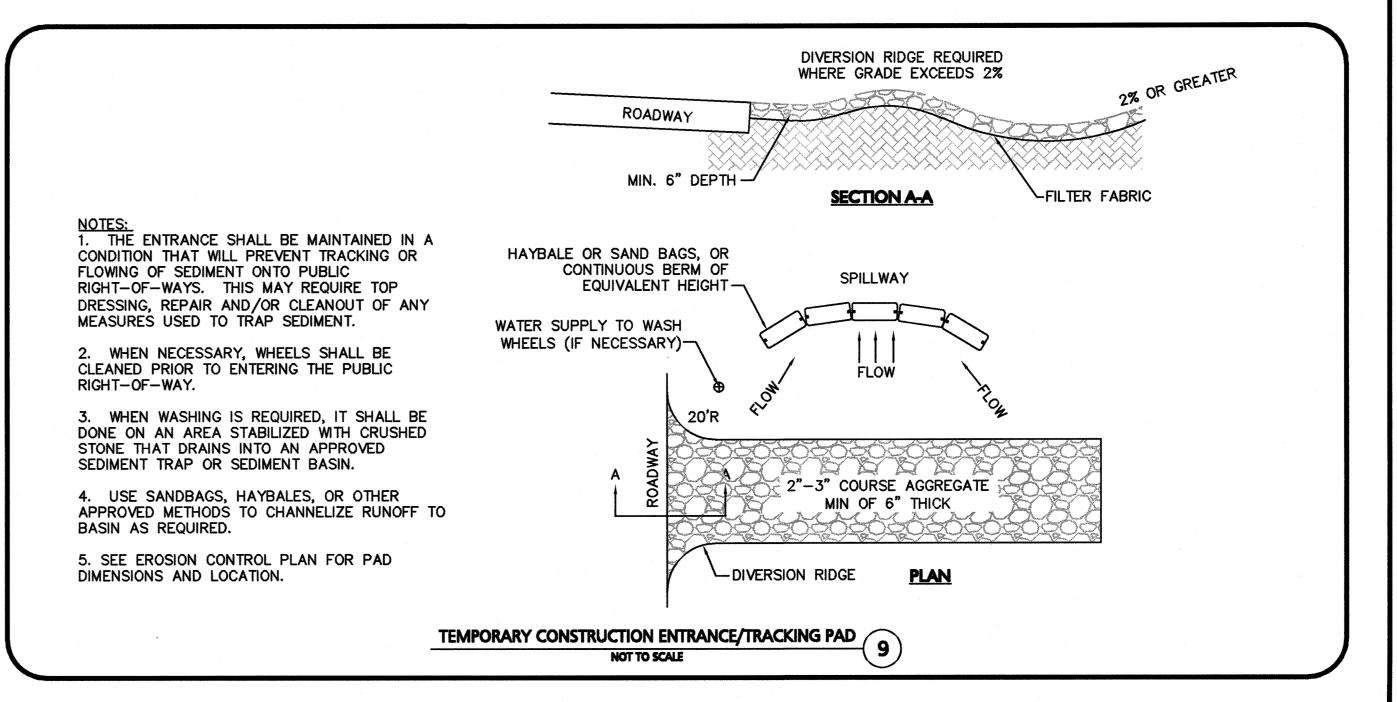

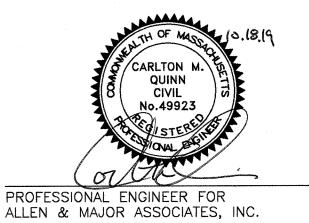

10/18/2019 REVISED PER TOWN COMMENTS 10/10/2019 REVISED PER TOWN COMMENTS 09/27/2019 REVISED PER TOWN COMMENTS A. 07/03/2019 ISSUED FOR NOTICE OF INTENT

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ALTA AT RIVER'S EDGE 490 BOSTON POST ROAD WAYLAND, MA

1670-09A DATE: 06-20-2019 PROJECT NO. AS SHOWN DWG. NAME: **DESIGNED BY:** SJL | CHECKED BY:



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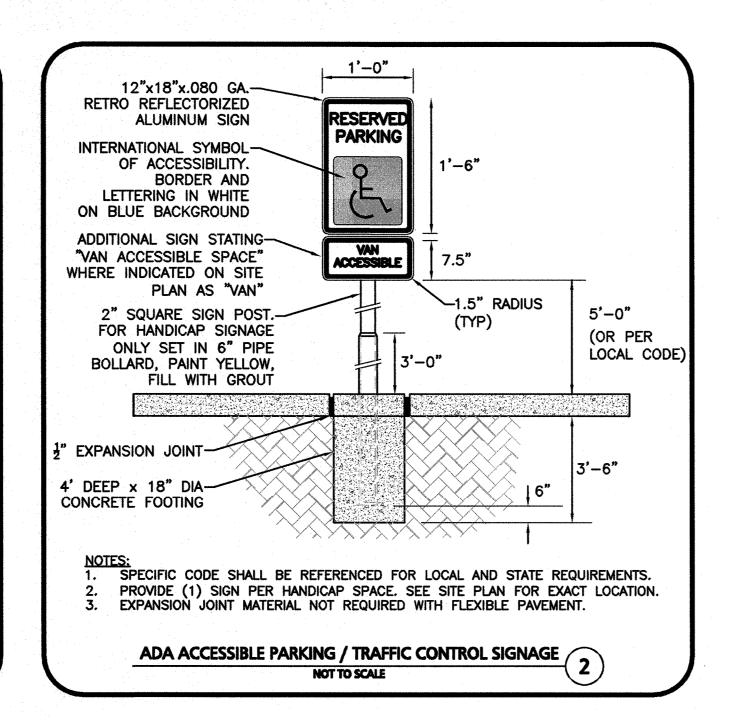
DETAILS


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2" X 2" X 36" WOODEN STAKES -


DO NOT PIERCE TUBULAR BARRIER

3. THE CONTRACTOR SHALL MAINTAIN THE TUBULAR BARRIERS IN A FUNCTIONAL CONDITION AT ALL TIMES. THE CONTROLS SHALL BE

4. WHERE THE TUBULAR BARRIERS REQUIRE REPAIR OR SEDIMENT REMOVAL, IT WILL BE COMPLETED BY THE CONTRACTOR AT NO ADDITIONAL COST.

5. AT A MINIMUM, THE CONTRACTOR SHALL REMOVE SEDIMENTS COLLECTED AT THE BASE WHEN THEY REACH 1/3 THE EXPOSED HEIGHT OF THE BARRIER.

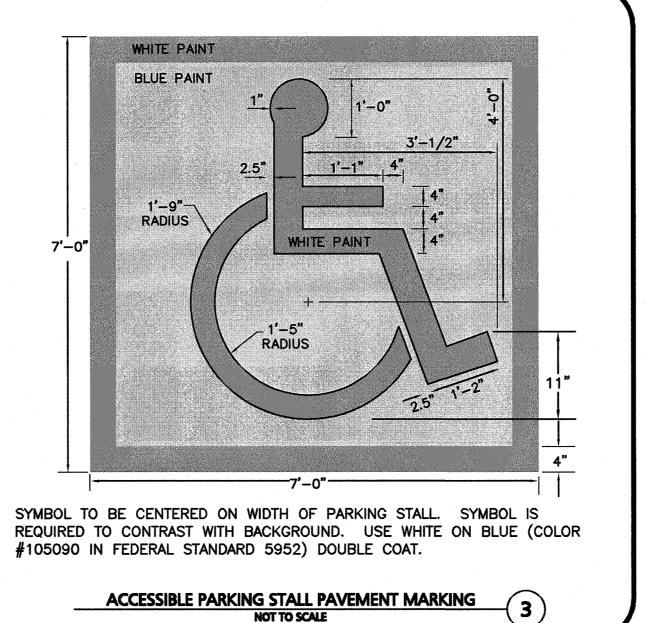(NOT REQUIRED IF IN PAVEMENT)

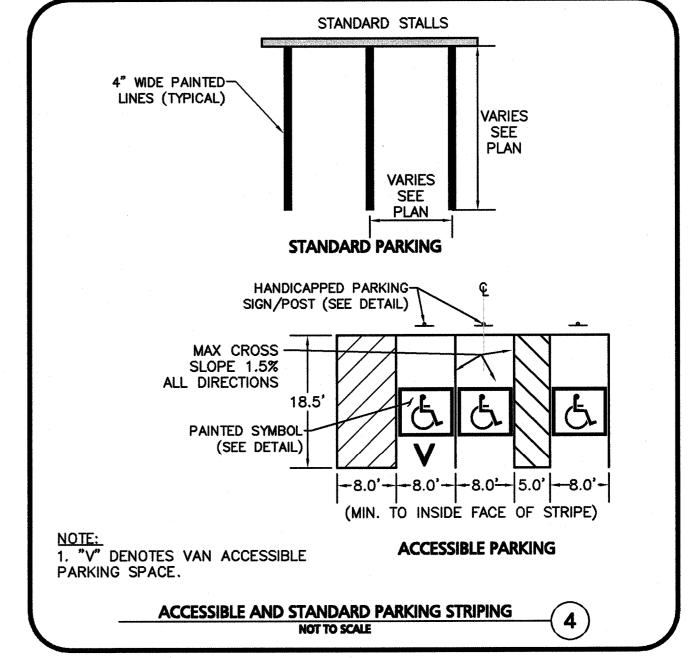


- 12" MIN. DIAMETER TUBULAR SEDIMENT CONTROL

(MESH TUBE WITH NATURAL FILTER MEDIA)

BY FILTREXX OR APPROVED EQUAL.

C—EARTH

PROFILE

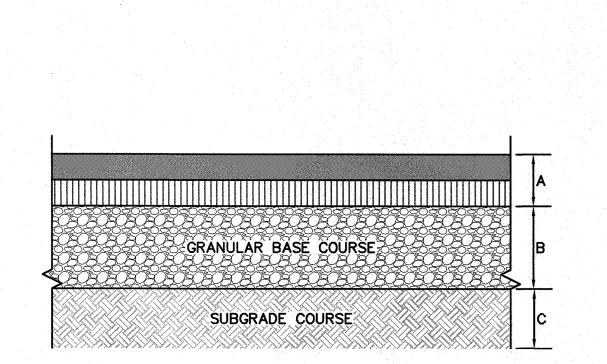

NOTES:

- COMPACT SOIL SUBGRADE UNIFORMLY TO AT LEAST 95 PERCENT OF ASTM D1557 LABORATORY DENSITY.
- PROOF-ROLL PREPARED SUBGRADE TO IDENTIFY SIFT POCKETS AND AREAS OF EXCESS YIELDING. EXCAVATE SOFT SPOTS, UNSATISFACTORY SOILS, AND AREAS OF EXCESSIVE PUMPING OR RUTTING, AS DETERMINED BY GEOTECHNICAL ENGINEER AND REPLACE WITH COMPACTED BACKFILL OR FILL AS DIRECTED.
- CONTRACTOR SHALL COORDINATE SURFACE, BINDER, BASE, AND SUBBASE COURSES WITH GEOTECHNICAL OR SOILS REPORT. REFER TO REPORT FOR RECOMMENDATIONS FOR LOCAL SOILS OR DRAINAGE CONDITIONS AND/OR METHODS.
- 4. BASE COURSE SHALL EXTEND 6 INCHES BEYOND PAVEMENT EDGE WHERE PAVEMENT DOES NOT ABUT CURB, WALL, STEPS, OR FIXED OBJECT.
- 5. PAVEMENT EDGES SHALL BE TAMPED WHRE PAVEMENT DOES NOT ABUT CURB, WALL, STEPS, OR FIXED OBJECT.


STANDARD DUTY PAVING A= 1.5" ASPHALT CONCRETE - SURFACE COURSE (M.3.11.3, TABLE A, TOP COURSE) 2.0" ASPHALT CONCRETE - BINDER COURSE (M.3.11.3, TABLE A, BINDER COURSE)

B= 8" BASE COURSE (MHD 2.01.7)

C= 10" SUBBASE COURSE (MHD 1.03.1, PROCESSED GRAVEL FOR SUBBASE)

SEE SECTION 4.11 OF GEOTECHNICAL REPORT BY HALEY & ALDRICH DATED MAY 2019 FOR RECOMMENDED BITUMINOUS PAVEMENT SECTION.

> STANDARD DUTY BITUMINOUS PAVEMENT NOT TO SCALE

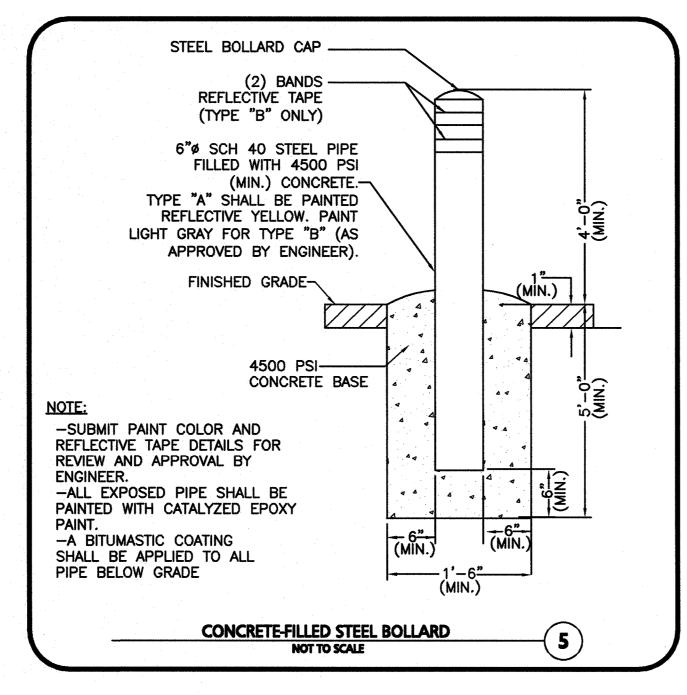

SEE TYPICAL

2500 PSI (MIN)

FULL LENGTH


FRONT SIDE


CONCRETE

PAVEMENT

SECTION

DETAIL

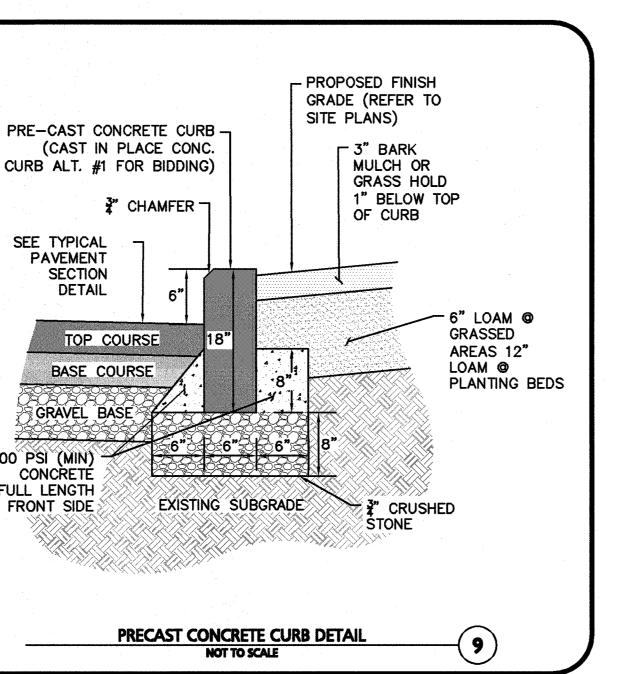

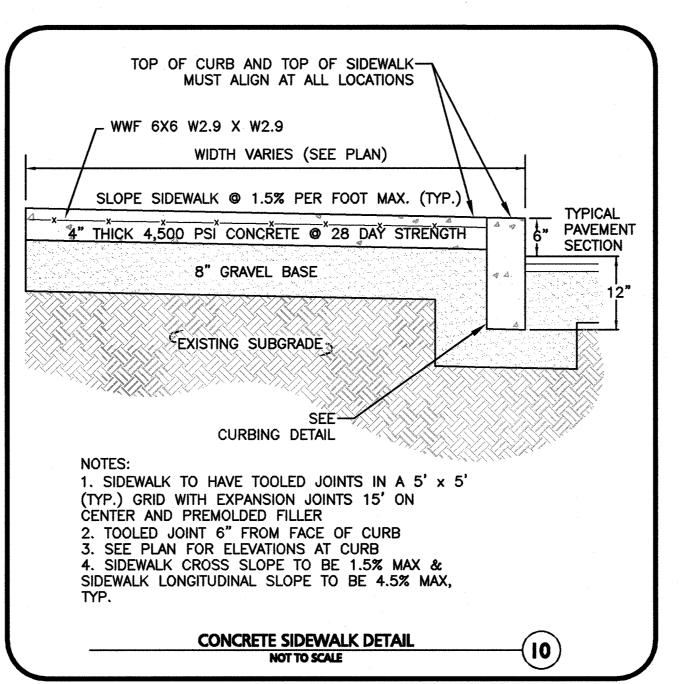


1. ALL MATERIALS TO MEET MANUFACTURERS SPECIFICATIONS.

2. OVERLAP TUBULAR BARRIER SEGMENTS A MINIMUM OF 12".

ROUTINELY INSPECTED BY THE CONTRACTOR.


2. INSTALL WOODEN STAKES IN A CRISS-CROSS PATTERN EVERY 8' ON CENTER.

NOTES:

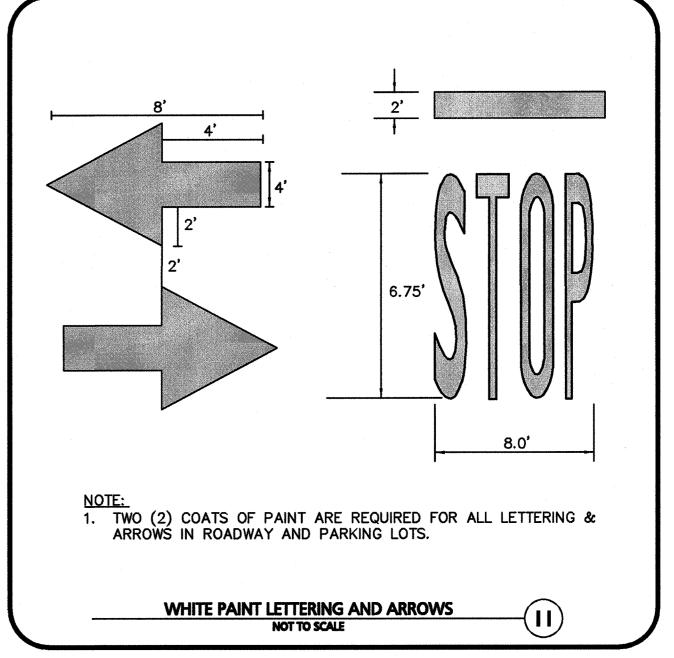

TUBULAR SEDIMENT BARRIER

NOT TO SCALE

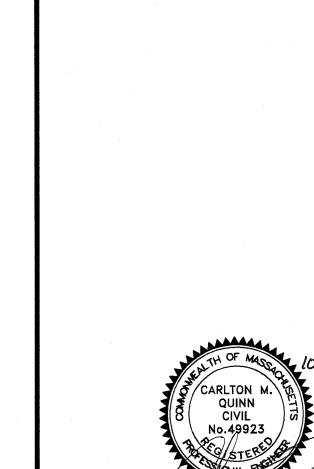

PROFESSIONAL ENGINEER FOR ALLEN & MAJOR ASSOCIATES, INC.

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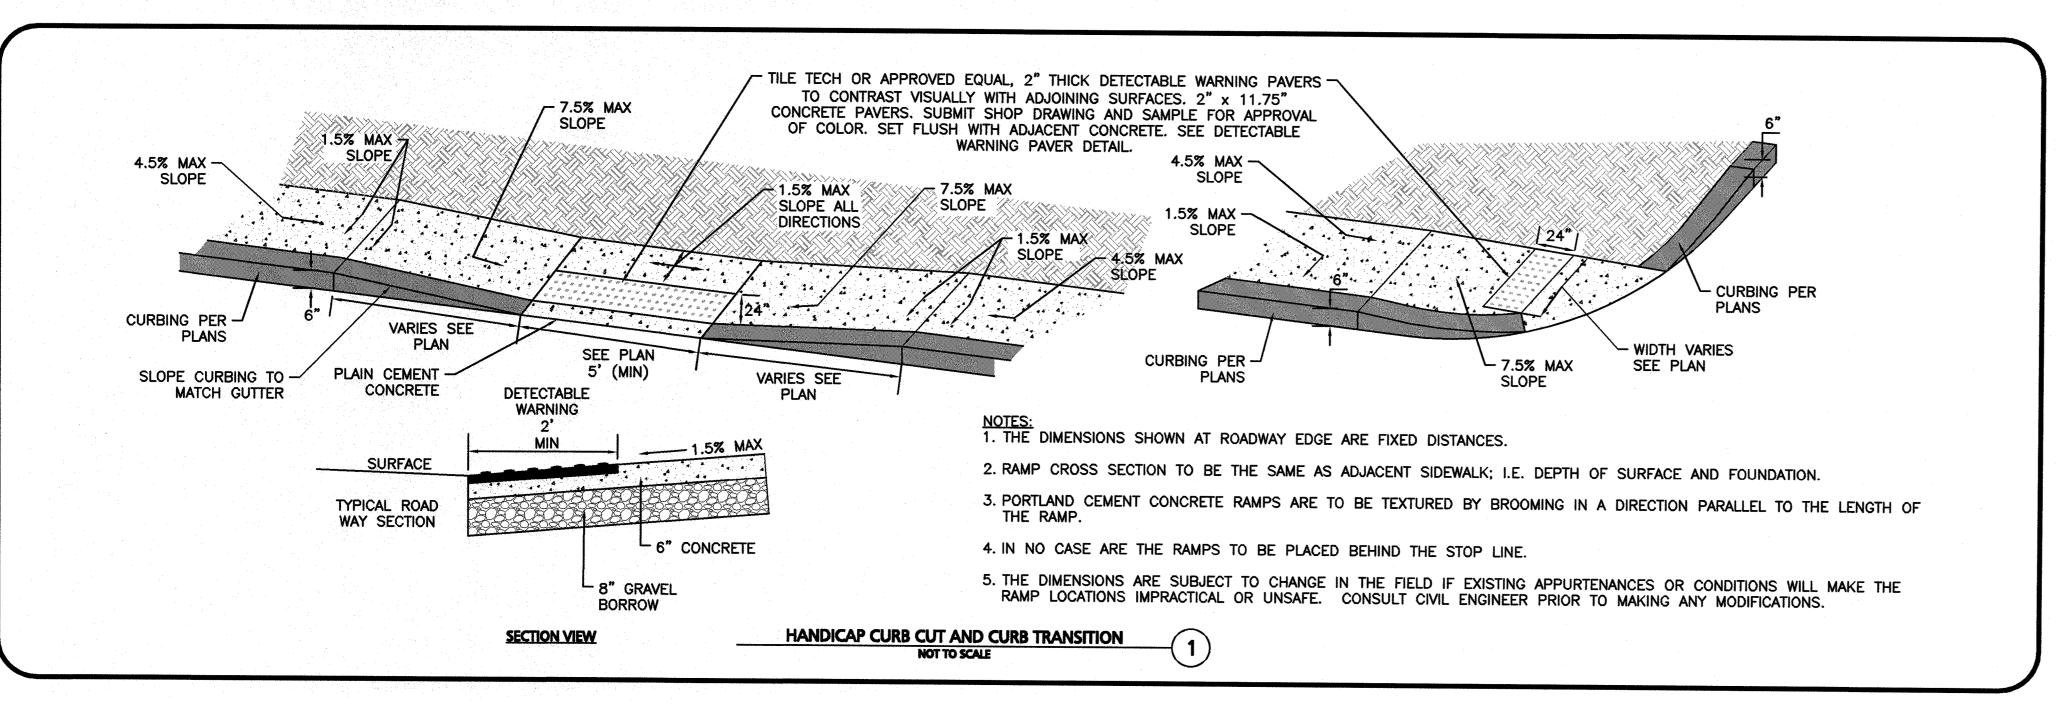
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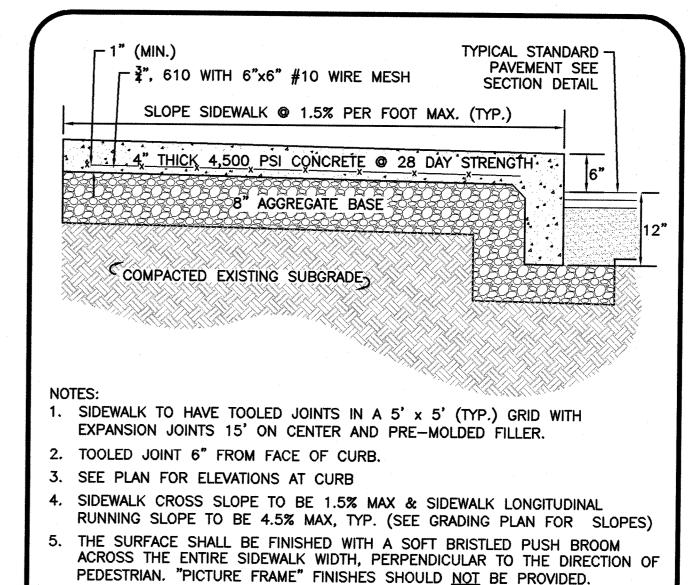
DETAILS

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C-502


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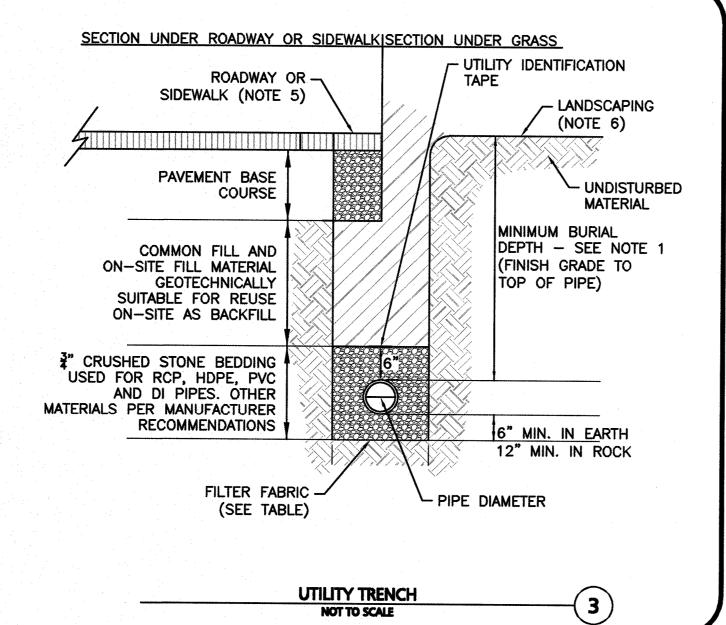








- MINIMUM BURIAL DEPTH (FINISH GRADE TO TOP OF PIPE) GRAVITY PIPE (SEWER & DRAIN) - SEE PLAN OR PROFILE PRESSURE PIPE UNDER PAVING - 4' PRESSURE PIPE BENEATH UNPAVED - 3' WATER PIPE - 5'
- WHERE BACKFILL IS DESIGNATED AS COMPACTED, THIS MEANS 90 TO 95% STANDARD PROCTOR. AASHTO T-99. ALL FILL PLACED BELOW PIPES AND STRUCTURES MUST MEET THIS REQUIREMENT.
- TRENCHES WITHIN PUBLIC RIGHT OF WAY MAY REQUIRE FLOWABLE FILL. VERIFY WITH MUNICIPAL ENGINEER.
- WHERE WASTE FILLS ARE ENCOUNTERED AT SUBGRADE LEVEL FOR NEW UTILITIES, THE FILL SHOULD BE OVER-EXCAVATED, THE SUBGRADE SHOULD BE RE-COMPACTED, AND BACKFILL CONSISTING OF PIPE BEDDING MATERIAL, CRUSHED STONE OR OTHER SUITABLE GRANULAR FILL SHOULD BE PLACED TO A SUFFICIENT DEPTH TO CREATE A FIRM AND STABLE SUBGRADE (TYPICALLY 12 TO 18 INCHES OVER-EXCAVATION).
- REFER TO PAVING, CURBS, WALKS AND DRIVEWAY DETAILS.
- REFER TO LANDSCAPING DETAILS.



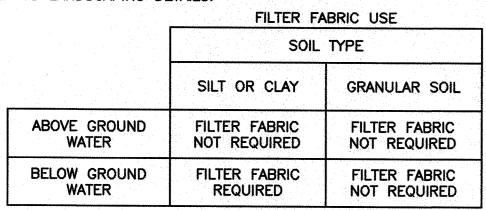

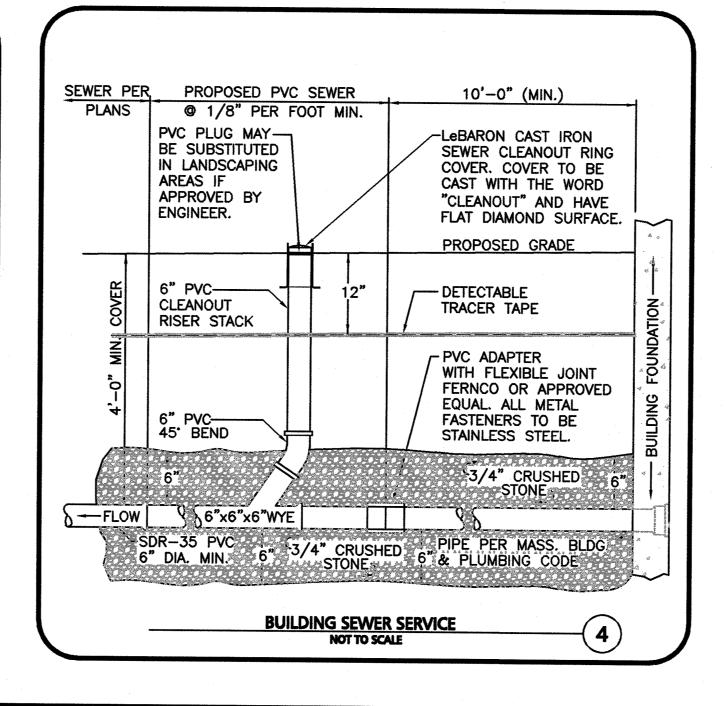

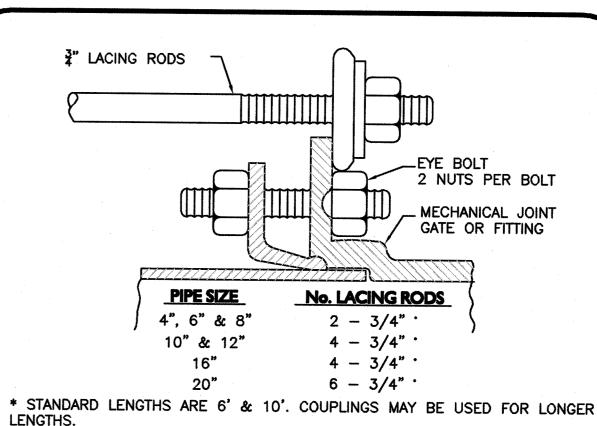


MONOLITHIC CONCRETE SIDEWALK WITH 6" REVEAL

NUMBER OF LACING RODS IS BASED ON MAXIMUM PRESSURE OF 125 P.S.I. IN MAIN.


- 2. EYE-BOLTS AND LACING RODS ARE TO BE FABRICATED FROM A-36
- STEEL LACING RODS SHALL HAVE A YIELD STRESS OF NOT LESS THAN
- 36,000 P.S.I. EYE-BOLTS SHALL HAVE A MINIMUM TENSILE STRENGTH OF 7,000 LBS.


MECHANICAL JOINT LACING DETAIL

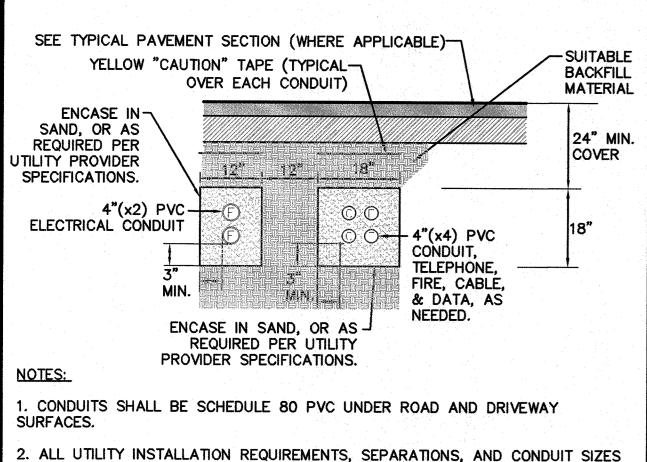

- TO BE VERIFIED WITH EACH UTILITY COMPANY PRIOR TO INSTALLATION OF ANY UNDERGROUND UTILITY CONDUIT.
- 3. SEE SITE ELECTRICAL PLANS FOR SPECIFIC SERVICE PROVIDER DETAILS.

BURIED CONDUIT DETAIL
NOT TO SCALE

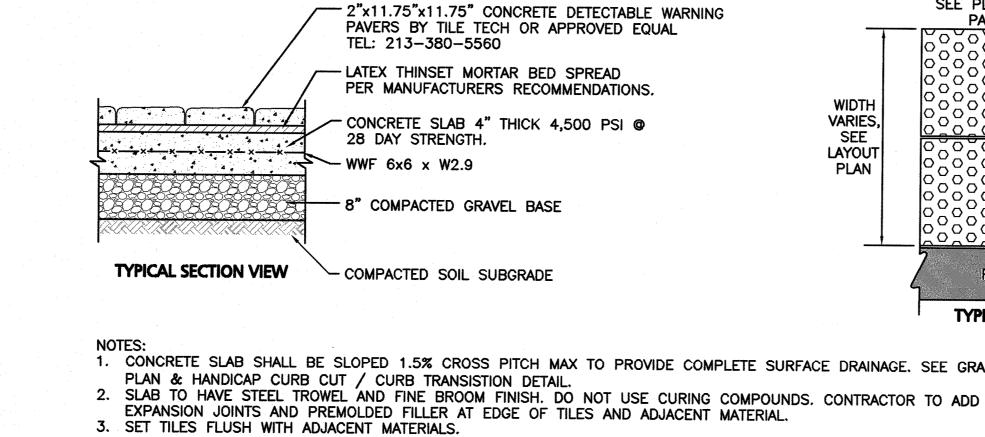


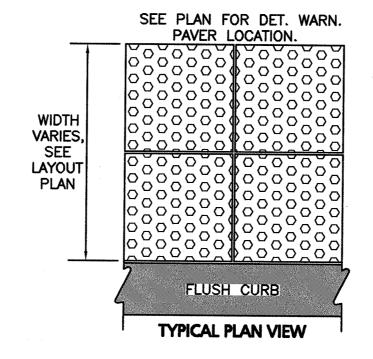


1. CONCRETE SLAB SHALL BE SLOPED 1.5% CROSS PITCH MAX TO PROVIDE COMPLETE SURFACE DRAINAGE. SEE GRADING PLAN & HANDICAP CURB CUT / CURB TRANSISTION DETAIL.

- EXPANSION JOINTS AND PREMOLDED FILLER AT EDGE OF TILES AND ADJACENT MATERIAL.
- 4. SUBMIT SHOP DRAWINGS OF TILES AND SAMPLE FOR APPROVAL OF COLOR TO OWNER / ARCH.
- 5. INSTALL DETECTABLE WARNING PAVERS PER MANUFACTURER'S RECOMMENDATIONS OR DÉSIGN ENGINEER.
- 6. ALL DET. WARN. PAVERS SHALL COMPLY WITH ADA REGULATIONS.

DETECTABLE WARNING PAVERS NOT TO SCALE

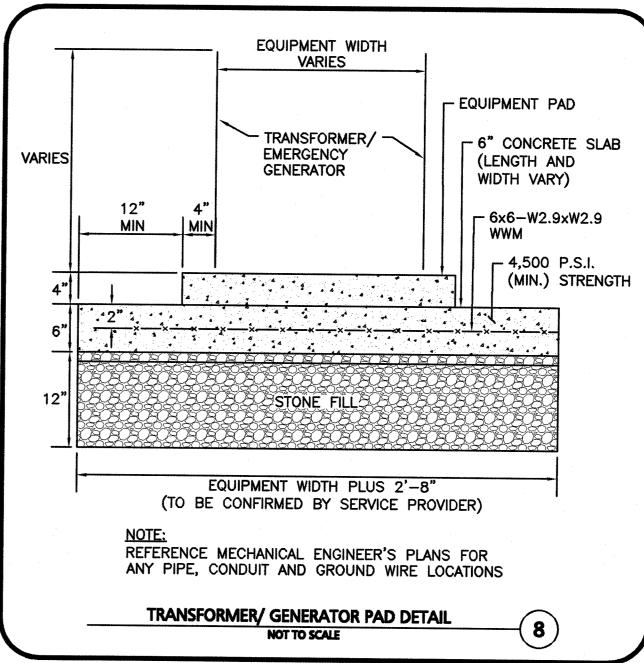

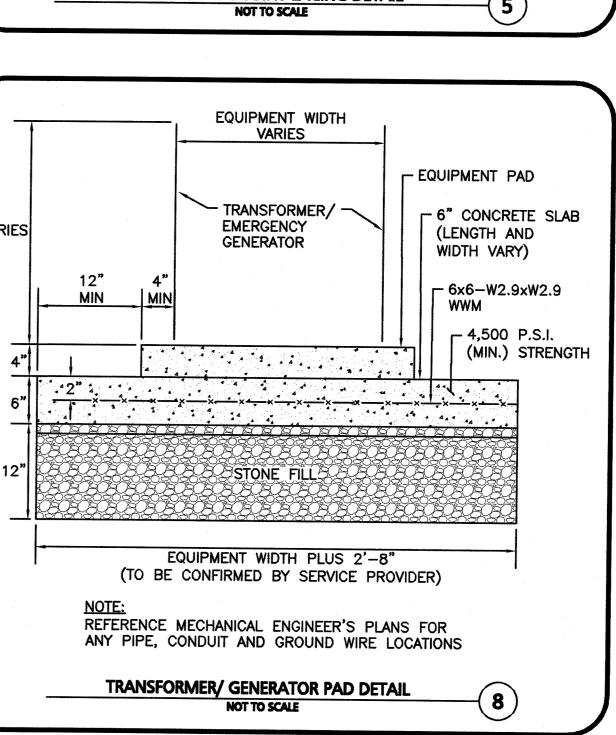

100 COMMERCE WAY, SUITE 5 WOBURN MA 01801 TEL: (781) 935-6889 FAX: (781) 935-2896 WOBURN, MA ♦ LAKEVILLE, MA ♦ MANCHESTER, N THIS DRAWING HAS BEEN PREPARED IN ELECTRONIC FORMAT. CLIENT/CLIENT'S REPRESENTATIVE OR CONSULTANT MAY BE PROVIDED COPIES OF DRAWINGS AND SPECIFICATIONS ON MAGNETIC MEDIA FOR HIS/HER INFORMATION AND USE FOR SPECIFIC APPLICATION TO THIS PROJECT. DUE TO THE POTENTIAL THAT THE MAGNETIC INFORMATION MAY BE MODIFIED UNINTENTIONALLY OR OTHERWISE, ALLEN & MAJOR ASSOCIATES, INC. MAY REMOVE ALL INDICATION OF THE DOCUMENT'S AUTHORSHIP ON THE MAGNETIC MEDIA. PRINTED REPRESENTATIONS OF THE DRAWINGS AND SPECIFICATIONS ISSUED SHALL BE THE ONLY RECORD COPIES OF ALLEN & MAJOR ASSOCIATES, INC.'S WORK PRODUCT. DRAWING TITLE: SHEET No.

CARLTON N

CIVIL

No.49923

PROFESSIONAL ENGINEER FOR

REV DATE DESCRIPTION

91 HARTWELL AVENUE

LEXINGTON, MA 02421

APPLICANT\OWNER:

PROJECT:

PROJECT NO.

DESIGNED BY:

SCALE:

ALLEN & MAJOR ASSOCIATES, INC.

D. 10/18/2019 REVISED PER TOWN COMMENTS

C. 10/10/2019 REVISED PER TOWN COMMENTS

B. 09/27/2019 REVISED PER TOWN COMMENTS

ALTA AT RIVER'S EDGE

490 BOSTON POST ROAD

WAYLAND, MA

1670-09A DATE:

AS SHOWN DWG. NAME:

ALLEN & MAJOR

ASSOCIATES, INC.

ivil & structural engineering • land surveying

environmental consulting • landscape architecture

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SJL | CHECKED BY:

06-20-2019

1670-09A


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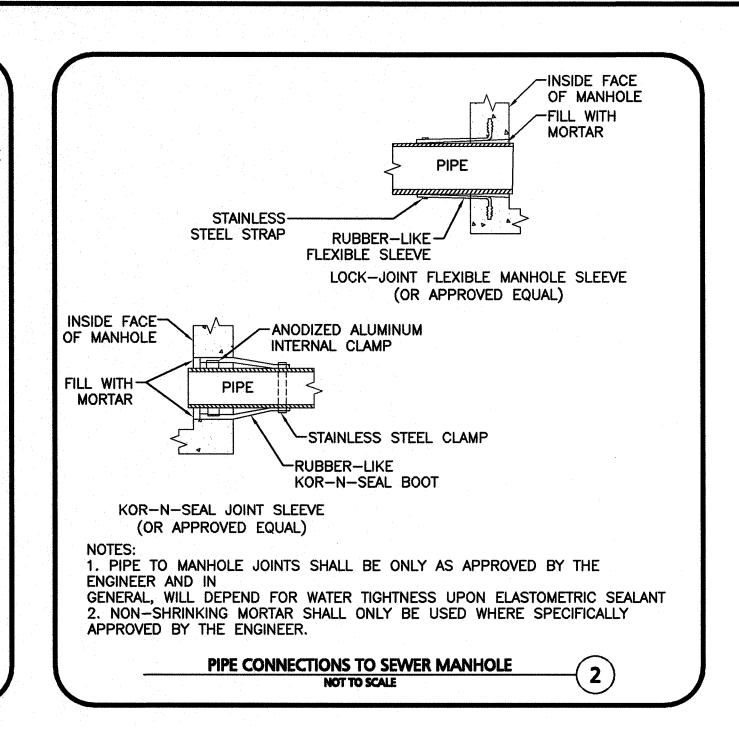
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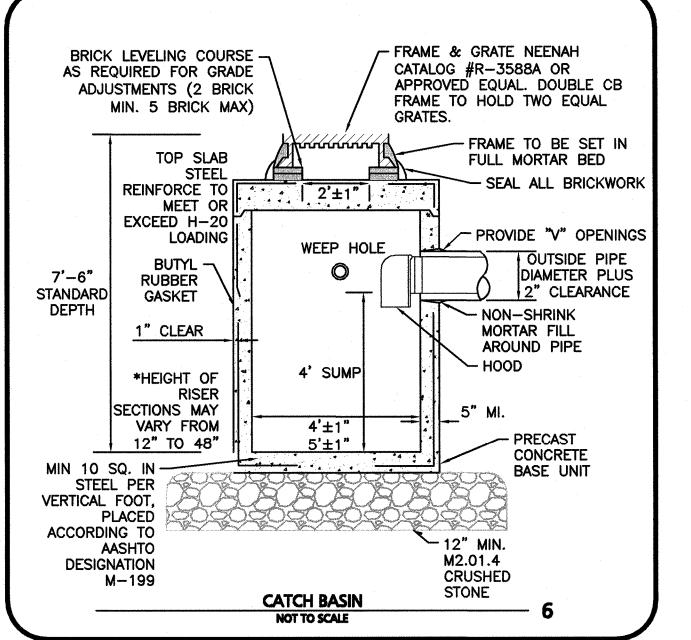
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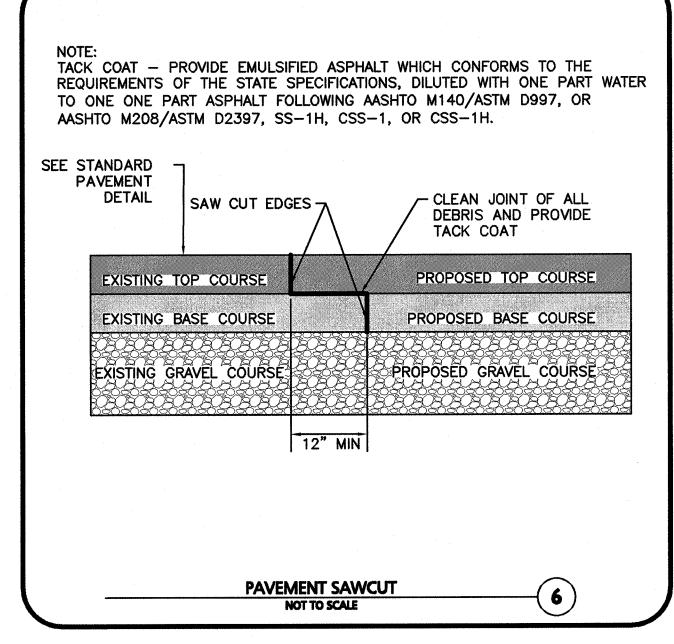
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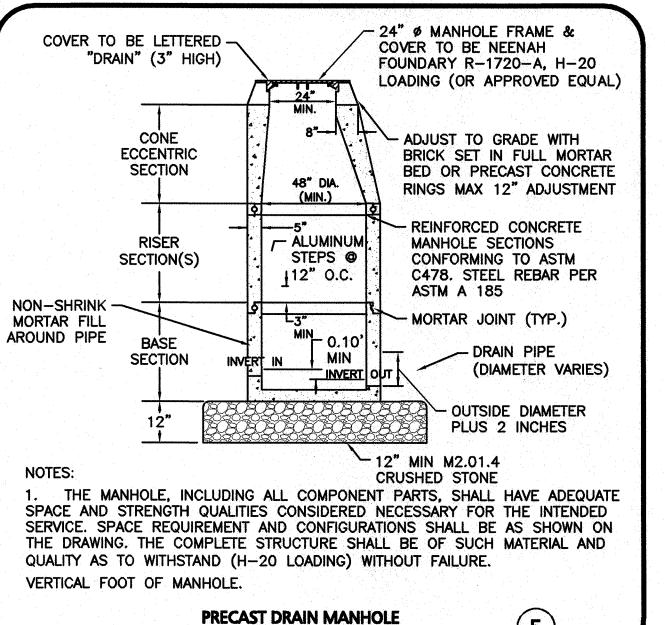
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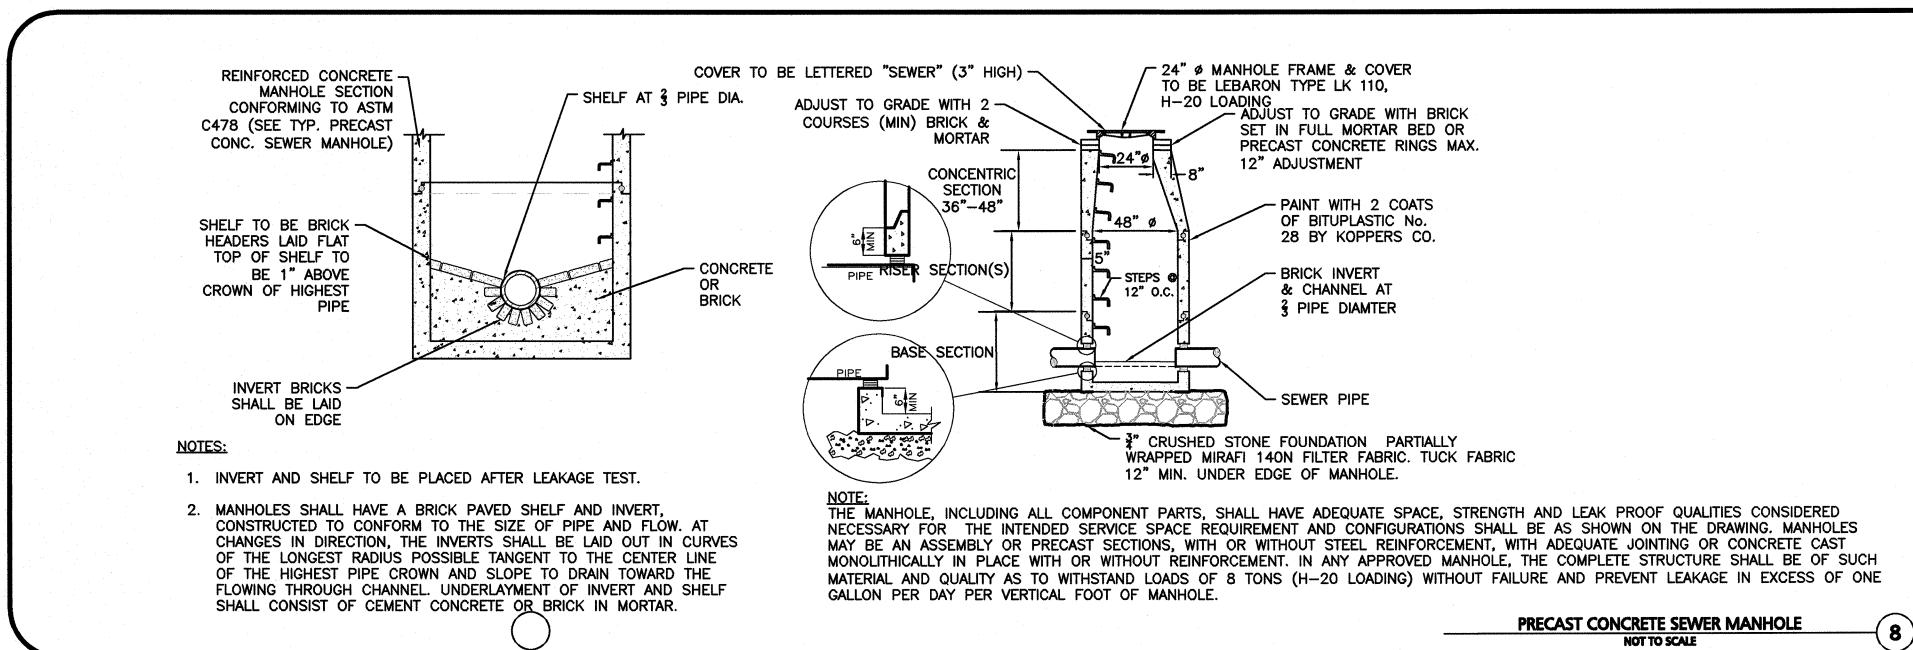












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PROFESSIONAL ENGINEER FOR ALLEN & MAJOR ASSOCIATES, INC.

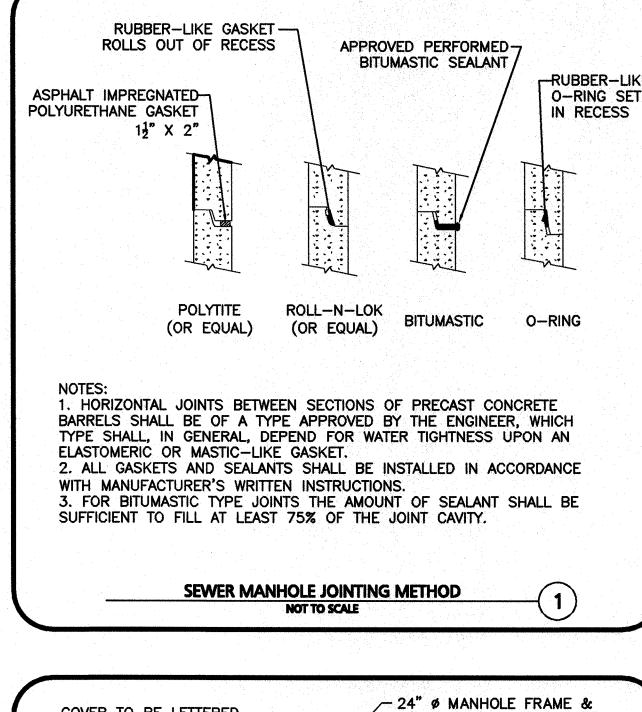D. |10/18/2019| REVISED PER TOWN COMMENTS C. |10/10/2019| REVISED PER TOWN COMMENTS B. 09/27/2019 REVISED PER TOWN COMMENTS A. 07/03/2019 ISSUED FOR NOTICE OF INTENT REV DATE DESCRIPTION

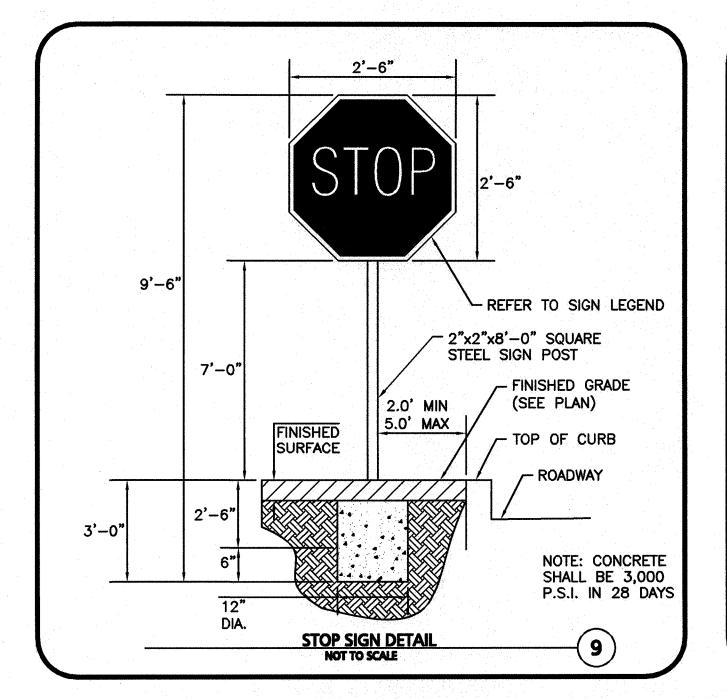APPLICANT\OWNER:

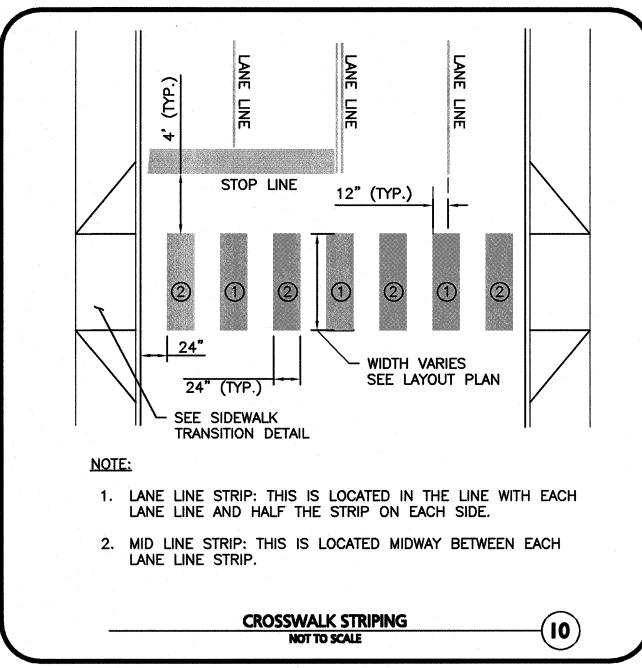WP EAST ACQUISITIONS, LLC. 91 HARTWELL AVENUE LEXINGTON, MA 02421

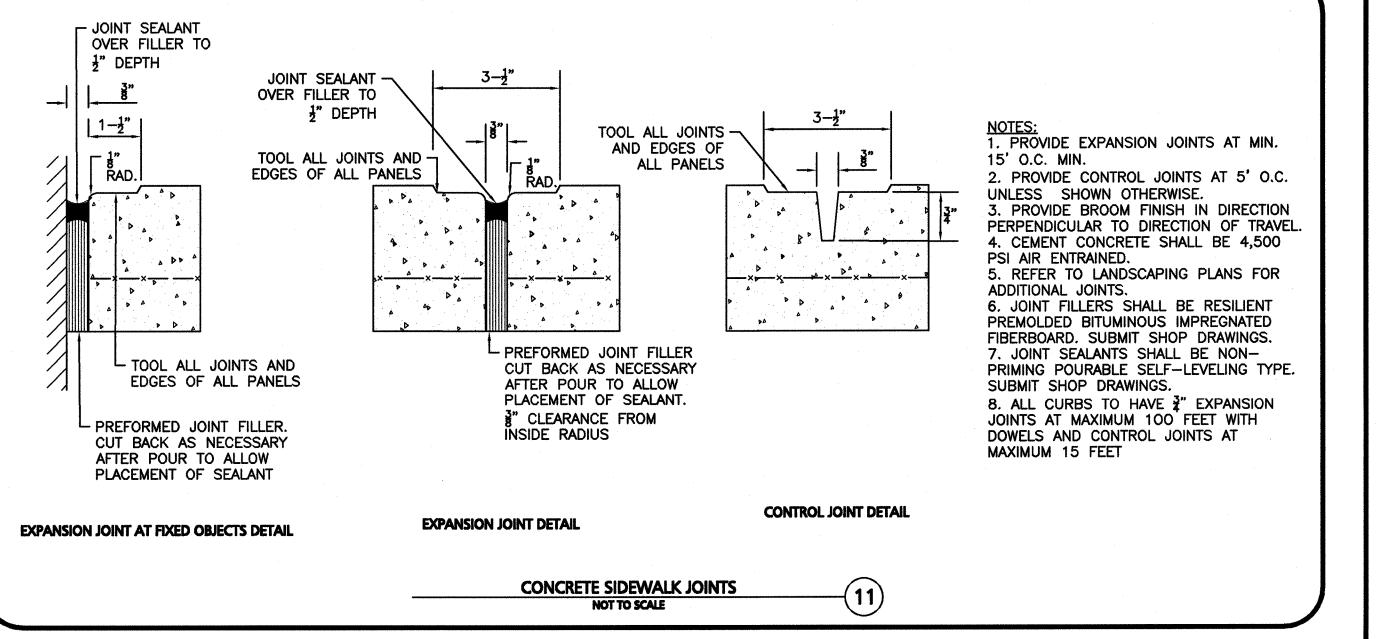ALTA AT RIVER'S EDGE **490 BOSTON POST ROAD** WAYLAND, MA

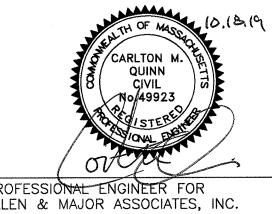1670-09A DATE: 06-20-2019 PROJECT NO. AS SHOWN DWG. NAME: SCALE: SJL | CHECKED BY: **DESIGNED BY:**



ASSOCIATES, INC.

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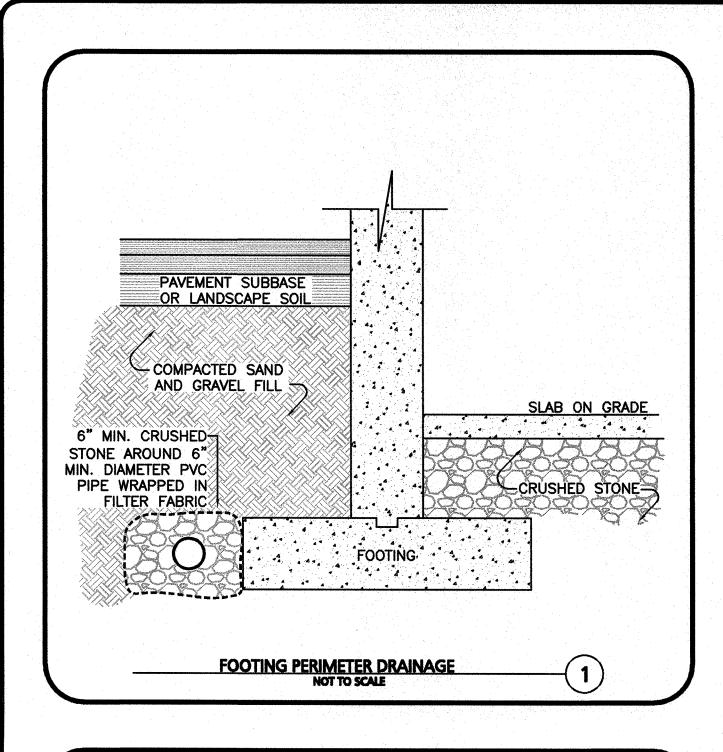
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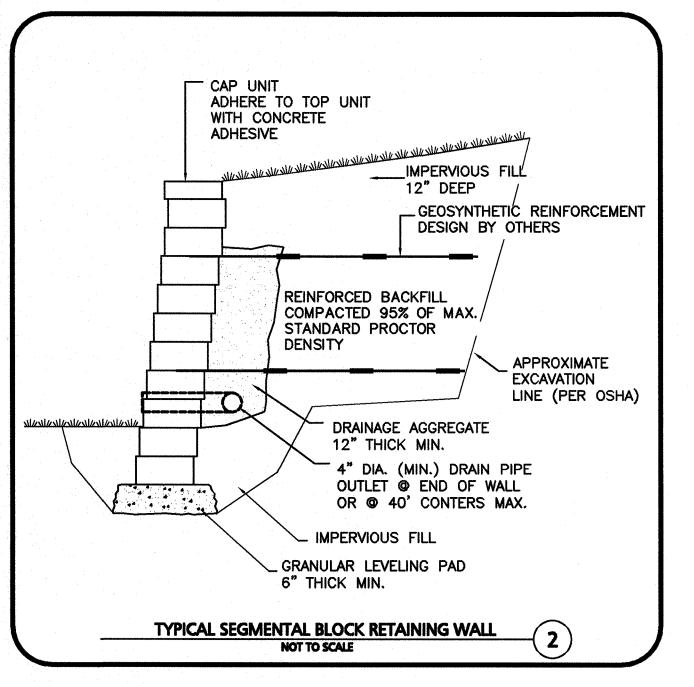
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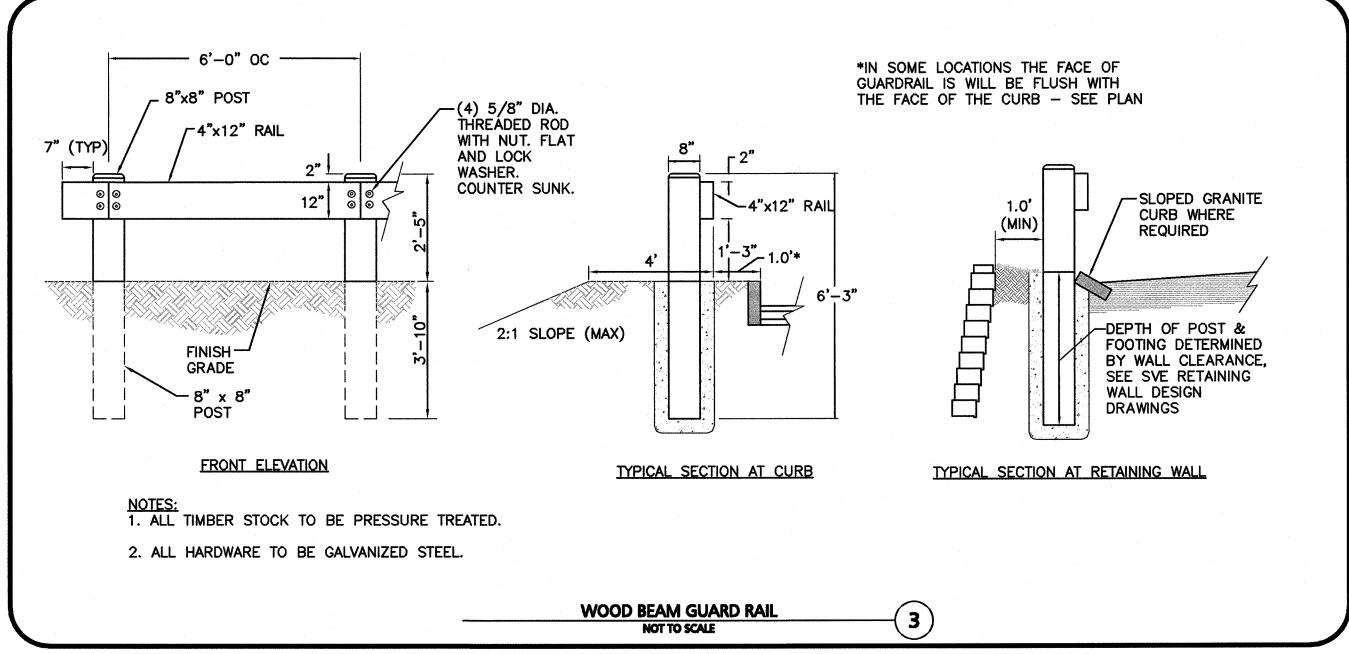
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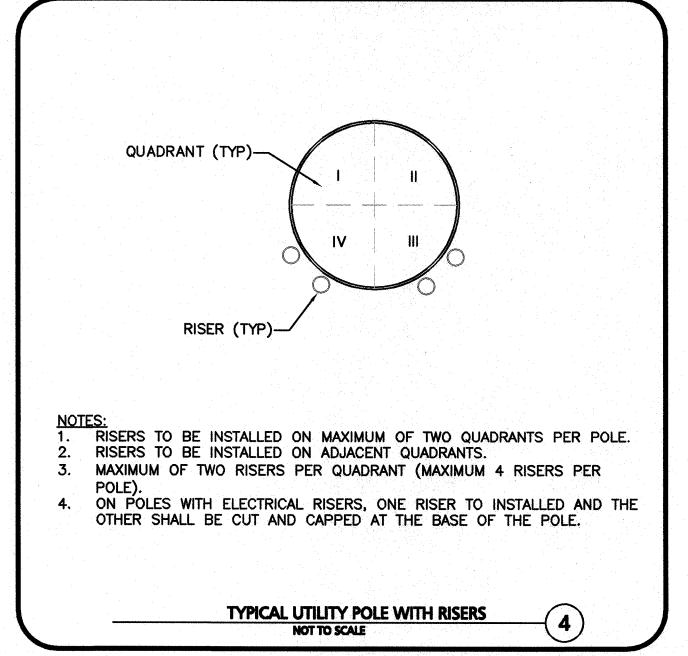
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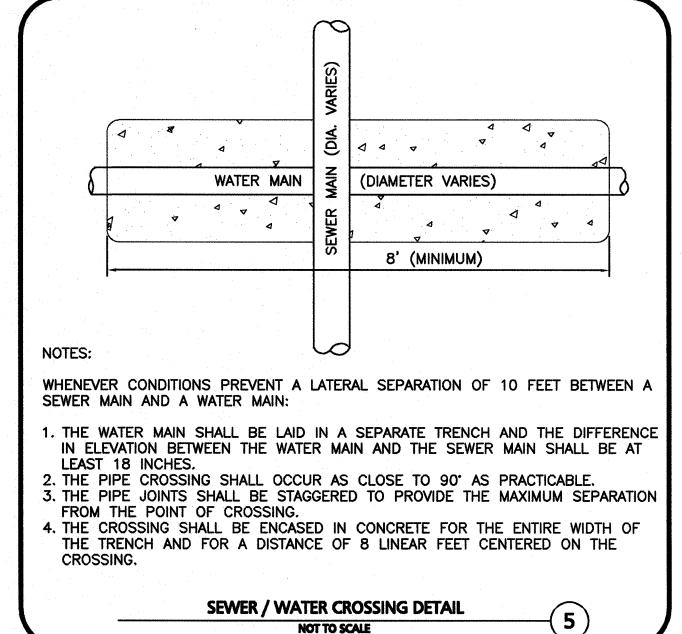
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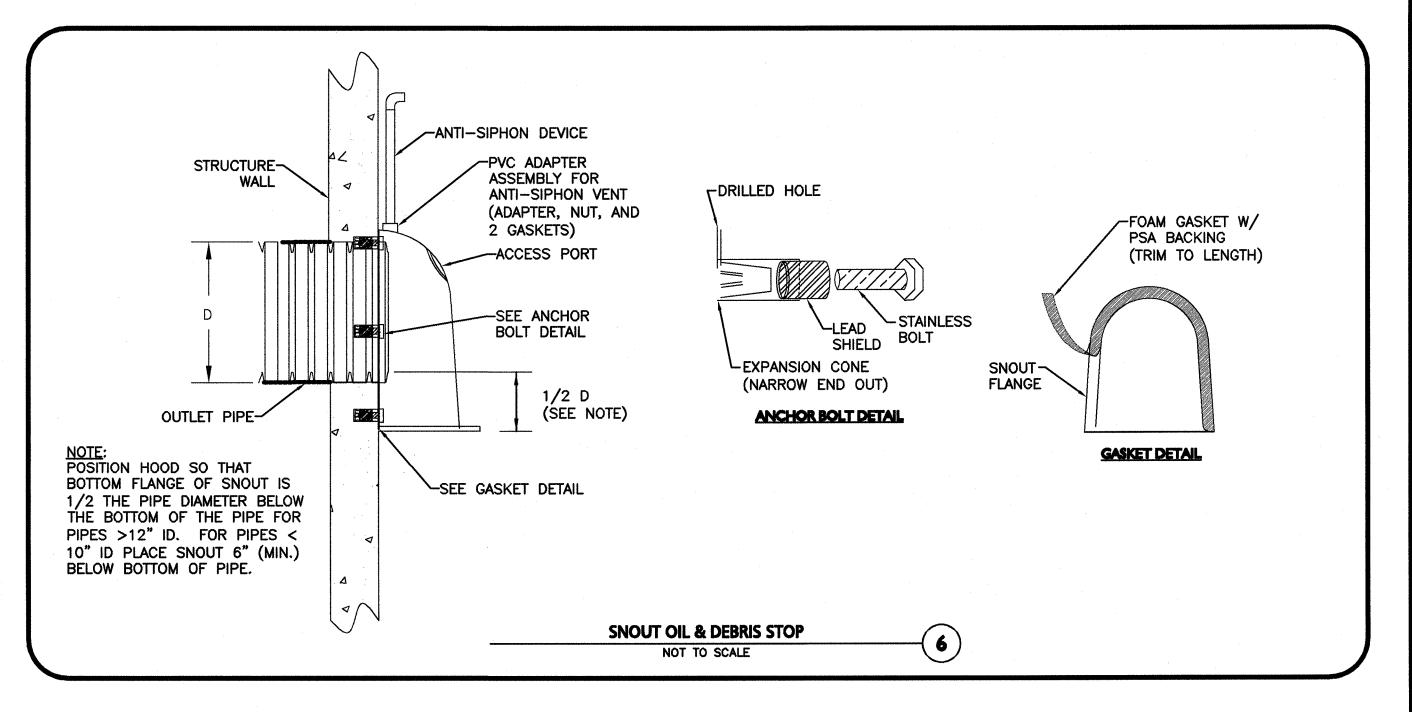















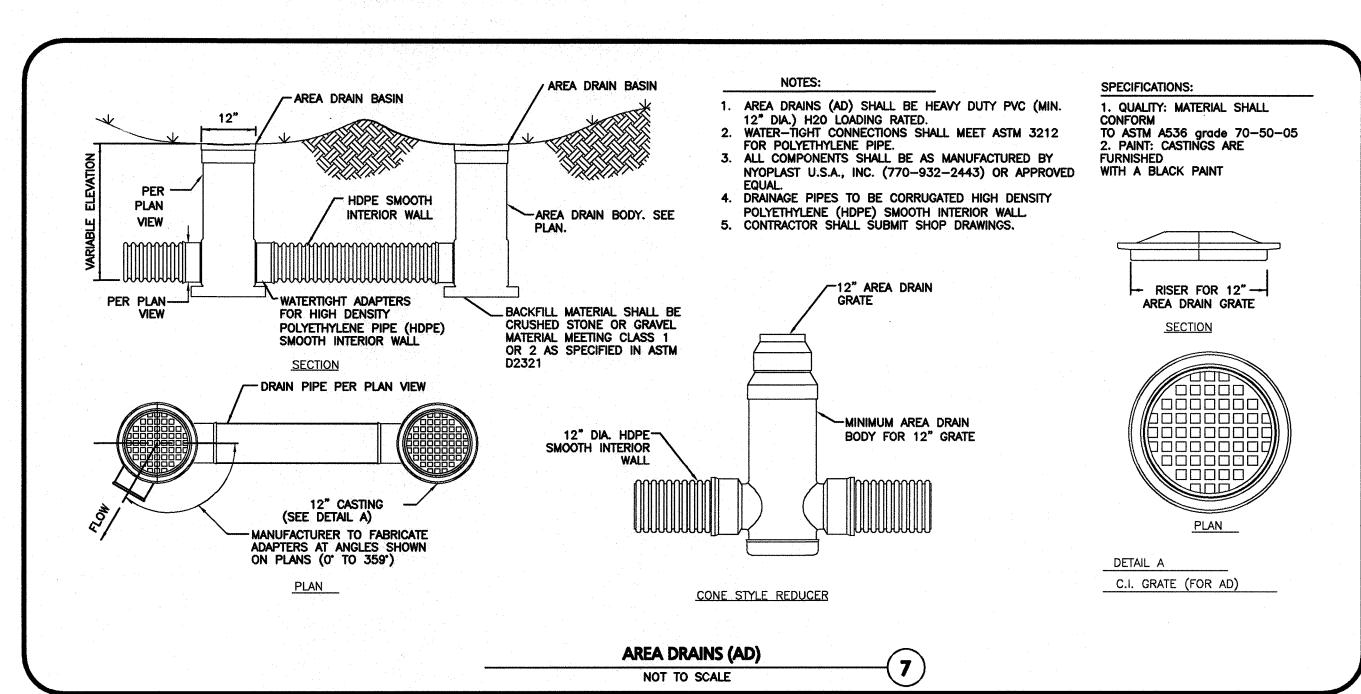

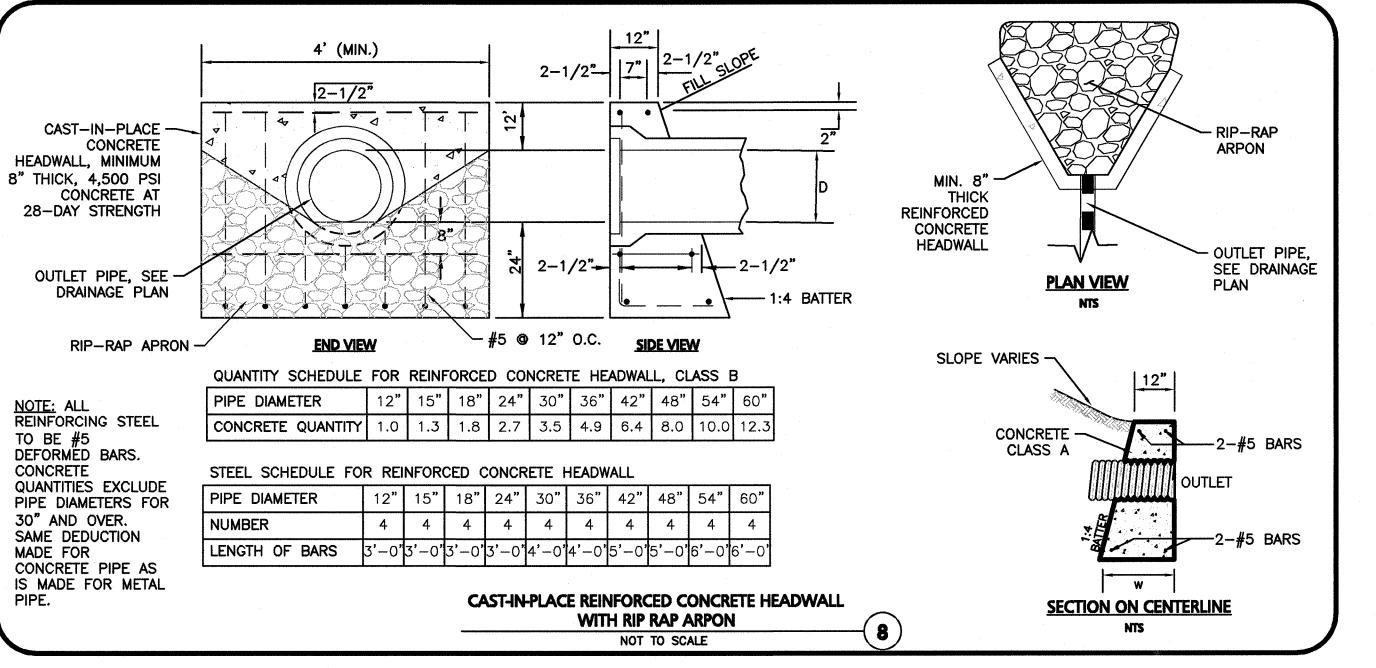

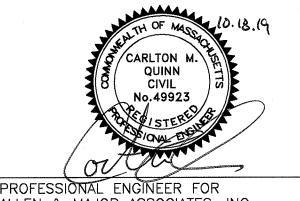

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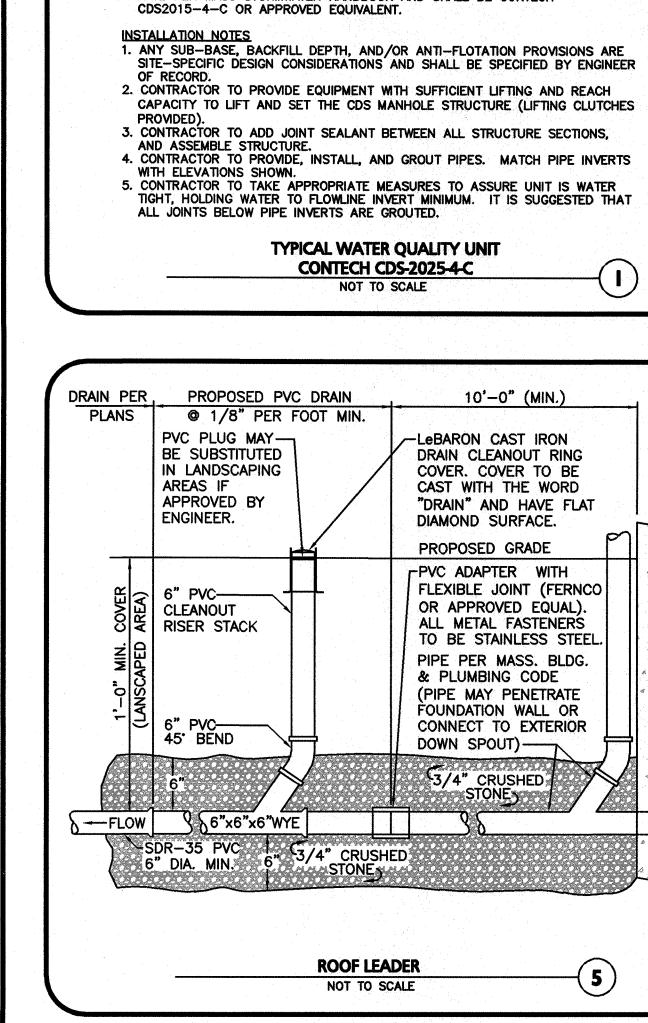
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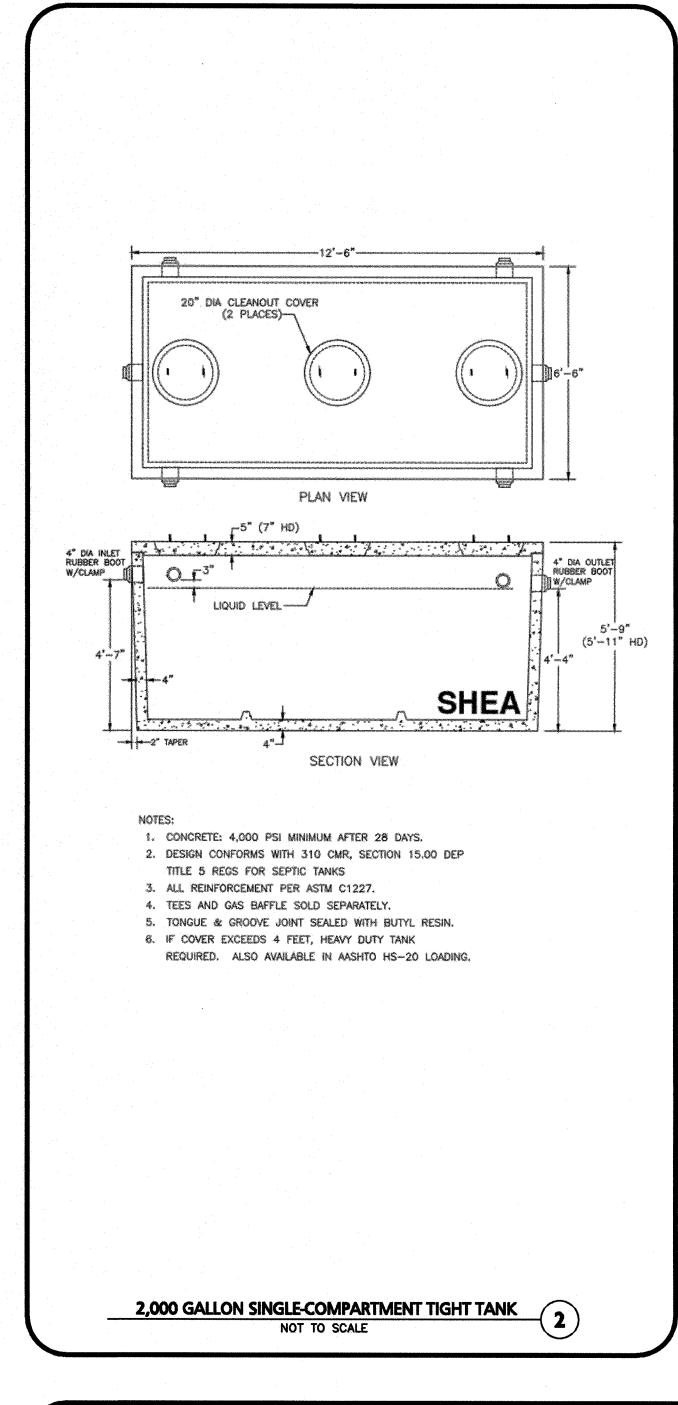
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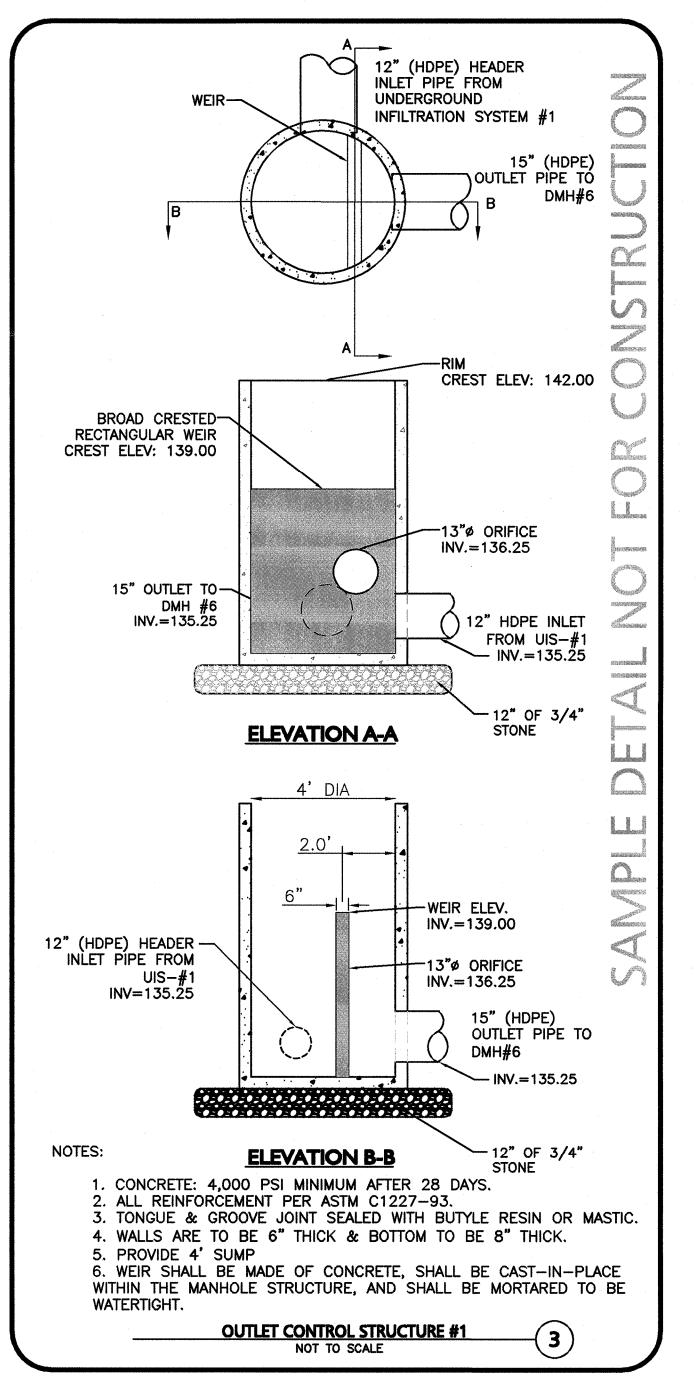
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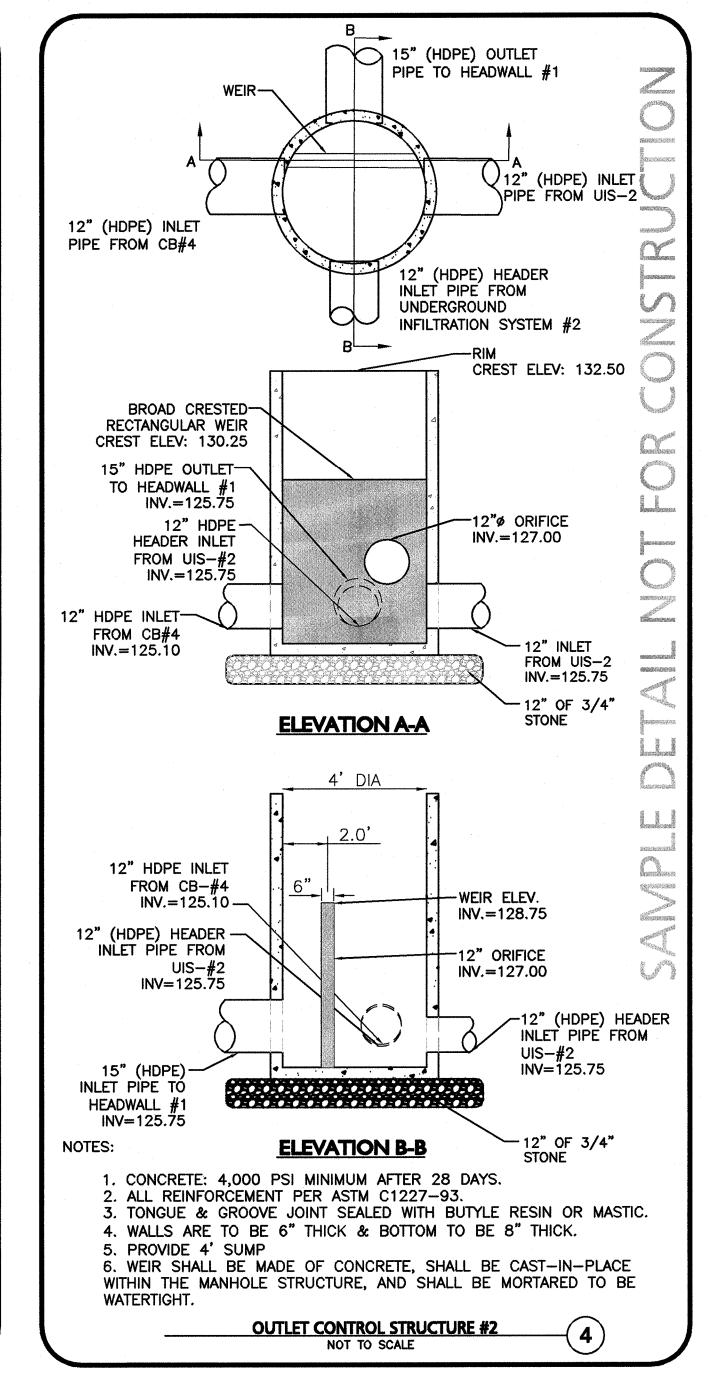
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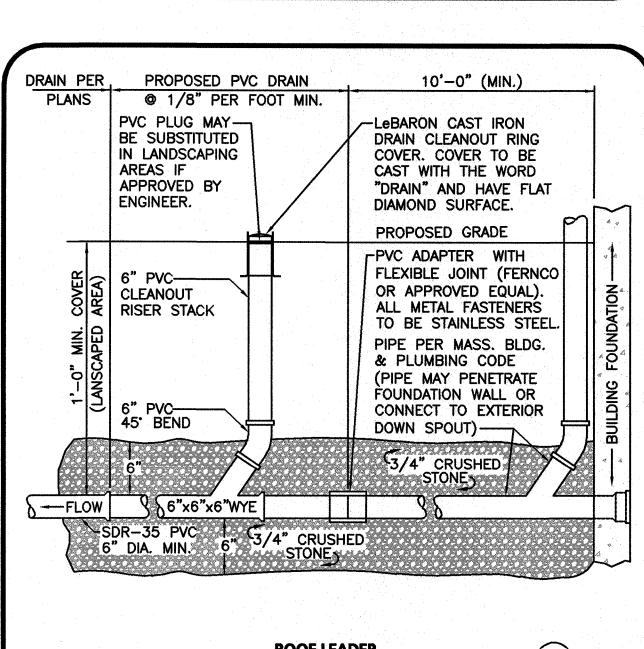
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CENTER OF CDS

STRUCTURE,

SCREEN AND

SUMP OPENING

STRUCTURE

'PERMANENT

TOP SLAB ACCESS

(SEE FRAME AND COVER

FIBERGLASS

SEPARATION

AND INLE

HYDRAULIC

FINISHED GRADE-

SKIRT-/

SCREEN-

SEPARATION

PVC HYDRAULIC-

REPRESENTATIVE. www.contech-cpi.com

GROUNDWATER ELEVATION.

DATA AND INFORMATION CONTAINED IN THIS DRAWING.

SHEAR PLATE

STORAGE

1. CONTECH TO PROVIDE ALL MATERIALS UNLESS NOTED OTHERWISE.

2. DIMENSIONS MARKED WITH () ARE REFERENCE DIMENSIONS. ACTUAL DIMENSIONS MAY

4. CDS WATER QUALITY STRUCTURE SHALL BE IN ACCORDANCE WITH ALL DESIGN

5. STRUCTURE SHALL MEET AASHTO HS20 AND CASTINGS SHALL MEET AASHTO

6. PVC HYDRAULIC SHEAR PLATE IS PLACED ON SHELF AT BOTTOM OF SCREEN CYLINDER. REMOVE AND REPLACE AS NECESSARY DURING MAINTENANCE

7. ALL "CDS" STRUCTURES HAVE BEEN SIZED USING THE WATER QUALITY FLOW

RATE PER MASS STORMWATER HANDBOOK AND SHALL BE CONTECH

M306 LOAD RATING, ASSUMING GROUNDWATER ELEVATION AT, OR BELOW, THE

OUTLET PIPE INVERT ELEVATION. ENGINEER OF RECORD TO CONFIRM ACTUAL

3. FOR FABRICATION DRAWINGS WITH DETAILED STRUCTURE DIMENSIONS AND

WEIGHTS, PLEASE CONTACT YOUR CONTECH CONSTRUCTION PRODUCTS

GRADE RINGS/RISERS-

INLET PIPE~

ACCOMMODATED)

CONTRACTOR TO GROUT TO

FIBERGLASS SEPARATION -


(MULTIPLE INLET PIPES MAY BE

CYLINDER AND INLET

SHEAR

PLATE PLAN VIEW B-B MANHOLE

CYLINDER.

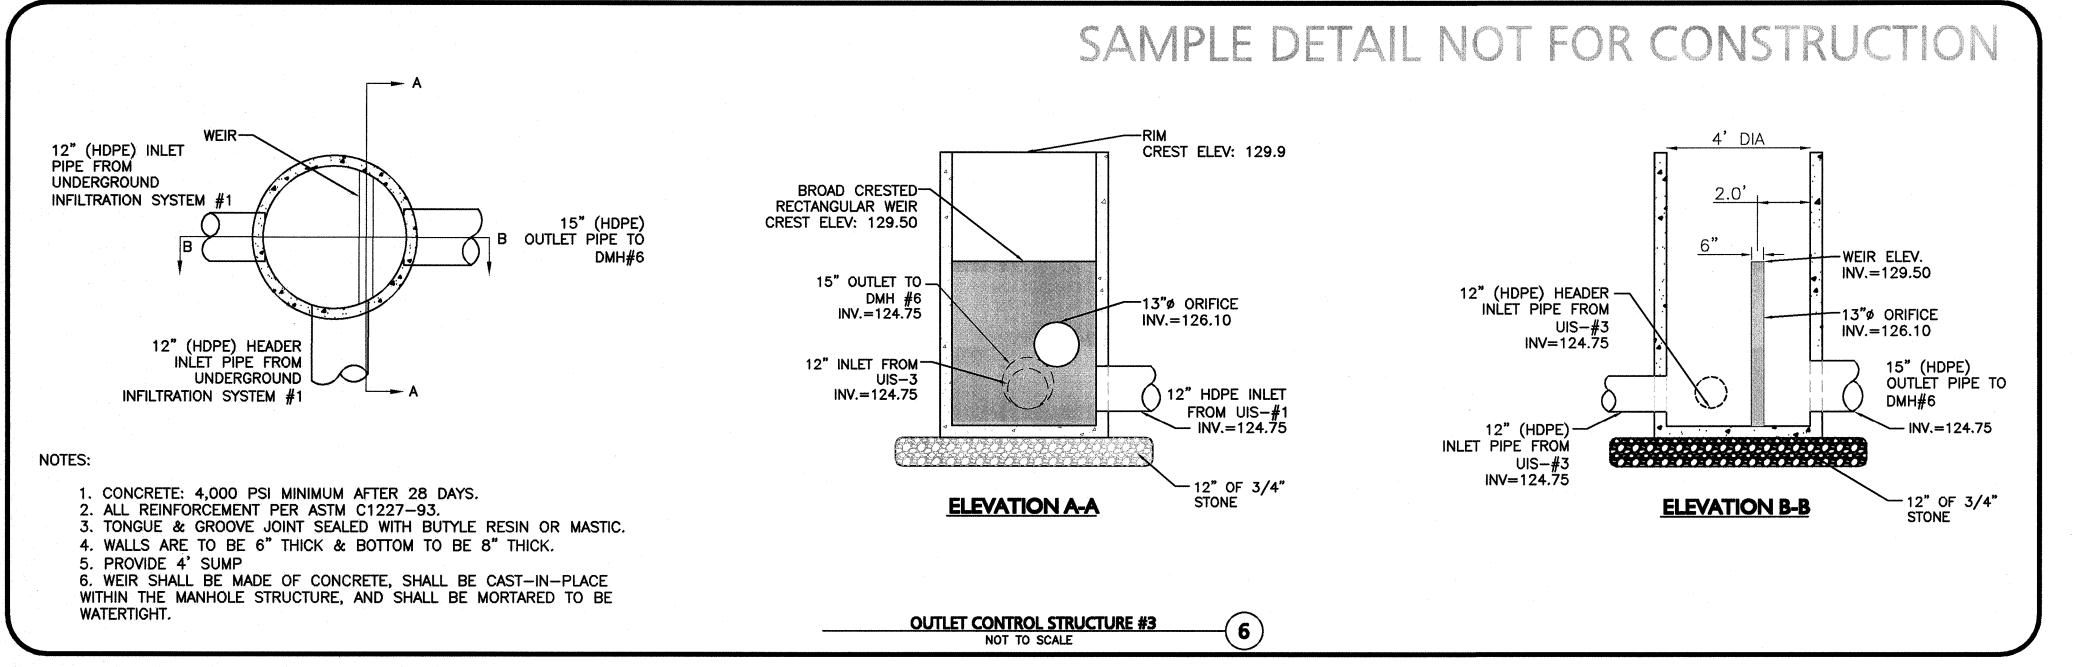



D. |10/18/2019| REVISED PER TOWN COMMENTS C. 10/10/2019 REVISED PER TOWN COMMENTS

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C-506

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DETAILS

- 1. CHAMBERS SHALL BE STORMTECH SC-740, SC-310, OR APPROVED EQUAL.
- 2. CHAMBERS SHALL BE MANUFACTURED FROM VIRGIN
- POLYPROPYLENE OR POLYETHYLENE RESINS.

 CHAMBER ROWS SHALL PROVIDE CONTINUOUS, UNOBSTRUCTED INTERNAL SPACE WITH NO INTERNAL SUPPORT PANELS THAT WOULD IMPEDE FLOW OR LIMIT ACCESS FOR INSPECTION.
- 4. THE STRUCTURAL DESIGN OF THE CHAMBERS, THE STRUCTURAL BACKFILL, AND THE INSTALLATION REQUIREMENTS SHALL ENSURE THAT THE LOAD FACTORS SPECIFIED IN THE AASHTO LRFD BRIDGE DESIGN SPECIFICATIONS, SECTION 12.12, ARE MET FOR:

 1) LONG-DURATION DEAD LOADS AND 2) SHORT-DURATION LIVE LOADS, BASED ON THE AASHTO DESIGN TRUCK WITH CONSIDERATION FOR IMPACT AND MULTIPLE VEHICLE PRESENCES.
- 5. CHAMBERS SHALL MEET ASTM F2922 (POLYETHYLENE) OR ASTM F2418 (POLYPROPYLENE), "STANDARD SPECIFICATION FOR THERMOPLASTIC CORRUGATED WALL STORMWATER COLLECTION CHAMBERS"
- 6. CHAMBERS SHALL BE DESIGNED AND ALLOWABLE LOADS
 DETERMINED IN ACCORDANCE WITH ASTM F2787, "STANDARD
 PRACTICE FOR STRUCTURAL DESIGN OF THERMOPLASTIC
 CORRUGATED WALL STORMWATER COLLECTION CHAMBERS".
- 7. ONLY CHAMBERS THAT ARE APPROVED BY THE SITE DESIGN ENGINEER WILL BE ALLOWED. THE CHAMBER MANUFACTURER SHALL SUBMIT THE FOLLOWING UPON REQUEST TO THE SITE DESIGN ENGINEER FOR APPROVAL BEFORE DELIVERING CHAMBERS TO THE PROJECT SITE:
- a. A STRUCTURAL EVALUATION SEALED BY A REGISTERED PROFESSIONAL ENGINEER THAT DEMONSTRATES THAT THE SAFETY FACTORS ARE GREATER THAN OR EQUAL TO 1.95 FOR DEAD LOAD AND 1.75 FOR LIVE LOAD, THE MINIMUM REQUIRED BY ASTM F2787 AND BY AASHTO FOR THERMOPLASTIC PIPE.
- A STRUCTURAL EVALUATION SEALED BY A REGISTERED PROFESSIONAL ENGINEER THAT DEMONSTRATES THAT THE LOAD FACTORS SPECIFIED IN THE AASHTO LRFD BRIDGE DESIGN SPECIFICATIONS, SECTION 12.12, ARE MET. THE 50 YEAR CREEP MODULUS DATA SPECIFIED IN ASTM F2418 OR ASTM F2922 MUST BE USED AS PART OF THE AASHTO STRUCTURAL EVALUATION TO VERIFY LONG—TERM PERFORMANCE.
- STRUCTURAL EVALUATION IS BASED.

 8. CHAMBERS AND END CAPS SHALL BE PRODUCED AT AN ISO 9001 CERTIFIED MANUFACTURING FACILITY.

STRUCTURAL CROSS SECTION DETAIL ON WHICH THE

IMPORTANT - NOTES FOR THE BIDDING AND INSTALLATION OF THE SC-310/SC-740 SYSTEM

- STORMTECH SC-310 & SC-740 CHAMBERS SHALL NOT BE INSTALLED UNTIL THE MANUFACTURER'S REPRESENTATIVE HAS COMPLETED A PRE-CONSTRUCTION MEETING WITH THE INSTALLERS.
 STORMTECH SC-310 & SC-740 CHAMBERS SHALL BE INSTALLED
- IN ACCORDANCE WITH THE "STORMTECH SC-310/SC-740/SC-780 CONSTRUCTION GUIDE".

 3. CHAMBERS ARE NOT TO BE BACKFILLED WITH A DOZER OR AN EXCAVATOR SITUATED OVER THE CHAMBERS.
- STORMTECH RECOMMENDS 3 BACKFILL METHODS:
- STONESHOOTER LOCATED OFF THE CHAMBER BED.
 BACKFILL AS ROWS ARE BUILT USING AN EXCAVATOR ON THE FOUNDATION STONE OR SUB-GRADE.
- BACKFILL FROM OUTSIDE THE EXCAVATION USING A LONG BOOM HOE OR EXCAVATOR.
- 4. THE FOUNDATION STONE SHALL BE LEVELED AND COMPACTED PRIOR TO PLACING CHAMBERS.
- 5. JOINTS BETWEEN CHAMBERS SHALL BE PROPERLY SEATED PRIOR TO PLACING STONE.
 6. MAINTAIN MINIMUM 6" (150 mm) SPACING BETWEEN THE
- CHAMBER ROWS.
 7. EMBEDMENT STONE SURROUNDING CHAMBERS MUST BE A CLEAN,
- CRUSHED, ANGULAR STONE 3/4-2" (20-50 mm).

 8. THE CONTRACTOR MUST REPORT ANY DISCREPANCIES WITH

CHAMBER FOUNDATION MATERIALS BEARING CAPACITIES TO THE

SITE DESIGN ENGINEER.

9. ADS RECOMMENDS THE USE OF "FLEXSTORM CATCH IT" INSERTS DURING CONSTRUCTION FOR ALL INLETS TO PROTECT THE SUBSURFACE STORMWATER MANAGEMENT SYSTEM FROM CONSTRUCTION SITE RUNOFF.


NOTES FOR CONSTRUCTION EQUIPMENT

- 1. STORMTECH SC-310 & SC-740 CHAMBERS SHALL BE INSTALLED IN ACCORDANCE WITH THE "STORMTECH SC-310/SC-740/DC-780 CONSTRUCTION GUIDE".
- 2. THE USE OF CONSTRUCTION EQUIPMENT OVER SC-310 & SC-740 CHAMBERS IS LIMITED:
- NO EQUIPMENT IS ALLOWED ON BARE CHAMBERS.
 NO RUBBER TIRED LOADERS, DUMP TRUCKS, OR EXCAVATORS ARE ALLOWED UNTIL PROPER FILL DEPTHS ARE REACHED IN ACCORDANCE WITH THE "STORMTECH SC-310/SC-740/DC-780
- CONSTRUCTION GUIDE".

 WEIGHT LIMITS FOR CONSTRUCTION EQUIPMENT CAN BE FOUND IN THE "STORMTECH SC-310/SC-740/DC-780 CONSTRUCTION
- 3. FULL 36" (900 mm) OF STABILIZED COVER MATERIALS OVER THE CHAMBERS IS REQUIRED FOR DUMP TRUCK TRAVEL OR DUMPING.

USE OF A DOZER TO PUSH EMBEDMENT STONE BETWEEN THE ROWS OF CHAMBERS MAY CAUSE DAMAGE TO THE CHAMBERS AND IS NOT AN ACCEPTABLE BACKFILL METHOD. ANY CHAMBERS DAMAGED BY THE "DUMP AND PUSH" METHOD ARE NOT COVERED UNDER THE STORMTECH STANDARD WARRANTY.

CONTACT STORMTECH AT 1-888-892-2694 WITH ANY QUESTIONS ON INSTALLATION REQUIREMENTS OR WEIGHT LIMITS FOR CONSTRUCTION EQUIPMENT.

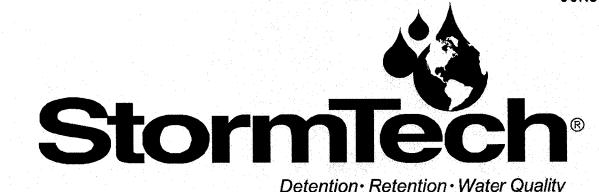

70 INWOOD ROAD, SUITE 3 | ROCKY HILL | CT | 06067 860-529-8188 | 888-892-2694 | WWW.STORMTECH.COM

GENERAL NOTES	
NOT TO SCALE	('ノ

		MATERIAL LOCATION	DESCRIPTION	AASHTO MATERIAL CLASSIFICATIONS	COMPACTION / DENSITY REQUIREMENT
	D	FINAL FILL: FILL MATERIAL FOR LAYER 'D' STARTS FROM THE TOP OF THE 'C' LAYER TO THE BOTTOM OF FLEXIBLE PAVEMENT OR UNPAVED FINISHED GRADE ABOVE, NOTE THAT PAVEMENT SUB-BASE MAY BE PART OF THE 'D' LAYER	ANY SOIL/ROCK MATERIALS, NATIVE SOILS, OR PER ENGINEER'S PLANS. CHECK PLANS FOR PAVEMENT SUB-GRADE REQUIREMENTS.	N/A	PREPARE PER SITE DESIGN ENGINEER'S PLANS. PAVED INSTALLATIONS MAY HAVE STRINGENT MATERIAL AND PREPARATION REQUIREMENTS.
	С	INITIAL FILL: FILL MATERIAL FOR LAYER 'C' STARTS FROM THE TOP OF THE EMBEDMENT STONE ('B' LAYER) TO 18" (450 mm) ABOVE THE TOP OF THE CHAMBER. NOTE THAT PAVEMENT SUB-BASE MAY BE A PART OF THE 'C' LAYER.	GRANULAR WELL-GRADED SOIL/AGGREGATE MIXTURES, <35% FINES OR PROCESSED AGGREGATE. MOST PAVEMENT SUB-BASE MATERIALS CAN BE USED IN LIEU OF THIS LAYER.	AASHTO M145 ¹ A-1, A-2-4, A-3 OR AASHTO M43 ¹ 3, 357, 4, 467, 5, 56, 57, 6, 67, 68, 7, 78, 8, 89, 9, 10	BEGIN COMPACTIONS AFTER 12" (300 mm) OF MATERIAL OVER THE CHAMBERS IS REACHED. COMPACT ADDITIONAL LAYERS IN 6" (150 mm) MAX LIFTS TO A MIN. 95% PROCTOR DENSITY FOR WELL GRADED MATERIAL AND 95% RELATIVE DENSITY FOR PROCESSED AGGREGATE MATERIALS. ROLLER GROSS VEHICLE WEIGHT NOT TO EXCEED 12,000 lbs (53 kN). DYNAMIC FORCE NOT TO EXCEED 20,000 lbs (89 kN).
	В	EMBEDMENT STONE: FILL SURROUNDING THE CHAMBERS FROM THE FOUNDATION STONE ('A' LAYER) TO THE 'C' LAYER ABOVE.	CLEAN, CRUSHED, ANGULAR STONE, NOMINAL SIZE DISTRIBUTION BETWEEN 3/4-2 INCH (20-50 mm)	AASHTO M43¹ 3, 357, 4, 467, 5, 56, 57	NO COMPACTION REQUIRED.
·	Α	FOUNDATION STONE: FILL BELOW CHAMBERS FROM THE SUB-GRADE UP TO THE FOOT (BOTTOM) OF THE CHAMBER.	CLEAN, CRUSHED, ANGULAR STONE, NOMINAL SIZE DISTRIBUTION BETWEEN 3/4-2 INCH (20-50 mm)	AASHTO M43 ¹ 3, 357, 4, 467, 5, 56, 57	PLATE COMPACT OR ROLL TO ACHIEVE A FLAT SURFACE. 2 3


PLEASE NOTE:

1. THE LISTED AASHTO DESIGNATIONS ARE FOR GRADATIONS ONLY. THE STONE MUST ALSO BE CLEAN, CRUSHED, ANGULAR. FOR EXAMPLE, A SPECIFICATION FOR #4 STONE WOULD STATE:

"CLEAN, CRUSHED, ANGULAR NO. 4 (AASHTO M43) STONE".

2. STORMTECH COMPACTION REQUIREMENTS ARE MET FOR 'A' LOCATION MATERIALS WHEN PLACED AND COMPACTED IN 9" (230 mm) (MAX) LIFTS USING TWO FULL COVERAGES WITH A VIBRATORY COMPACTOR.


3. WHERE INFILTRATION SURFACES MAY BE COMPROMISED BY COMPACTION, FOR STANDARD DESIGN LOAD CONDITIONS, A FLAT SURFACE MAY BE ACHIEVED BY RAKING OR DRAGGING WITHOUT COMPACTION EQUIPMENT. FOR SPECIAL LOAD DESIGNS, CONTACT STORMTECH FOR COMPACTION REQUIREMENTS.

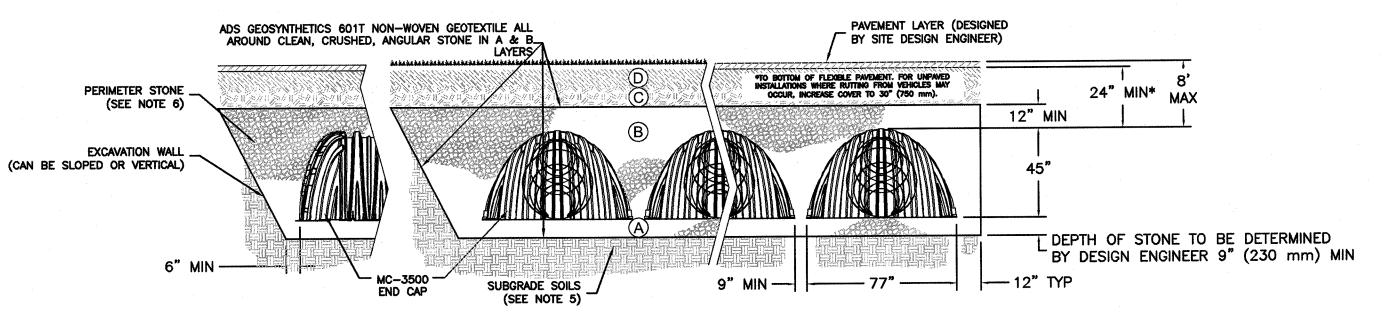


NOTES:

- 1. MC-3500 CHAMBERS SHALL CONFORM TO THE REQUIREMENTS OF ASTM F2418 "STANDARD SPECIFICATION FOR POLYPROPYLENE (PP) CORRUGATED WALL STORMWATER COLLECTION CHAMBERS".
- 2. MC-3500 CHAMBERS SHALL BE DESIGNED IN ACCORDANCE WITH ASTM F2787 "STANDARD PRACTICE FOR STRUCTURAL DESIGN OF THERMOPLASTIC CORRUGATED WALL STORMWATER COLLECTION CHAMBERS".
- 3. "ACCEPTABLE FILL MATERIALS" TABLE ABOVE PROVIDES MATERIAL LOCATIONS, DESCRIPTIONS, GRADATIONS, AND COMPACTION REQUIREMENTS FOR FOUNDATION, EMBEDMENT, AND FILL MATERIALS.
- 4. THE "SITE DESIGN ENGINEER" REFERS TO THE ENGINEER RESPONSIBLE FOR THE DESIGN AND LAYOUT OF THE STORMTECH CHAMBERS FOR THIS PROJECT.
- 5. THE SITE DESIGN ENGINEER IS RESPONSIBLE FOR ASSESSING THE BEARING RESISTANCE (ALLOWABLE BEARING CAPACITY) OF THE SUBGRADE SOILS AND THE DEPTH OF FOUNDATION STONE WITH CONSIDERATION FOR THE RANGE OF EXPECTED SOIL MOISTURE CONDITIONS.
- 6. PERIMETER STONE MUST BE EXTENDED HORIZONTALLY TO THE EXCAVATION WALL FOR BOTH VERTICAL AND SLOPED EXCAVATION WALLS.
- 7. ONCE LAYER 'C' IS PLACED, ANY SOIL/MATERIAL CAN BE PLACED IN LAYER 'D' UP TO THE FINISHED GRADE. MOST PAVEMENT SUBBASE SOILS CAN BE USED TO REPLACE THE MATERIAL REQUIREMENTS OF LAYER 'C' OR 'D' AT THE SITE DESIGN ENGINEER'S DISCRETION.
- 8. SEE GRADING AND DRAINAGE PLAN, SHEET C-103, FOR MORE INFORMATION.

ACCEPTABLE FILL MATERIALS: STORMTECH MC-3500 CHAMBER SYSTEMS

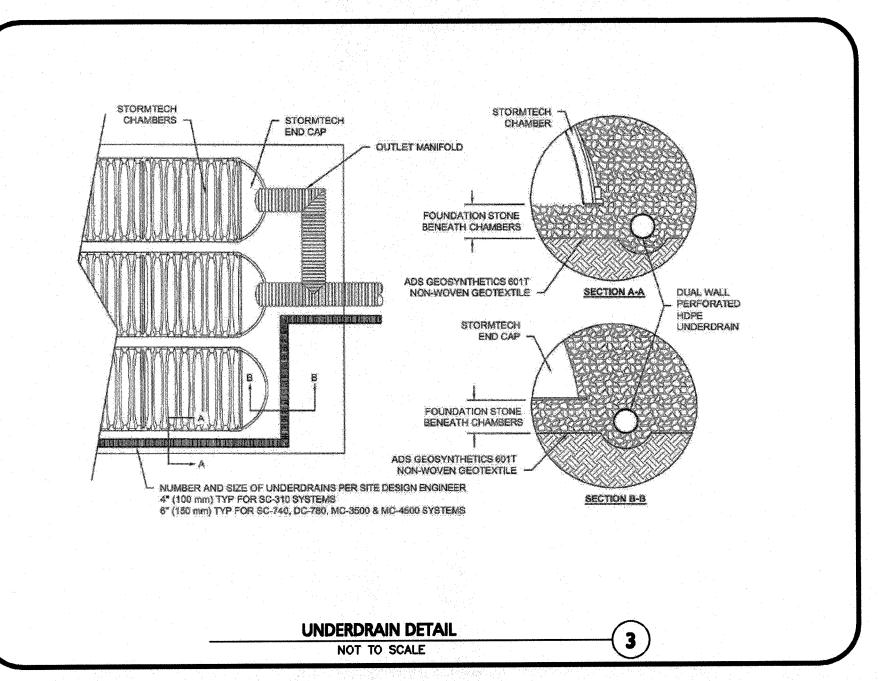

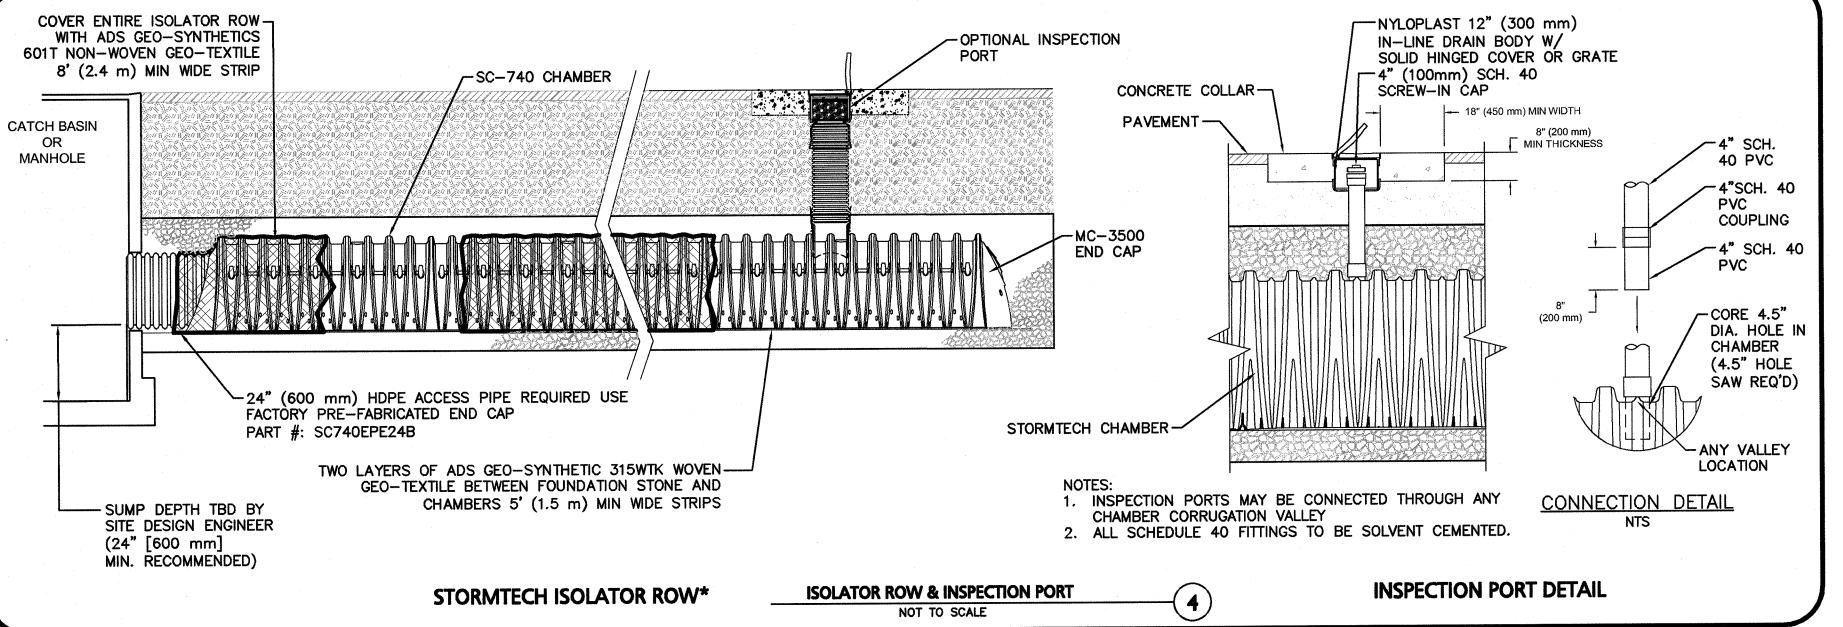

D. 10/18/2019 REVISED PER TOWN COMMENTS
 C. 10/10/2019 REVISED PER TOWN COMMENTS

B. 09/27/2019 REVISED PER TOWN COMMENTS

A. 07/03/2019 ISSUED FOR NOTICE OF INTENT

REV DATE DESCRIPTION
APPLICANT\OWNER:

WP EAST ACQUISITIONS, LLC. 91 HARTWELL AVENUE LEXINGTON, MA 02421

PROJECT:

ALTA AT RIVER'S EDGE 490 BOSTON POST ROAD WAYLAND, MA

PROJECT NO. 1670-09A DATE: 06-20-2019
SCALE: AS SHOWN DWG. NAME: 1670-09A
DESIGNED BY: SJL CHECKED BY: CMC



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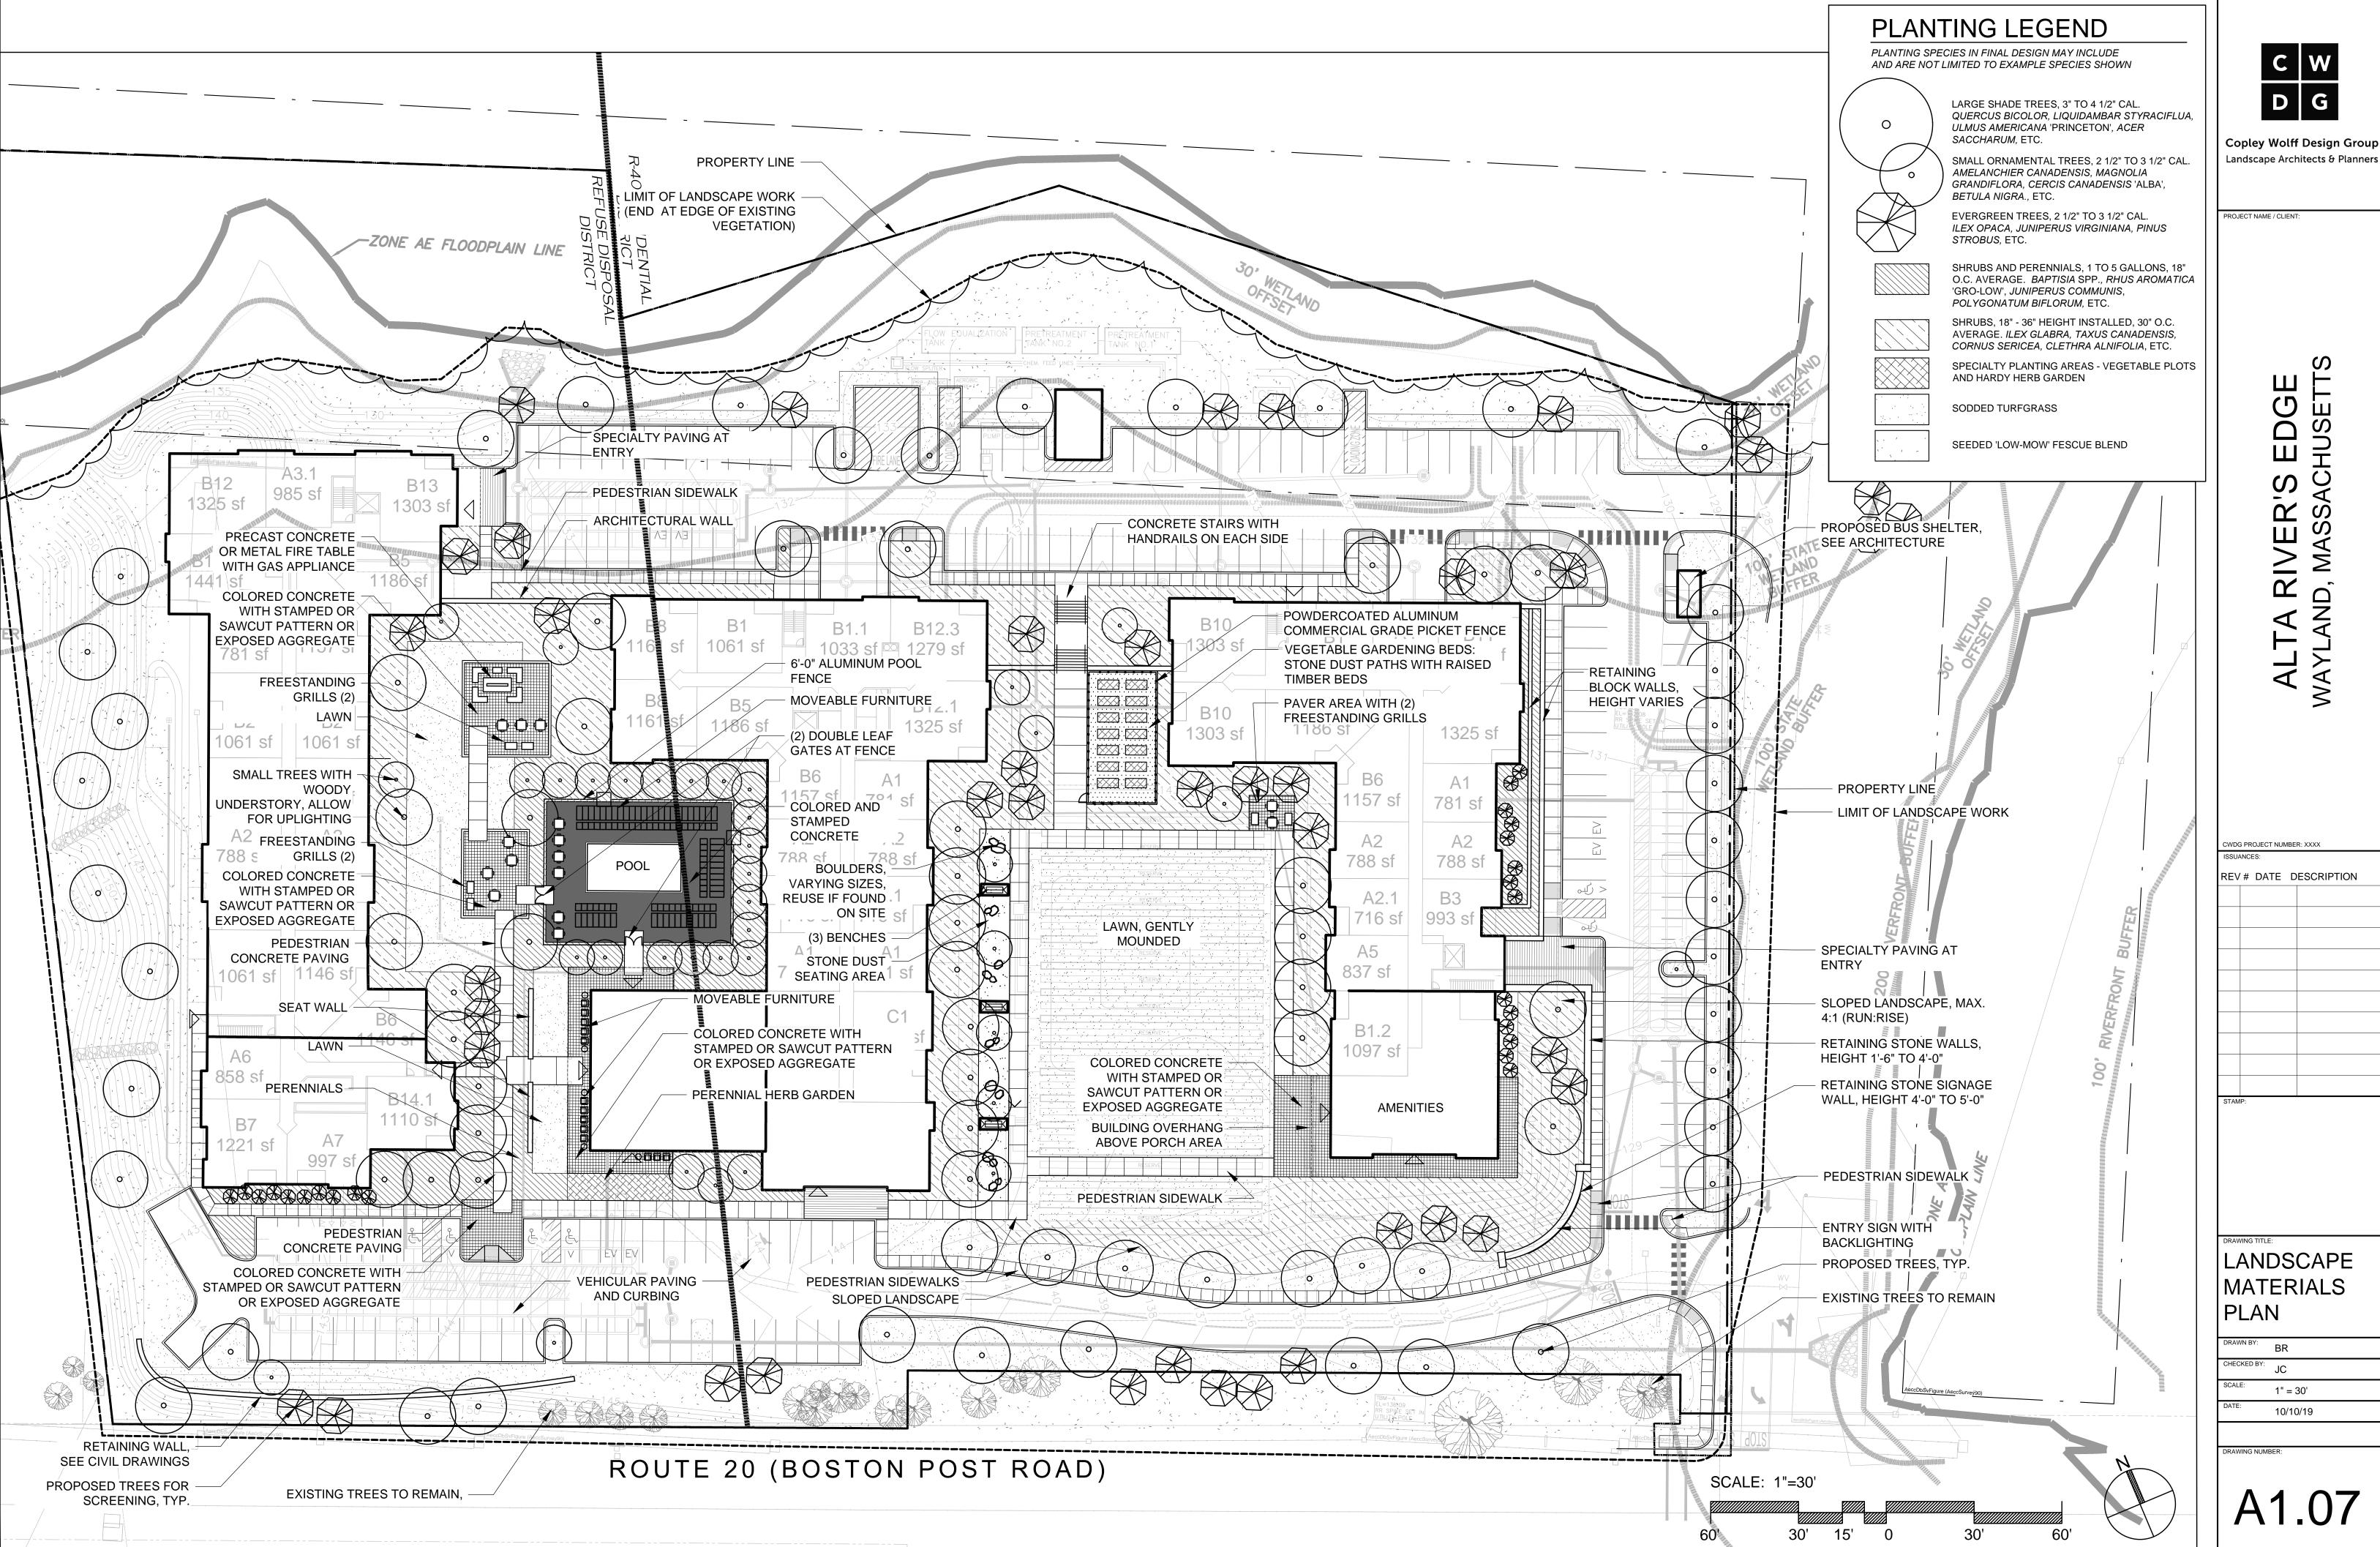
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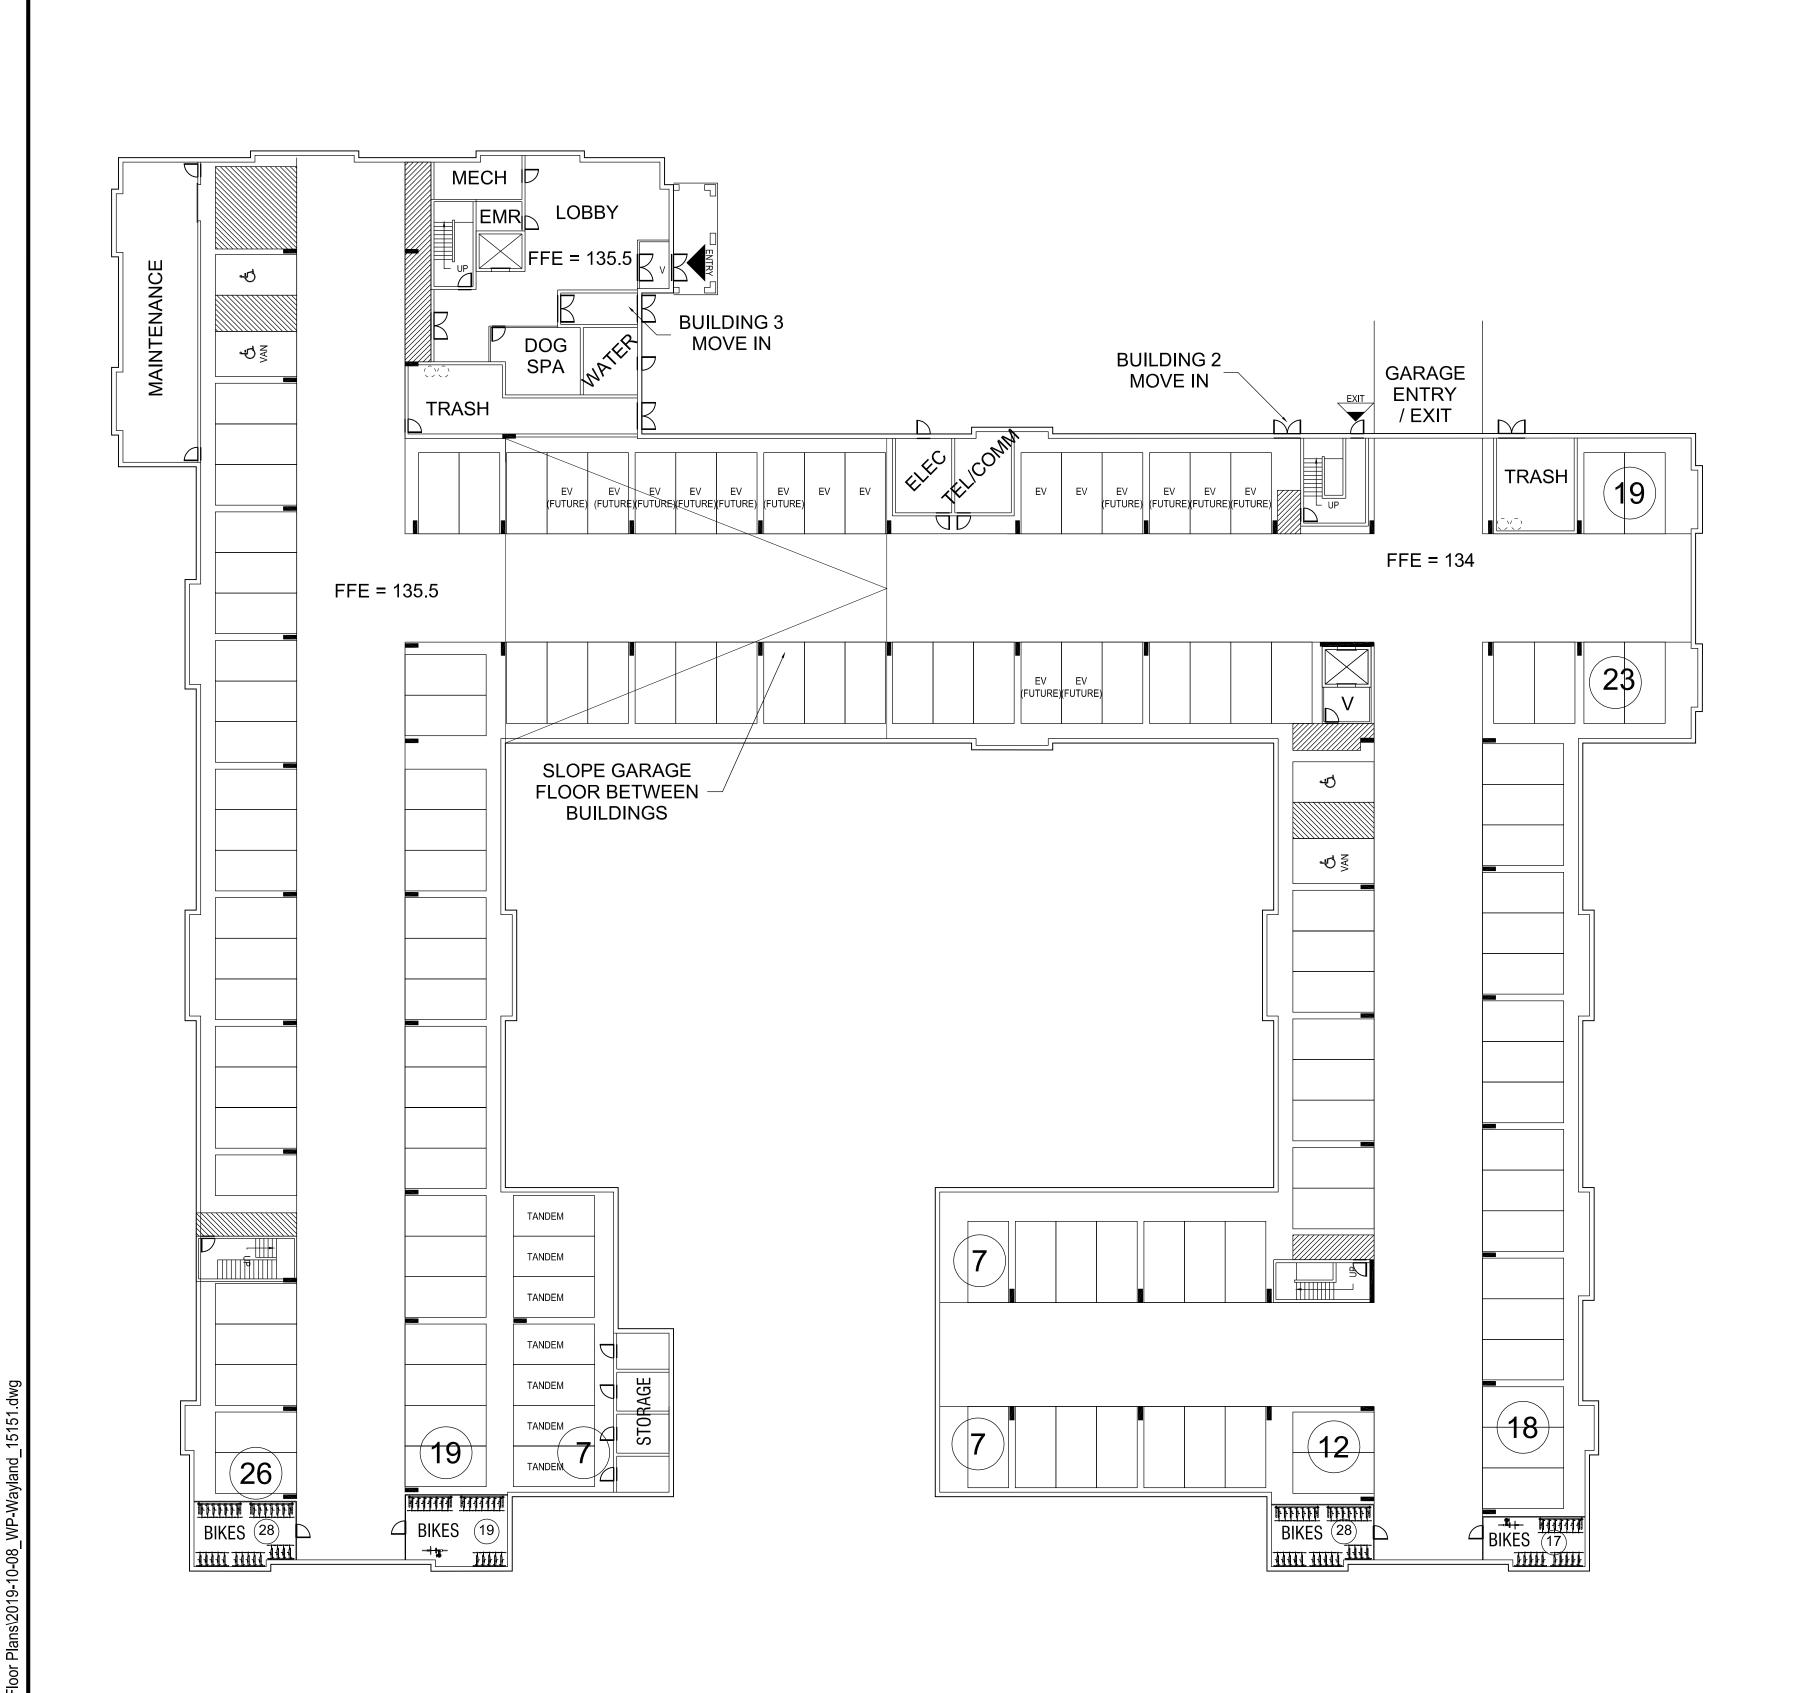
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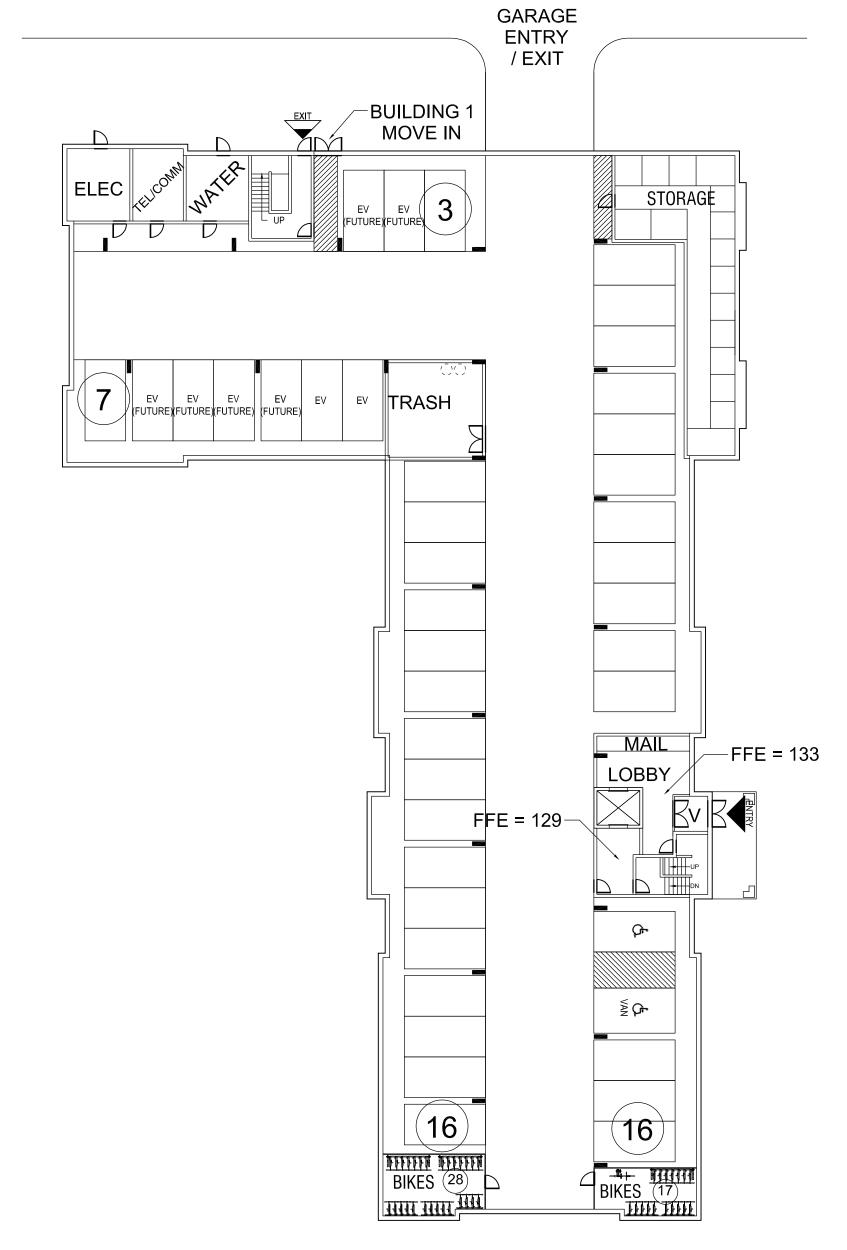
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DETAILS

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PROPOSED PARKING LEVEL

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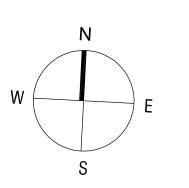
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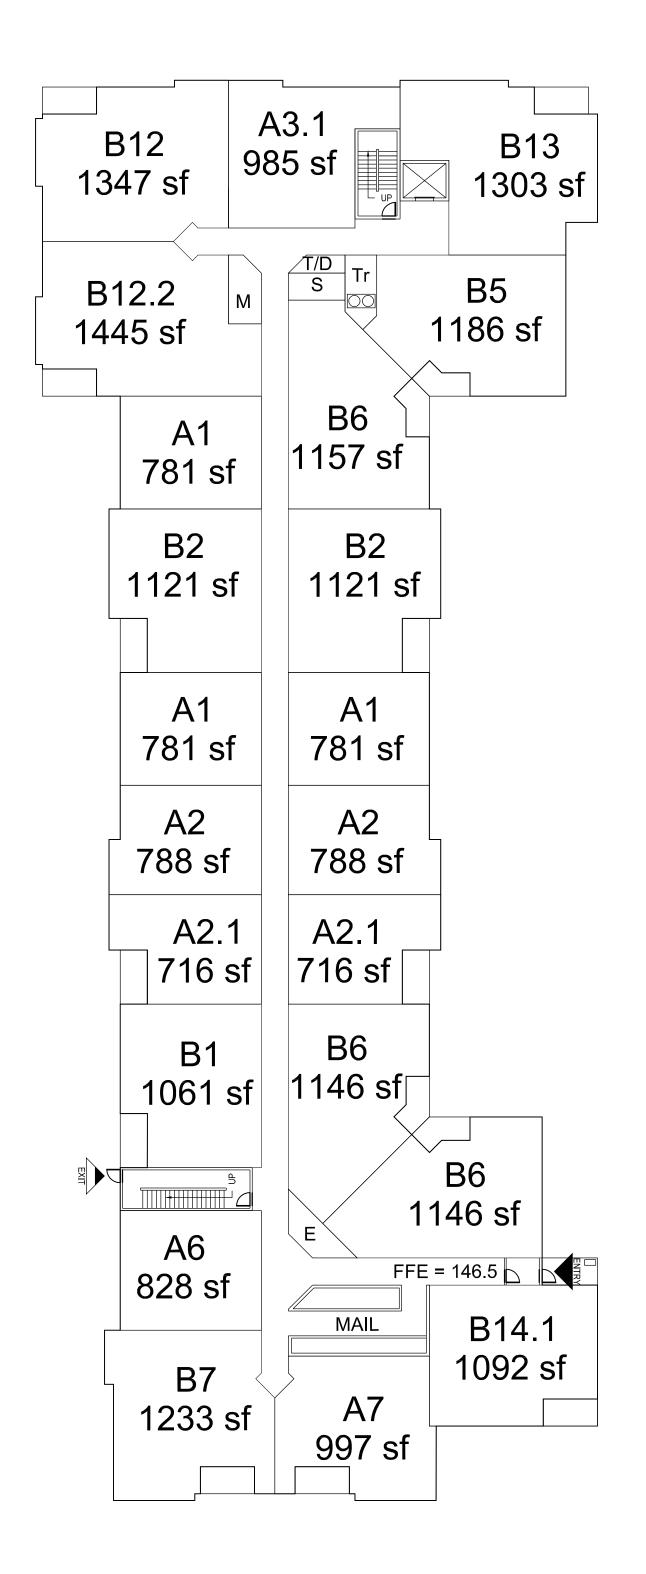
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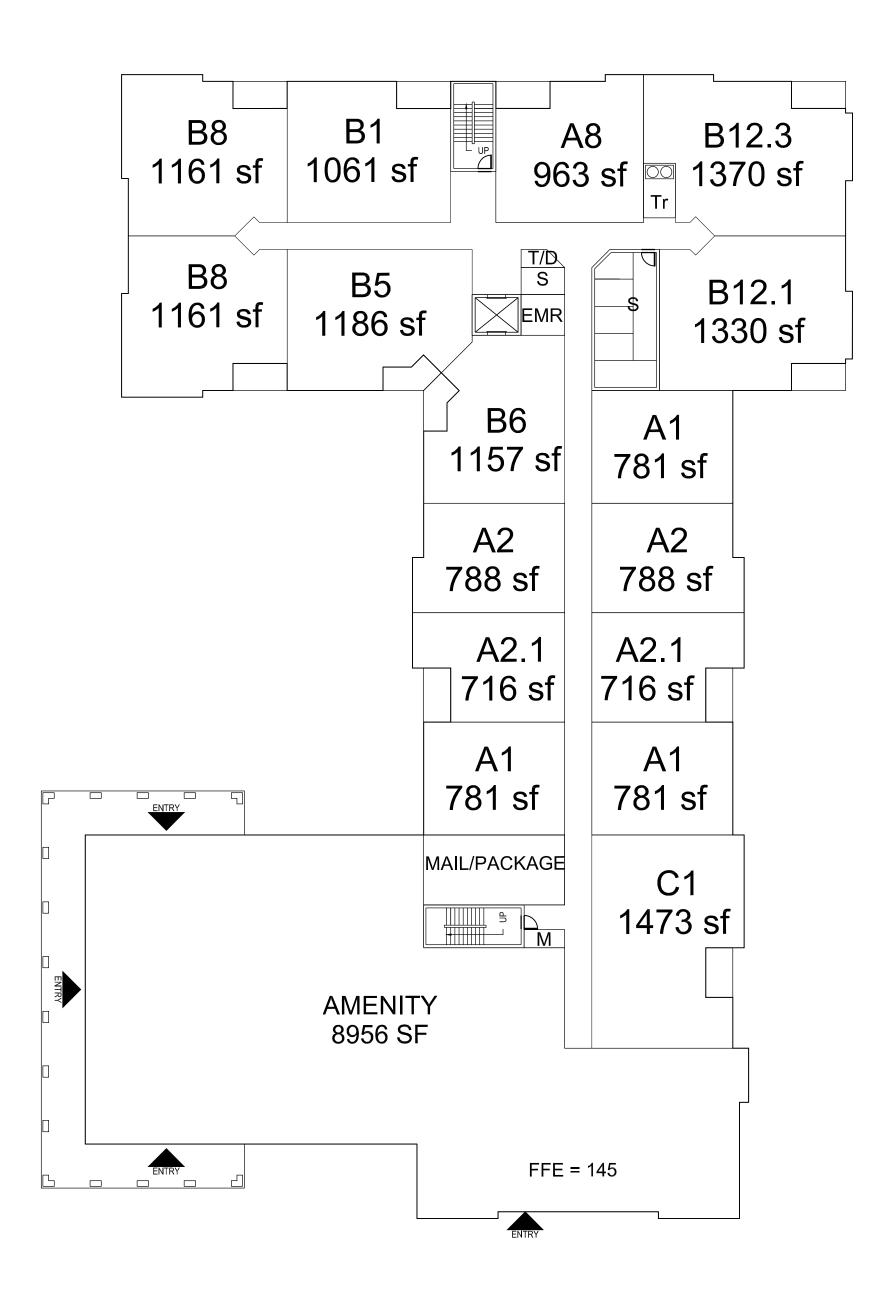
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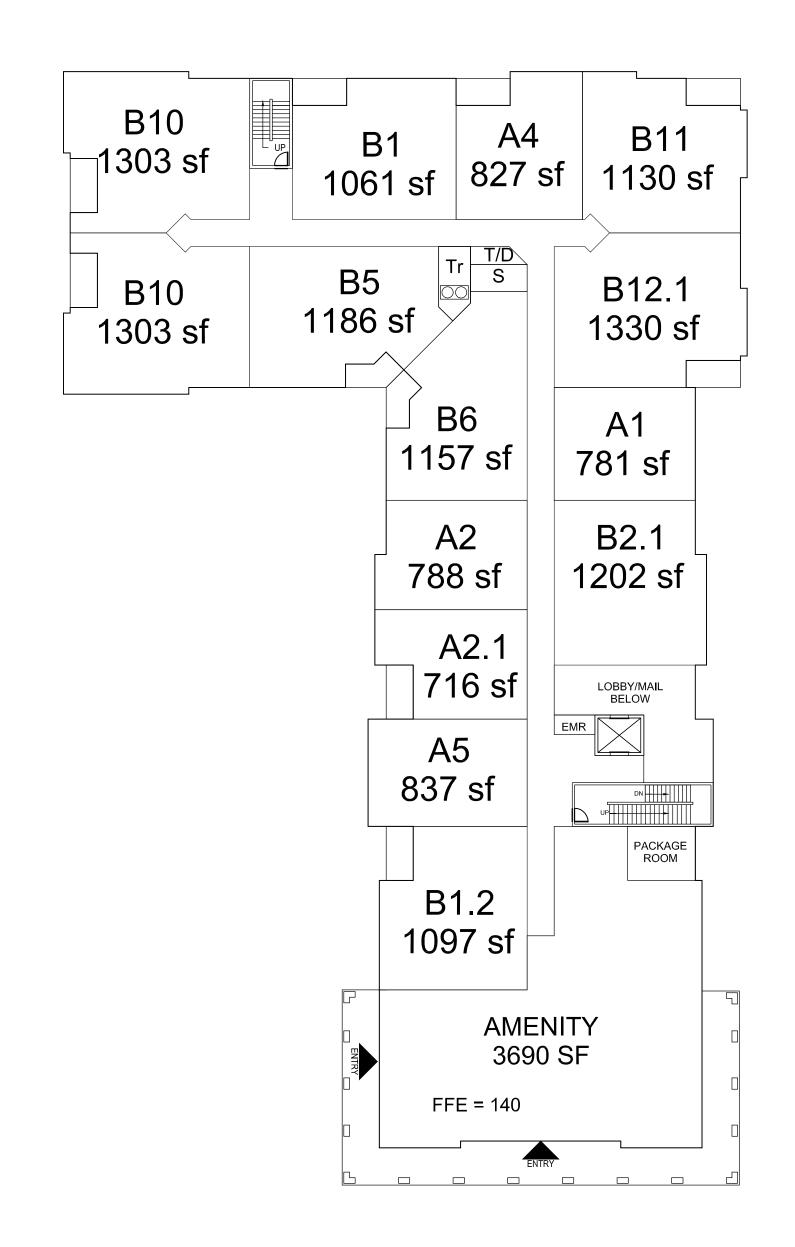
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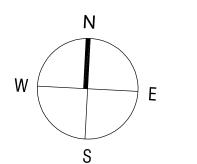






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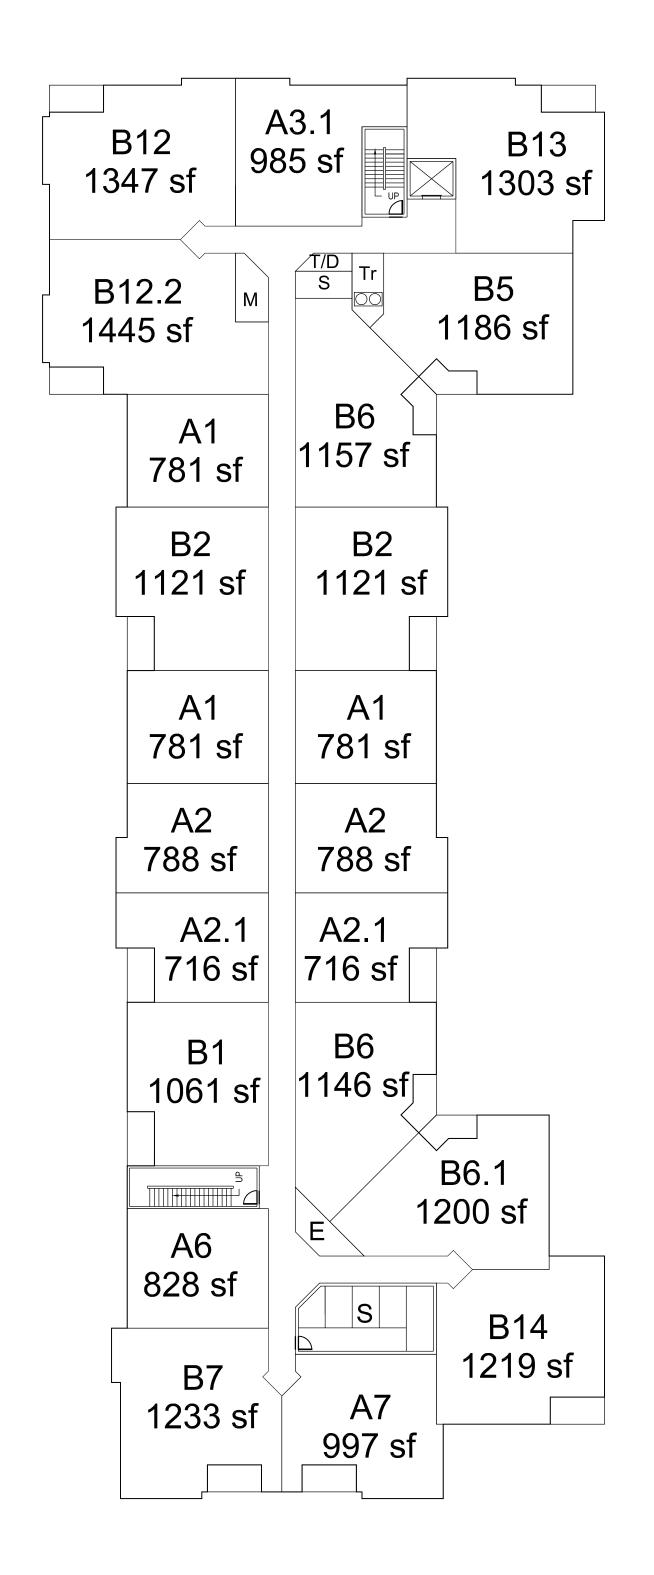
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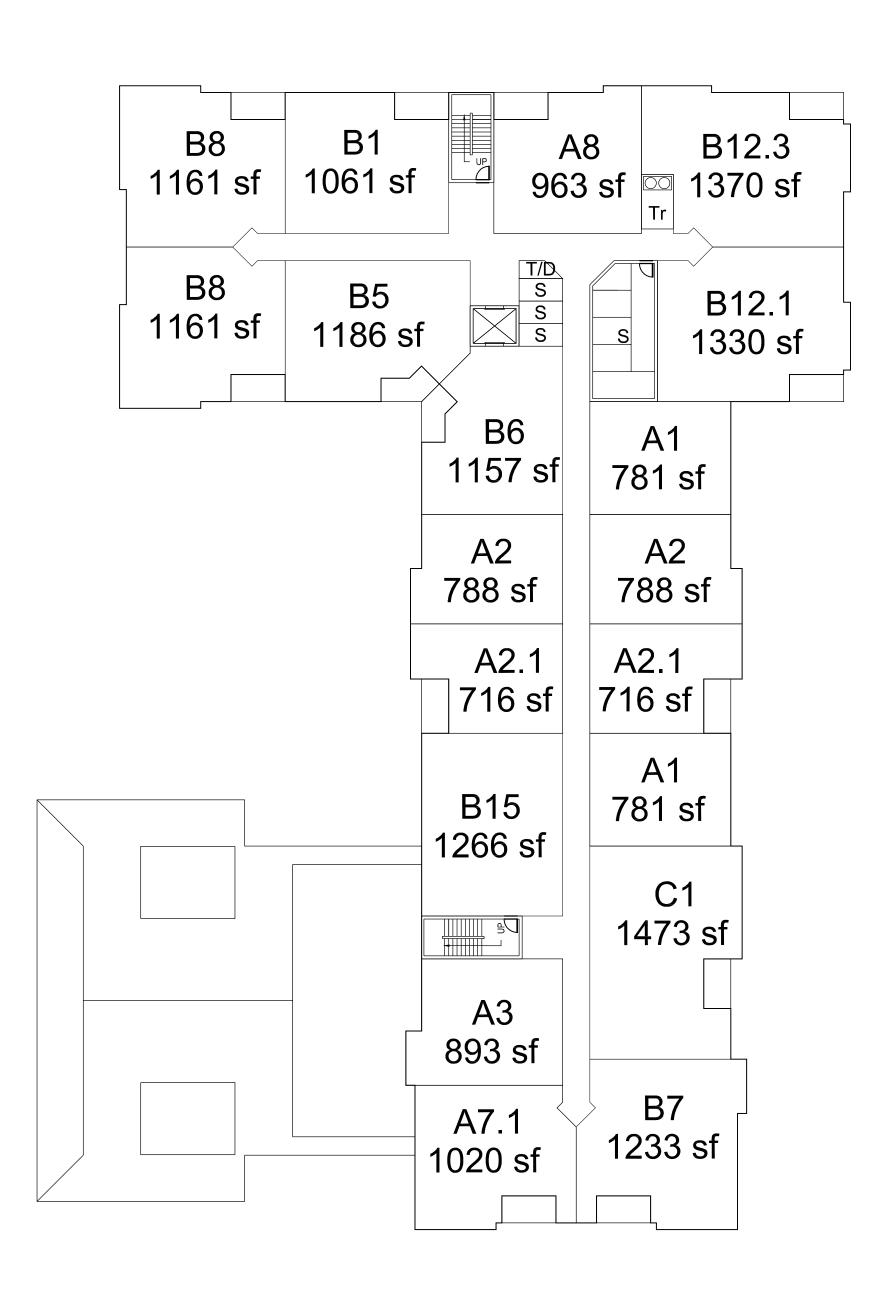
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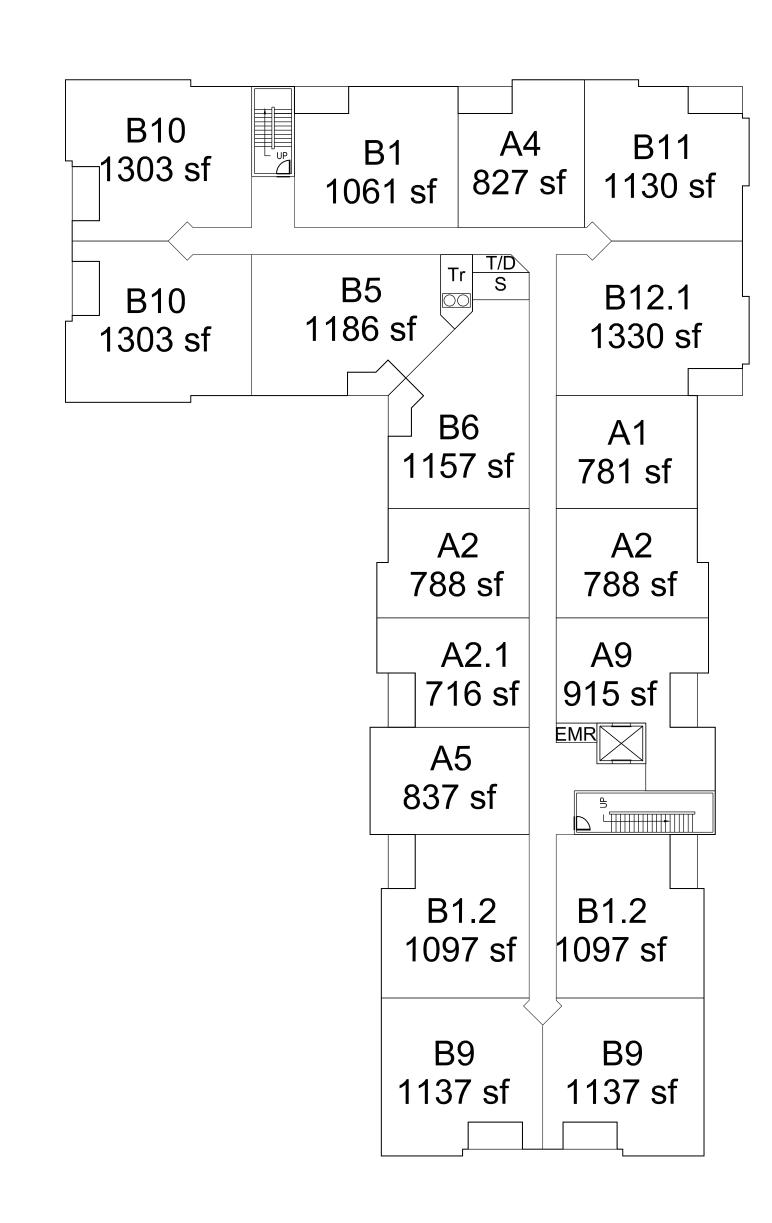
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PROPOSED SECOND AND THIRD FLOORS

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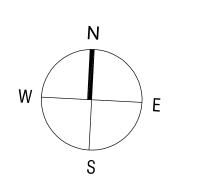
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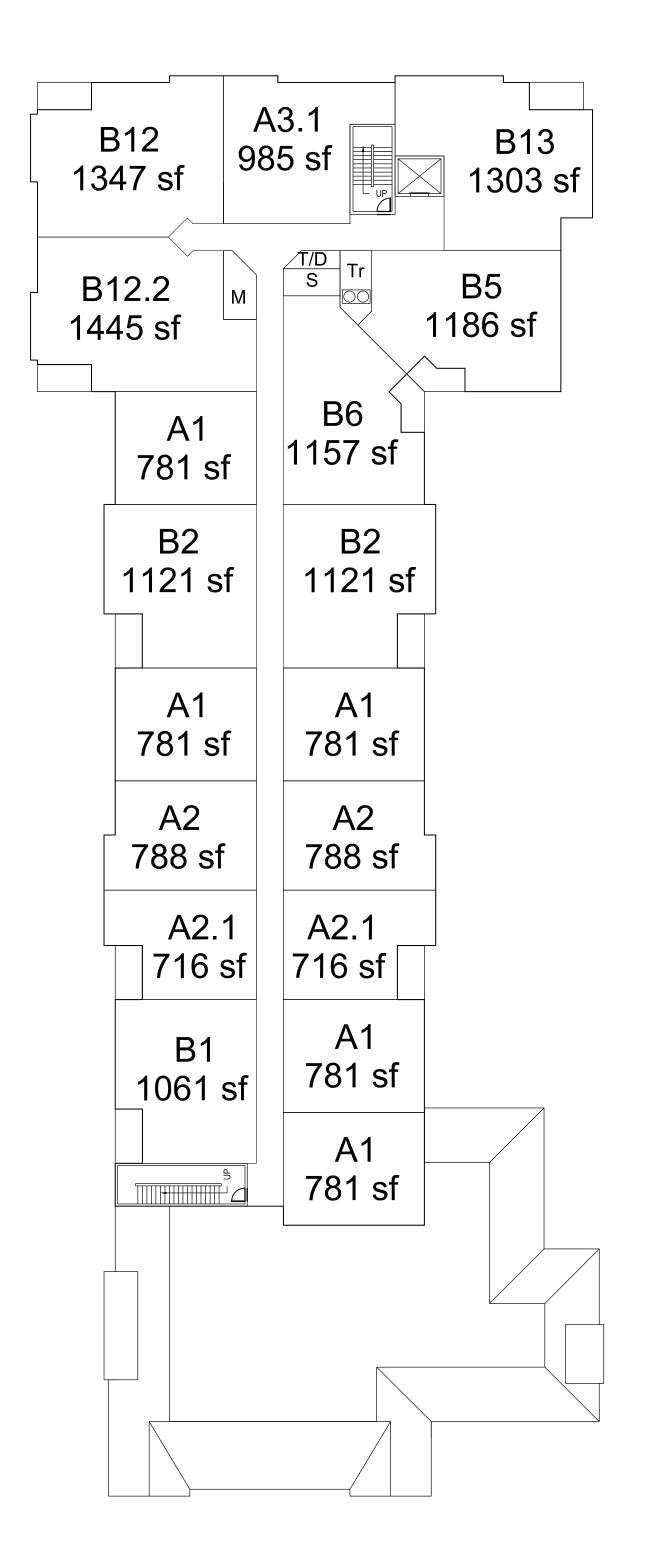
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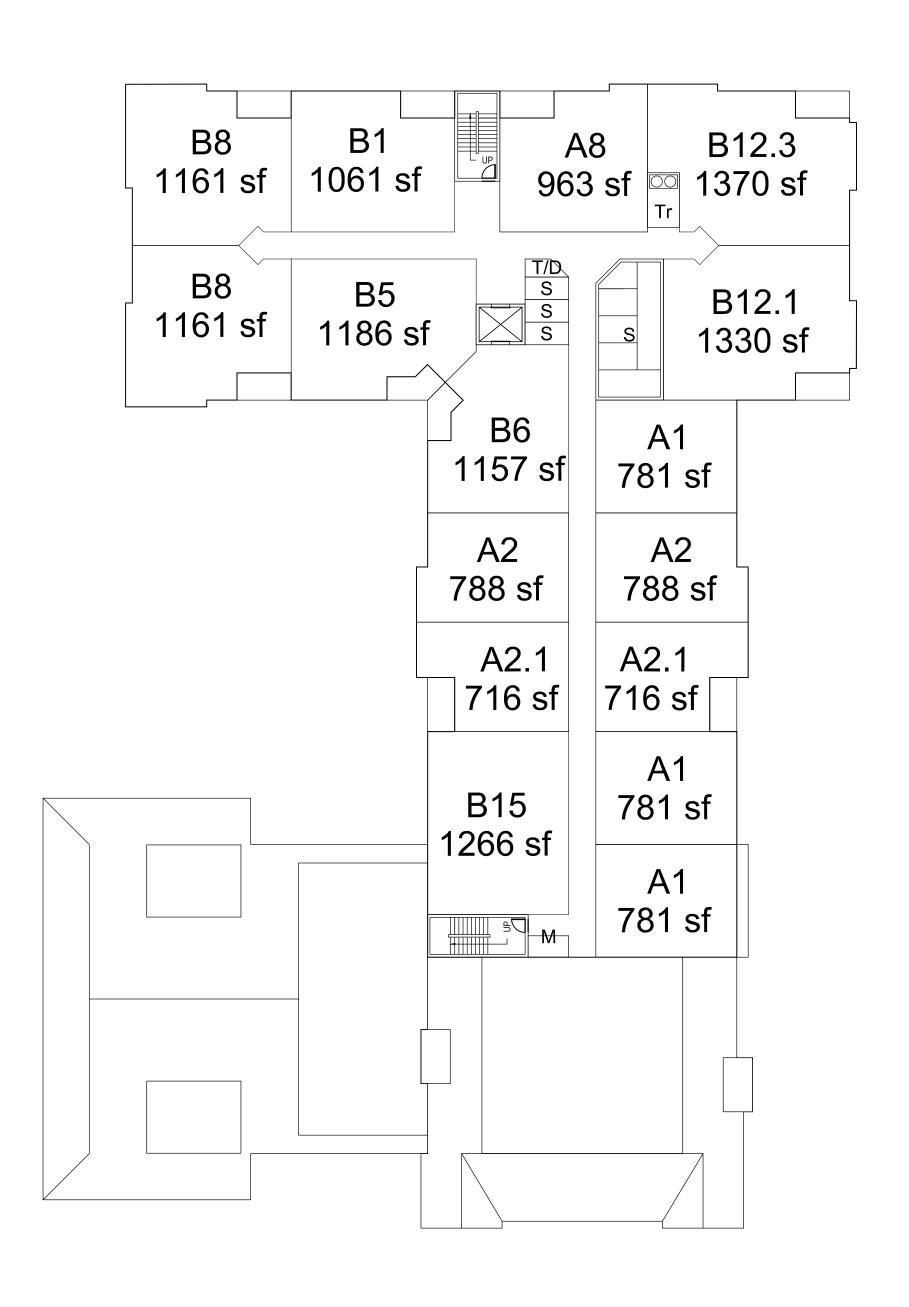
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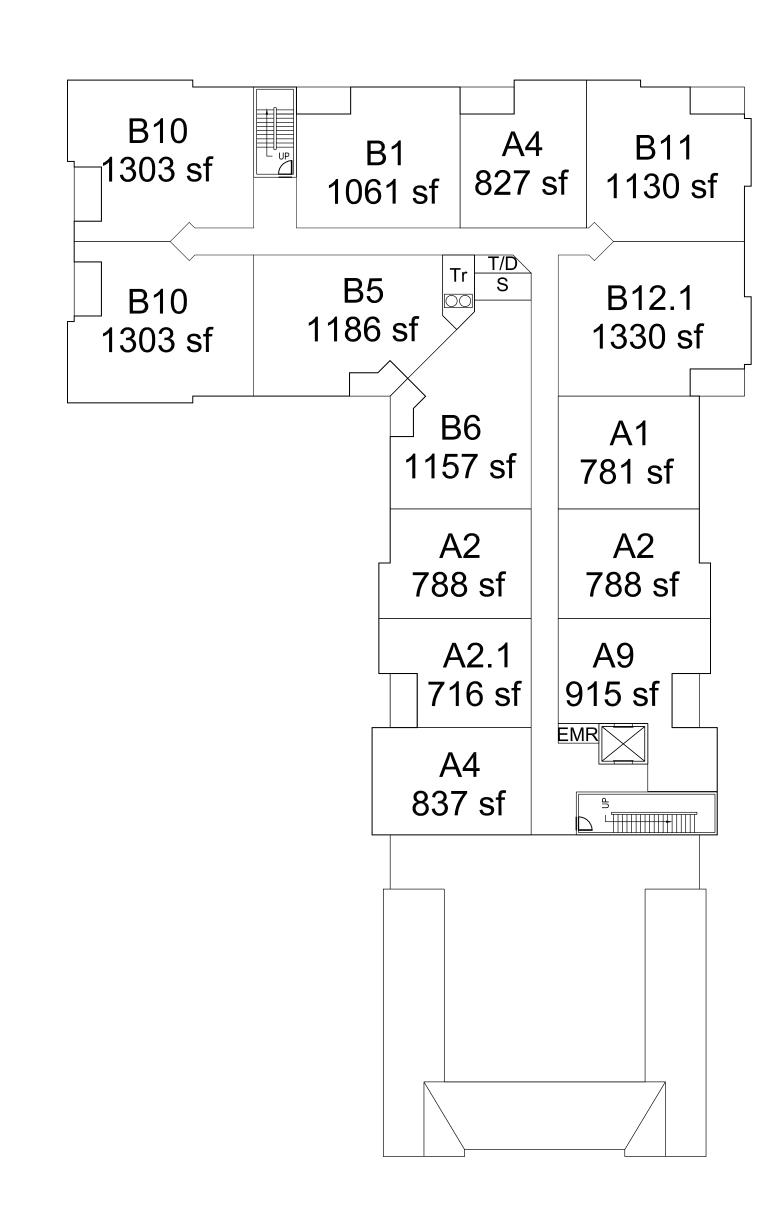
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SOUTH ELEVATION

NORTH ELEVATION



Building 1 Gross So	quare Footage	
	Floor	GSF
	4th Floor	16,660
	3rd Floor	21,376
	2nd Floor	21,376
	1st Floor	21,664
	Podium	22,329
Total Residential GSF		81,076
Total Building GSF (inc Podium)		103,405
Podium Parking Spaces		42
Amenity Area SF		3690
Lobby SF		790
Bike Storage	_	45
Building Efficiency		0.83

Floor	1B	2B	3B Total	
lth Floor	7	7	0 14	
3rd Floor	7	11	0 18	
2nd Floor	7	11	0 18	
1st Floor	5	9	0 14	
Total	26	38	0 64	Units*

218*.25 = 54.5 -- 55 units min.
This is a requirement per the zoning.
Amenity includes 180 SF Package Room
Lobby (garage level) includes Mail SF

	Floor	GSF
	4th Floor	18,963
	3rd Floor	23,043
	2nd Floor	23,043
	1st Floor	28,259
Total Residential GSF		93,308
Amenity Area SF		8,956
Building Efficiency		0.76

Building 2 Unit Count:					
Floor	1B	2B	3B Total		
4th Floor	8	8	0 16		
3rd Floor	9	9	1 19		
2nd Floor	9	9	1 19		
1st Floor	8	7	1 16		
Total	34	33	3 70	Units	

Amenity space includes 485 SF Mail/Package Room

Building 3 Gross Square Footage:				
	Floor	GSF		
	4th Floor	20,295		
	3rd Floor	26,437		
	2nd Floor	26,437		
	1st Floor	26,363		
Total Residential GSF		99,532		
Lobby SF		2,368		
Building Efficiency		0.86		

Building 3 Unit Count:				
Floor	1B	2B	3B Total	
4th Floor	10	8	0 18	
3rd Floor	10	12	0 22	
2nd Floor	10	12	0 22	
1st Floor	10	12	0 22	
Total	40	44	0 84	Units
Lobby (garage		-1-7	0 04	Office

Building 2/3 Podium:

Podium GSF 63,336
Total Building 2/3 GSF (Inc Podium) 256,176
Podium Parking Spaces 138
Bike Storage 92

Includes (7) Tandem Spaces

Project Totals:	
Building 1 Residential GSF	81,076
Building 2 Residential GSF	93,308
Building 3 Residential GSF	99,532
TOTAL RESIDENTIAL GSF	273,916
TOTAL RESIDENTIAL NRSF	223,917
AVERAGE NRSF/UNIT	1027
AVERAGE EFFICIENCY	0.82
TOTAL PODIUM GSF	85,665
TOTAL PROJECT GSF (inc podium)	359,581
TOTAL LOT AREA	8.24 Acres
TOTAL AMENITY AREA	12,646
TOTAL UNIT COUNT	218
TOTAL PODIUM PARKING SPACES	180
TOTAL SURFACE PARKING SPACES	168
TOTAL PARKING SPACES	348
PARKING RATIO PER UNIT	1.60

Unit Totals:					
Floor	1B	2B	3B Total		
4th Floor	25	23	0 48		
3rd Floor	26	32	1 59		
2nd Floor	26	32	1 59		
1st Floor	23	28	1 52		
Total	100	115	3 218	Units	
1 BED RATIO:		45.87%			
2 BED RATIO:		52.75%			
3 BED RATIO:		1.38%			
TOTAL:		100%			



WEST ELEVATION



EAST ELEVATION

the architectural team

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SCHEMATIC BUILDING ELEVATIONS AND BUILDING SUMMARY

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