TO

CONTRACT DOCUMENTS

IMPROVEMENTS TO WAYLAND HIGH SCHOOL ATHLETIC FACILITIES Wayland, MA

IFB #19-1030

October 4, 2018

NOTICE TO BIDDERS

The attention of all bidders submitting proposals for "Improvements to Wayland High School Athletic Facilities" is called to the following Addenda to the specifications and plans. The items set forth herein, whether of omission, addition or substitution are to be included in, and form part of the specifications and plans of the above-named project for bids to be received as advertised.

PLEASE BE SURE TO ACKNOWLEDGE THIS ADDENDUM ON BID PRICING PAGE

The following clarifications, modifications, deletions and additions are hereby incorporated into and become part of the Contract Documents.

For reference and public record, see attachment, - Attendance List: Pre-Bid Site Walk, dated September 27, 2018

WRITTEN CHANGES AND CLARIFICATIONS TO SPECIFICATIONS

1. Specification Section 0011 13 – ADVERTISEMENT FOR BID:

Change in bid dates as follows:

Any questions about this IFB should be directed to Brandon Kunkel, at Weston & Sampson, 85 Devonshire Street, 3rd Floor, Boston, MA 02109, or by email to <u>kunkelb@wseinc.com</u> to be received no later than **Wednesday**, **11:00 AM on October 10**, **2018**.

Sealed bids for the contract will be received at the Facility Department, 2nd Floor, Wayland Town Building, 41 Cochituate Road on **Tuesday, October 16, 2018 at 2:00 PM.**

For clarification. The estimated cost of contract is \$5,300,000.00

- 2. Specification Section 12 40 00 SITE FURNISHING, PART 2 PRODUCTS:
 - A. Section 2.01 SPORTS EQUIPMENT, Item T, BASKETBAL BENCHES:

DELETE Model # L&L-L15-323 (2 total);

ADD Model # SOL-L12-234, Bench with 12 slats, 92×36×18 inches (2 total),

Model # SOL-L12-234-Ext, Extension Bench with 12 slats, 92×36×18 inches (2 total).

Model # SOL-L-SBR-180, Double sided rounded backrest, 71×6×13 inches (2 total)

B. Section 2.01 SPORTS EQUIPMENT

ADD: Item X. SOFTBALL FIELD BLEACHERS

The spectator bleachers at the softball field shall be Model #LU-0415AS with four (4) rows, 15'-0" length as manufactured by GT Grandstands, 2810 Sydney Road, Plant City, FL 33566, 866-550-5511, or approved equal. (2 total)

C. ADD Section 2.02 PICNIC TABLE – Standard and ADA-Compliant,

- 1. The Standard Picnic Table shall be Model #100 Series PL, S-2 surface mount, 6'-0" in length, "Walnut" recycled plastic as manufactured by Dumor, Inc., PO Box 142, Mifflintown, PA 017059, 800-598-4018, or approved equal. All steel members shall be coated with zinc-rich epoxy then finished with polyester powder coating. (1 total)
- 2. The ADA-Compliant Picnic Table shall be Model #100-68-1 PL, S-2 surface mount, 95" in length, "Walnut" recycled plastic as manufactured by Dumor, Inc., PO Box 142, Mifflintown, PA 017059, 800-598-4018, or approved equal. All steel members shall be coated with zinc-rich epoxy then finished with polyester powder coating. (1 total)

D. ADD Section 2.03 TREE GRATE

1. Tree grate shall be Model #6090L, Bond Street tree grate, 60"x60", tree grate in two sections. ½" maximum slot opening for pedestrian safety and ADA compliance. Cast from 100% recycled aluminum. Tree opening: 36"; Weight: Aluminum = 185 lb/85 kg; Finish: unfinished; Frame Model: 6000F, Finish: unfinished; as manufactured by IronSmith, 41-701 Corporate Way #3, Palm Desert, CA 92260, 800-338-4766, or approved equal.

QUESTIONS AND CLARIFICATIONS

Question 1: Can the length of the home bleacher be 138' (standard length for 6' steel spacing) instead of the 139' shown on the plans?

Response: Dimensions may vary slightly and as required by the approved manufacture's bleacher system and /or structural engineers' requirements. All dimensions will be reviewed and approved during the submittal process. The total seat count must be met, and MAAB / ADA requirements must be met.

Question 2: Is the walkway elevation at the visitor bleacher 48" or 49"?

Response: The walkway elevation at the visitor bleacher shall be 48-inch ht.

Question 3: Is the Field General Contractor responsible for the foundations/earthwork for the storage building?

Response: The field contractor is responsible for earthwork excavation, installation of foundations and concrete floor, placing and compacting backfill materials, installing all required conduits and utilities through the foundation walls and floor and stubbing at finished floor elevations, and installing all finished surface materials.

Question 4: Is the Field General Contractor responsible for the foundations/earthwork for the concession/ticket building?

Response: The field contractor is responsible for earthwork excavation, installation of foundations, placing and compacting backfill materials, installing all required conduits and utilities through the foundation walls and stubbing at finished floor elevations, and installing all finished surface materials.

Question 5: Is the Field General Contractor responsible for the foundations/earthwork for the Bathroom Building?

Response: The field contractor is responsible for earthwork excavation, installation of foundations, placing and compacting backfill materials, installing all required conduits and utilities through the foundation walls and stubbing at finished floor elevations, and installing all finished surface materials.

Question 6: Is the proposed infield area to be constructed in accordance with Detail #4 on Sheet L7.02 (depth of 3")?

Response: Contractor shall DELETE reference to 3" depth and ADD 4" depth to Detail 4, L7.07 – WARNING TRACK MIX

Question 7: What is the size of the Perforated HDPE collector pipe on the inside of the track?

Response: The perforated HDPE collector pipe for the synthetic turf field shall be 12."

Question 8: Is there a requirement to supply maintenance equipment for the new turf field?

Response: There is no requirement to supply maintenance equipment for the new turf field.

Question 9: Will the center logo on the synthetic turf field be more than one color? Is a logo drawing available?

Response: The logo shall be two colors. Refer to the Detail 1, L7.08 – SYNTHETIC TURF STRIPING LAYOUT for information on the center logo.

Question 10: Where will excess material, if any, be permitted to go?

Response: Per Wayland town by-law §198-504 EARTH MOVEMENT, excess material is not allowed to be disposed of outside of the town limits without a special permit issued by the Wayland ZBA. The contractor shall dispose of excess material at a location designated by the Owner's Representative.

Question 11: What is the fiber reinforced mesh noted in the anchor curb detail?

Response: Refer to Specification 03 30 00, Sub-section 2.03, A: FIBER REINFORCEMENT. Concrete reinforcing fibers shall be polypropylene, collated, fibrillated fibers from Fibermesh Co. or approved equal.

ATTACHMENTS:

Pre-Bid Attendee List Basketball Benches Cut Sheets Tree Grate Cut Sheets Picnic Table Cut Sheets

END OF ADDENDUM NO. 1

IMPROVEMENTS TO WAYLAND HIGH SCHOOL ATHLETIC FACILITIES Wayland, MA

IFB #19-1030

Pre-Bid Meeting Attendees

September 27, 2018

NAME	COMPANY	PHONE	EMAIL
Mike Salem/Peter	Argus	781-275-2417	peter@argusconstructioncorp.com
Salem			
Steve Zoto	MountainView	413-536-7555	stevez@mountainviewinc.com
Bill Lorenz	Act Global	978-404-1789	blorenz@actglobal.com
Travis Kalberer	David White	603-856-5442	travis@dwwsport.com
Mark Masella	Quirk	978-352-4666	mark@quirkcorp.com
Bill Austin	United Concrete	203-535-4338	baustin@unitedconcrete.com
Brian Turner	Aries Building	603-216-1086	bturner@ariesbuildings.com
	Systems		
Jack Blais	Blais Electrical		blaiselectrical@live.com
Brandon Kunkel	Weston &	(617) 412-4480	kunkelb@wseinc.com
	Sampson		
Cassidy Chroust	Weston &	(617) 412-4480	chroustc@wseinc.com
	Sampson		
Ben Keefe	Town of Wayland		

Product Sheet Solid Benches

Timber seat with steel supports. FSC hardwood slats (7x7cm) locked into Streetlock® comb fittings; extendable with extension set





Product Code SOL-L12-234 SOL-L12-300

Dimensions ca. 234x93x45cm | 92x37x18" (wxdxh)

ca. 300x93x45cm | 118x37x18" (wxdxh)

Weight ca. 161kg | 355lbs (plain, without options)

ca. 191kg | 421lbs (plain, without options)

Material Seat: timber, untreated 100% Hardwood Cumaru

Solid slats (7x7cm | 2.8x2.8")

Supports: rectangular shaped feet in hot dip galvanised steel

according to NEN-EN-ISO 1461: 2009NL

Optional: supports in CorTen Steel (weathering steel) or with

double PPC finish in RAL colour

Mounting equipment Stainless steel anti-theft flange nuts and Pin-Torx L-key

Accessories/extras Quatro backrest or Soft backrest

Seat in black recycled plastic (All Black)

Armrest in stainless steel with micro-peen finish

Delivery Supports, slats and mounting tools detached

Cleaning & Maintenance


Timber: with clear water and soft brush or cloth; do not use high pressure cleaner or similar (this can open up the wood grain and make the surface coarse)

The timber can be gently sanded every 2-3 year (in the direction of the wood grain)

Steel supports: with clear water and brush or high pressure water cleaner (avoid the timber seat)

Installation

Surface mounted; supports have four holes each for M12 bolts to connect to hard flat surface or in-ground footings

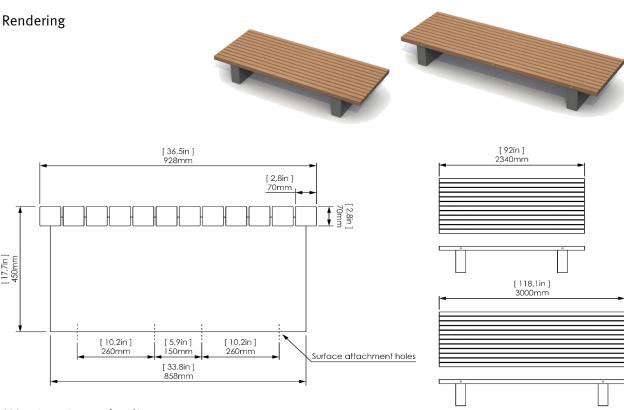

*Metric units are leading

Design: Streetlife

Protected by int. Modeldepots & Patents

NON-ELEVATED BLEACHER





COVER SHEET 4 ROW BLEACHER 6" RISE / I2" SEAT

OPTIONAL -MS (MUD SILL) OPTIONAL -RB (RUBBER BUMPERS) LU-0415AS

DRAWN BY
MME
CHECKED BY

LU-04I5AS

CS.1

COVER SHEET


- BLEACHER SEATING PLAN

 FRAME AND BRACING BA.1 - BLEACHER ASSEMBLY

FOUNDATION PLAN

ALUMINUM 4 ROW x 15'-0" - UNIVERSAL SERIES

MODEL **LU-0415AS**

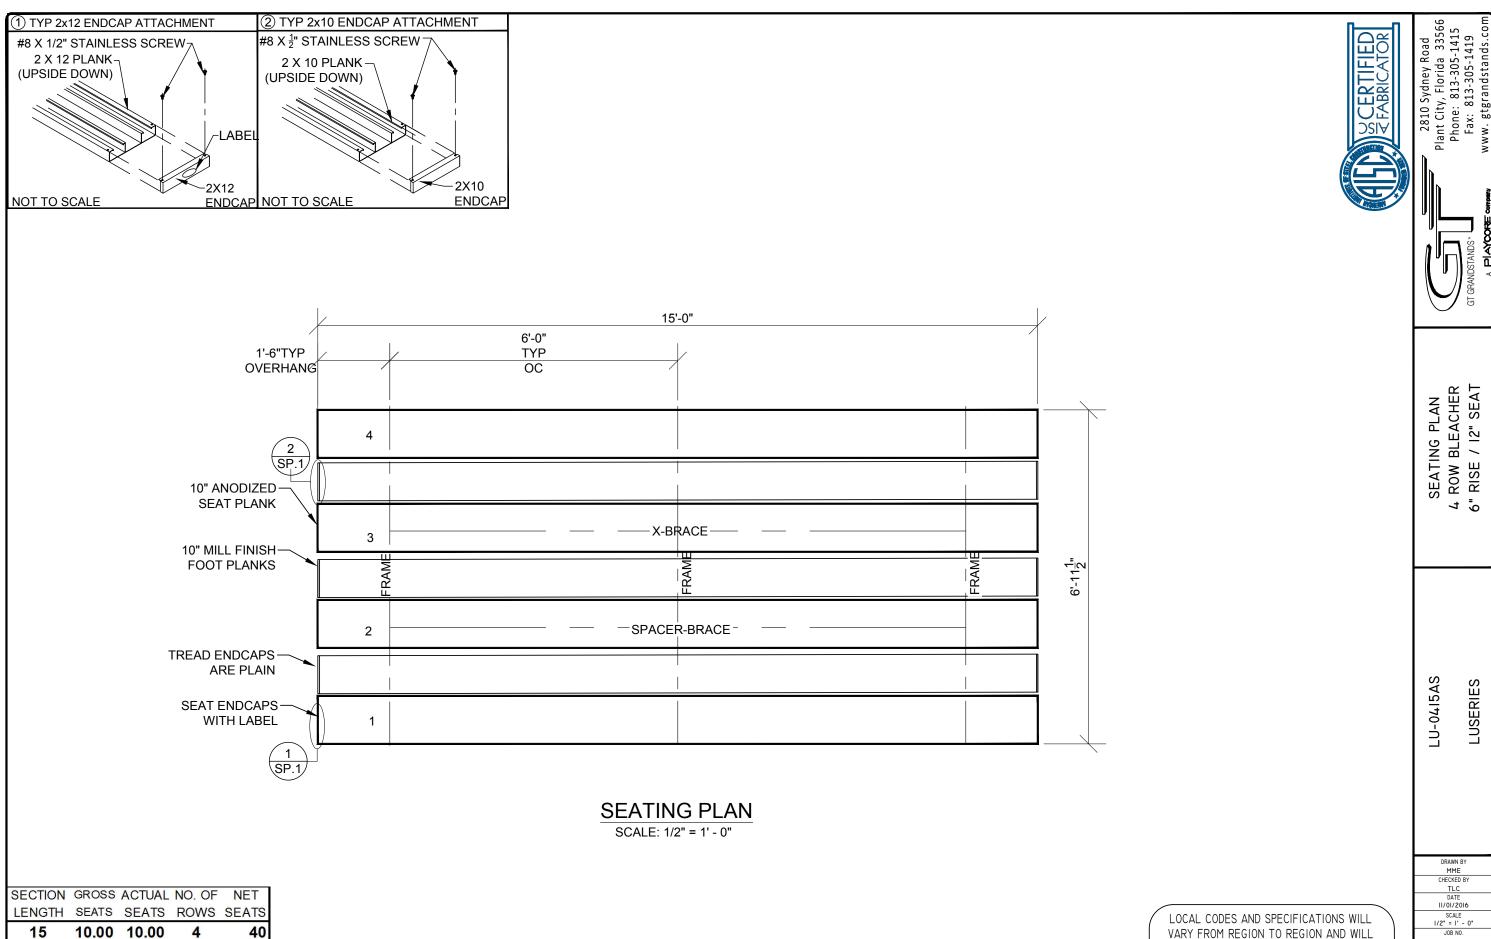

NET SEATS

WHEELCHAIR SPACES

(BASED ON 18" PER SEAT)

TOTAL NET SEATING CAPACITY


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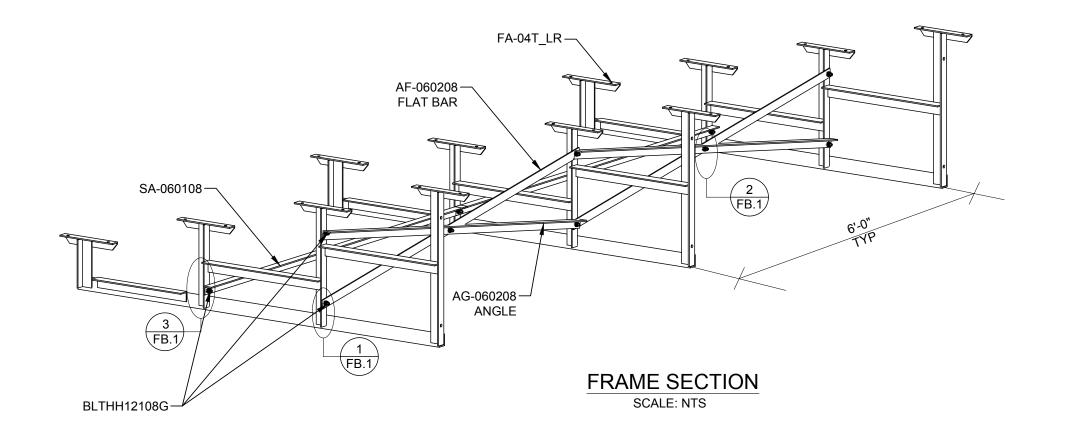
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LOCAL CODES AND SPECIFICATIONS WILL VARY FROM REGION TO REGION AND WILL ALSO CHANGE OVER TIME. IT IS THE BUYER'S RESPONSIBILITY TO CHECK LOCAL CODES FOR COMPLIANCE.

LU-04I5AS

SP.1



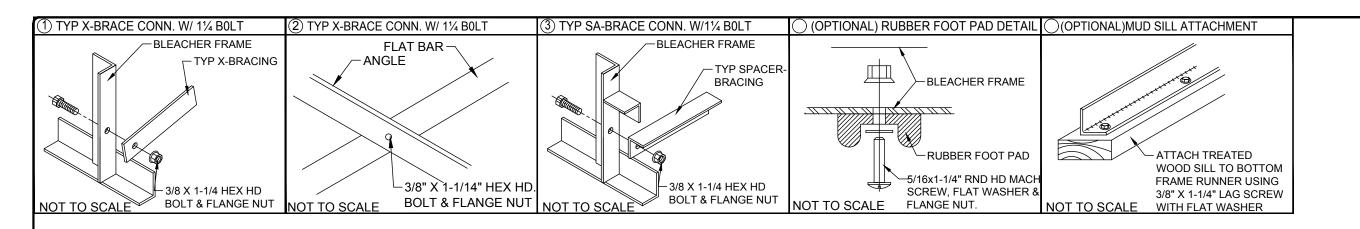

SCERTIFIED STABRICATOR

GT GRANDSTANDS*


FRAME AND BRACE 4 ROW BLEACHER 6" RISE / I2" SEAT

LU-0415AS OPTIONAL -MS (MUD SILL) OPTIONAL -RB (RUBBER BUMPER)


DRAWN BY	
MME	
CHECKED BY	
TLC	
DATE	
11/01/2016	
SCALE	
AS SHOWN	
JOB NO.	

LU-0415AS DWG NO.

FB.1

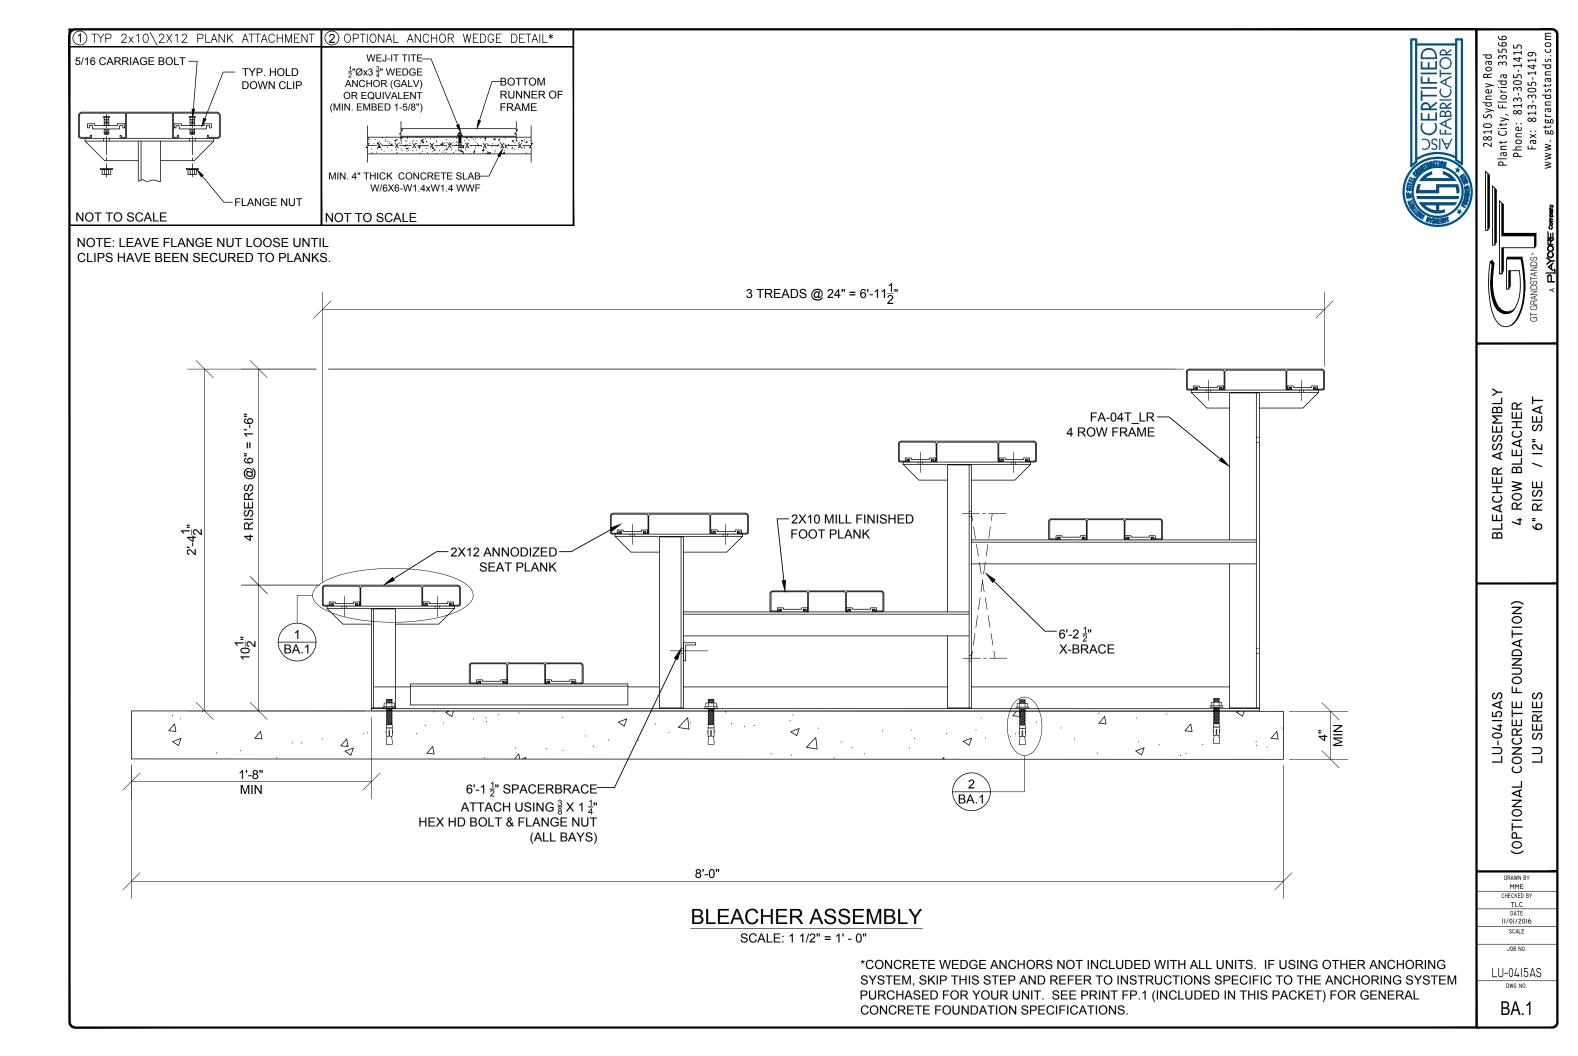



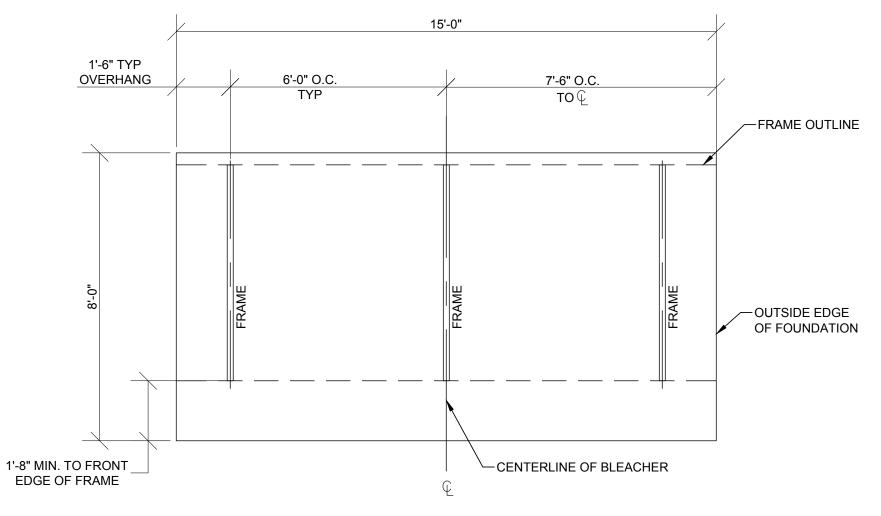

OPTIONAL FOUNDATION PLAN*

SCALE: 3/8" = 1' - 0"

* MINIMUM FOUNDATION AREA SHOWN. DEPENDING ON LOCAL SOIL CONDITIONS, BLEACHER CAN BE INSTALLED ON A CONCRETE PAD OR FOOTERS, OR ATTACHED TO 2x6 TREATED LUMBER GROUND SILLS AND PLACED ON COMPACTED STONE, ASPHALT, OR ANY OTHER SMOOTH, SOLID, LEVEL SURFACE. CONSULT YOUR LOCAL CONCRETE CONTRACTOR TO DETERMINE PROPER CONCRETE SPECIFICATIONS FOR YOUR LOCAL SOIL AND WEATHER-RELATED CONDITIONS. THE BEARING SURFACE MUST BE CAPABLE OF SUPPORTING A MINIMUM OF 660 POUNDS PER LINEAR FOOT. TO MEET LOCAL CODES, BLEACHERS WILL NEED TO BE ANCHORED. ANCHORING SYSTEMS FOR ALL SURFACE TYPES ARE AVAILABLE - CONTACT YOUR BLEACHER SALES REPRESENTATIVE FOR MORE INFORMATION.

) (


FOUNDATION PLAN 4 ROW BLEACHER 6" RISE / I2" SEAT

LU-0415AS LU SERIES

DRAWN BY
MME
CHECKED BY
TLC
DATE
II/01/2016
SCALE

JOB NO.

FP.1

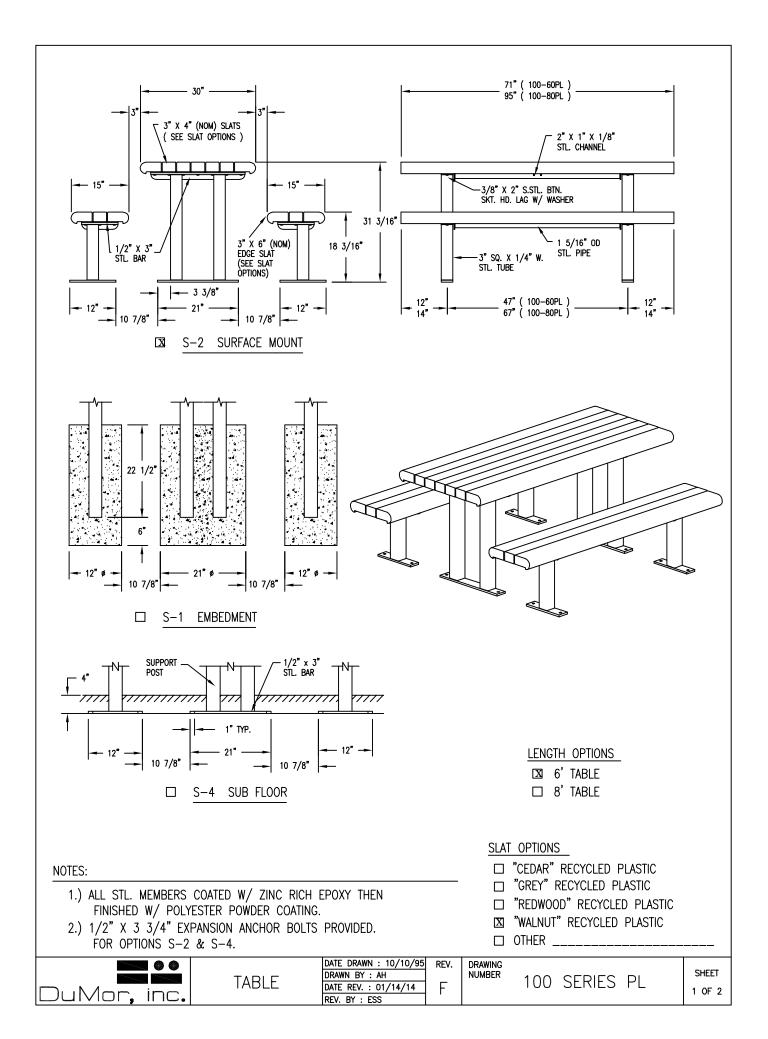

NOTE:

- 1.) DURING ASSEMBLY PROCEDURE; DO NOT COMPLETELY TIGHTEN HARDWARE.
- 2.) THE ACTUAL PARTS WILL NOT BE NUMBERED. NUMBERS ONLY APPLY TO DRAWING.
- 3.) UPON COMPLETION OF ASSEMBLY SQUARE ALL COMPONENTS THEN TIGHTEN ALL HARDWARE.
- 4.) MOUNT AND ANCHOR AS SPECIFIED.

TOOLS REQ'D 3/4" WRENCH


3/4" WRENCH 1/4" ALLEN WRENCH 1/2" MASONRY DRILL BIT DRILL

PARTS LIST FOR S-2			
ITEM	QTY	PART NO	DESCRIPTION
1	2	0-100-00-01/S-2	TABLE TOP SUPPORT FOR SURFACE
2	4	0-100-00-02/S-2	SEAT SUPPORT FOR SURFACE MT
3	1	0-100-60-05	6' TABLE TOP BRACE
4	2	0-100-60-06	6' SEAT BRACE
5	7	0-88-60PL-02	3" X 4" X 71" INT'R SLAT, PLASTIC
6	6	0-88-60PL-03	71" EDGE SLAT, PLASTIC
7	39	1-13-016	3/8" X 2" SS BTN SKT HD LAG SCR
8	39	1-22-024	3/8" SS FLAT WASHER

KITS PROVIDED FOR S-2

ITEM	QTY	PART NO	DESCRIPTION
9	3	K-ANC0860-4	1/2" X 3 3/4" SS ANCHOR KIT (4PC)
10	1	K-BL0632-40	3/8" LAG HARDWARE KIT (40PC)

(1) ATTACH SLATS & BRACES TO SUPPORTS.

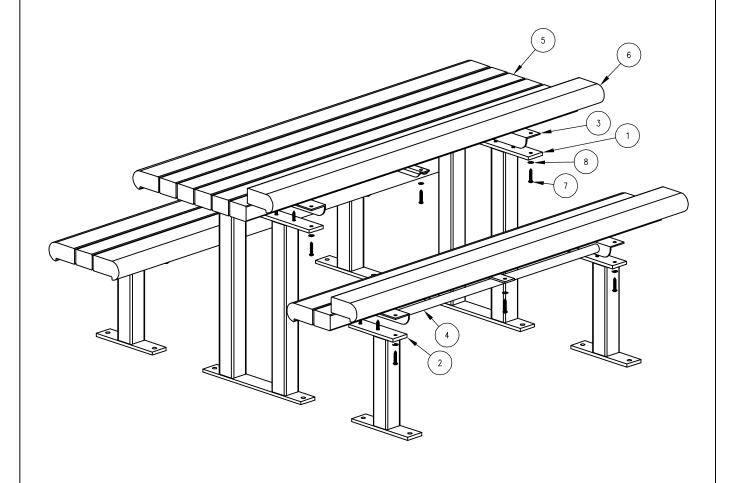


		• •
DuMo	Г.	inc.

ASSEMBLY INSTRUCTIONS

DATE DRAWN: 10/10/95 DRAWN BY: AWH DATE REV.: 01/14/14 REV. BY: ESS REV.

DRAWING NUMBER 100 SERIES PL

SHEET 2 OF 2

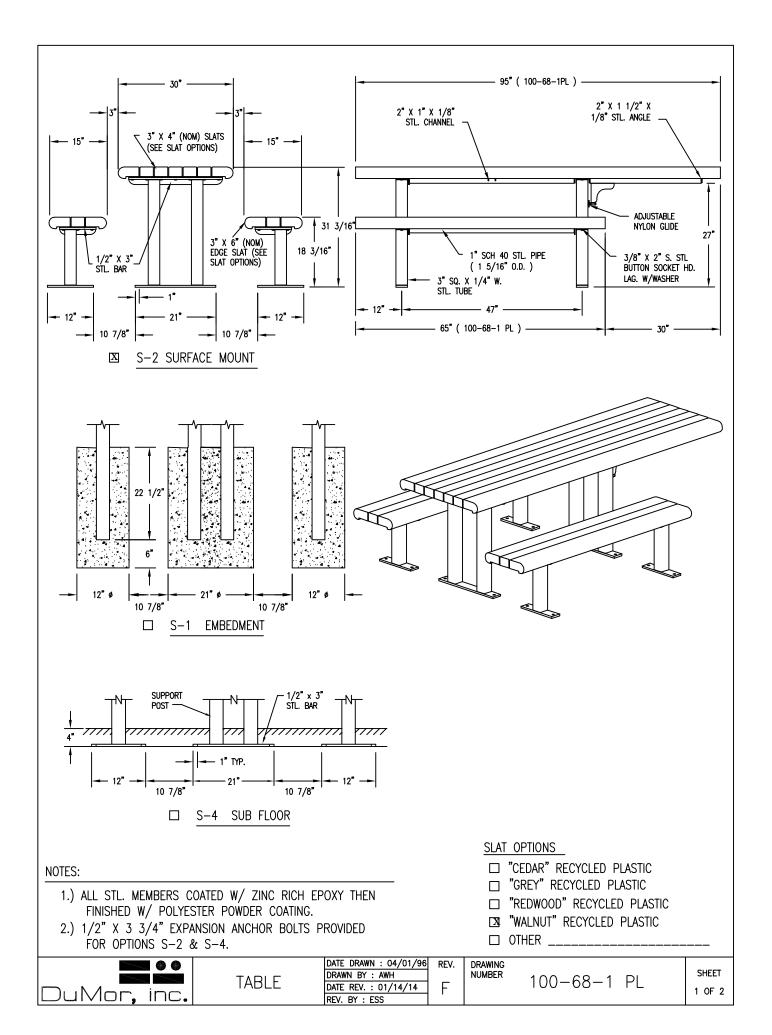

NOTE:

- 1.) DURING ASSEMBLY PROCEDURE; DO NOT COMPLETELY TIGHTEN HARDWARE.
- 2.) THE ACTUAL PARTS WILL NOT BE NUMBERED. NUMBERS ONLY APPLY TO DRAWING.
- 3.) UPON COMPLETION OF ASSEMBLY SQUARE ALL COMPONENTS THEN TIGHTEN ALL HARDWARE.
- 4.) MOUNT AND ANCHOR AS SPECIFIED.

TOOLS REQ'D


3/4" WRENCH 9/16" WRENCH 1/4" ALLEN WRENCH 1/2" MASONRY DRILL BIT DRILL

PARTS LIST FOR S-2			S LIST FOR S-2
ITEM	ŢΩ	PART NO	DESCRIPTION
1	2	0-100-00-01/S-2	TABLE TOP SUPPORT FOR SURFACE
2	4	0-100-00-02/S-2	SEAT SUPPORT FOR SURFACE MT
3	2	0-100-60-06	6' SEAT BRACE
4	1	0-100-68-1-05	TABLE TOP BRACE, HANDICAPPED
5	5	0-100-681PL-1	3" X 4" X 95" INT'R TABLE SLAT, PLASTIC
6	1	0-100-681PL-2	95" RIGHT EDGE TABLE SLAT, PLASTIC
7	2	0-100-681PL-3	3" X 4" X 65" INT'R SEAT SLAT, PLASTIC
8	2	0-100-681PL-4	65" RIGHT EDGE SEAT SLAT, PLASTIC
9	1	0-100-681PL-8	95" LEFT EDGE TABLE SLAT, PLASTIC
10	2	0-100-681PL-9	65" LEFT EDGE SEAT SLAT, PLASTIC
11	46	1-13-016	3/8" X 2" SS BTN SKT HD LAG SCR
12	46	1-22-024	3/8" SS FLAT WASHER
13	2	5-48-076	3/8" X 1 1/2" SWIVEL GLIDE
LUTO DESCRIPTE FOR CO.			


KITS PROVIDED FOR S-2

ITEM	QTY	PART NO	DESCRIPTION
14	3	K-ANC0860-4	1/2" X 3 3/4" SS ANCHOR KIT (4PC)
15	1	K-BL0632-48	3/8" LAG HARDWARE KIT (48PC)
16	1	K-GL0624-2	3/8" X 1 1/2" GLIDE KIT (2PCS)

1 ATTACH GLIDES TO TABLE TOP BRACE.

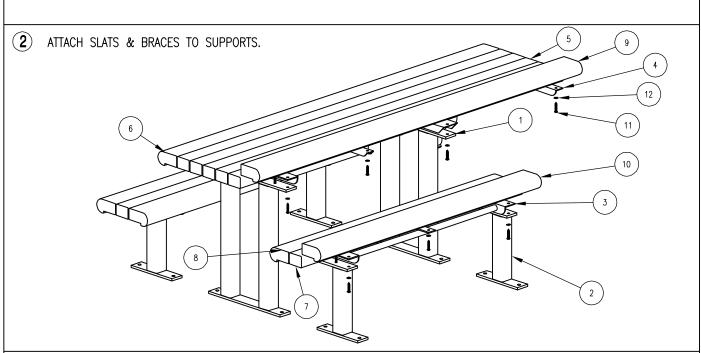

(3) UNSCREW SWIVEL GLIDE SO IT FITS TIGHT AGAINST SUPPORT POST TUBE AND TIGHTEN.

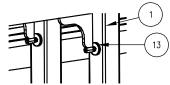

DuMor, inc.


ASSEMBLY INSTRUCTIONS

DATE DRAWN: 04/01/96 DRAWN BY: AWH DATE REV.: 01/14/14 REV. BY: ESS

REV.

DRAWING NUMBER 100-68-1 PL

SHEET 2 OF 2

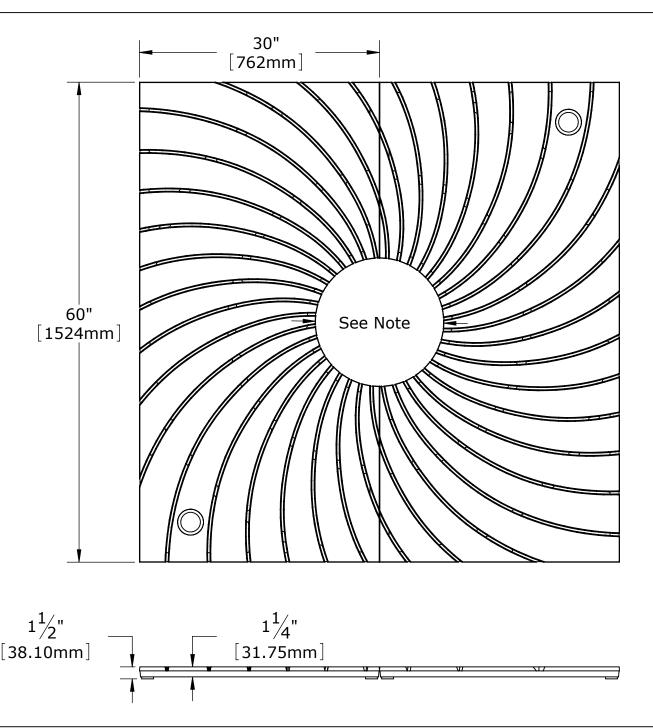

PROPRIETARY AND CONFIDENTIAL

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6090L

Bond Street

60" x 60"

tree grate in two sections. Two lightwells as shown. To be used exclusively with TGL-2 series IRONSMITH Lamp assembly. Lamp sold separately from Tree Grate.

1/2" maximum slot opening for A.D.A. compliance and pedestrian safety.

Cast from 100% recycled Iron, Aluminum, or Bronze for Pedestrian loads only.

Tree opening: 16", 36"
Grates can be ordered with or later expanded to these openings.

Finish: Unfinished, or Black Dip, or Enamel Paint, or Polyurethane Paint, or Powder Coat. Zinc undercoat available.

Specify finish and color.

Use Frame Model: 6000F

Weight: Iron=485 lb/ 220Kg Aluminum=185 lb/ 85Kg

DO NOT SCALE DRAWING

IRONSMITH

41-701 Corporate Way #3 Palm Desert, CA 92260 (800) 338-4766 (760) 776-5080 Fax