

PREPARED BY:

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DESIGN STUDIO

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TOWN OF WAYLAND


IMPROVEMENTS TO LOKER CONSERVATION AND RECREATION AREA

TOWN OF WAYLAND, MASSACHUSETTS

TOWN BUILDING
41 COCHITUATE RD
WAYLAND, MA 01778
BEN KEEFE
PUBLIC BUILDING DIRECTOR
(508) 358-3786

Locus Map



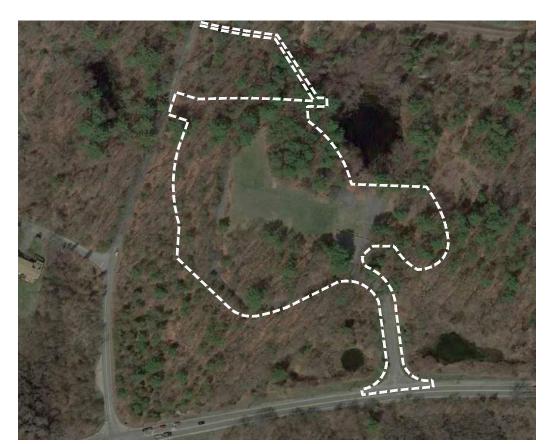

LOKER CONSERVATION AND RECREATION AREA



LOKER CONSEVATION AND RECREATION AREA 410 COMMONWEALTH RD, WAYLAND, MA 01778

PERMITTING SET

-NOT FOR CONSTRUCTION-

FEBRUARY 18, 2022 Prepared By



85 Devonshire St, 3rd Floor, Boston, MA 02109 (617) 412-4480 (800) Sampson w w w . w e s t o n a n d s a m p s o n . c o m

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GENERAL NOTES

- PROPERTY LINES, SITE SURVEY AND TOPOGRAPHICAL INFORMATION BASED FROM A COMPILATION OF THE TOWN OF WAYLAND GIS, RECORD DRAWINGS AND ON THE GROUND SURVEYS PERFORMED BY WESTON & SAMPSON IN APRIL 2018.
- 2. CONTOURS AND ELEVATIONS SHOWN ON NAVD88 VERTICAL DATUM BASED ON GPS OBSERVATIONS.
- 3. NORTH ORIENTATION IS TRUE NORTH BASED ON GPS OBSERVATIONS TAKEN AT THE TIME OF THE FIELD SURVEY. MAPPING PREPARED ON NADV83 STATE PLANE COORDINATE SYSTEM-MASSACHUSETTS MAINLAND
- 4. FOR DETAILED NOTES REGARDING TEST PITS AND BORINGS, REFER TO MEMO TITLED "GEOTECH LETTER REPORT WAYLAND ATHLETIC FACILITIES" IN THE SPECIFICATIONS AND SEE SECTIONS RELATED TO LOKER.
- REFER TO GENERAL SYMBOLS FOR SURVEY LEGEND. ALL BIDDERS ARE REQUIRED TO INSPECT THE PROJECT SITE IN ITS ENTIRETY PRIOR TO SUBMITTING THEIR BID, AND BECOME FAMILIAR WITH ALL CONDITIONS AS THEY MAY AFFECT THEIR BID. CONTRACTOR AND SUB-CONTRACTOR SHALL BE FAMILIAR WITH ALL DRAWINGS AND SPECIFICATIONS PRIOR TO COMMENCING THE CONSTRUCTION.
- LOCATIONS OF ANY UTILITIES SHOWN ON THESE PLANS ARE APPROXIMATE ONLY. CONTRACTOR SHALL BE RESPONSIBLE FOR VERIFYING THE LOCATION OF SUCH UTILITIES, PROTECTING ALL EXISTING UTILITIES AND REPAIRING ANY DAMAGE DONE DURING CONSTRUCTION. THE CONTRACTOR SHALL BE RESPONSIBLE FOR ALL ON-SITE COORDINATION WITH UTILITY COMPANIES AND PUBLIC AGENCIES AND FOR OBTAINING ALL REQUIRED PERMITS AND PAYING ALL REQUIRED FEES. IN ACCORDANCE WITH M.G.L. CHAPTER 82, SECTION 40, INCLUDING AMENDMENTS, CONTRACTORS SHALL NOTIFY ALL UTILITY COMPANIES AND GOVERNMENT AGENCIES IN WRITING PRIOR TO EXCAVATION. CONTRACTOR SHALL ALSO CALL "DIG SAFE" AT (888) 344-7233 NO LESS THAN 72 HOURS, (EXCLUSIVE OF WEEKENDS AND HOLIDAYS), PRIOR TO SUCH EXCAVATION. DOCUMENTATION OF REQUESTS SHALL BE PROVIDED TO OWNER'S REPRESENTATIVE PRIOR TO EXCAVATION WORK.

DEMOLITION & SITE PREPARATION NOTES

1. THE CONTRACTOR SHALL INCLUDE IN THE BID THE COST OF REMOVING ANY

EXISTING SITE FEATURES AND APPURTENANCES NECESSARY TO ACCOMPLISH

THE CONSTRUCTION OF THE PROPOSED SITE IMPROVEMENTS. THE CONTRACTOR

SHALL ALSO INCLUDE IN THE BID THE COST NECESSARY TO RESTORE SUCH ITEMS

IF THEY ARE SCHEDULED TO REMAIN AS PART OF THE FINAL SITE IMPROVEMENTS.

REFER TO PLANS TO DETERMINE EXCAVATION AND DEMOLITION REQUIREMENTS

AND TO DETERMINE THE LOCATION OF THE PROPOSED SITE IMPROVEMENTS.

REMOVAL AND TO RETAIN OWNERSHIP OF SUCH MATERIALS. IF THE OWNER

MUNICIPAL PROPERTY AT NO ADDITIONAL COST. ALL GEOTECHNICALLY OR

UNSUITABLE UNCONTAMINATED EXCESS SOIL FROM CONSTRUCTION

REFER TO WAYLAND TOWN BY-LAW §198-504 EARTH MOVEMENT

3. UNLESS SPECIFICALLY NOTED TO BE REMOVED AND STOCKPILED (R&S) OR

THE OWNER RESERVES THE RIGHT TO REVIEW ALL MATERIALS DESIGNATED FOR

RETAINS ANY MATERIAL THE CONTRACTOR SHALL MAKE ARRANGEMENTS WITH

THE OWNER TO HAVE THOSE MATERIALS REMOVED OFF SITE TO A DESIGNATED

ACTIVITIES SHALL BE DISPOSED OF BY THE CONTRACTOR AT NO ADDITIONAL

COST TO THE TOWN. REMOVAL ACTIVITIES SHALL BE ACCORDANCE WITH

STATE AND LOCAL REGULATIONS AT NO ADDITIONAL COST TO THE TOWN

- 7. WHERE AN EXISTING UTILITY IS FOUND TO CONFLICT WITH THE PROPOSED WORK, THE LOCATION, ELEVATION AND SIZE OF THE UTILITY SHALL BE ACCURATELY DETERMINED WITHOUT DELAY BY THE CONTRACTOR AND THE 15. THE CONTRACTOR SHALL TAKE ALL NECESSARY PRECAUTIONS TO INFORMATION FURNISHED TO THE OWNER'S REPRESENTATIVE FOR RESOLUTION OF THE CONFLICT.
- 8. THE CONTRACTOR SHALL MAKE ALL ARRANGEMENTS FOR THE ALTERATION AND ADJUSTMENT OF GAS, ELECTRIC, TELEPHONE AND ANY OTHER PRIVATE UTILITIES BY THE UTILITY OWNER AT NO ADDITIONAL COST TO THE TOWN OF WAYLAND.
- 9. CONTRACTOR SHALL BE RESPONSIBLE FOR REVIEWING ALL DRAWINGS AND SPECIFICATIONS TO DETERMINE THE EXTENT OF EXCAVATION AND DEMOLITION REQUIRED TO RECEIVE SITE IMPROVEMENTS.
- 10. ANY DISCREPANCIES OR CONFLICTS BETWEEN THE DRAWINGS AND EXISTING CONDITIONS, EXISTING CONDITIONS TO REMAIN, TEMPORARY CONSTRUCTION, PERMANENT CONSTRUCTION AND WORK OF ADJACENT CONTRACTS SHALL BE BROUGHT TO THE ATTENTION OF THE OWNER'S REPRESENTATIVE BEFORE PROCEEDING. ITEMS ENCOUNTERED IN AREAS OF EXCAVATION THAT ARE NOT INDICATED ON THE DRAWINGS, BUT ARE VISIBLE ON SURFACE, SHALL BE THE CONTRACTOR'S RESPONSIBILITY AND SHALL BE REMOVED AT NO ADDITIONAL COST TO THE OWNER.
- 11. ANY ALTERATIONS TO THESE DRAWINGS MADE IN THE FIELD DURING CONSTRUCTION SHALL BE RECORDED BY THE GENERAL CONTRACTOR ON "AS BUILT" DRAWINGS.
- 12. ALL AREAS DISTURBED BY THE CONTRACTOR'S OPERATIONS OUTSIDE THE PROJECT LIMITS, SHALL BE RESTORED TO THE ORIGINAL CONDITION BY THE CONTRACTOR AT NO ADDITIONAL COST AND TO THE SATISFACTION OF THE OWNER.
- 13. ALL WORK SHOWN ON THE PLANS AS BOLD SHALL REPRESENT PROPOSED WORK. THE TERM "PROPOSED (PROP)" INDICATES WORK TO BE CONSTRUCTED USING NEW MATERIALS OR, WHERE APPLICABLE, RE-USING EXISTING MATERIALS IDENTIFIED AS "REMOVE AND RESET (R&R)" OR "REMOVE AND SALVAGE (R&S).
- 14. ALL KNOWN EXISTING STATE, COUNTY AND TOWN LOCATION LINES AND

- PRIVATE PROPERTY LINES HAVE BEEN ESTABLISHED FROM AVAILABLE INFORMATION AND ARE INDICATED ON THE PLANS.
- PROTECT HIS EMPLOYEES, AS WELL AS PUBLIC USERS FROM INJURY DURING THE ENTIRE CONSTRUCTION PERIOD USING ALL NECESSARY SAFEGUARDS, INCLUDING BUT NOT LIMITED TO, THE ERECTION OF TEMPORARY WALKS, STRUCTURES, PROTECTIVE BARRIERS, COVERING, OR FENCES AS NEEDED.
- 16. THE CONTRACTOR SHALL SUPPLY THE OWNER WITH THE NAME OF THE OSHA "COMPETENT PERSON" PRIOR TO CONSTRUCTION.
- 17. FILLING OF EXCAVATED AREAS SHALL NOT TAKE PLACE WITHOUT THE PRESENCE OR PERMISSION OF THE OWNER.
- 18. EXISTING TREES TO REMAIN SHALL BE PROTECTED FROM CONSTRUCTION ACTIVITIES. NO STOCKPILING OF MATERIAL, EQUIPMENT OR VEHICULAR TRAFFIC SHALL BE ALLOWED WITHIN THE DRIP LINE OF TREES TO REMAIN. NO GUYS SHALL BE ATTACHED TO ANY TREE TO REMAIN. WHEN NECESSARY OR AS DIRECTED BY THE OWNER'S REPRESENTATIVE, THE CONTRACTOR SHALL ERECT TEMPORARY BARRIERS FOR THE PROTECTION OF EXISTING TREES DURING CONSTRUCTION.
- 19. TREES AND SHRUBS WITHIN THE LIMITS OF WORK SHALL BE REMOVED ONLY UPON THE APPROVAL OF THE OWNER'S REPRESENTATIVE OR AS NOTED ON THE PLANS.
- 20. NO FILLING SHALL OCCUR AROUND EXISTING TREES TO REMAIN WITHOUT THE APPROVAL OF THE OWNER OR OWNER REPRESENTATIVE.
- 21. THE CONTRACTOR SHALL REMOVE ALL SURFACE VEGETATION PRIOR TO GRADING THE SITE. TREES AND STUMPS SHALL BE REMOVED AND DISPOSED COMPLETE BY CONTRACTOR. TEMPORARY EROSION CONTROL MEASURES SHOWN ON THE DRAWINGS (INCLUDING SILT FENCE, STRAW WATTLES, OR SILT SOCKS) SHALL BE INSTALLED BY THE CONTRACTOR. THE CONTRACTOR SHALL BE RESPONSIBLE FOR MAINTAINING THESE TEMPORARY EROSION CONTROL MEASURES THROUGHOUT THE PROJECT WHICH COST SHALL BE INCIDENTAL TO THE PROJECT.
- 22. ALL UNSUITABLE UNCONTAMINATED EXCESS SOIL FROM CONSTRUCTION

- ACTIVITIES SHALL BE DISPOSED OF BY THE CONTRACTOR AT NO ADDITIONAL COST TO THE TOWN. REMOVAL ACTIVITIES SHALL BE ACCORDANCE WITH STATE AND LOCAL REGULATIONS AT NO ADDITIONAL COST TO THE TOWN. REFER TO WAYLAND TOWN BY-LAW §198-504 EARTH MOVEMENT. SUITABLE SOIL EXCAVATION AS PART OF THE PROJECT MUST MEET ONE OR MORE OF THE MATERIAL REQUIREMENTS SPECIFIED IN 31 00 00-EARTHWORK. IF THE CONTRACTOR PROPOSES TO USE THE EXISTING FILL ON SITE BELOW PAVEMENT AREAS, HE MUST DEMONSTRATE THAT THE FILL MEETS THE REQUIREMENTS PER THE SPECIFICATIONS. ALL EXCAVATED FILL MATERIAL WHICH DOES NOT MEET THE REQUIREMENTS OF THE CONTRACT DOCUMENTS SHALL BE REMOVED AND DISPOSED OF OFF-SITE AT NO ADDITIONAL COST.
- 23. CONTRACTOR IS RESPONSIBLE FOR STAKING CONSTRUCTION BASELINES IN FIELD WITH A MA. REGISTERED PROFESSIONAL LAND SURVEYOR. NO CONSTRUCTION WILL BE PERFORMED WITHOUT THE PROPOSED BASELINES AND LAYOUTS APPROVED BY THE ENGINEER.
- 24. NO FILL SHALL CONTAIN HAZARDOUS MATERIALS.
- 25. CONTRACTOR SHALL PROVIDE TEMPORARY CONSTRUCTION FENCING AROUND PERIMETER OF WORK AREA (LIMIT OF WORK). FENCE SHALL NOT IMPEDE TRAVEL WAYS.
- 26. ANY QUANTITIES SHOWN ON PLANS ARE FOR COMPARATIVE BIDDING PURPOSES ONLY. IT IS THE CONTRACTOR'S RESPONSIBILITY TO VISIT THE PROJECT SITE TO VERIFY ALL QUANTITIES AND CONDITIONS PRIOR TO SUBMITTING BID.
- 27. ALL EXISTING DRAINAGE FACILITIES TO REMAIN SHALL BE MAINTAINED FREE OF DEBRIS, SOIL, SEDIMENT, AND FOREIGN MATERIAL AND OPERATIONAL THROUGHOUT THE LIFE OF THE CONTRACT. REMOVE ALL SOIL, SEDIMENT, DEBRIS AND FOREIGN MATERIAL FROM ALL DRAINAGE STRUCTURES, INCLUDING BUT NOT LIMITED TO, DRAINAGE INLETS, MANHOLES AND CATCH BASINS WITHIN THE LIMIT OF WORK AND DRAINAGE STRUCTURES OUTSIDE THE LIMIT OF WORK THAT ARE IMPACTED BY THE WORK FOR THE ENTIRE DURATION OF CONSTRUCTION.
- 28. CONTRACTOR'S STAGING AREA MUST BE WITHIN THE CONTRACT LIMIT LINE AND IN AREAS APPROVED BY OWNER. ANY OTHER AREAS THAT THE CONTRACTOR MAY WISH TO USE FOR STAGING MUST BE COORDINATED

WITH THE OWNER.

- 29. THE CONTRACTOR SHALL KEEP ALL STREETS, PARKING LOTS AND WALKS THAT ARE NOT RESTRICTED FROM PUBLIC USE DURING CONSTRUCTION BROOM CLEAN AT ALL TIMES. THE CONTRACTOR SHALL USE ACCEPTABLE METHODS AND MATERIALS TO MAINTAIN ADEQUATE DUST CONTROL THROUGHOUT CONSTRUCTION.
- 30. CONTRACTOR SHALL COORDINATE ALL WORK WITH THE OWNER.
- 31. THE LIMIT OF WORK SHALL BE DELINEATED IN THE FIELD PRIOR TO THE START OF SITE CLEARING OR CONSTRUCTION AND AGREED UPON WITH THE OWNER'S REPRESENTATIVE.
- 32. DEEP SUMP CATCH BASINS AND STORMWATER BASINS SHALL BE CLEANED FOLLOWING CONSTRUCTION AND SHALL FOLLOW THE OPERATION AND MAINTENANCE PLAN THEREAFTER.
- 33. HAULING OF EARTH MATERIALS TO AND FROM THE SITE SHALL BE RESTRICTED TO THE HOURS OF 7 AM TO 5 PM.
- 34. ANY BOULDERS 3 CY OR SMALLER SHALL BE CONSIDERED UNDOCUMENTED FILL AND SHALL BE DISPOSED OF AT NO ADDITIONAL COST TO THE TOWN.
- 35. WORK ON WEEKENDS SHALL ONLY BE CONDUCTED IF PRIOR WRITTEN PERMISSION IS PROVIDED BY THE TOWN.
- 36. NO TRUCKS LEFT IDLING ON TOWN STREETS DURING CONSTRUCTION. CONSTRUCTION TRAFFIC AT NO TIME SHALL IMPEDE FLOW OF RESIDENT TRAFFIC.

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WAYLAND, MA 01778

IMPROVEMENTS TO

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GENERAL NOTES

Sheet Number:

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EROSION AND SEDIMENT CONTROL NOTES

- 1. ALL SEDIMENT AND EROSION CONTROL DEVICES SHALL BE PUT INTO PLACE PRIOR TO BEGINNING ANY CONSTRUCTION OR DEMOLITION. REFER TO PLANS FOR APPROXIMATE LOCATION OF EROSION AND SEDIMENT CONTROL. REFER TO
- 2. THE CONTRACTOR SHALL BE RESPONSIBLE FOR THE CONTINUAL MAINTENANCE
- CONTRACTOR SHALL MEET ALL OF THE STATE OF MASSACHUSETTS AND THE TOWN OF WAYLAND WETLAND ORDINANCE REGULATIONS FOR SEDIMENT AND **EROSION CONTROL.**
- EXCAVATED MATERIAL STOCKPILED ON THE SITE SHALL BE SURROUNDED BY A RING OF UNBROKEN SEDIMENT AND EROSION CONTROL FENCE. THE LIMITS OF ALL GRADING AND DISTURBANCE SHALL BE KEPT TO A MINIMUM WITHIN THE APPROVED AREA OF CONSTRUCTION. ALL AREAS OUTSIDE OF THE LIMIT OF CONTRACT SHALL REMAIN TOTALLY UNDISTURBED UNLESS OTHERWISE
- 5. ALL CATCH BASINS AND DRAIN GRATES WITHIN THE LIMIT OF WORK SHALL BE PROTECTED WITH SILT SACKS DURING THE ENTIRE DURATION OF
- EROSION CONTROL BARRIERS TO BE INSTALLED AT THE TOE OF SLOPES. SEE GRADING & DRAINAGE PLANS, NOTES, DETAILS AND SPECIFICATIONS.
- OPERATIONS AS APPROVED BY THE OWNER'S REPRESENTATIVE AND MASSACHUSETTS D.E.P. REQUIREMENTS.
- PREVENT TRACKING OR FLOWING OF SEDIMENT ON TO PUBLIC/PRIVATE ROADS.
- 10. CONTRACTOR SHALL BE RESPONSIBLE FOR WHEEL CLEANING OF ALL CONSTRUCTION VEHICLES PRIOR TO EXITING THE SITE. CONTRACTOR SHALL

LAYOUT NOTES

- 1. COORDINATE ALL LAYOUT ACTIVITIES WITH THE SCOPE OF WORK CALLED FOR BY DEMOLITION, GRADING AND UTILITIES OPERATIONS ENCOMPASSED BY THIS CONTRACT. SET, PROTECT AND REPLACE REFERENCE STAKES AS NECESSARY OR AS REQUIRED BY THE OWNER'S REPRESENTATIVE.
- 2. ALL WORK SHALL BE PERFORMED BY CONTRACTOR UNLESS SPECIFICALLY INDICATED THAT THE WORK WILL BE PERFORMED "BY OWNER".
- 3. THE LAYOUT OF SITE AMENITIES AND FENCES MUST BE APPROVED BY THE OWNER'S REPRESENTATIVE PRIOR TO INSTALLATION.
- 4. ALL PROPOSED SITE FEATURES SHALL BE LAID OUT AND STAKED FOR REVIEW AND APPROVAL BY THE OWNER'S REPRESENTATIVE PRIOR TO COMMENCEMENT OF INSTALLATION. ANY REQUIRED ADJUSTMENTS TO THE LAYOUT SHALL BE UNDERTAKEN AS DIRECTED, AT NO ADDITIONAL COST TO THE OWNER.
- 5. ALL PROPOSED PAVEMENTS SHALL MEET THE LINE AND GRADE OF EXISTING ADJACENT PAVEMENT SURFACES AND SHALL BE TREATED WITH AN RS-1 TACK COAT AT POINT OF CONNECTION. ALL PATHWAY WIDTHS SHALL BE AS NOTED ON THE LAYOUT AND MATERIALS PLAN.
- 6. THE CONTRACTOR SHALL VERIFY ALL DIMENSIONS AND GRADES ON THE GROUND AND REPORT ANY DISCREPANCIES IMMEDIATELY TO THE OWNER.
- 7. THE CONTRACTOR SHALL BE RESPONSIBLE FOR FIELD MEASUREMENTS OF ALL PROPOSED FENCES, GATES.

GRADING & DRAINAGE NOTES

- 1. ALL WORK RELATING TO INSTALLATION, RENOVATION OR MODIFICATION OF DRAINAGE SERVICES SHALL BE PERFORMED IN ACCORDANCE WITH THE STANDARDS OF THE TOWN OF WAYLAND AND ITS DEPARTMENT OF PUBLIC WORKS.
- 2. THE CONTRACTOR SHALL VERIFY ALL DIMENSIONS, GRADES AND INVERT ELEVATIONS IN THE FIELD AND REPORT ANY DISCREPANCIES IMMEDIATELY TO THE OWNER AND OWNER'S REPRESENTATIVE.
- 3. ALL NEW WALKWAYS MUST CONFORM TO CURRENT AMERICANS WITH DISABILITIES ACT (ADA) REGULATIONS: WALKWAYS SHALL MAINTAIN A CROSS PITCH OF NOT MORE THAN ONE AND A HALF (1.5%) PERCENT MAXIMUM AND THE RUNNING SLOPE (PARALLEL TO THE DIRECTION OF TRAVEL) OF 4.5% MAXIMUM.
- 4. MINIMUM SLOPE ON ALL WALKWAYS WILL BE 1:100 OR 1% TO PROVIDE POSITIVE DRAINAGE. ANY DISCREPANCIES NOT ALLOWING THIS TO OCCUR SHALL BE REPORTED TO THE OWNER'S REPRESENTATIVE PRIOR TO CONTINUING WORK.
- 5. ALL UTILITY GRATES, COVERS OR OTHER SURFACE ELEMENTS INTENDED TO BE EXPOSED AT GRADE SHALL BE FLUSH WITH THE ADJACENT FINISHED GRADE AND ADJUSTED TO PROVIDE A SMOOTH TRANSITION AT ALL EDGES.
- 6. THE CONTRACTOR SHALL SET SUBGRADE ELEVATIONS TO ALLOW FOR POSITIVE DRAINAGE AND PROVIDE EROSION CONTROL DEVICES, STRUCTURES, MATERIALS AND CONSTRUCTION METHODS TO DIRECT SILT MIGRATION AWAY FROM DRAINAGE AND OTHER UTILITY SYSTEMS, PUBLIC/ PRIVATE STREETS AND WORK AREAS. CLEAN BASINS REGUAL; RLY AND AT THE END OF THE PROJECT.
- 7. CONTRACTOR SHALL ENSURE ALL AREAS ARE PROPERLY PITCHED TO DRAIN, WITH NO SURFACE WATER PONDING OR PUDDLING.
- 8. EXCAVATION REQUIRED WITHIN PROXIMITY OF KNOWN EXISTING UTILITY LINES SHALL BE DONE BY HAND. CONTRACTOR SHALL REPAIR ANY DAMAGE TO EXISTING UTILITY LINES OR STRUCTURES INCURRED DURING CONSTRUCTION OPERATIONS AT NO COST TO THE OWNER.
- 9. WHERE NEW EARTHWORK MEETS EXISTING EARTHWORK, CONTRACTOR SHALL BLEND NEW EARTHWORK SMOOTHLY INTO EXISTING, PROVIDING VERTICAL CURVES OR POUNDS AT ALL TOP AND BOTTOM OF SLOPES.
- 10. WHERE A SPECIFIC LIMIT OF WORK LINE IS NOT OBVIOUS OR IMPLIED, BLEND GRADES TO EXISTING CONDITIONS WITHIN 5 FEET OF PROPOSED CONTOURS.
- 11. RESTORE ALL DISTURBED AREAS AND LIMITS OF ALL REMOVALS TO LOAM AND CONSERVATION SEED MIX UNLESS OTHERWISE NOTED.
- 12. WHERE NEW IMPROVEMENTS MEET EXISTING CONDITIONS, MEET LINE AND GRADE OF EXISTING ADJACENT PAVEMENTS, TYPICAL

REUSED AND RELOCATED (R&R), ALL SITE FEATURES CALLED TO BE REMOVED AND DEMOLISHED (R&D) SHALL BE REMOVED WITH THEIR FOOTINGS, ATTACHMENTS, BASE MATERIAL, ETC. TRANSPORTED FROM THE SITE TO BE DISPOSED OF IN A LAWFUL MANNER AT AN ACCEPTABLE DISPOSAL SITE AND AT NO ADDITIONAL COST TO THE OWNER. 4. ALL EXISTING SITE FEATURES TO REMAIN SHALL BE PROTECTED THROUGHOUT

- THE CONSTRUCTION PERIOD. ANY FEATURES DAMAGED DURING CONSTRUCTION OPERATIONS SHALL BE REPAIRED OR REPLACED TO THE SATISFACTION OF THE OWNER AND/OR OWNER'S REPRESENTATIVE AT NO ADDITIONAL COST. DURING EARTHWORK OPERATIONS, CONTRACTOR SHALL TAKE CARE TO NOT DISTURB EXISTING MATERIALS TO REMAIN, OUTSIDE THE LIMITS OF EXCAVATION
- AND BACKFILL AND SHALL TAKE WHATEVER MEASURES NECESSARY, AT THE CONTRACTOR'S EXPENSE, TO PREVENT ANY EXCAVATED MATERIAL FROM COLLAPSING. ALL BACKFILL MATERIALS SHALL BE PLACED AND COMPACTED AS SPECIFIED TO THE SUBGRADE REQUIRED FOR THE INSTALLATION OF THE REMAINDER OF THE CONTRACT WORK.
- IT SHALL BE THE CONTRACTOR'S OPTION, WITH CONCURRENCE OF THE OWNER'S REPRESENTATIVE, TO REUSE EXISTING BITUMINOUS CONCRETE PAVEMENT BASE COURSE AND/ OR SUBBASE GRAVEL MATERIALS IF IT MEETS THE REQUIREMENTS OF THE SPECIFICATIONS FOR DENSE GRADED CRUSHED STONE.

STRIP & STOCKPILE EXISTING TOPSOIL FOR LATER REUSE AS REQUIRED.

- STOCKPILE SHALL HAVE APPROPRIATE EROSION AND SEDIMENT CONTROLS. THE CONTRACTOR SHALL CONFIRM THAT THE TOPSOIL IS SUITABLE FOR REUSE AND IT MEETS THE REQUIREMENTS OF THE SPECIFICATIONS FOR TOPSOIL LOAM BORROW.
- CLEAR AND GRUB VEGETATION SHALL INCLUDE REMOVAL OF ALL GRASS/LAWN, SHRUBS, AND UNDERBRUSH, REMOVAL OF ROOTS, AND ROUGH GRADING. INSTALLATION OF LOAM (IF APPLICABLE), FINE GRADING, SEEDING AND TURF OR VEGETATION ESTABLISHMENT BY THE CONTRACTOR.
- 9. THE CONTRACTOR SHALL PROTECT EXISTING TREES TO REMAIN. CONTRACTOR SHALL INSTALL TREE PROTECTION BARRIERS AFTER CLEARING TURF AND UNDERBRUSH BY HAND AND TAKE DUE CARE TO PREVENT INJURY TO TREES DURING CLEARING OPERATIONS.


10. THE STORAGE OF MATERIALS AND EQUIPMENT WILL BE PERMITTED AT LOCATIONS


MATERIALS AND EQUIPMENT SHALL BE THE SOLE RESPONSIBILITY OF THE

CONTRACTOR.

DESIGNATED BY OWNER OR OWNER'S REPRESENTATIVE. PROTECTION OF STORED

- SPECS AND DETAILS FOR TYPE OF EROSION AND SEDIMENT CONTROL.
- OF ALL CONTROL DEVICES THROUGHOUT THE DURATION OF THE PROJECT.
- APPROVED BY OWNER'S REPRESENTATIVE
- CONSTRUCTION.
- 7. THE CONTRACTOR SHALL PROVIDE DUST CONTROL FOR CONSTRUCTION
- 8. ALL POINTS OF CONSTRUCTION EGRESS OR INGRESS SHALL BE MAINTAINED TO
- 9. ALL MATERIAL HAULING VEHICLES SHALL BE COMPLETELY COVERED PRIOR TO LEAVING THE SITE.
- ENSURE THAT MATERIAL HAULING VEHICLES REMAIN ON PAVED SURFACES AS MUCH AS POSSIBLE

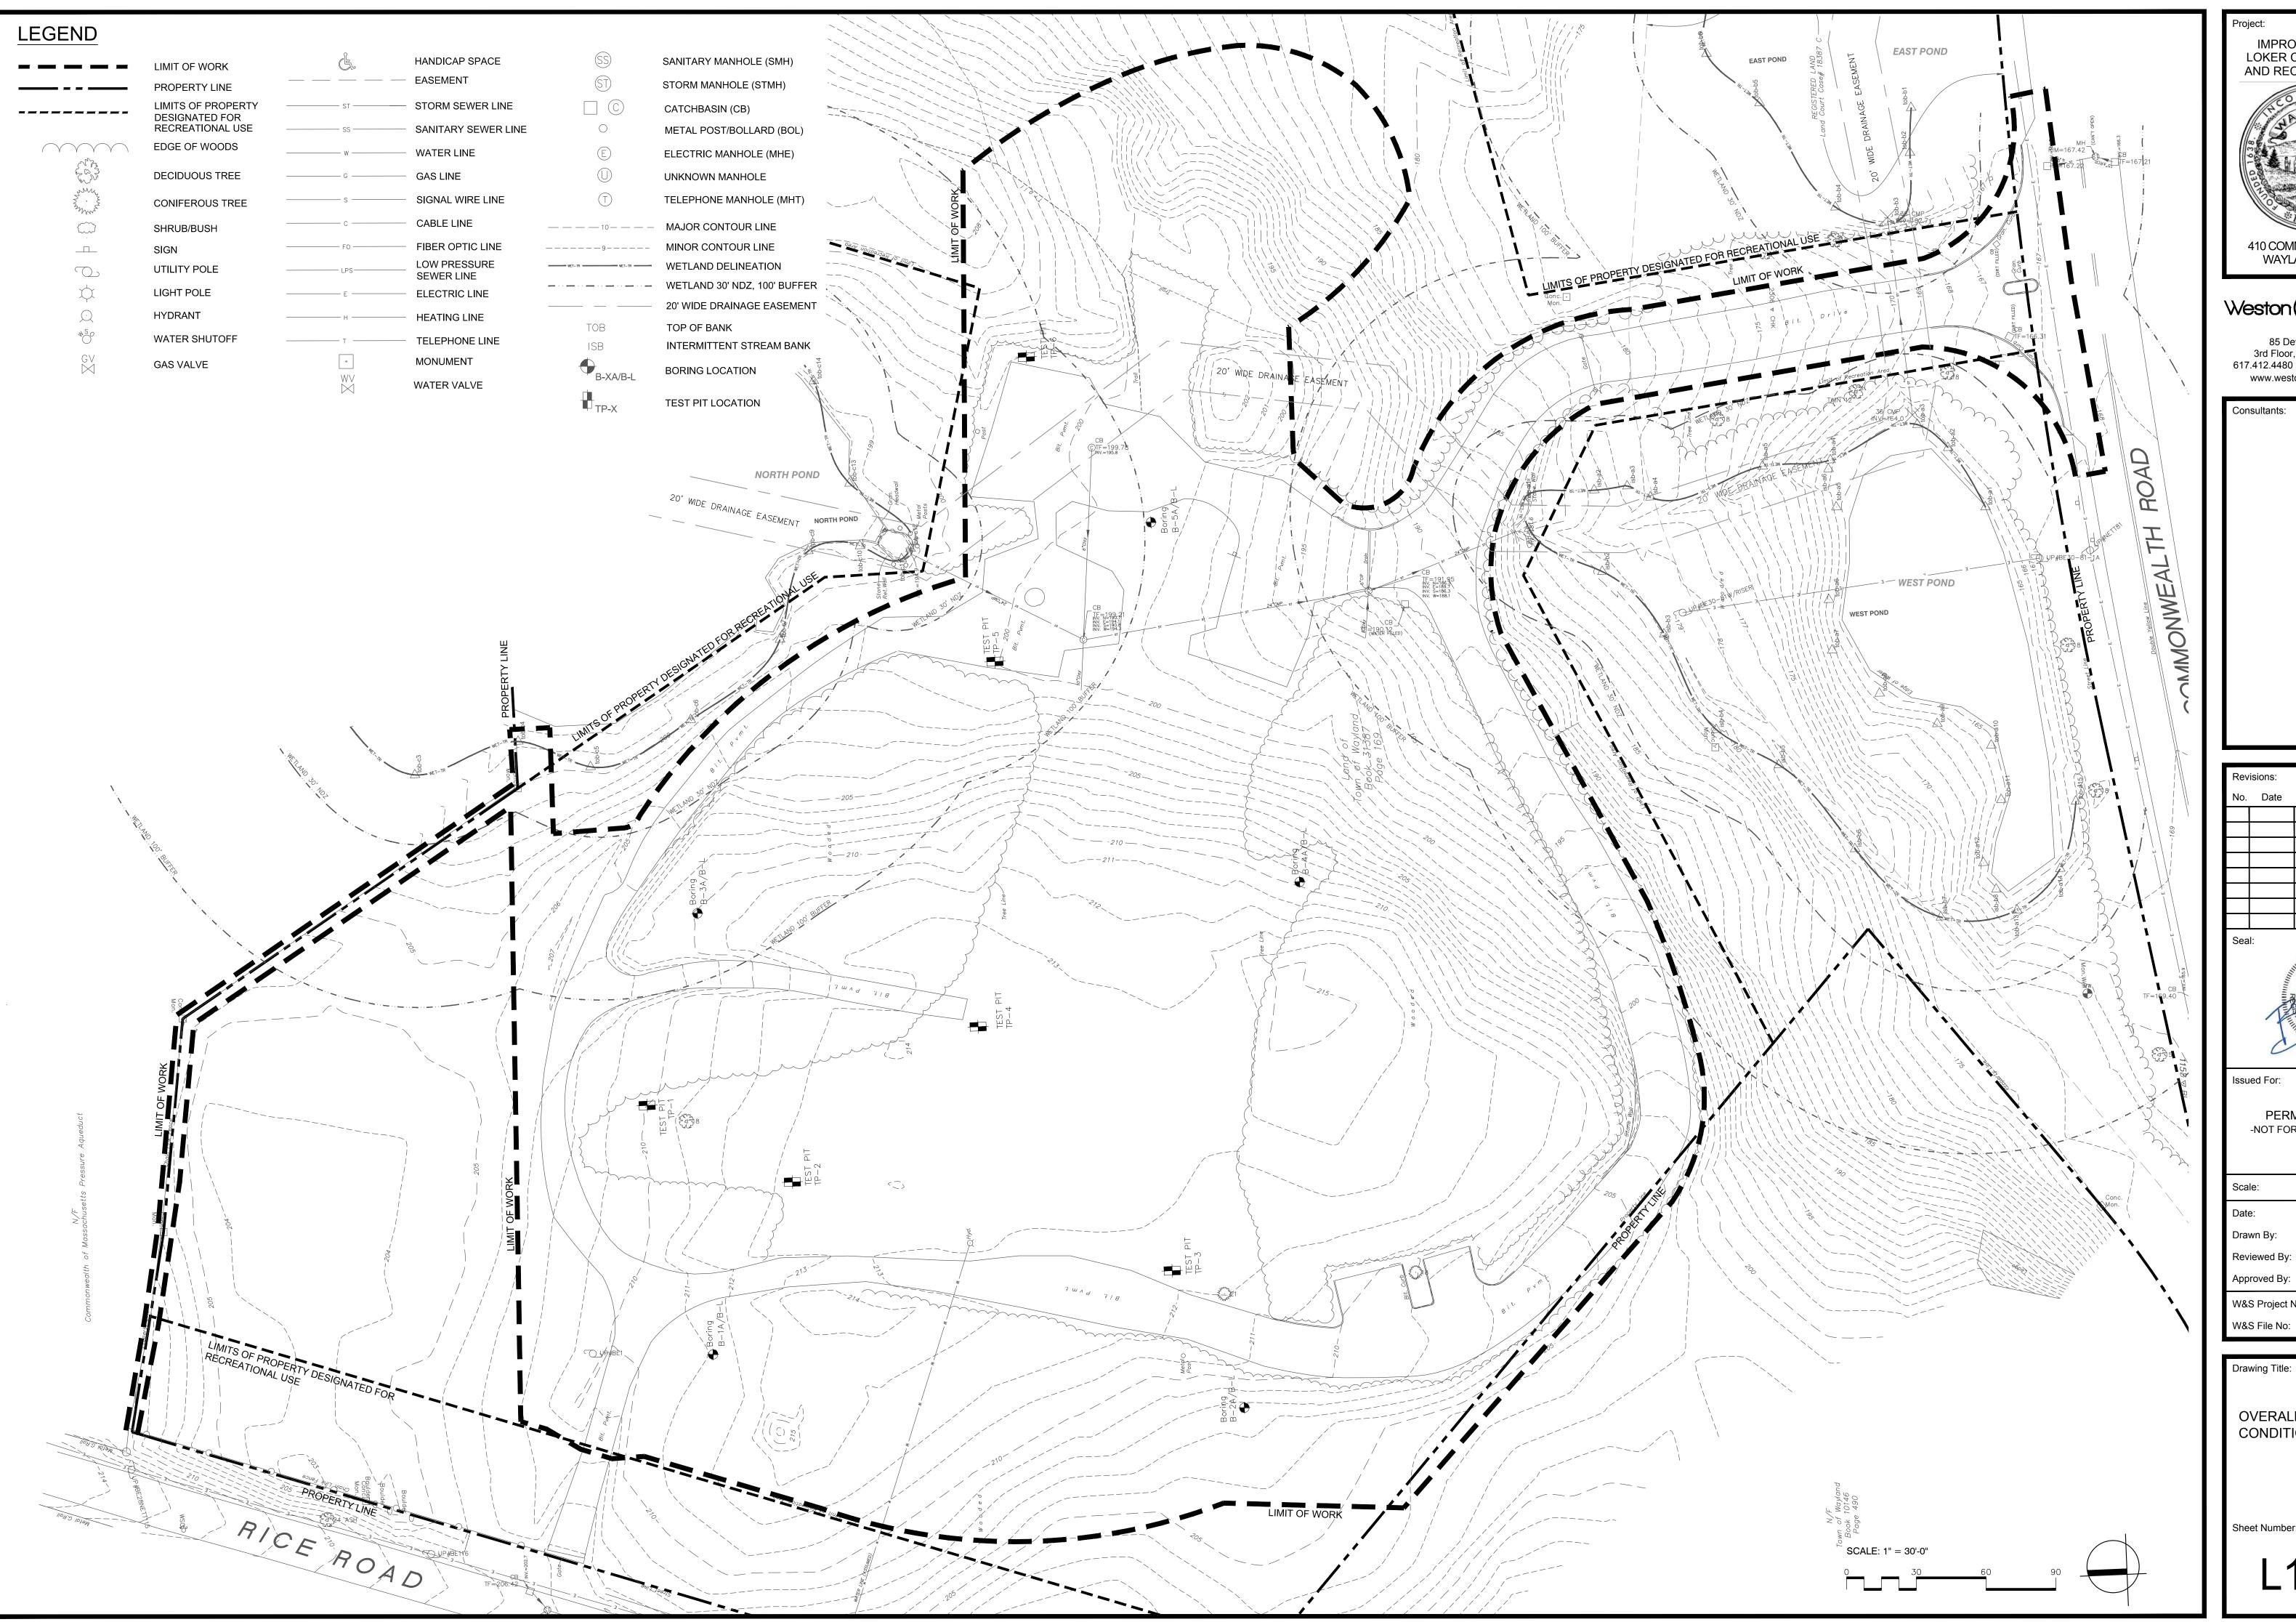

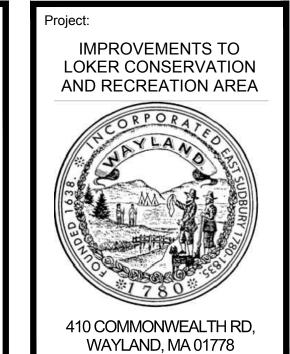


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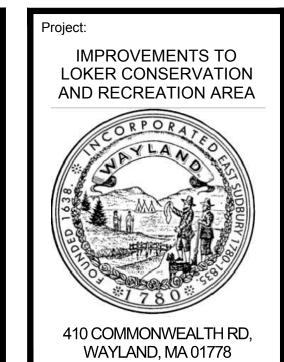
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OVERALL EXISTING CONDITIONS PLAN

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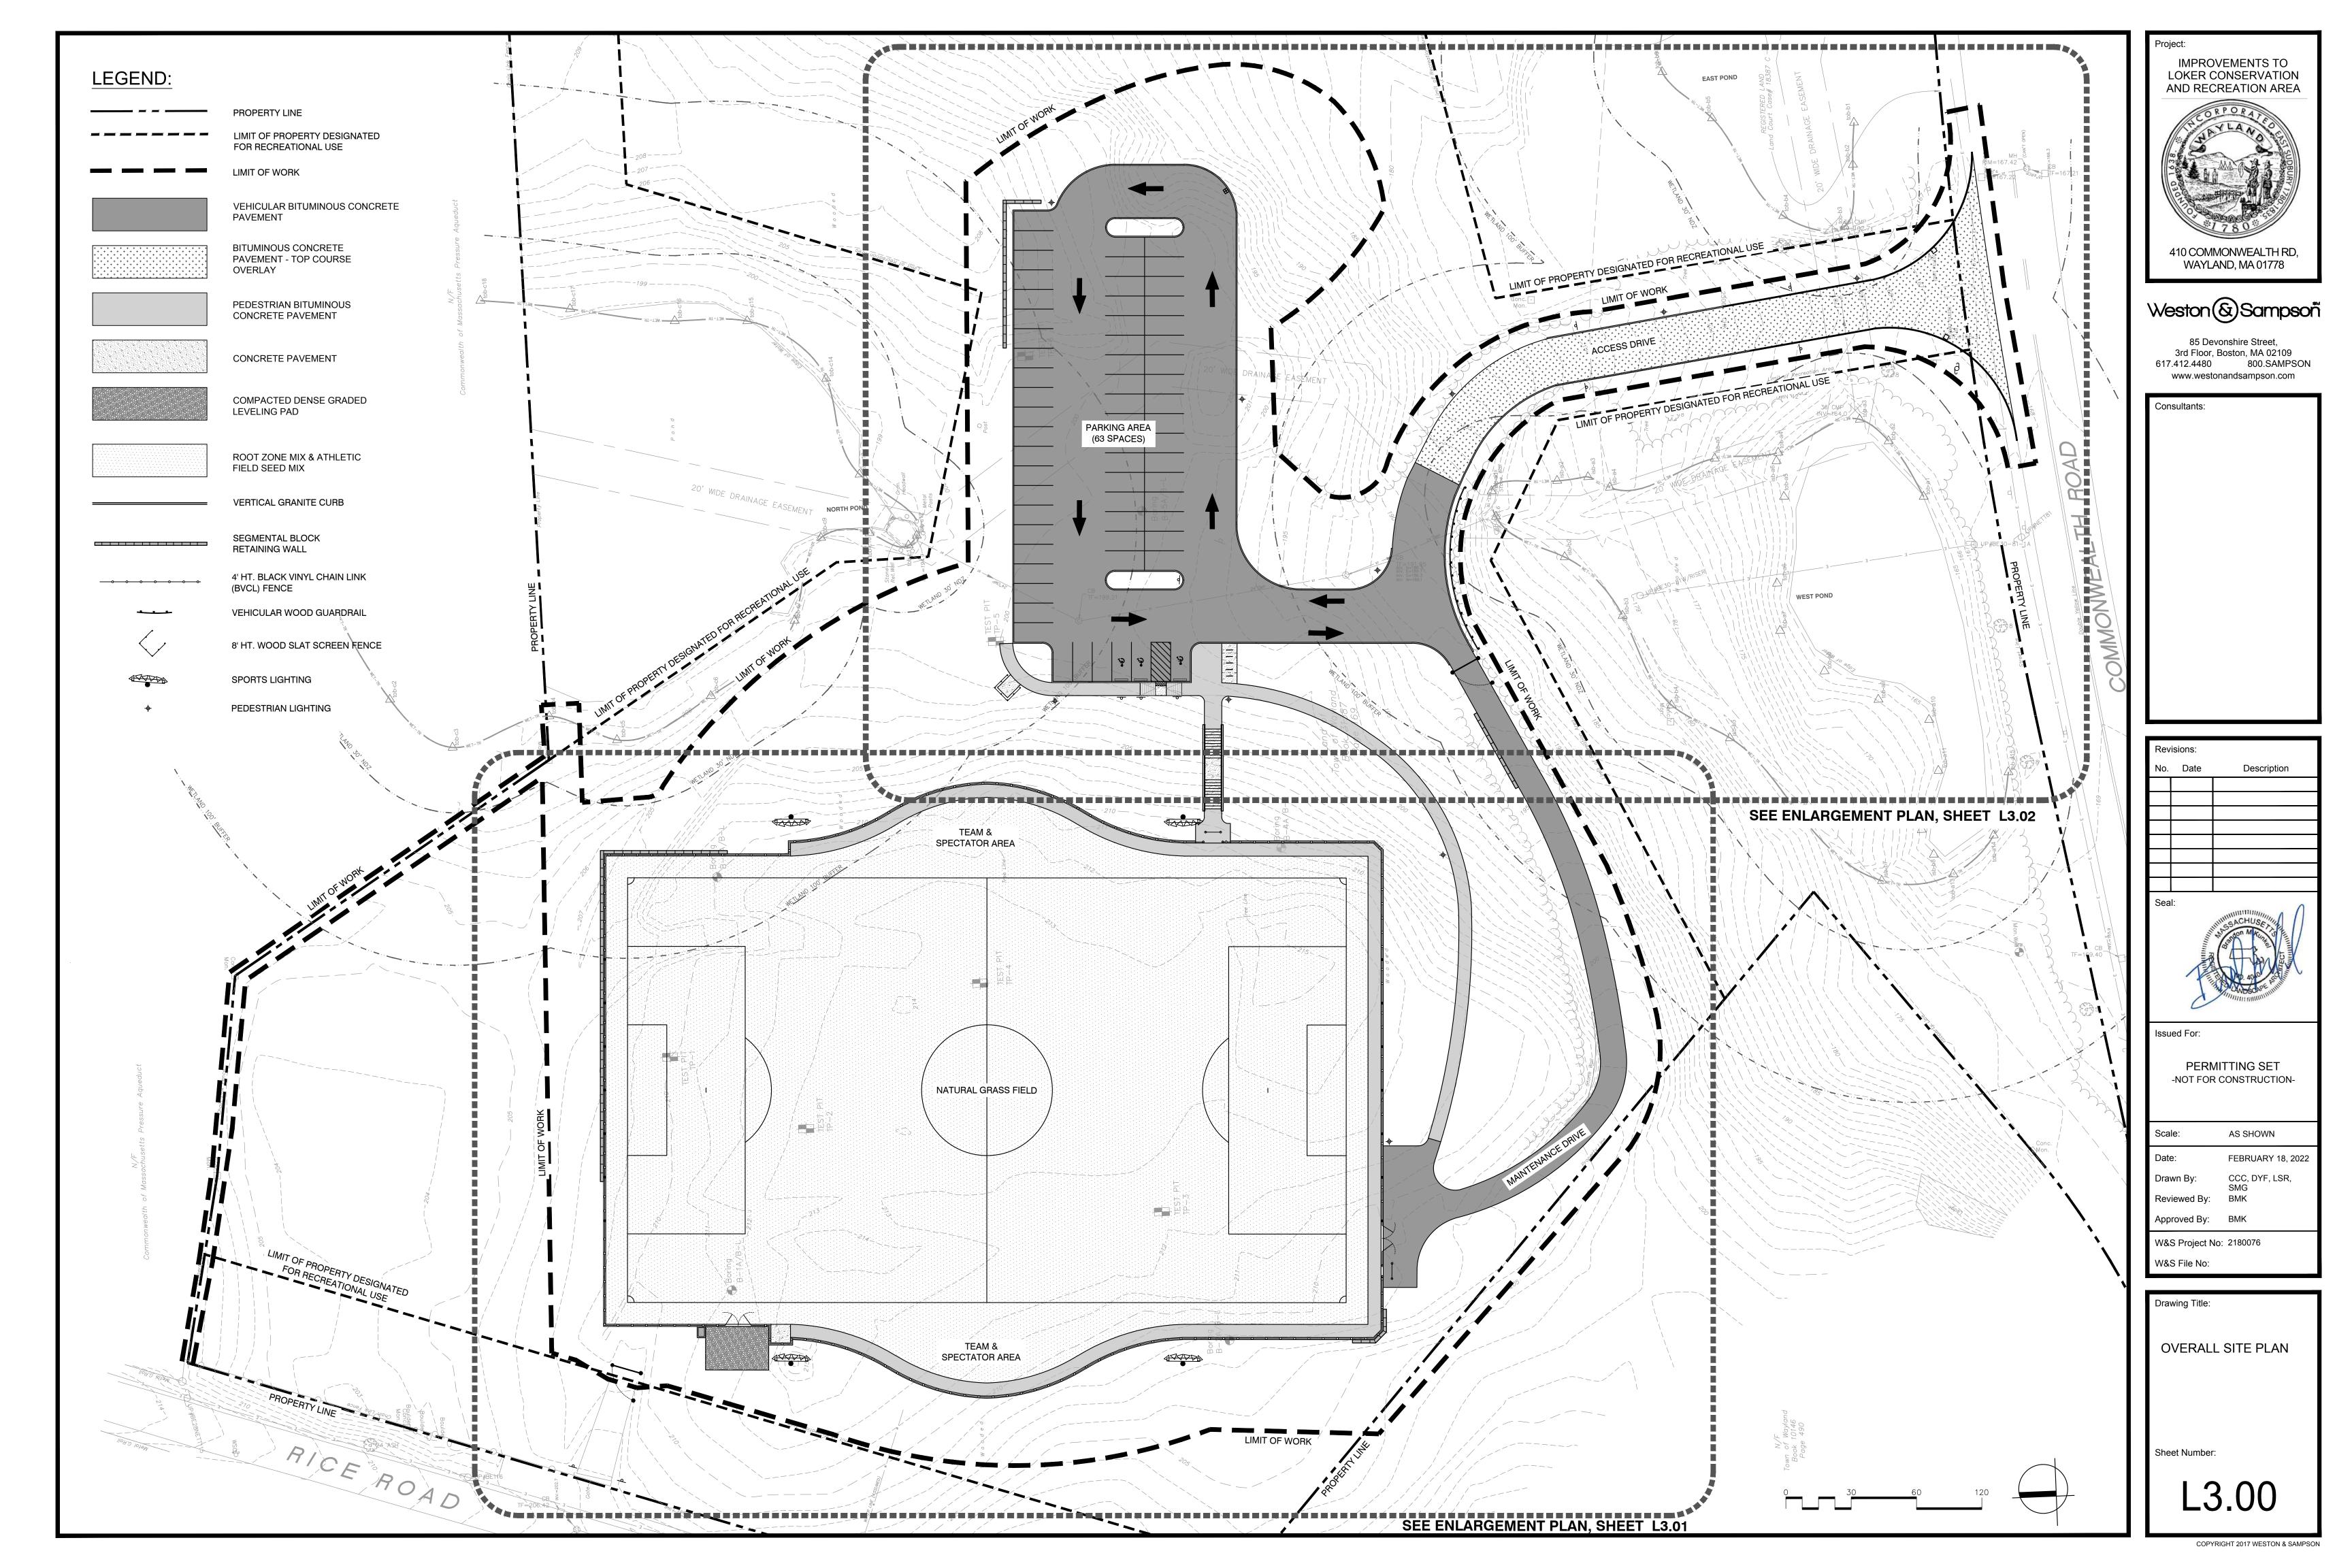
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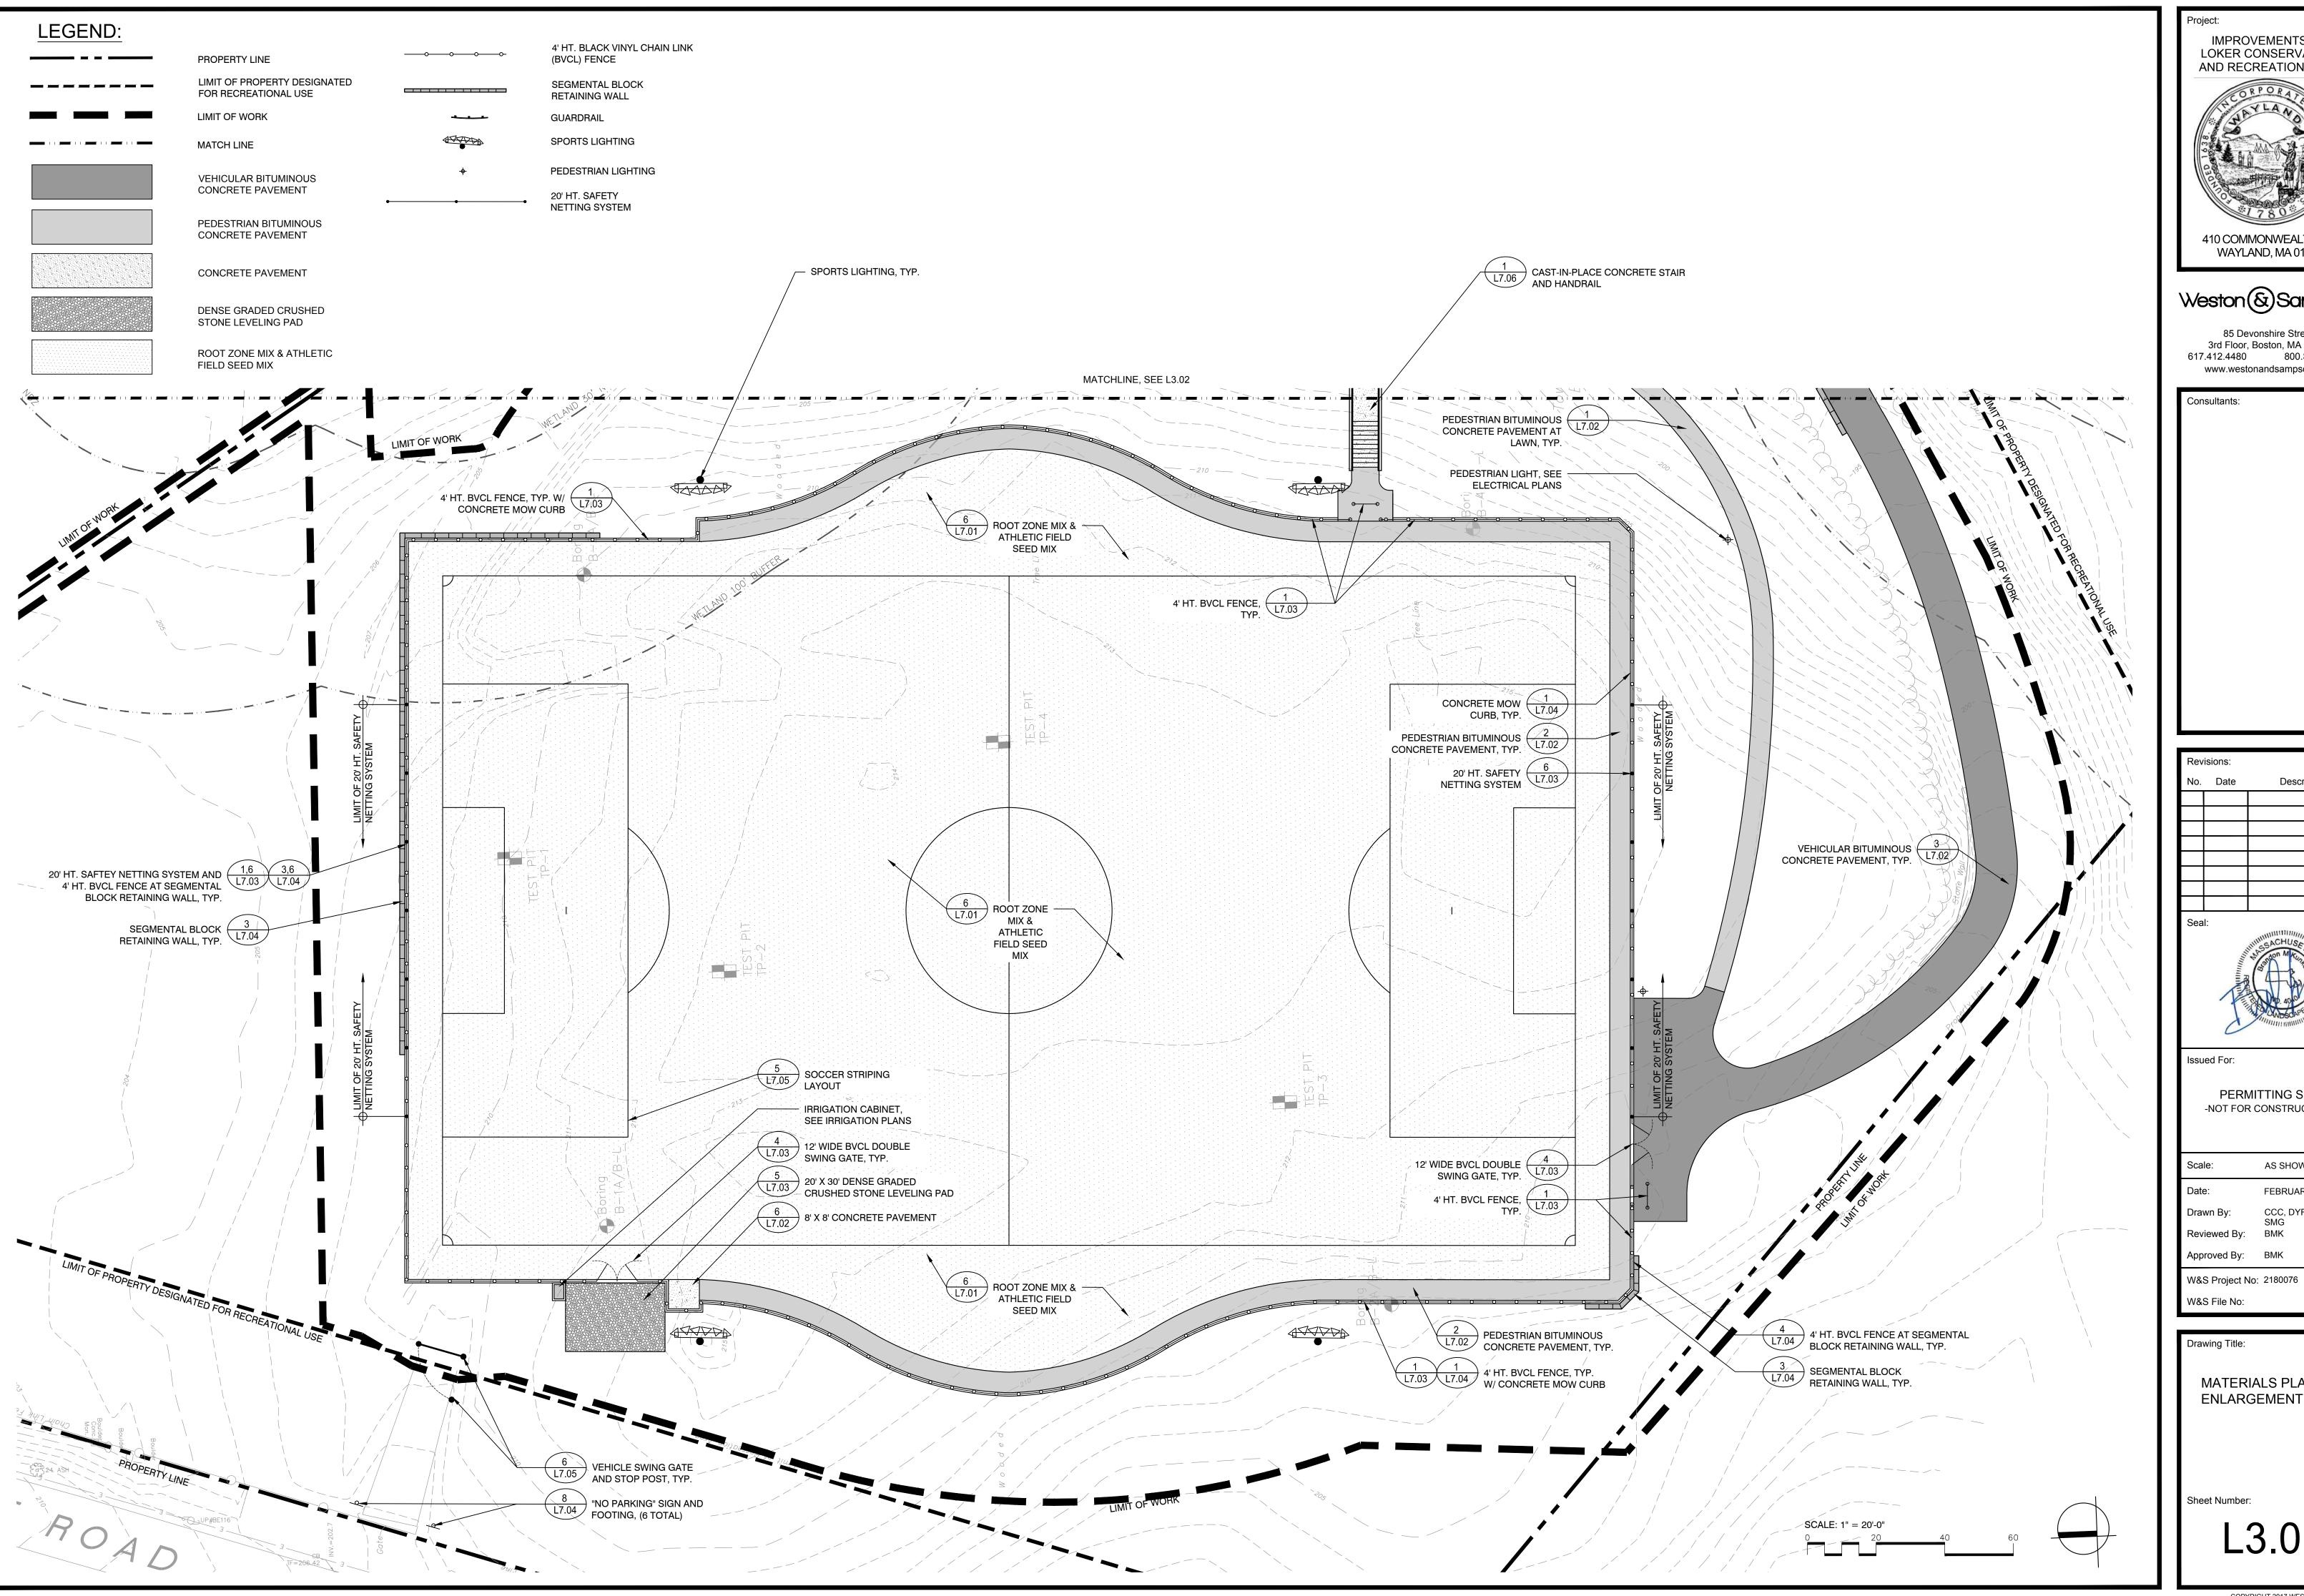
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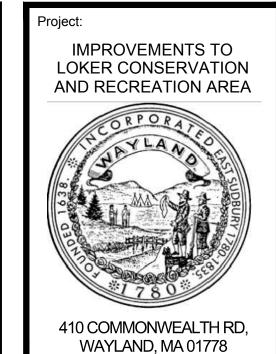
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OVERALL SITE PREPARATION AND DEMOLITION PLANS

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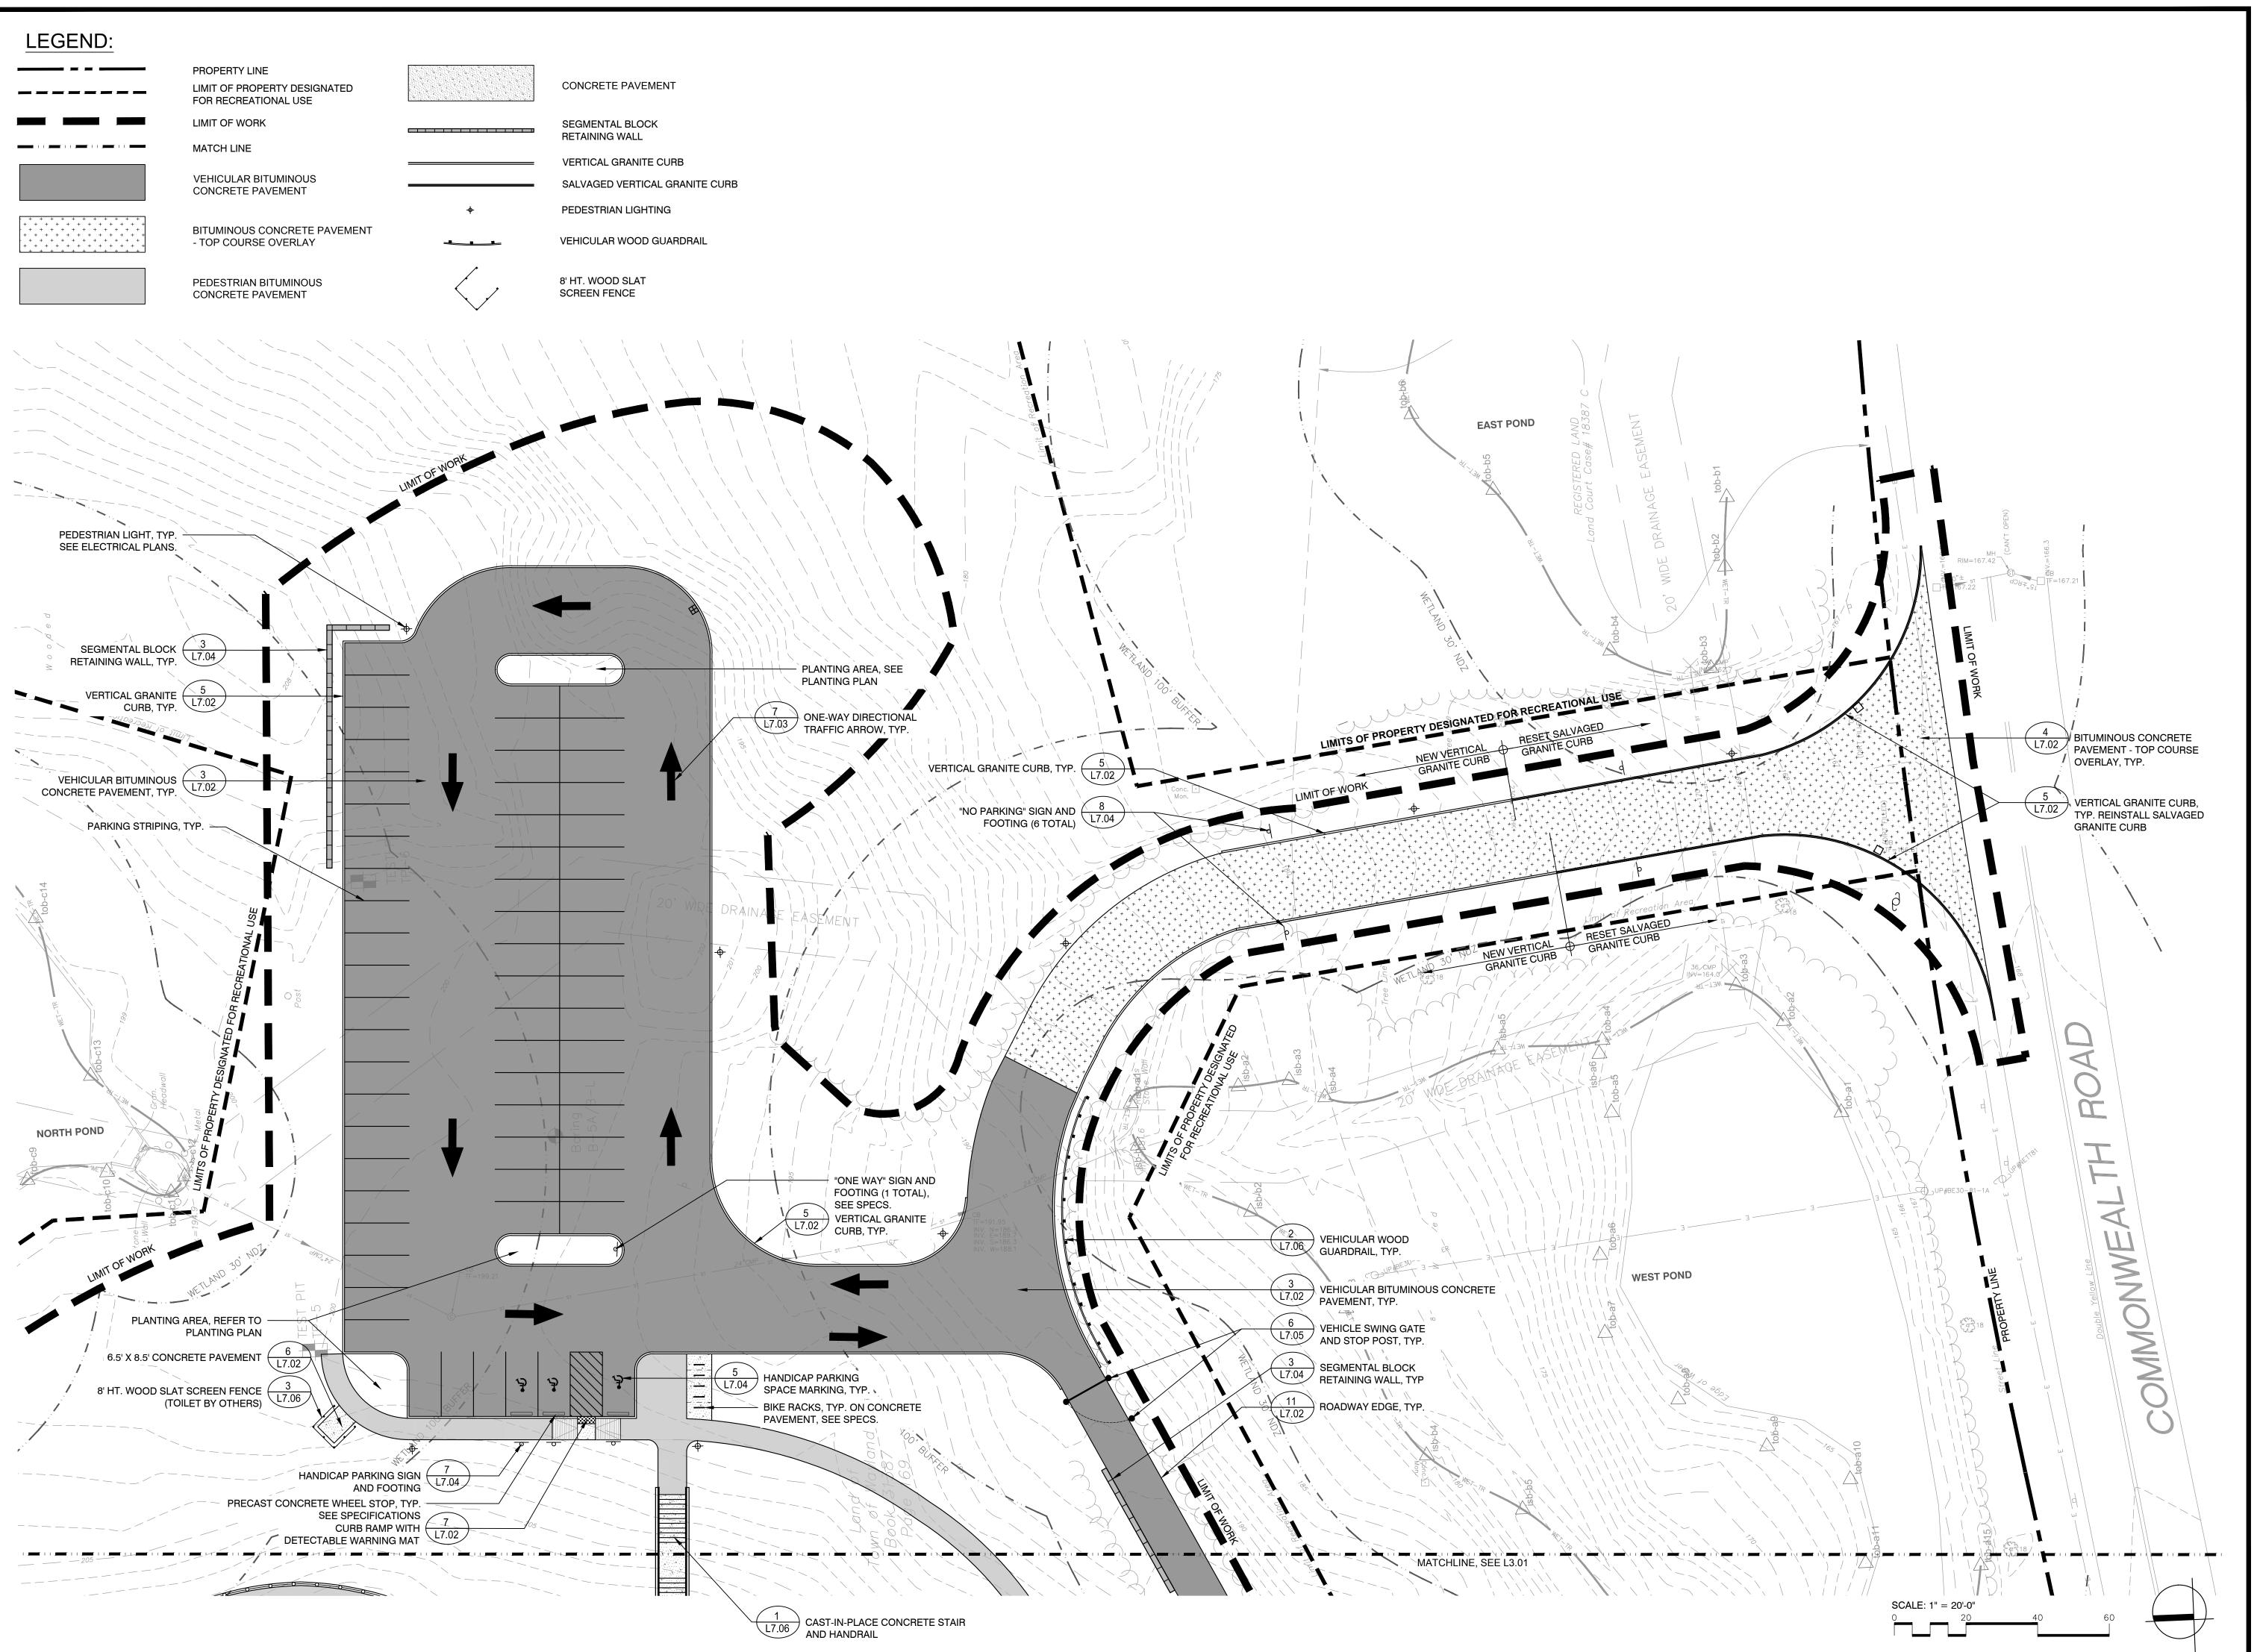





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MATERIALS PLAN **ENLARGEMENT**

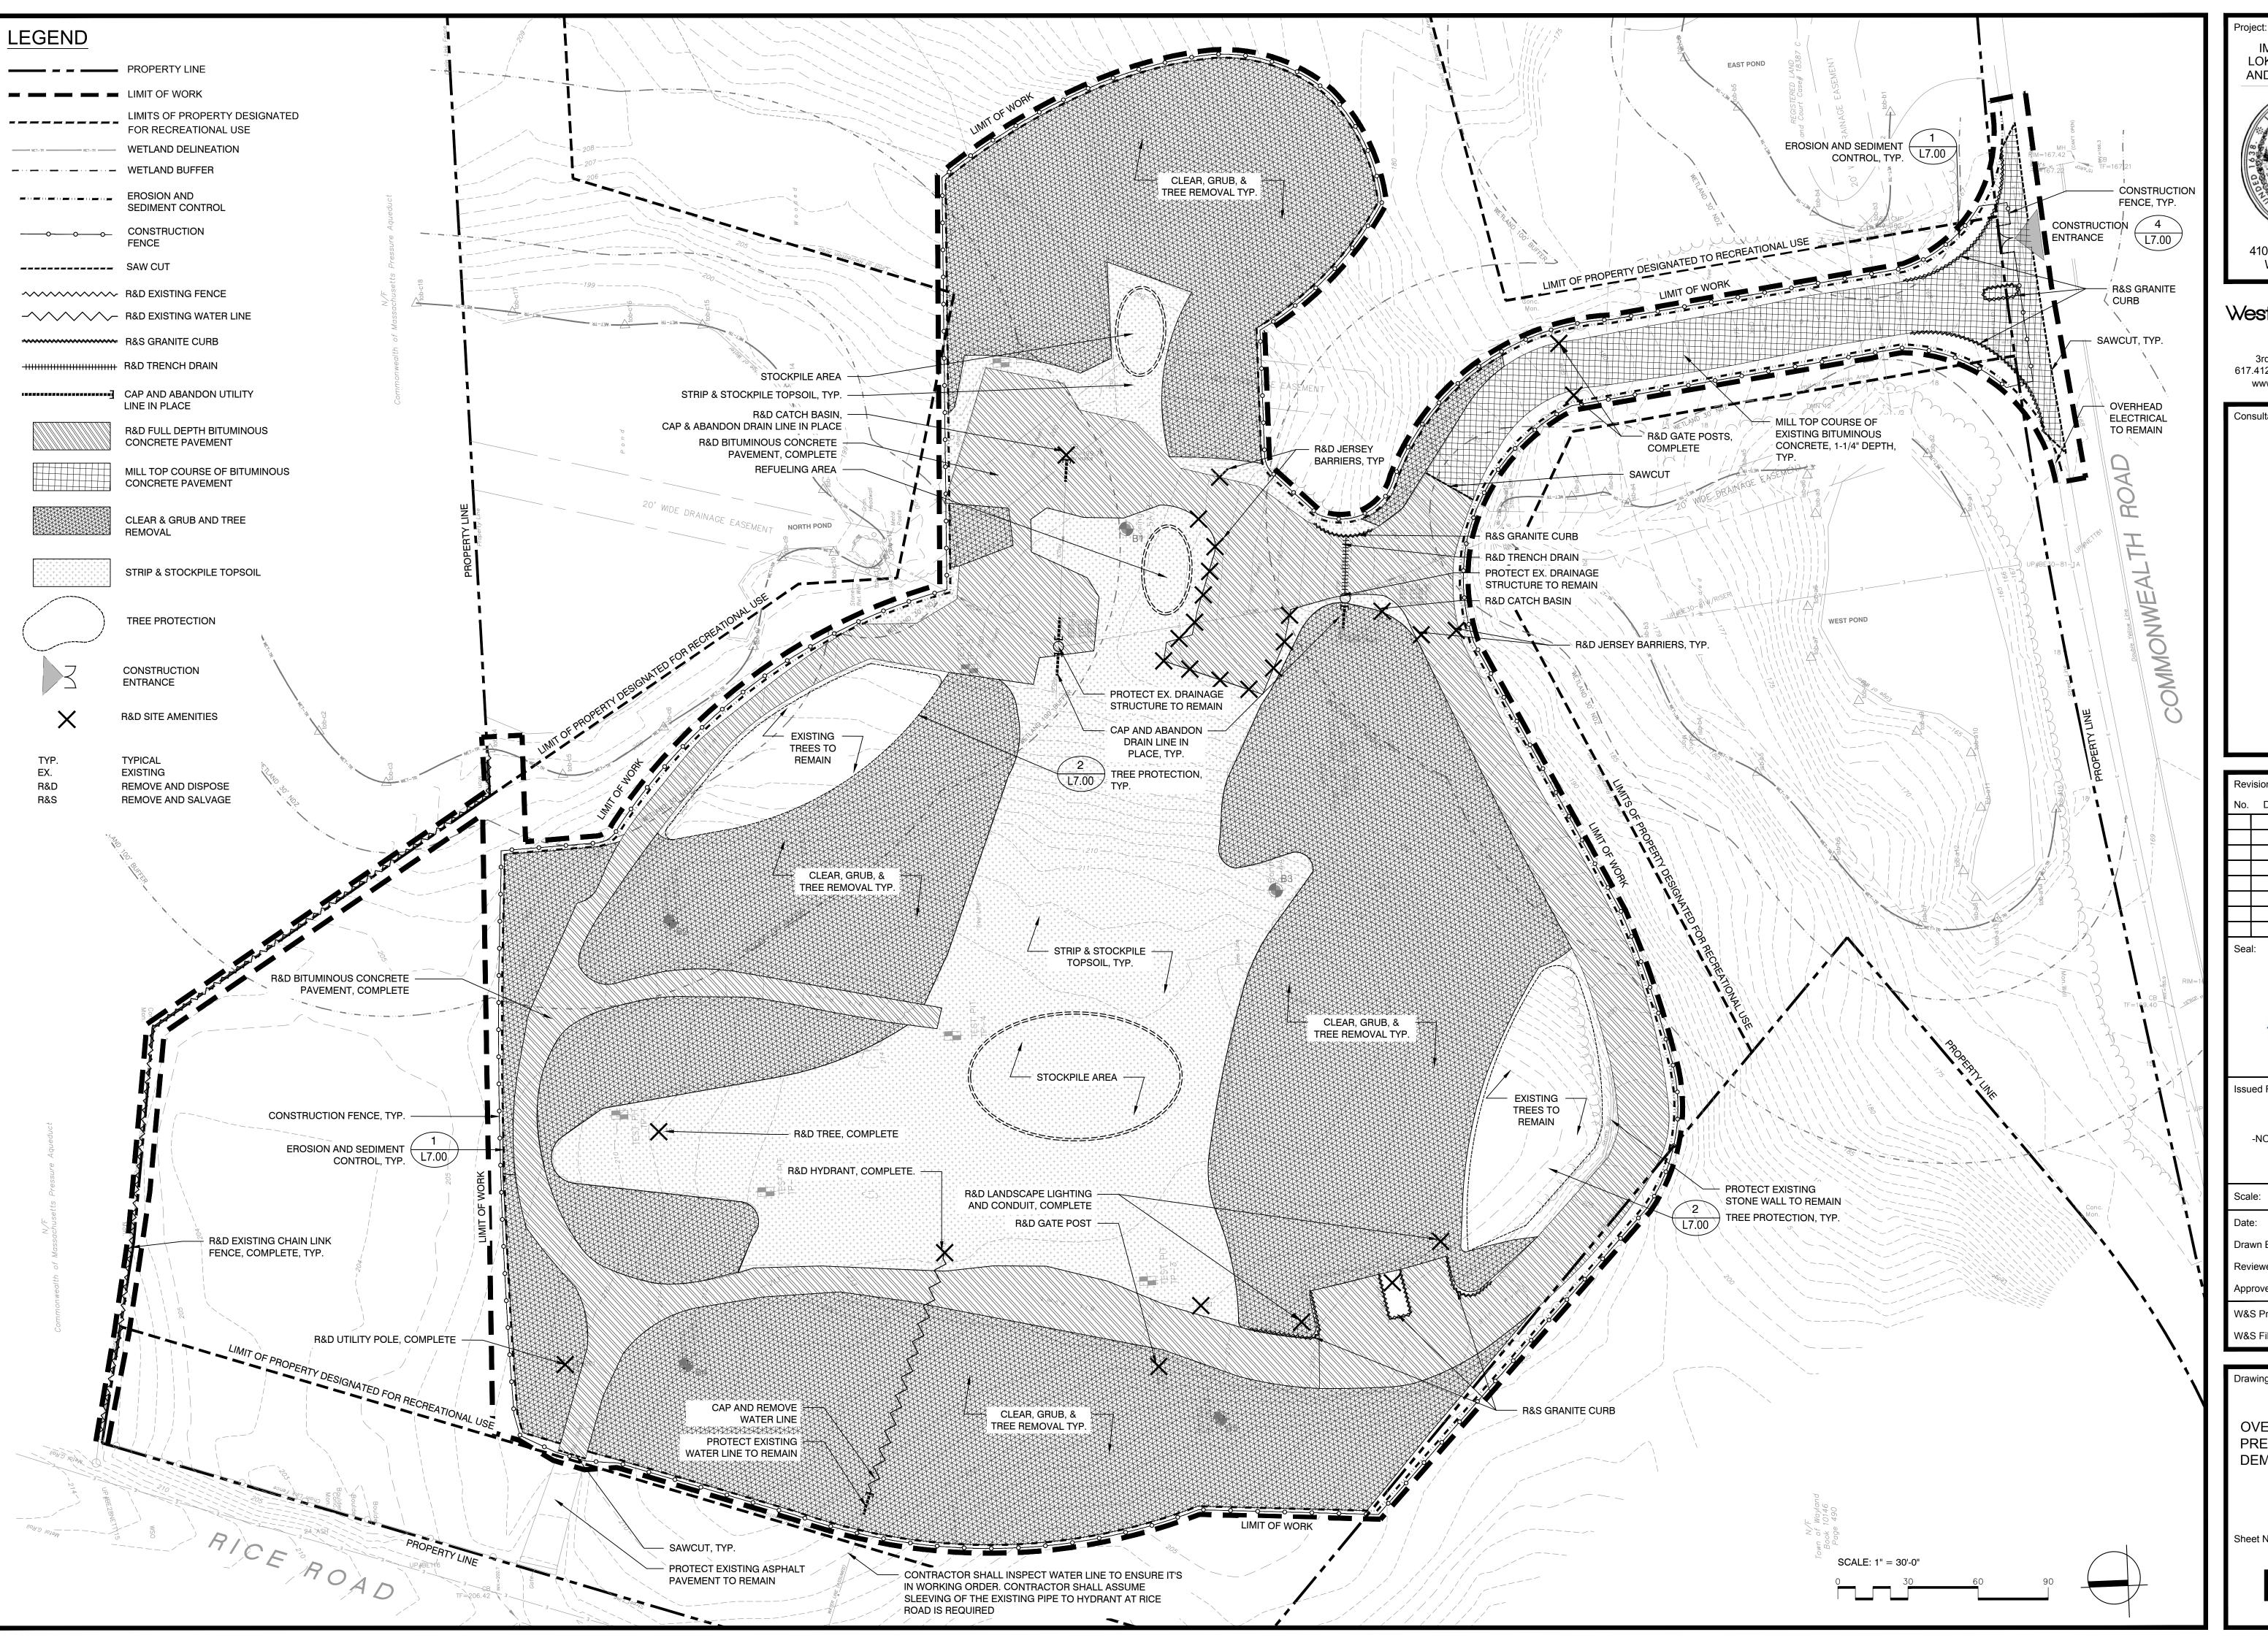



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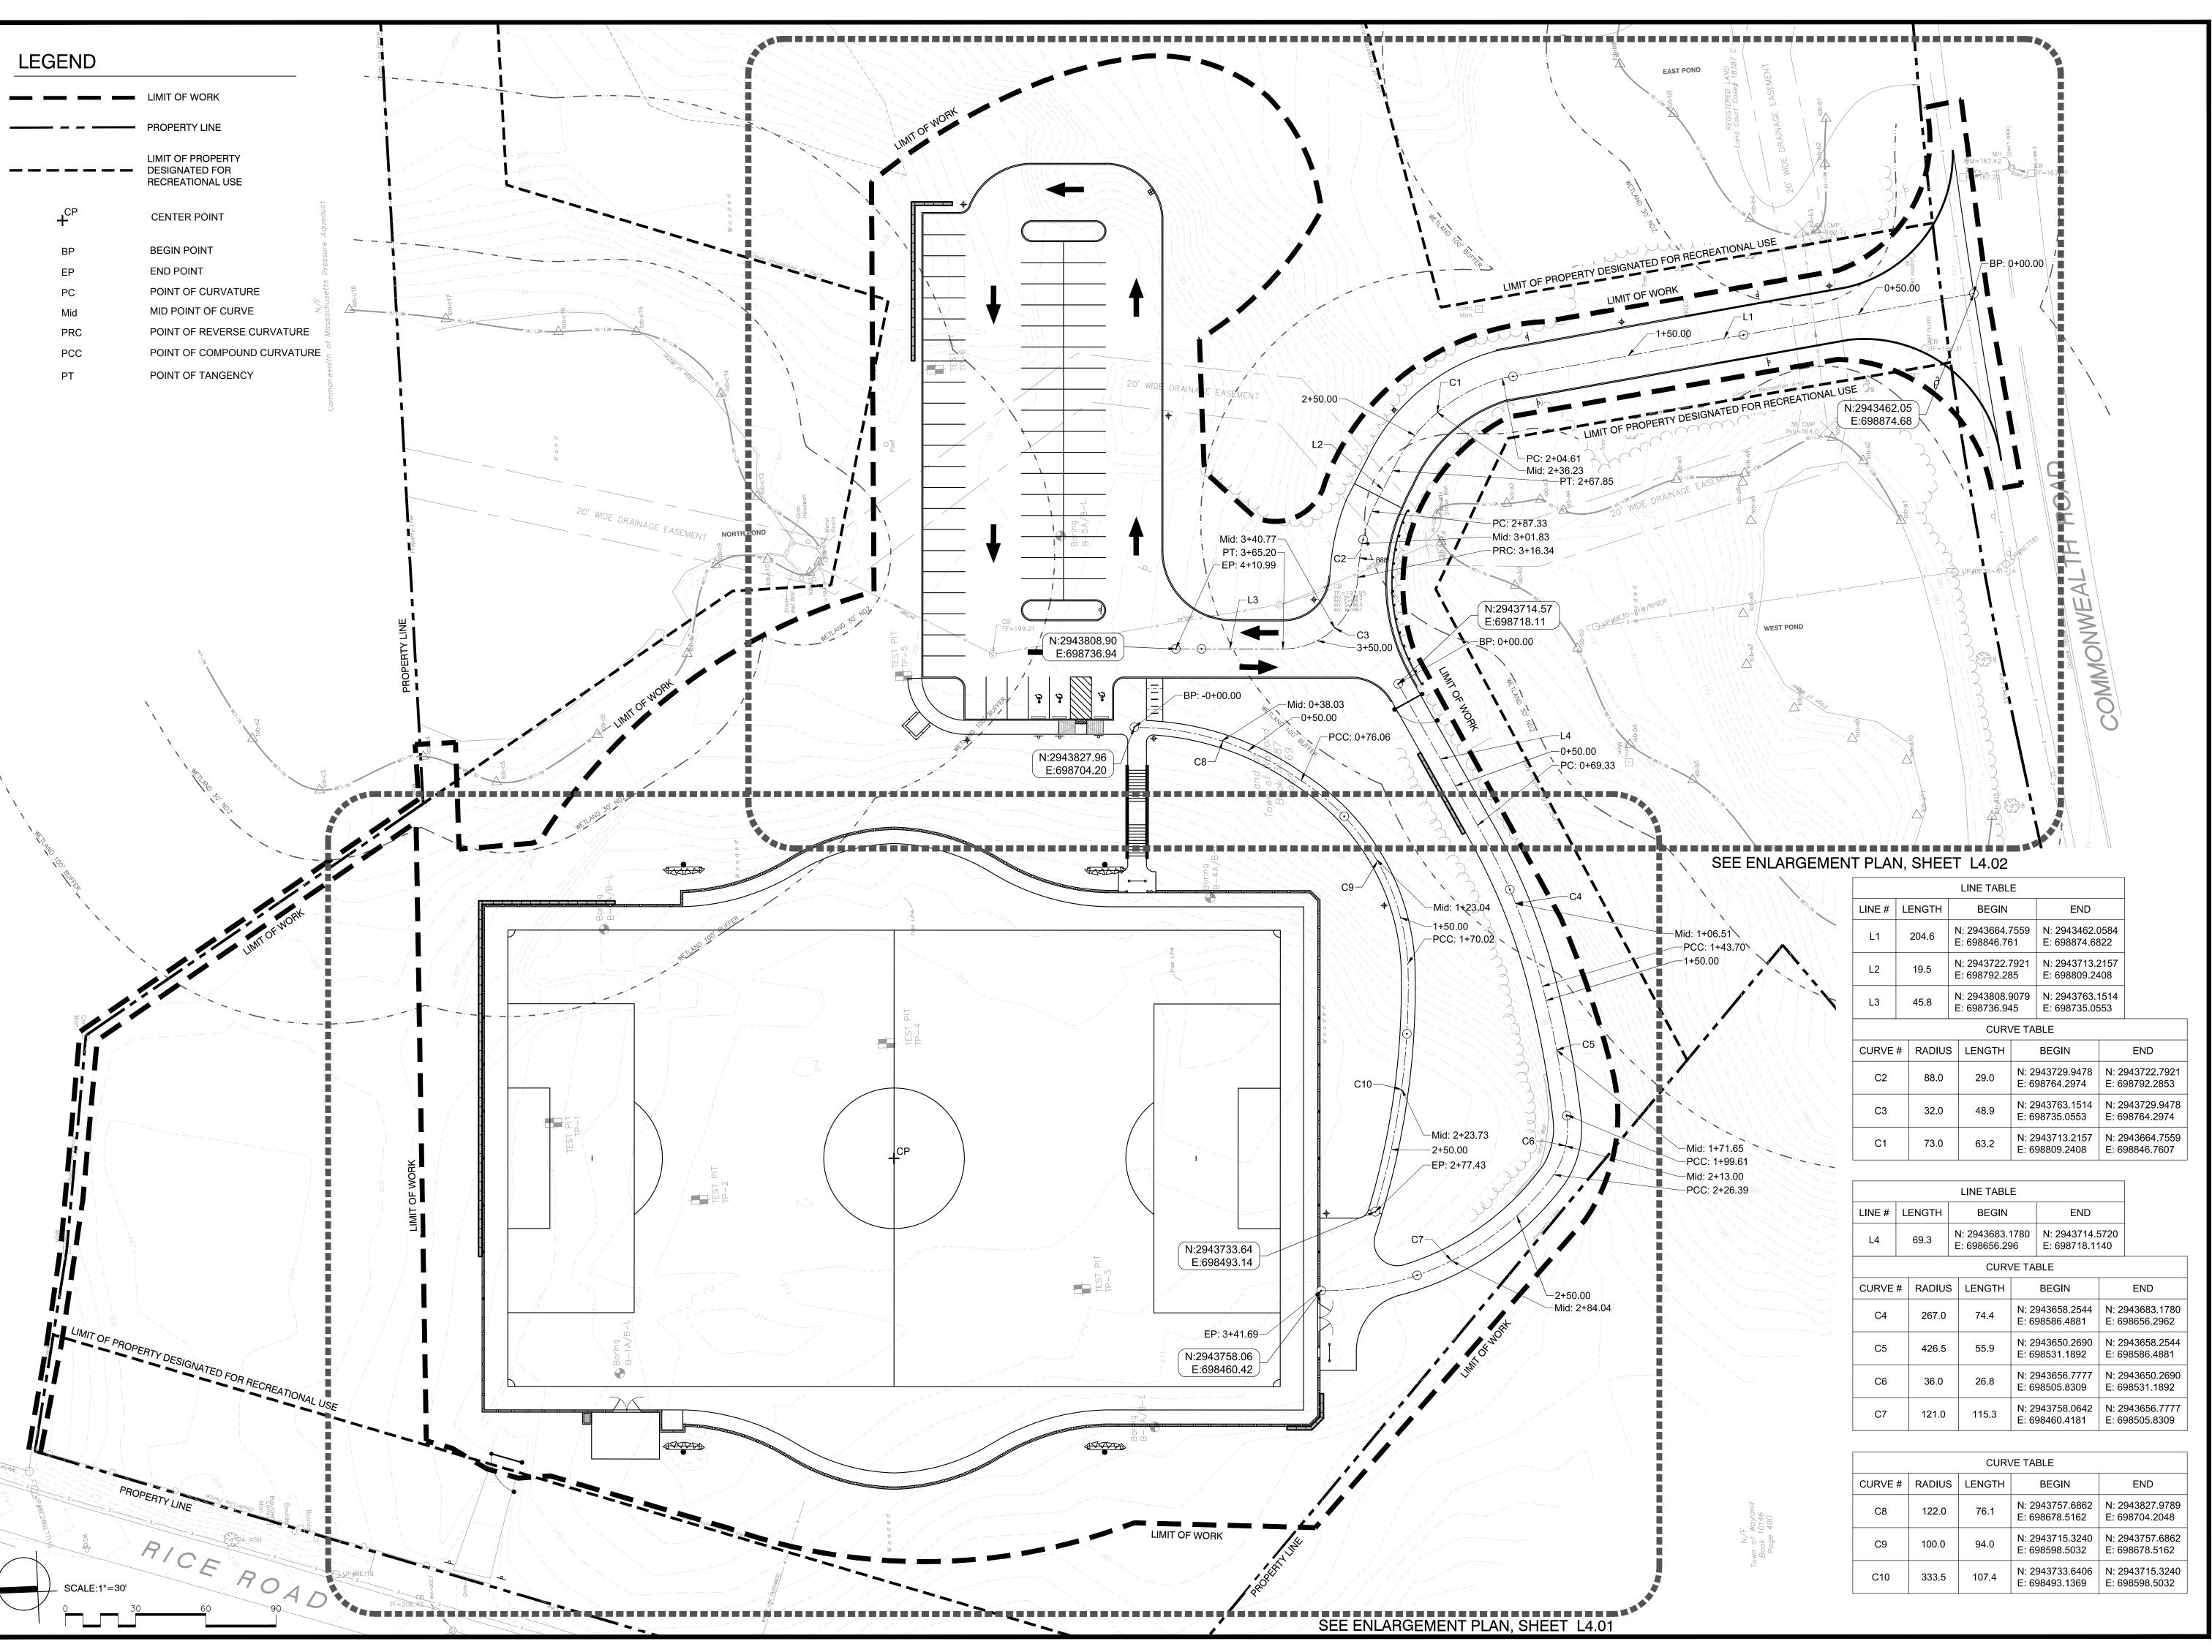
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Date:	FEBRUARY 18, 2022				
Drawn By:	CCC, DYF, LSR,				
Reviewed By:	SMG BMK				
Approved By:	вмк				
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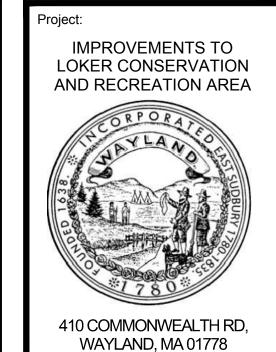
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MATERIALS PLAN
ENLARGEMENT

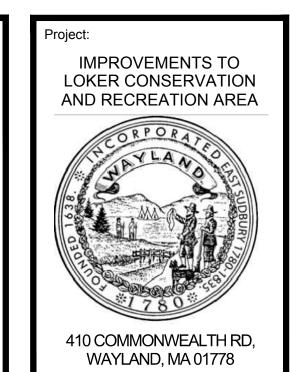
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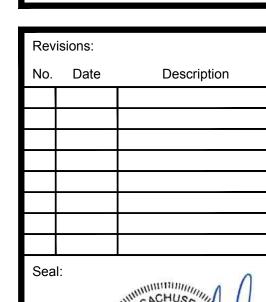
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Drawn By: CCC, DYF, LSR, SMG

Reviewed By: BMK

Approved By: BMK

W&S Project No: 2180076


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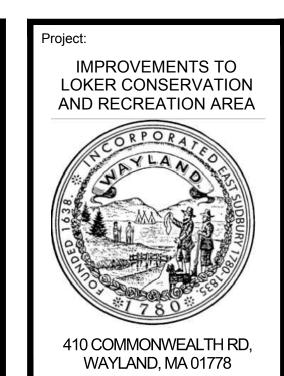
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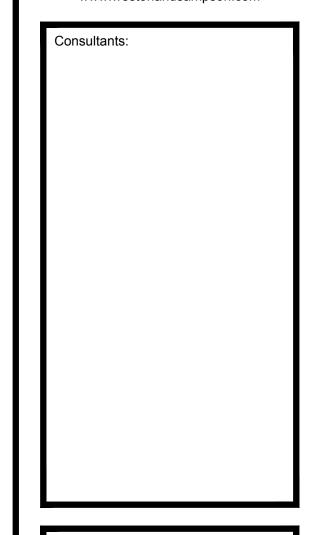
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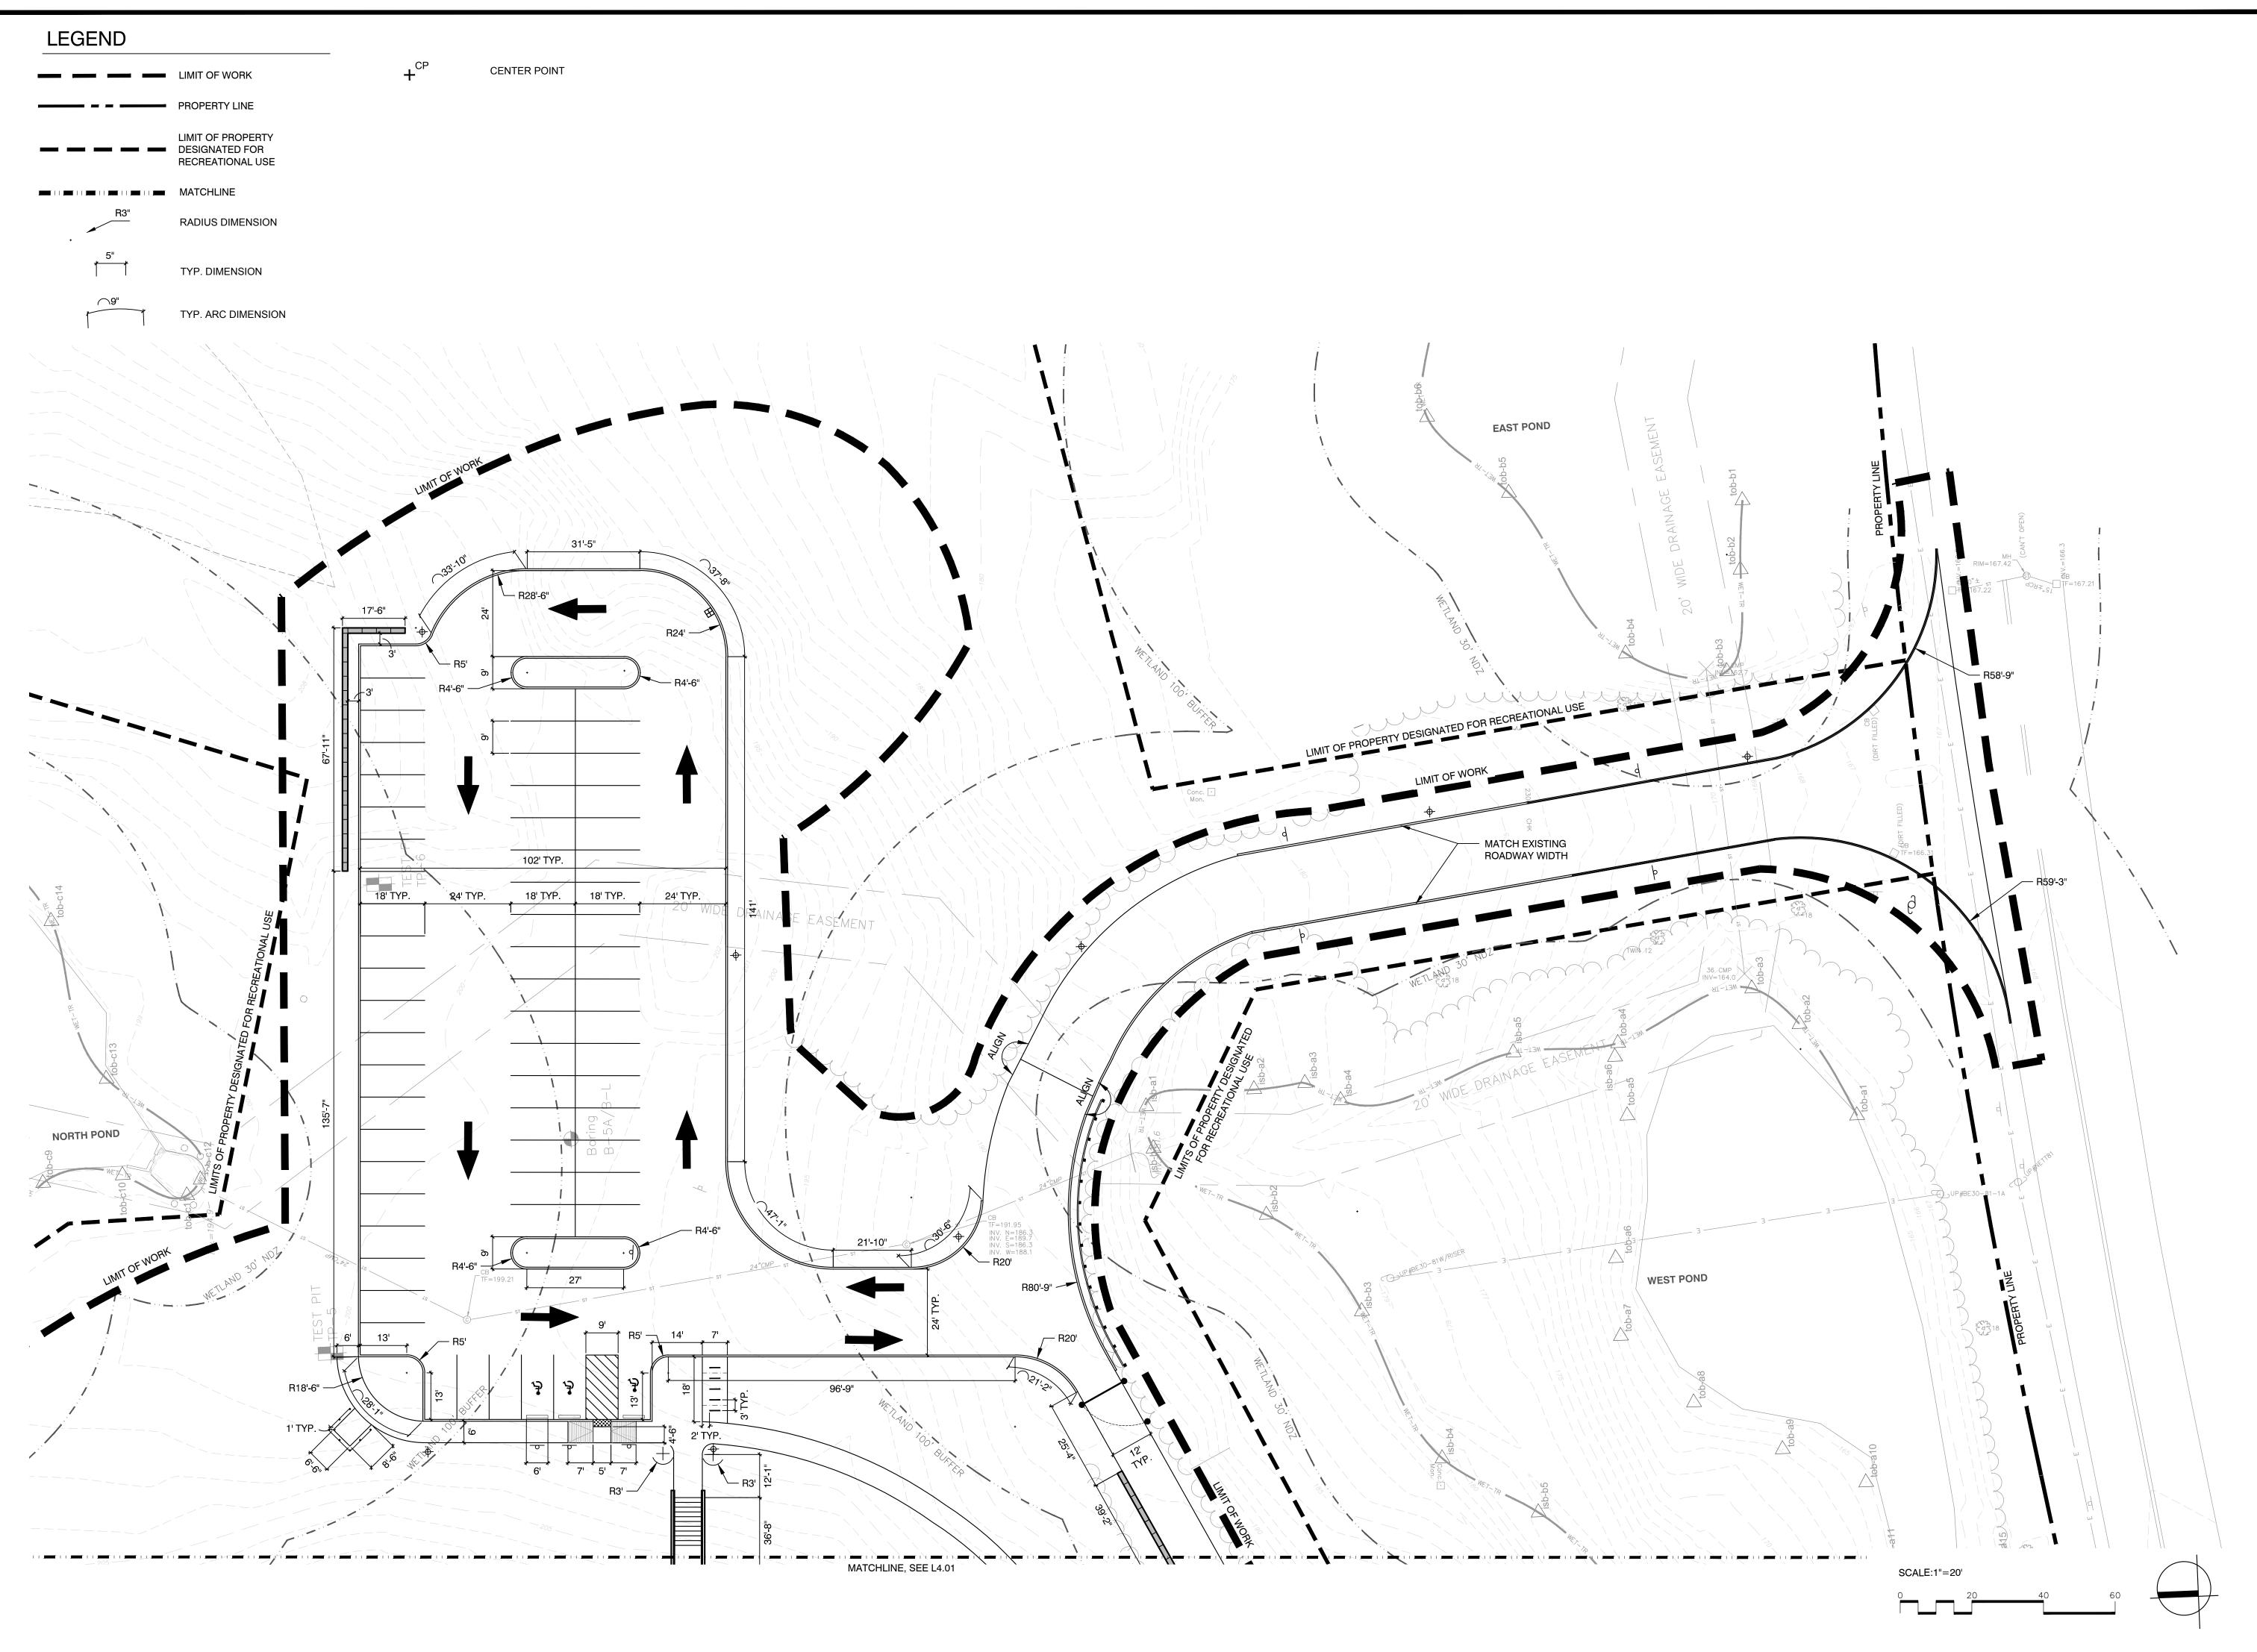


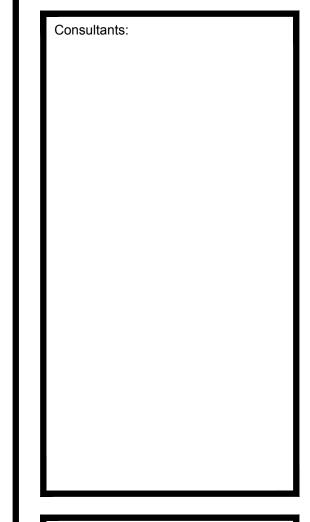
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Dra	wn By:	CCC, DYF, LSR, SMG		
Rev	iewed By:	BMK		
Арр	roved By:	вмк		
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Consultants:


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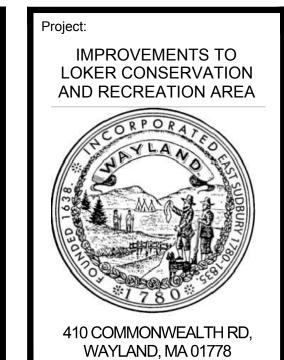
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LAYOUT PLANS
ENLARGEMENT


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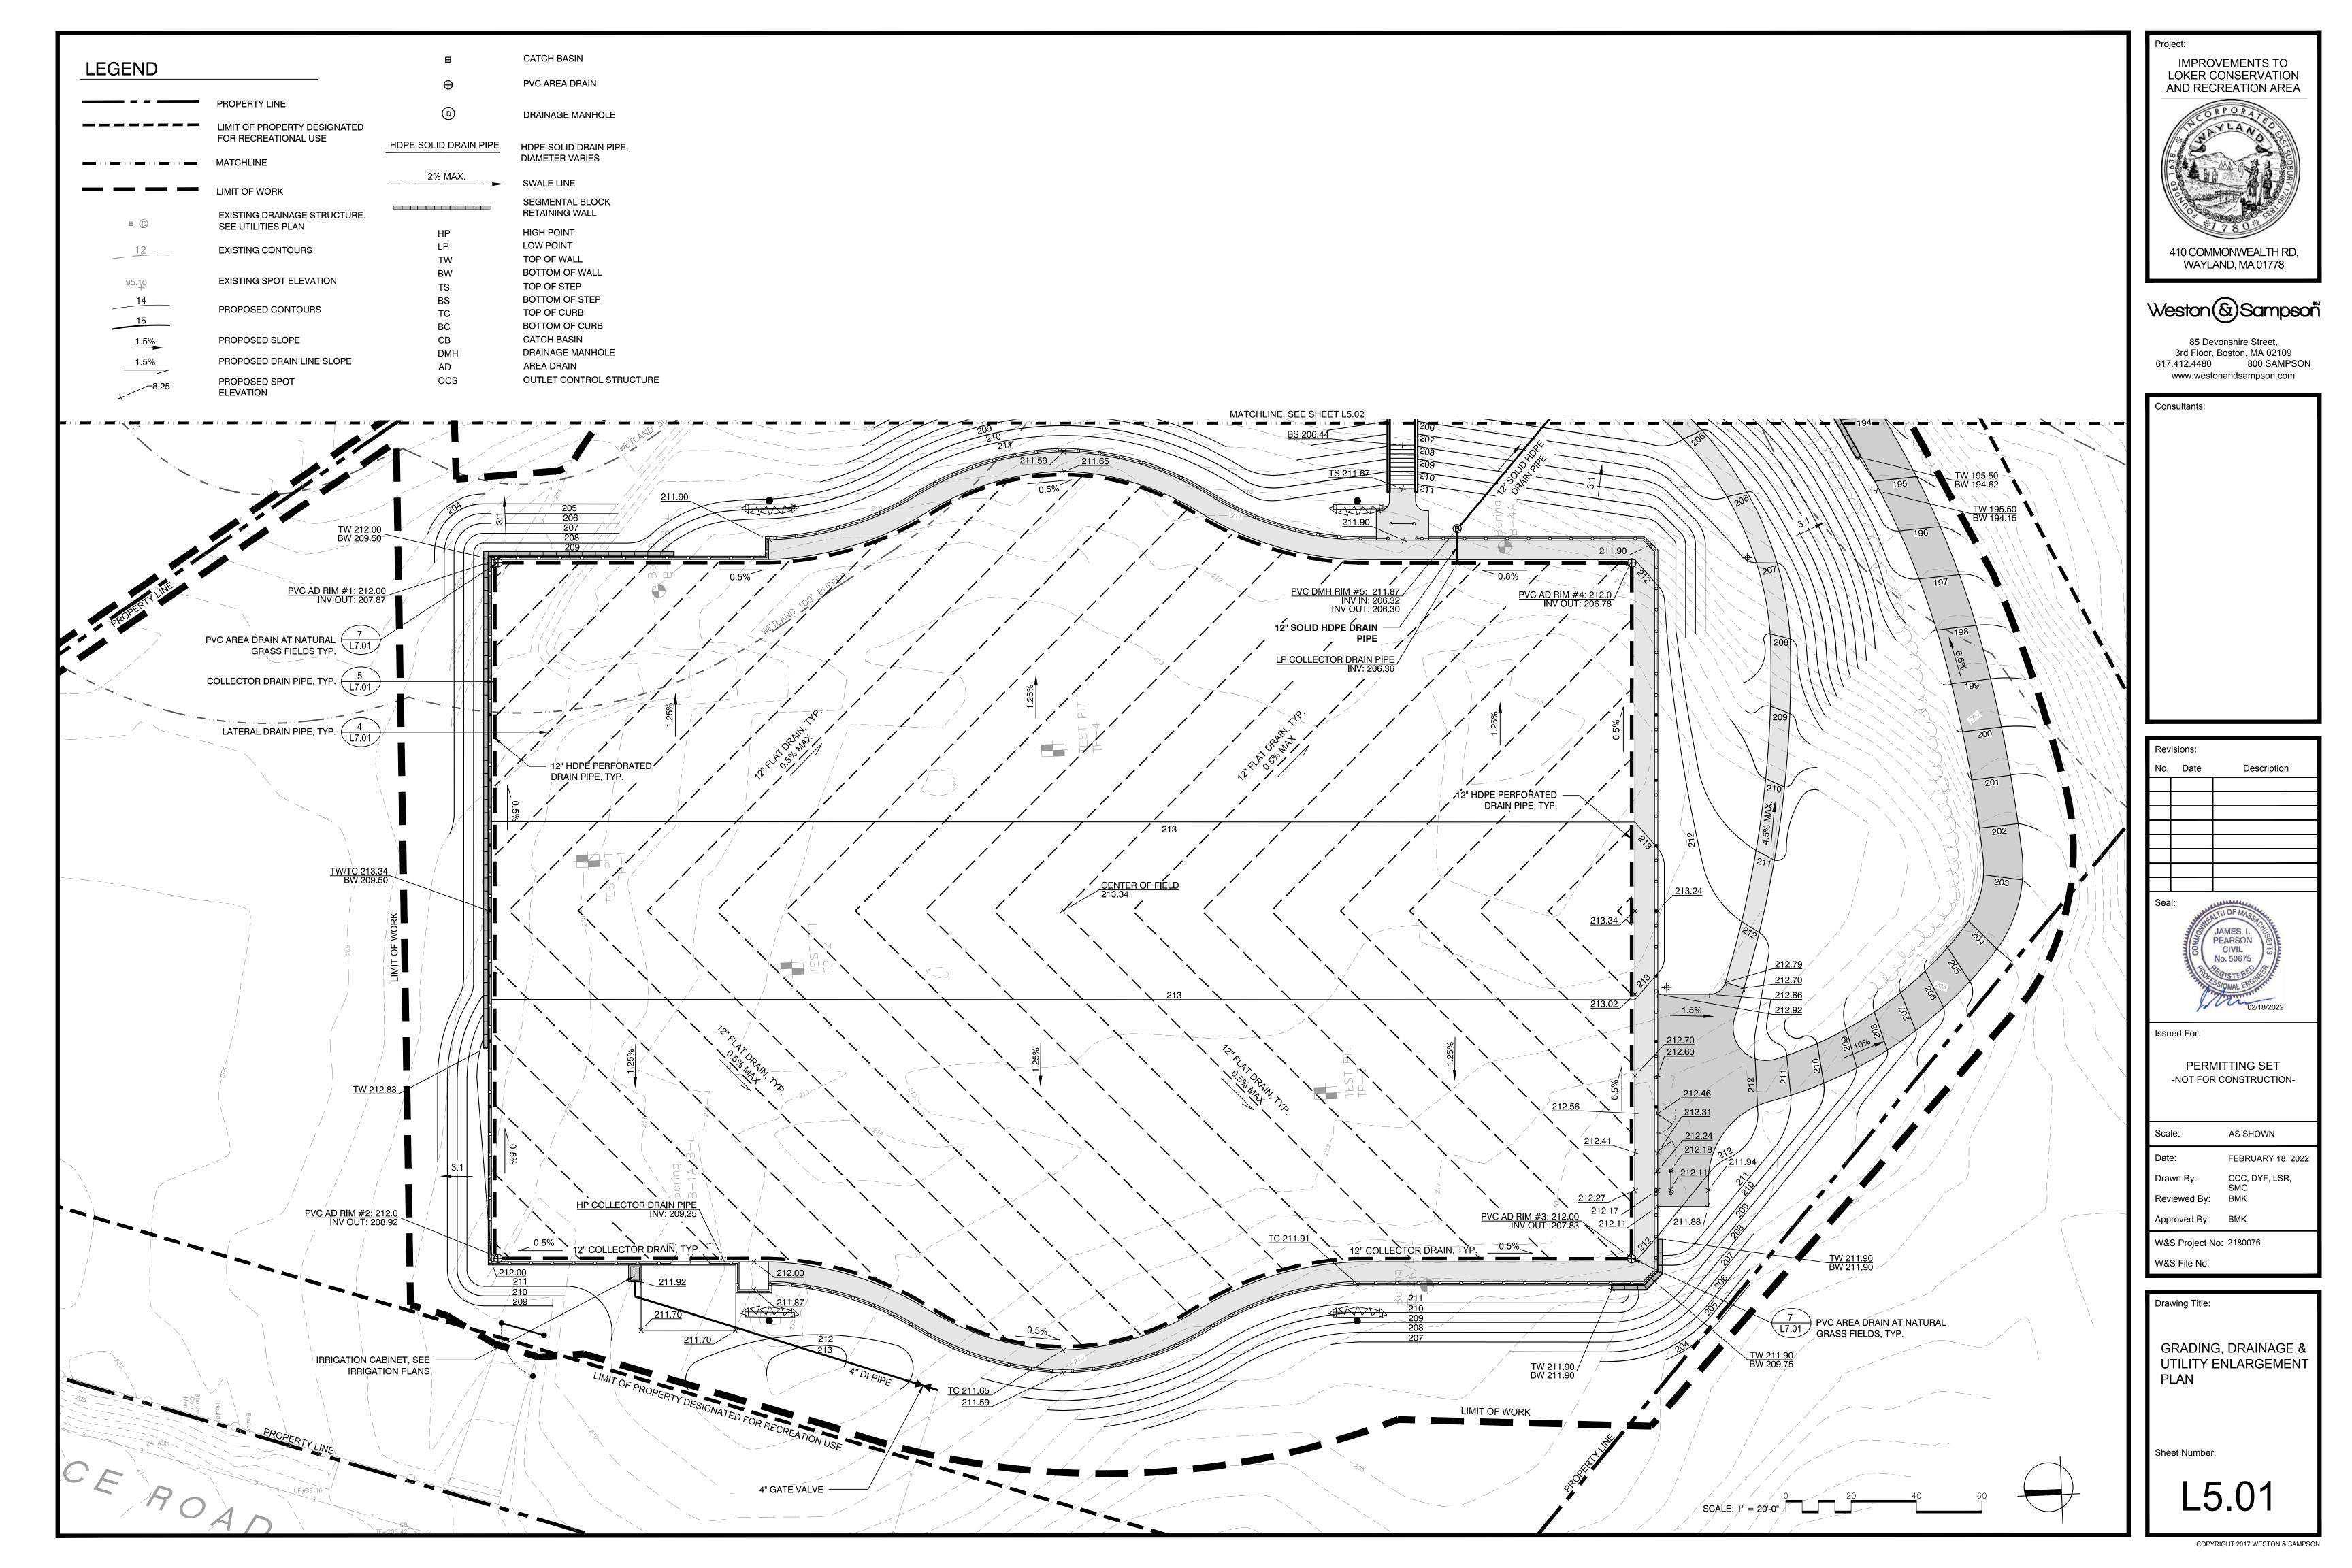



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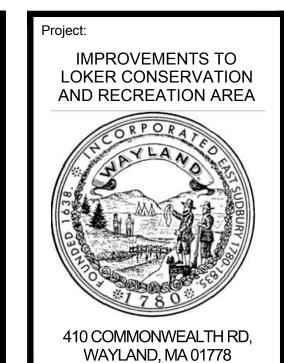
Drawing Title: OVERALL GRADING,

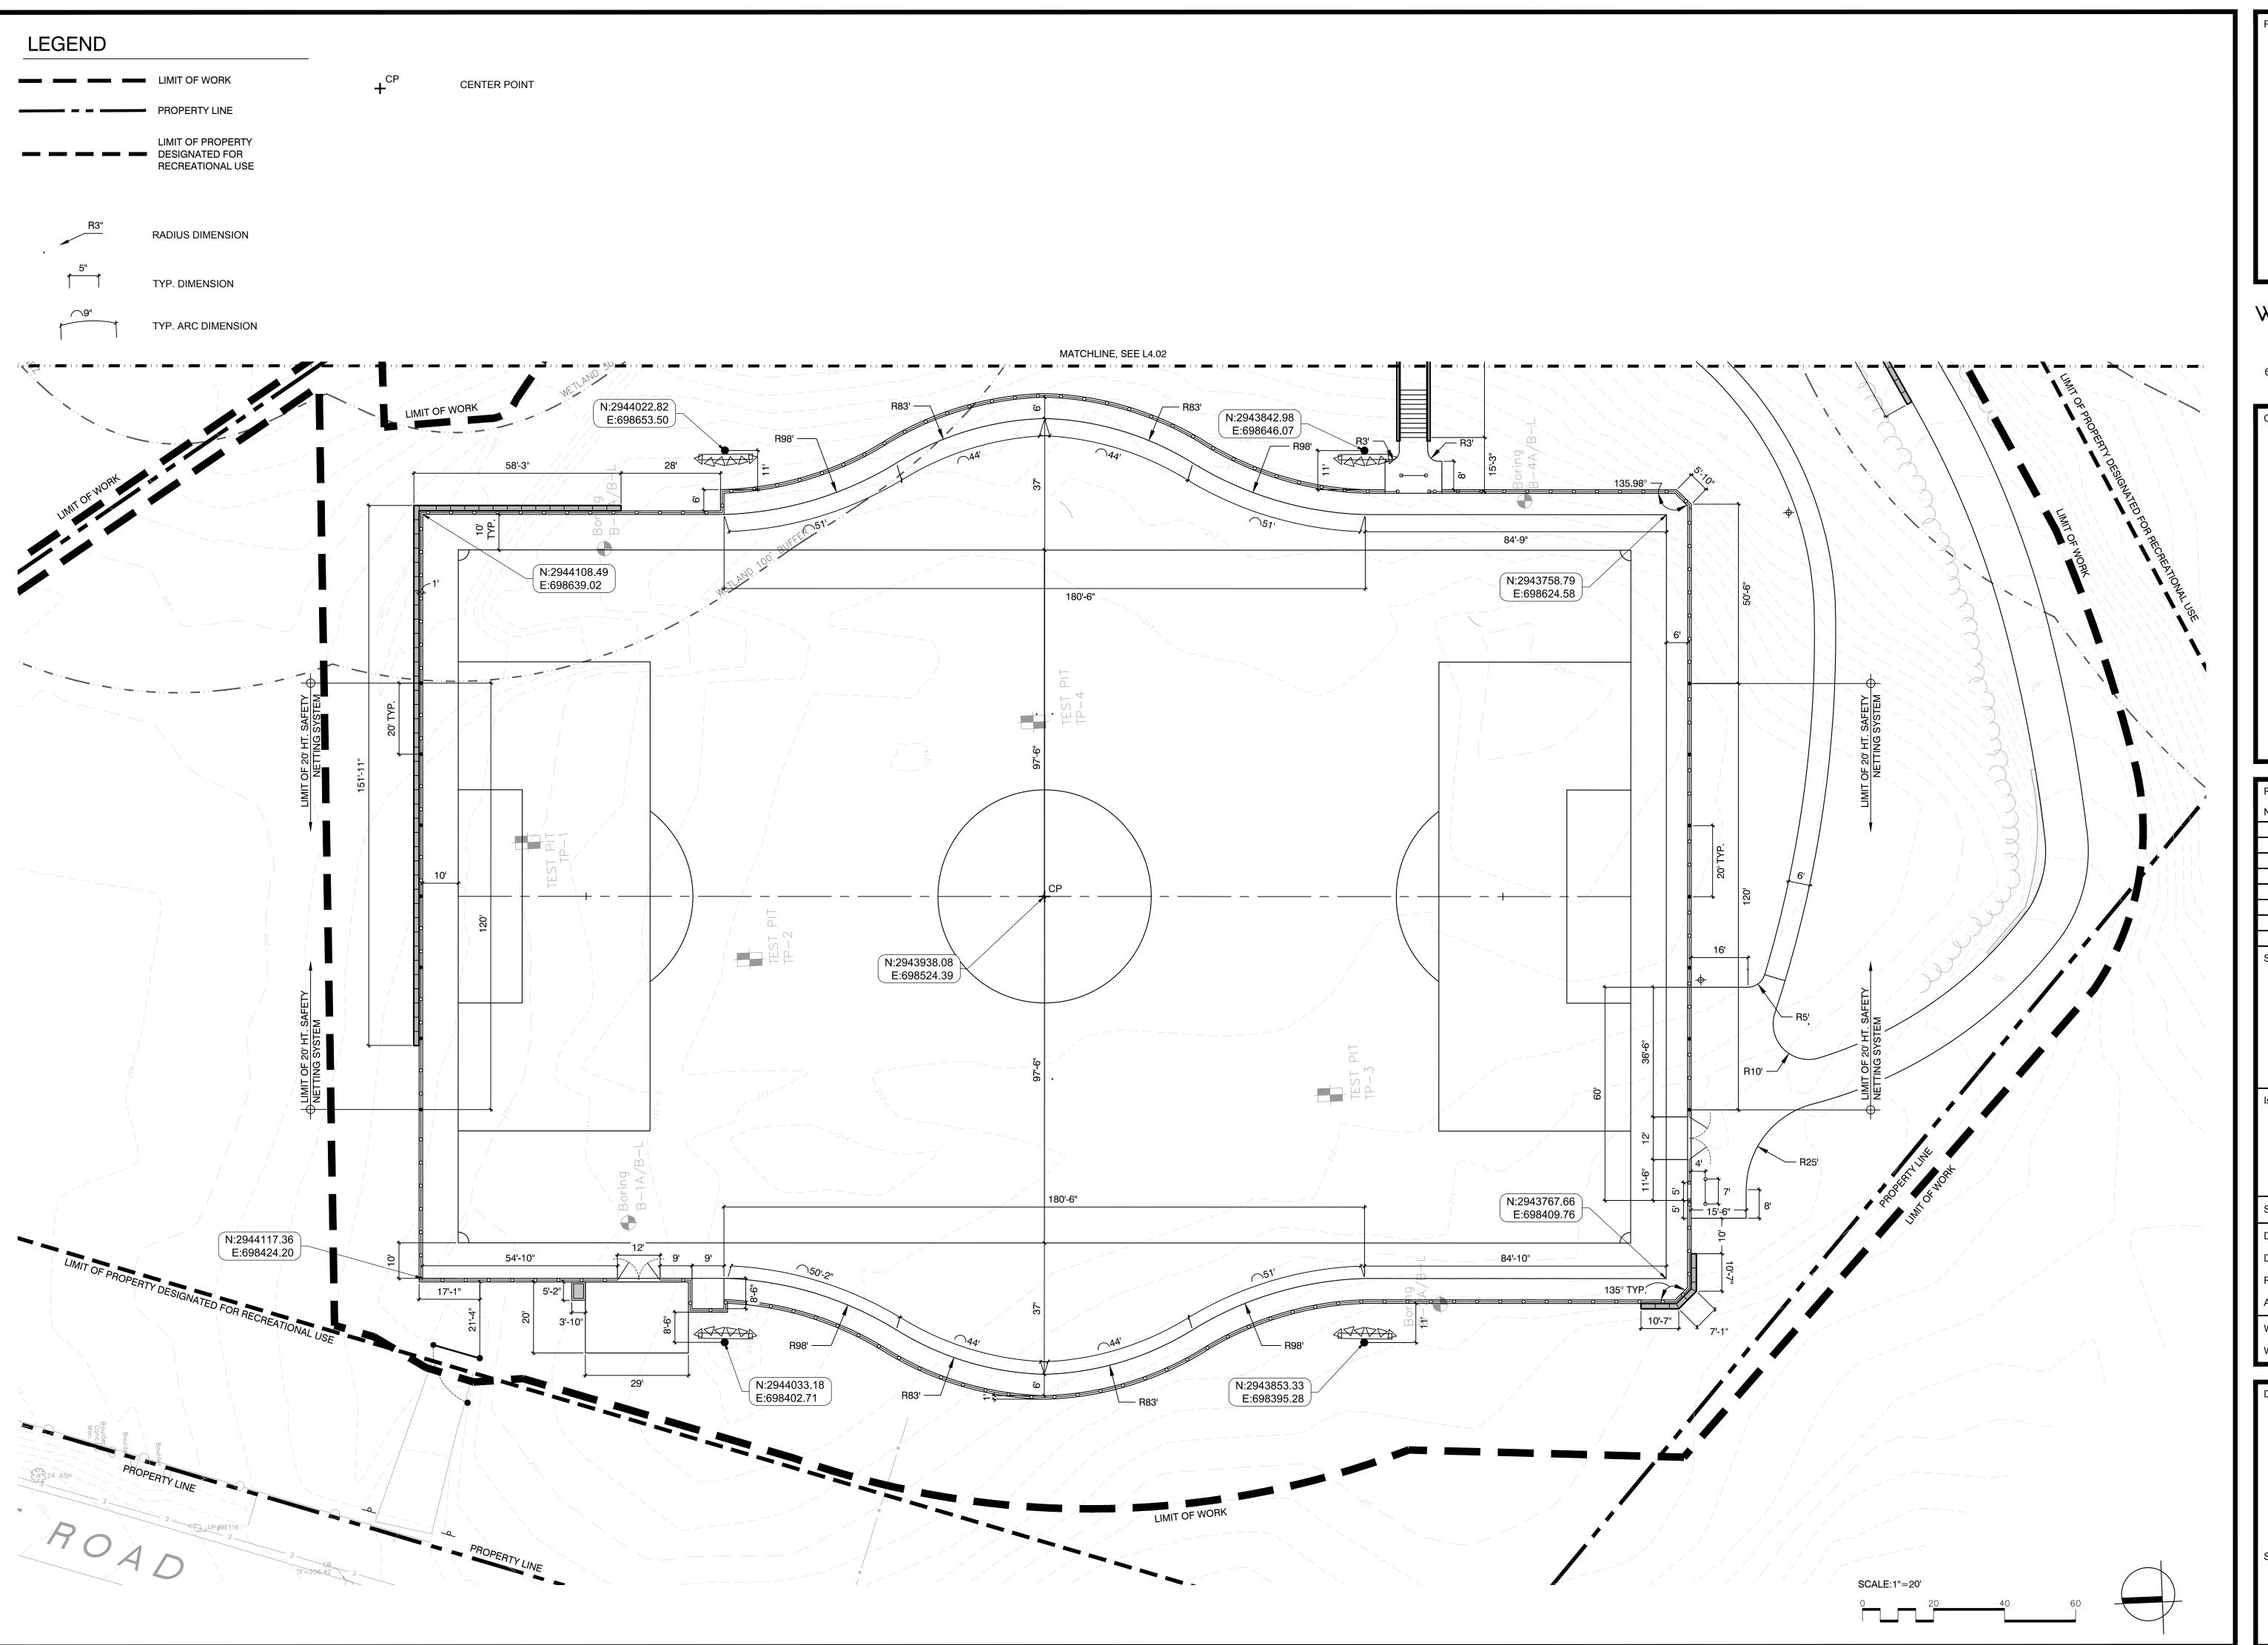DRAINAGE & UTILITY PLAN
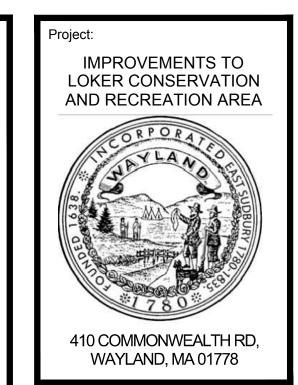
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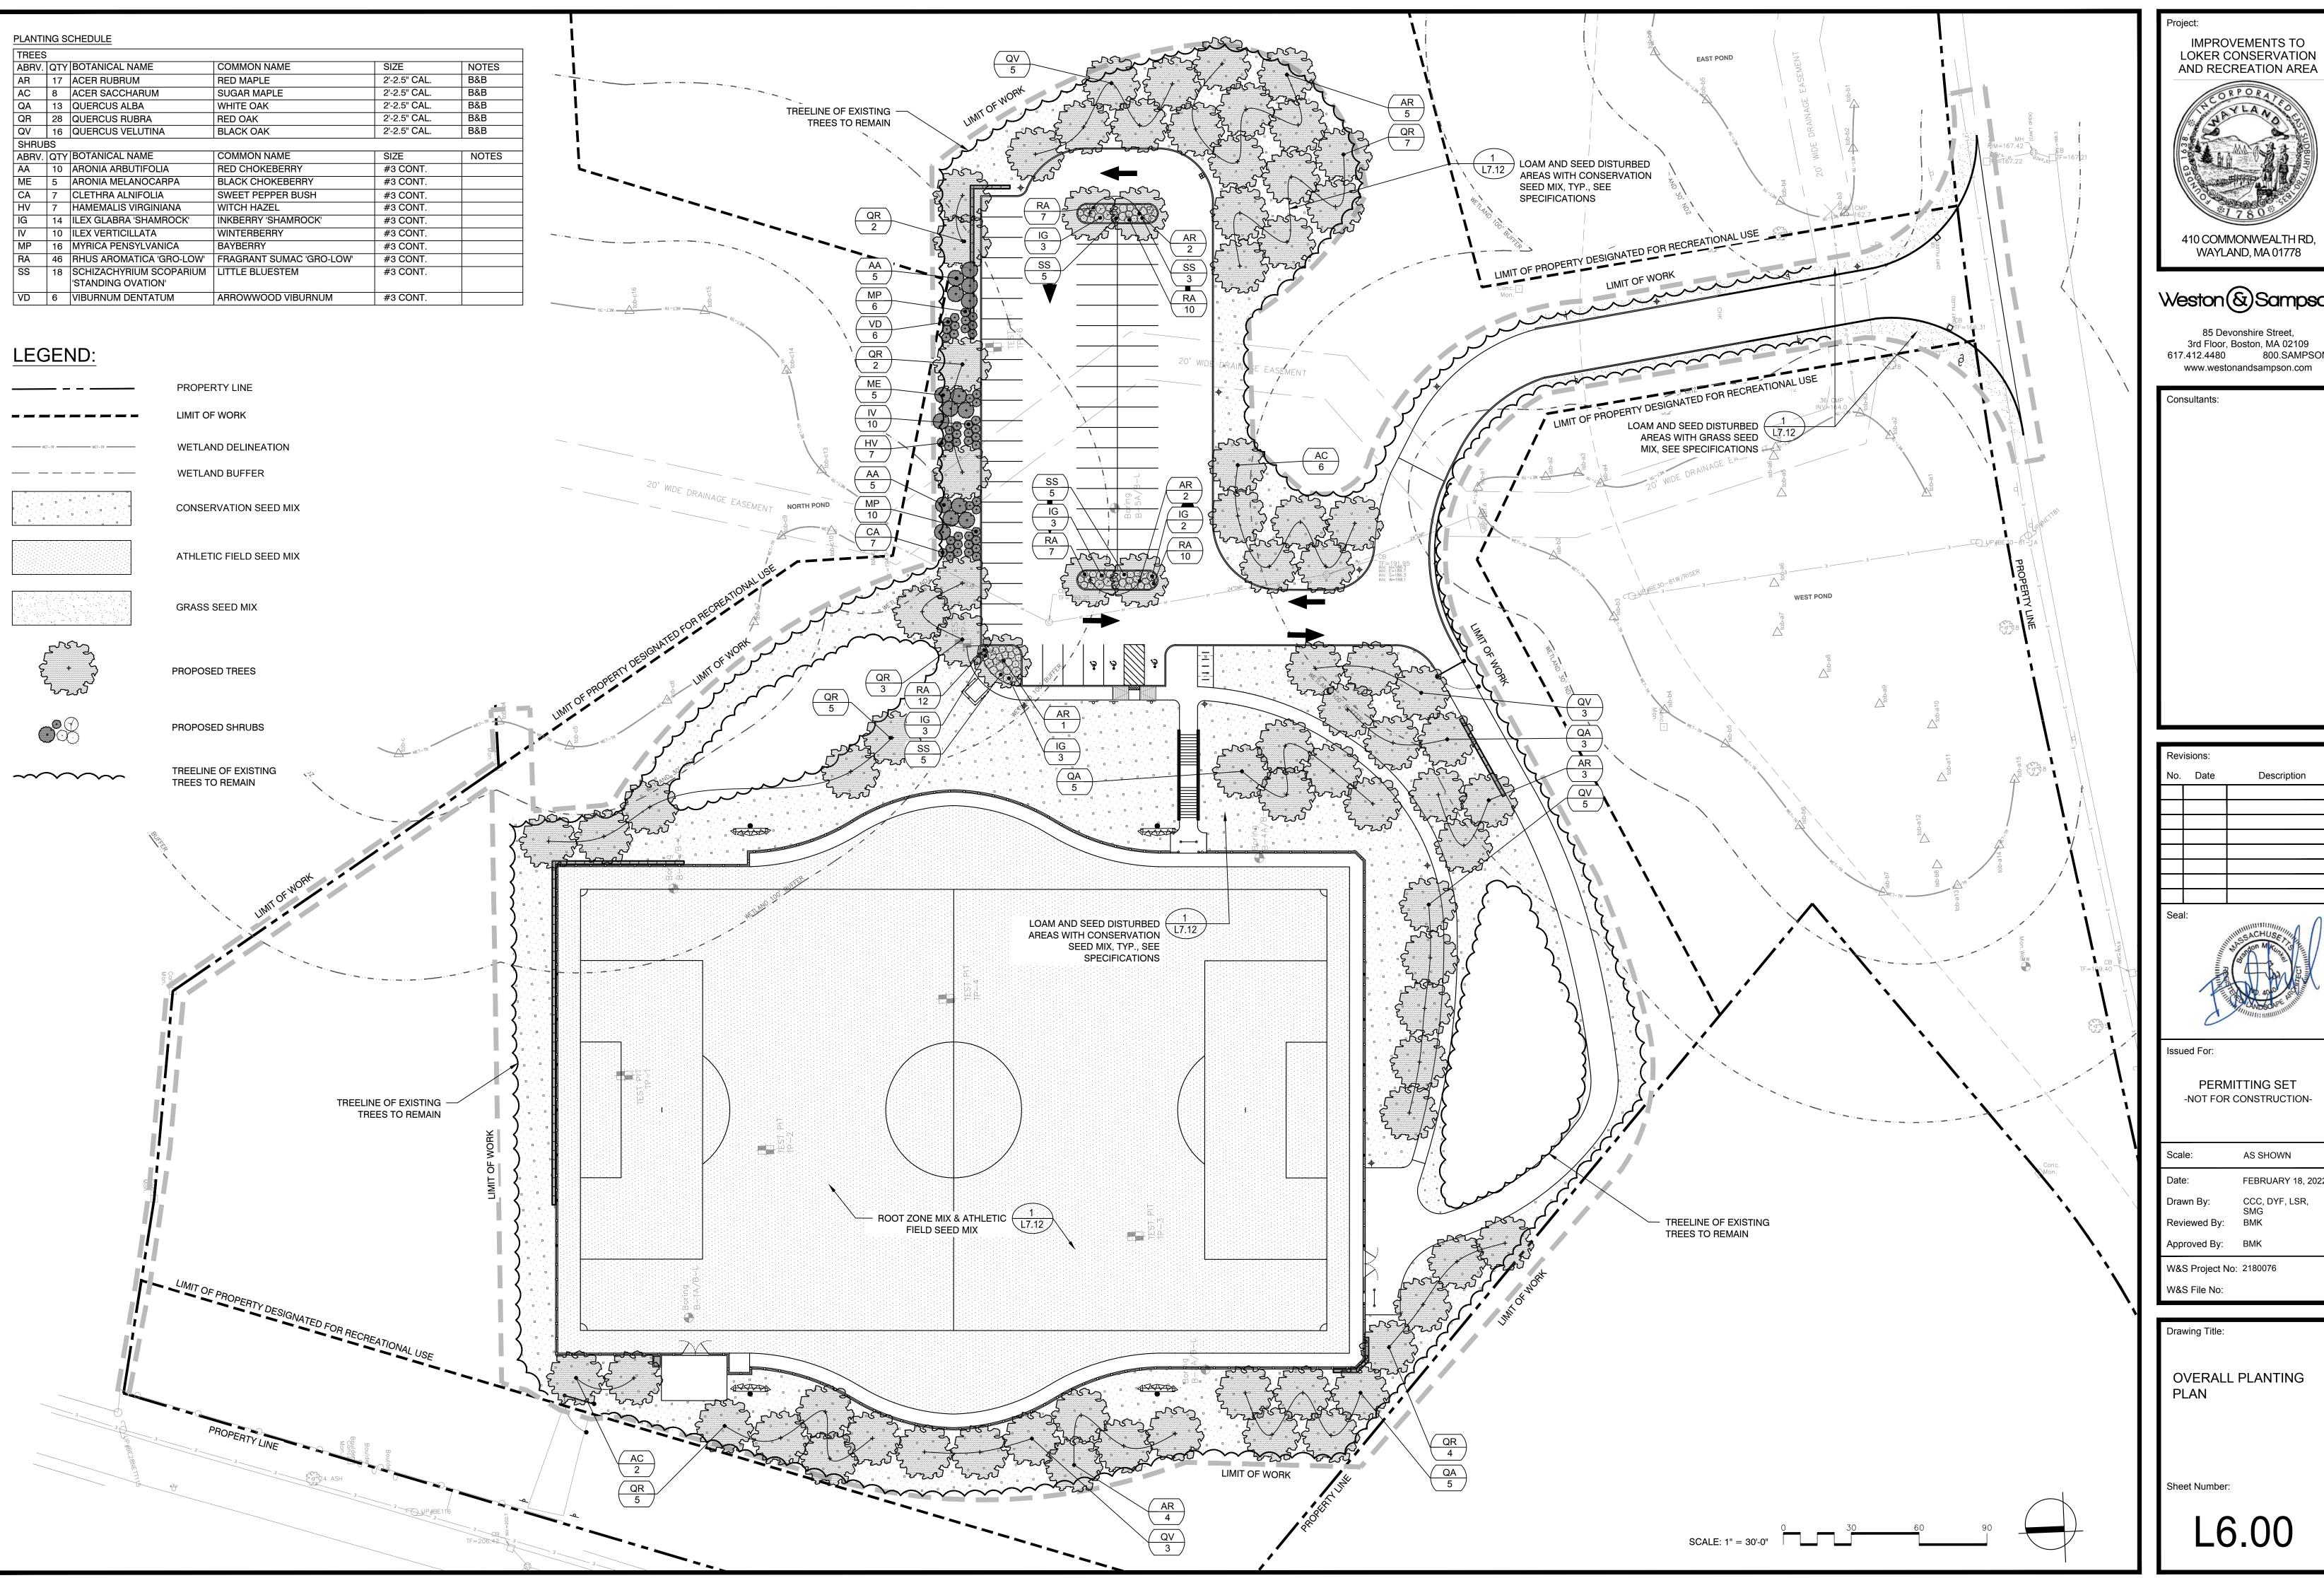
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W&S Project No: 2180076		

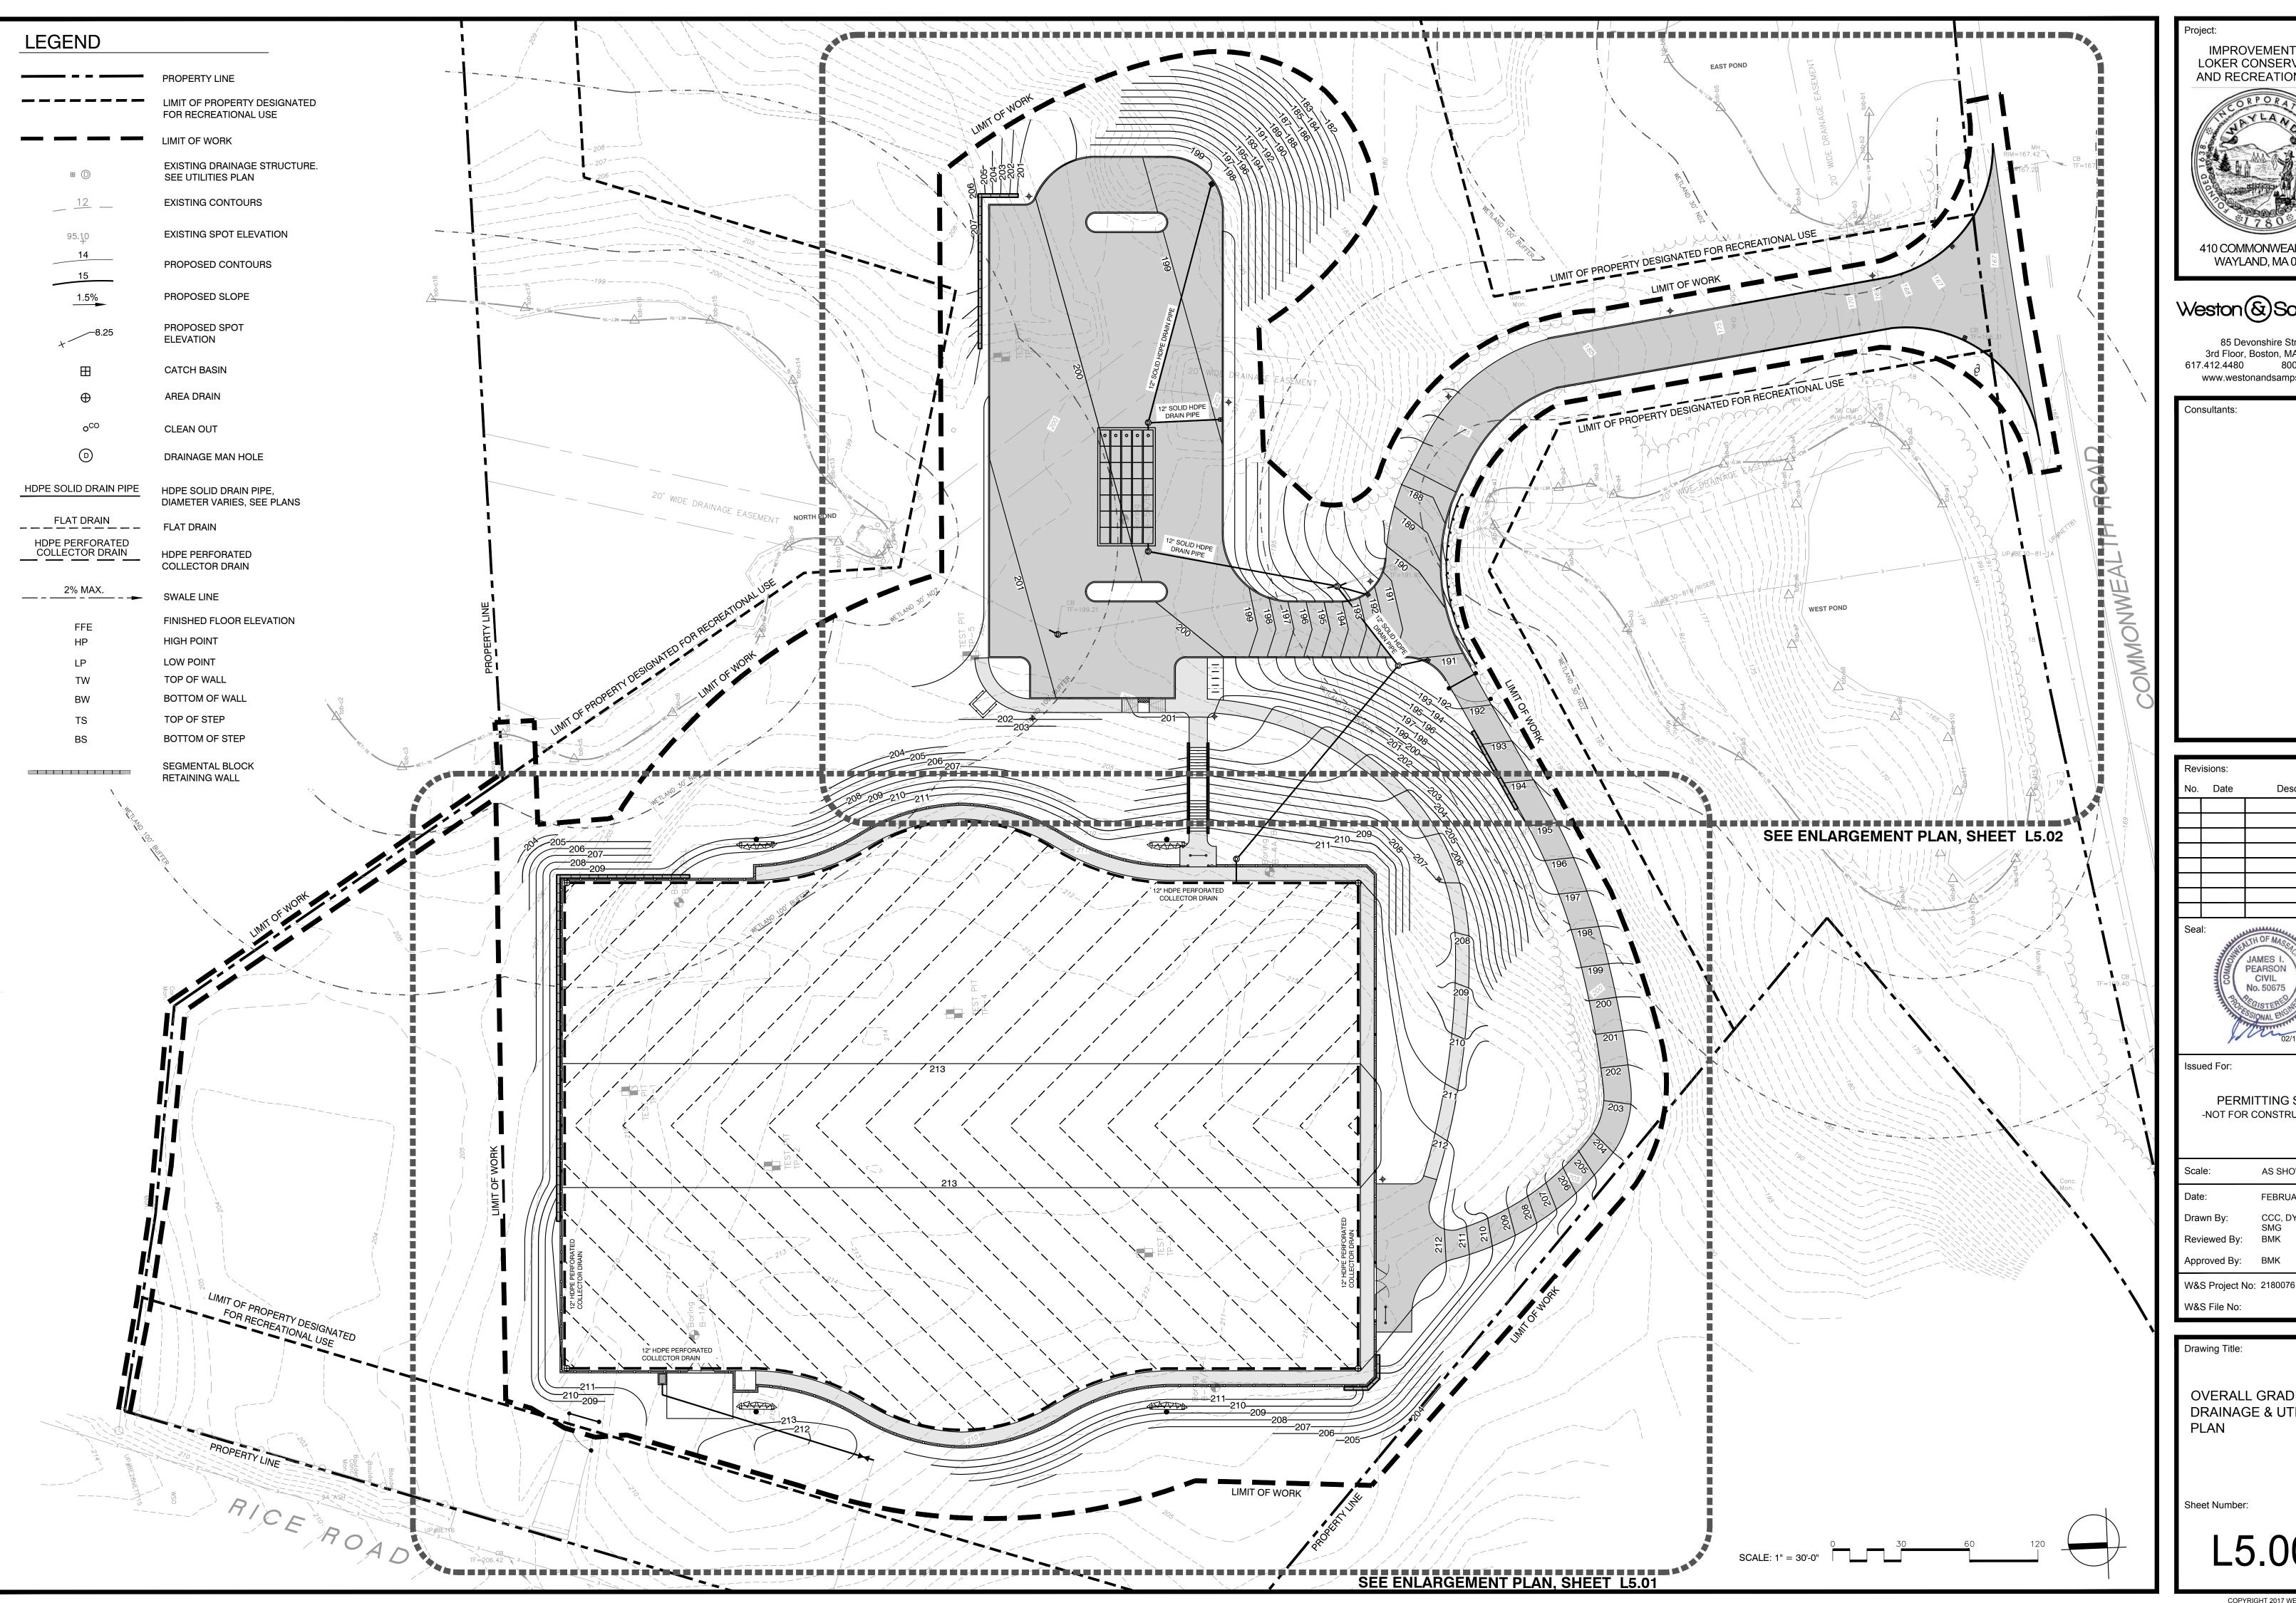Drawing Title:
GRADING, DRAINAGE & UTILITY ENLARGEMENT PLAN

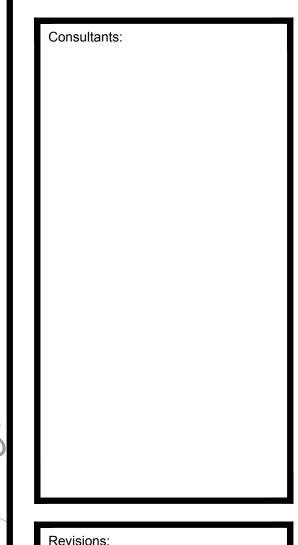W&S File No:

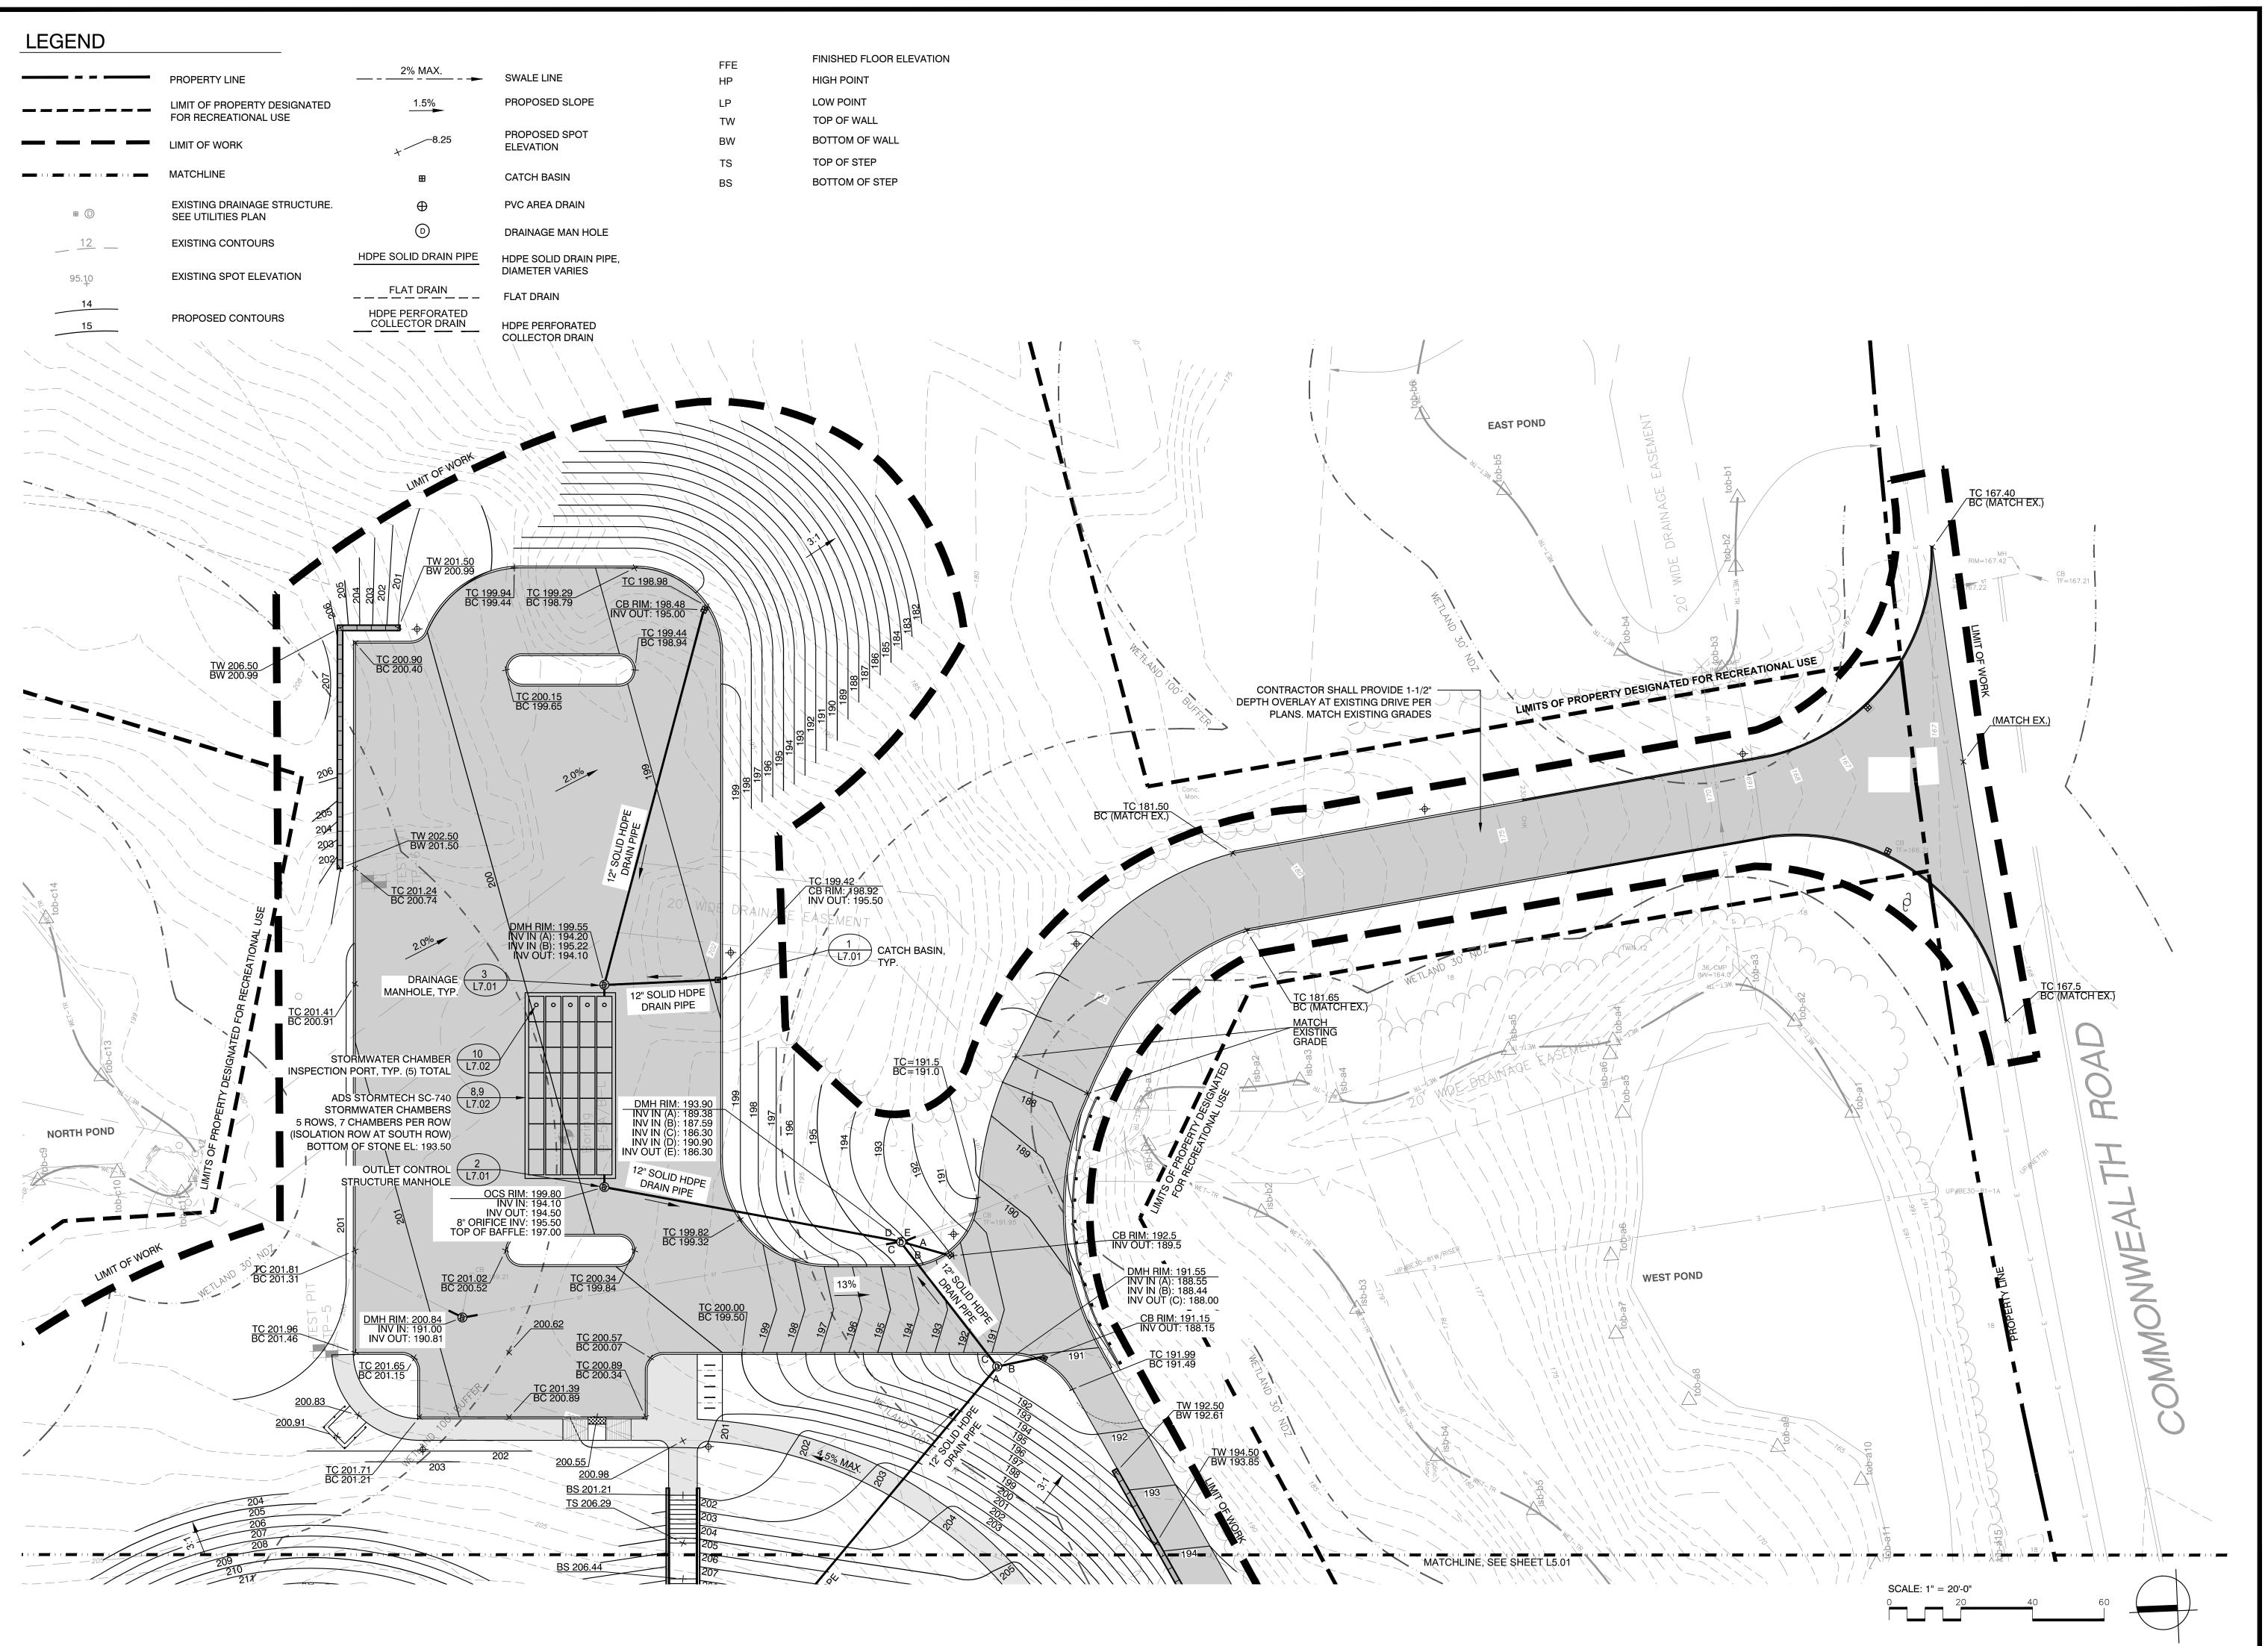Sheet Number:

L5.02




IMPROVEMENTS TO LOKER CONSERVATION AND RECREATION AREA

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OVERALL PLANTING




IMPROVEMENTS TO LOKER CONSERVATION AND RECREATION AREA 410 COMMONWEALTH RD, WAYLAND, MA 01778


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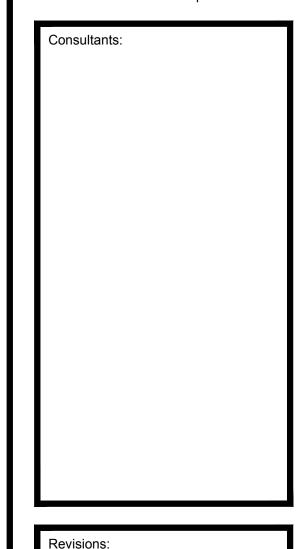
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Drawing Title: CONSTRUCTION **DETAILS**

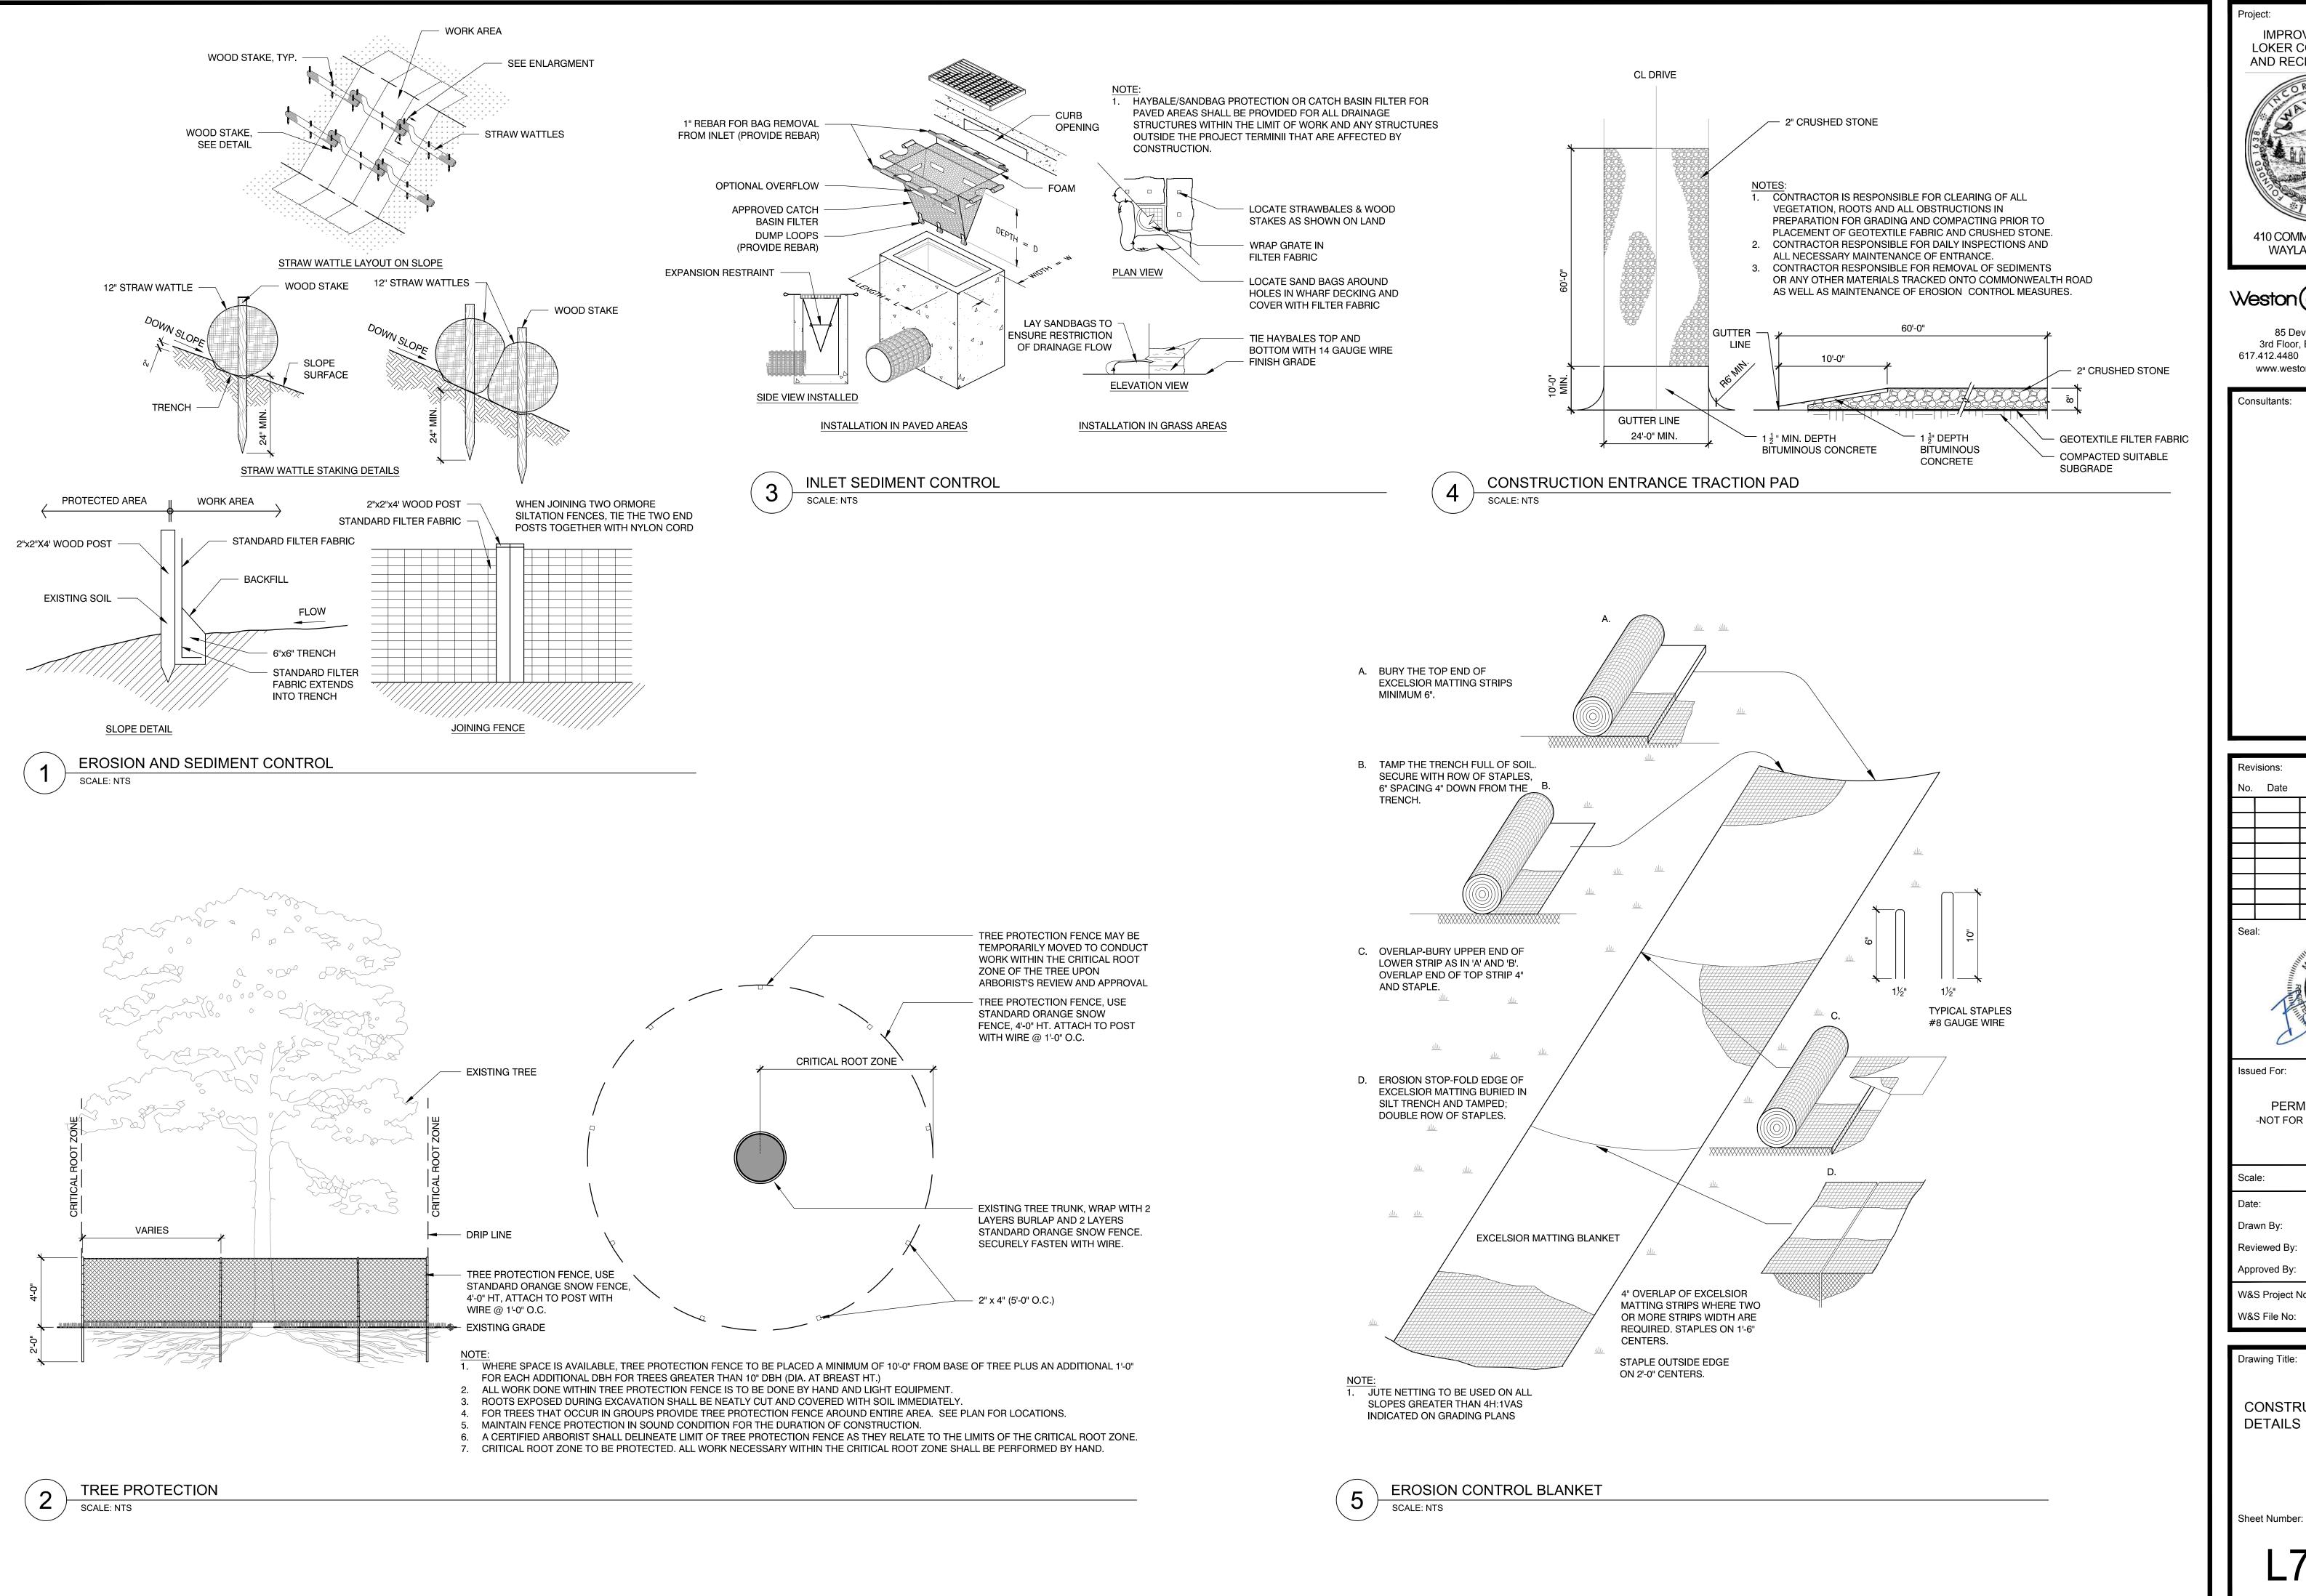



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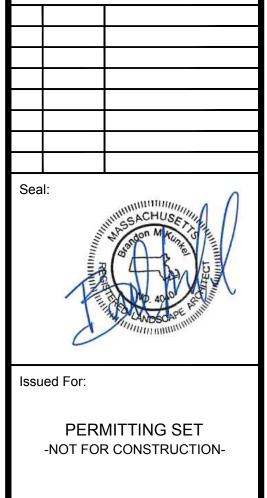
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Approved By: BMK

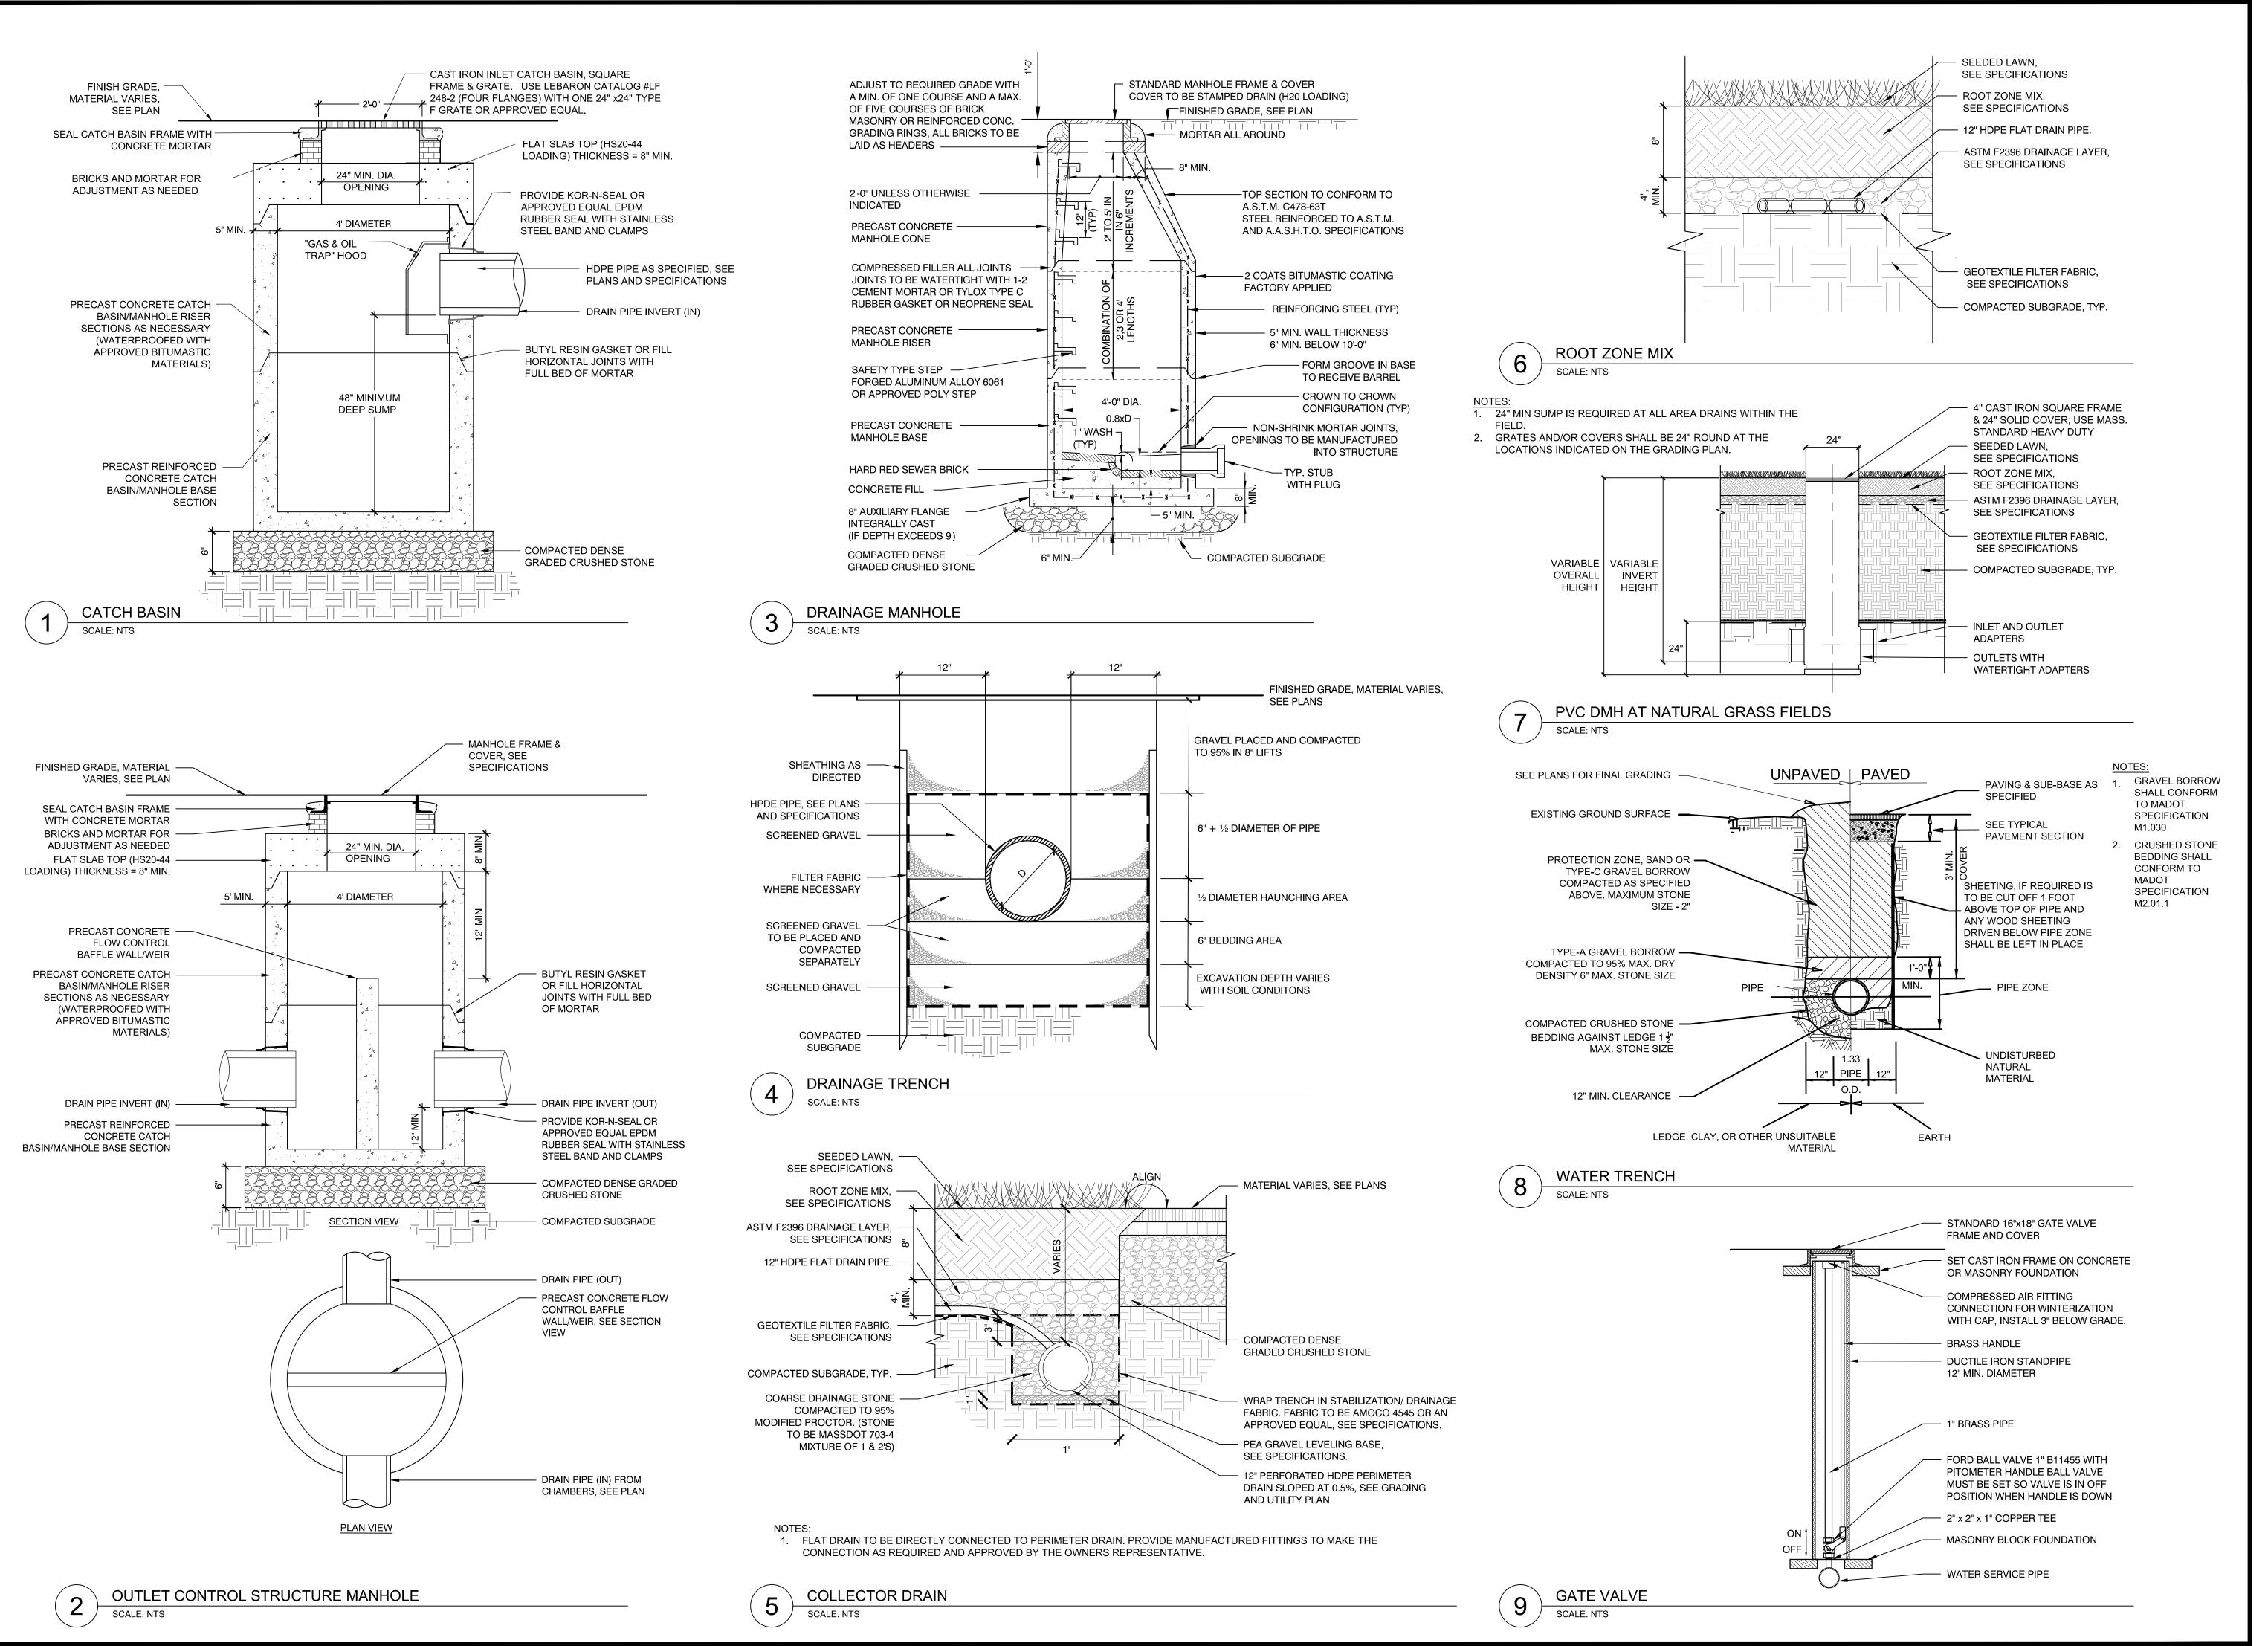W&S Project No: 2180076

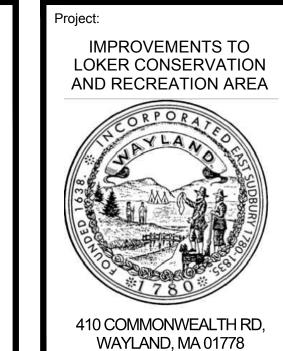

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FEBRUARY 18, 2022

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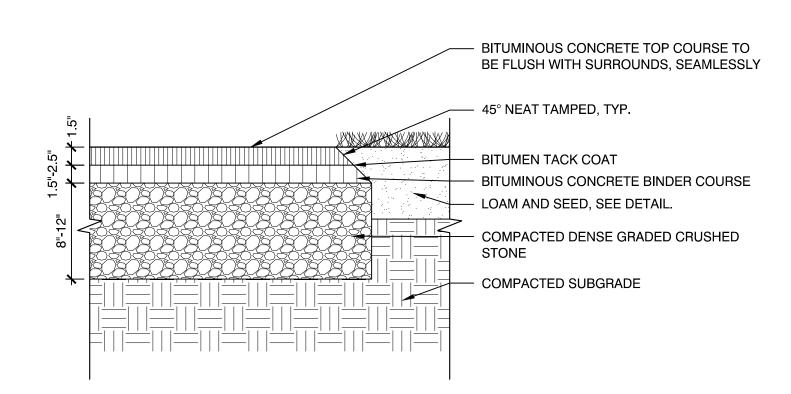
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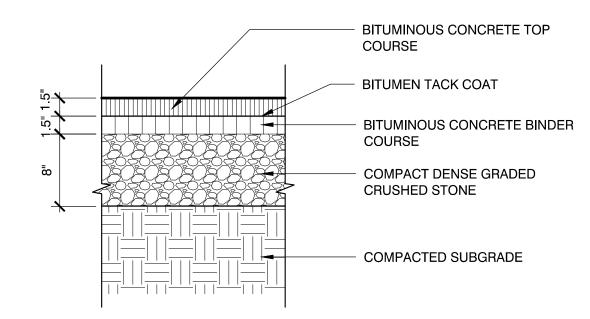
Drawing Title:

CONSTRUCTION
DETAILS

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1 BITUMINOUS CONCRETE AT LAWN SCALE: NTS



NOTES:

1. CONTRACTOR TO PROVIDE SMOOTH TRANSITION WHERE NEW PAVEMENT ABUTS EXISTING PAVEMENT.

PEDESTRIAN BITUMINOUS CONCRETE PAVEMENT

BITUMINOUS CONCRETE TOP COURSE

BITUMEN TACK COAT

BITUMINOUS CONCRETE BINDER COURSE

COMPACTED DENSE GRADED CRUSHED STONE


COMPACTED SUBGRADE

NOTES:

1. CONTRACTOR TO PROVIDE SMOOTH TRANSITION WHERE NEW PAVEMENT ABUTS EXISTING PAVEMENT, TYP.

VEHICULAR BITUMINOUS CONCRETE PAVEMENT


SCALE:NTS

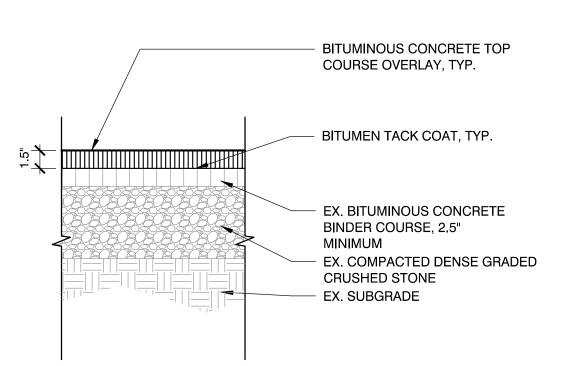

NOTES:
1. CONTRACTOR TO PROVIDE SMOOTH TRANSITION WHERE NEW PAVEMENT ABUTS EXISTING PAVEMENT, TYP.


BITUMINOUS CONCRETE PAVEMENT - TOP COURSE OVERLAY


SCALE: NTS

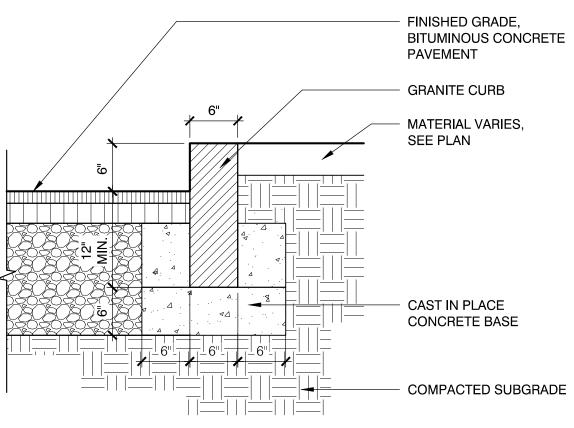

VERTICAL GRANITE CURB

SCALE: NTS

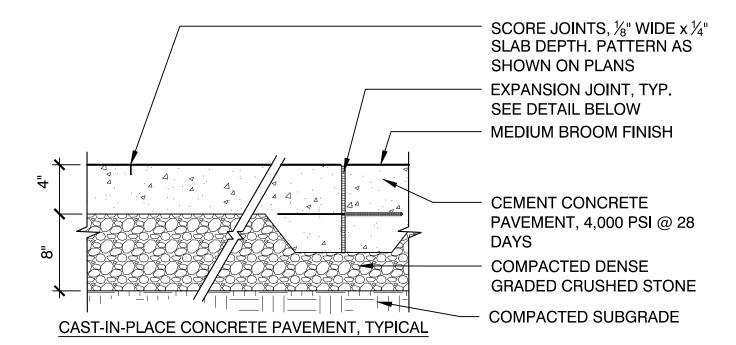

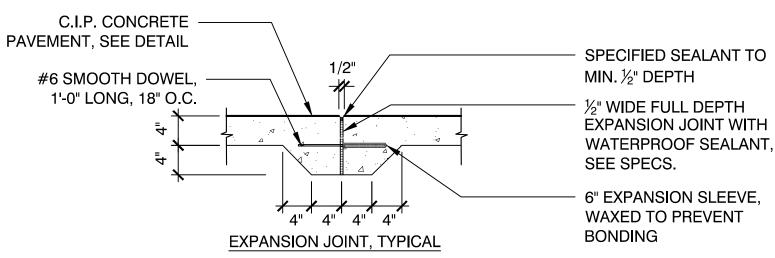


EXPANSION JOINT INSTALLATION NOTES:


- 1. DOWEL IS TYPICAL AT ALL EXPANSION JOINTS (18" O.C.) WITHIN CONCRETE PAVING AND
- BETWEEN NEW CONCRETE PAVING AND EXISTING CONCRETE PAVING TO REMAIN.

 2. DELETE EXPANSION SLEEVE AND DOWEL WHERE JOINT ABUTS WALL, CURBS, OR OTHER
- VERTICAL SURFACES, UNLESS OTHERWISE NOTED.
- EXPANSION JOINTS MAX. 25'-0" O.C. UNLESS SHOWN OTHERWISE.
 EXPANSIONS JOINTS SHALL BE PLACED WHERE NEW CEMENT CONCRETE PAVEMENT MEETS
- EXISTING PAVEMENT OR WALLS TO REMAIN.
- 5. ALL EXPANSION JOINTS SHALL BE SAW CUT

6 CONCRETE PAVEMENT

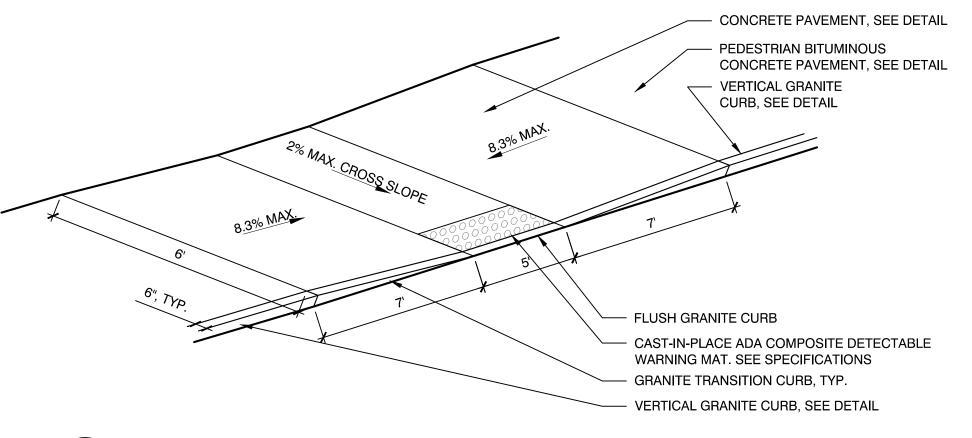

7 CURB RAMP WITH DETECTABLE WARNING MAT

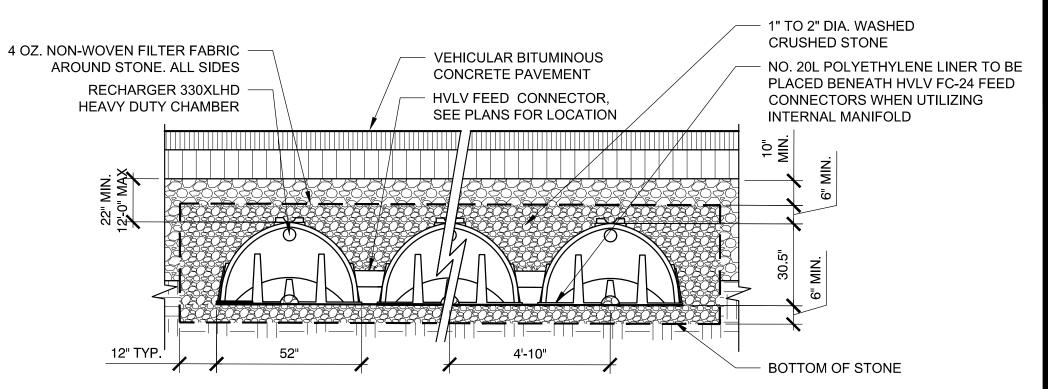


1. STORAGE PROVIDED = SEE PLANS.


2. CHAMBER SHALL BE INSTALLED PER MANUFACTURER'S REQUIREMENTS.

STORMWATER CHAMBER ISOLATION ROW

- USE 330XLHD HEAVY DUTY FOR TRAFFIC AND/OR H-25 APPLICATIONS OR APPROVED EQUAL. SEE SPECIFICATIONS.
 ALL UNITS SHALL BE MARKED WITH A COLOR STRIPE FORMED INTO THE PART ALONG THE LENGTH OF THE CHAMBER.
- 5. ALL CHAMBERS MUST BE INSTALLED IN ACCORDANCE WITH ALL APPLICABLE LOCAL, STATE AND FEDERAL REGULATIONS.
 6. PROVIDE ONE 6" INSPECTION PORT ON THE END OF EACH ROW PER MANUFACTURER DETAILS.



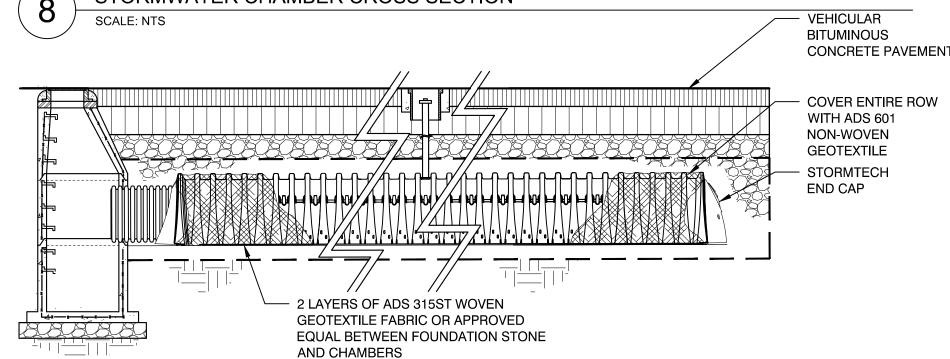


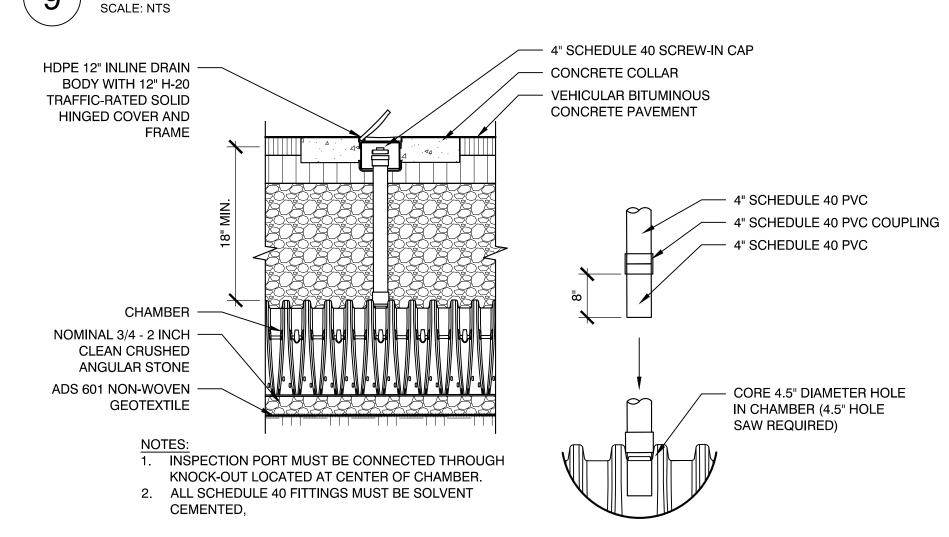

STORMWATER CHAMBER INSPECTION PORT

SCALE: NTS

SCALE: NTS

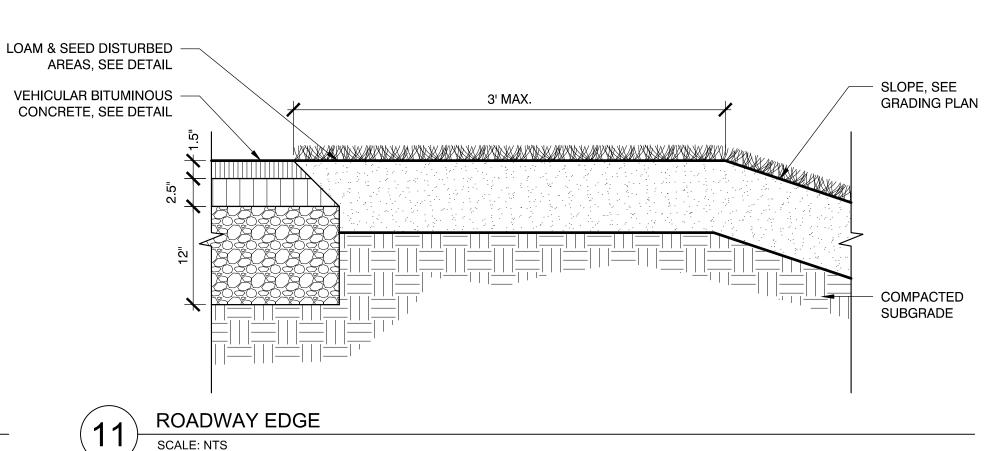


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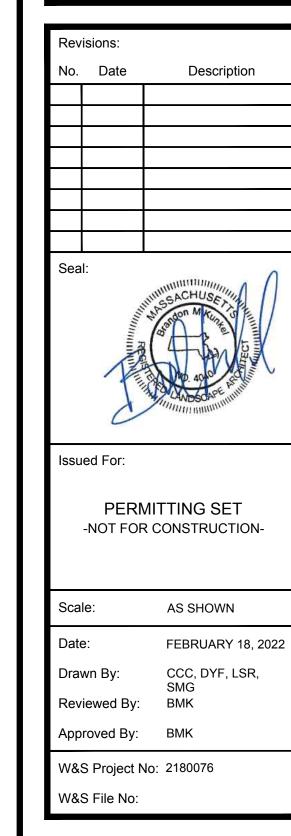
IMPROVEMENTS TO LOKER CONSERVATION AND RECREATION AREA

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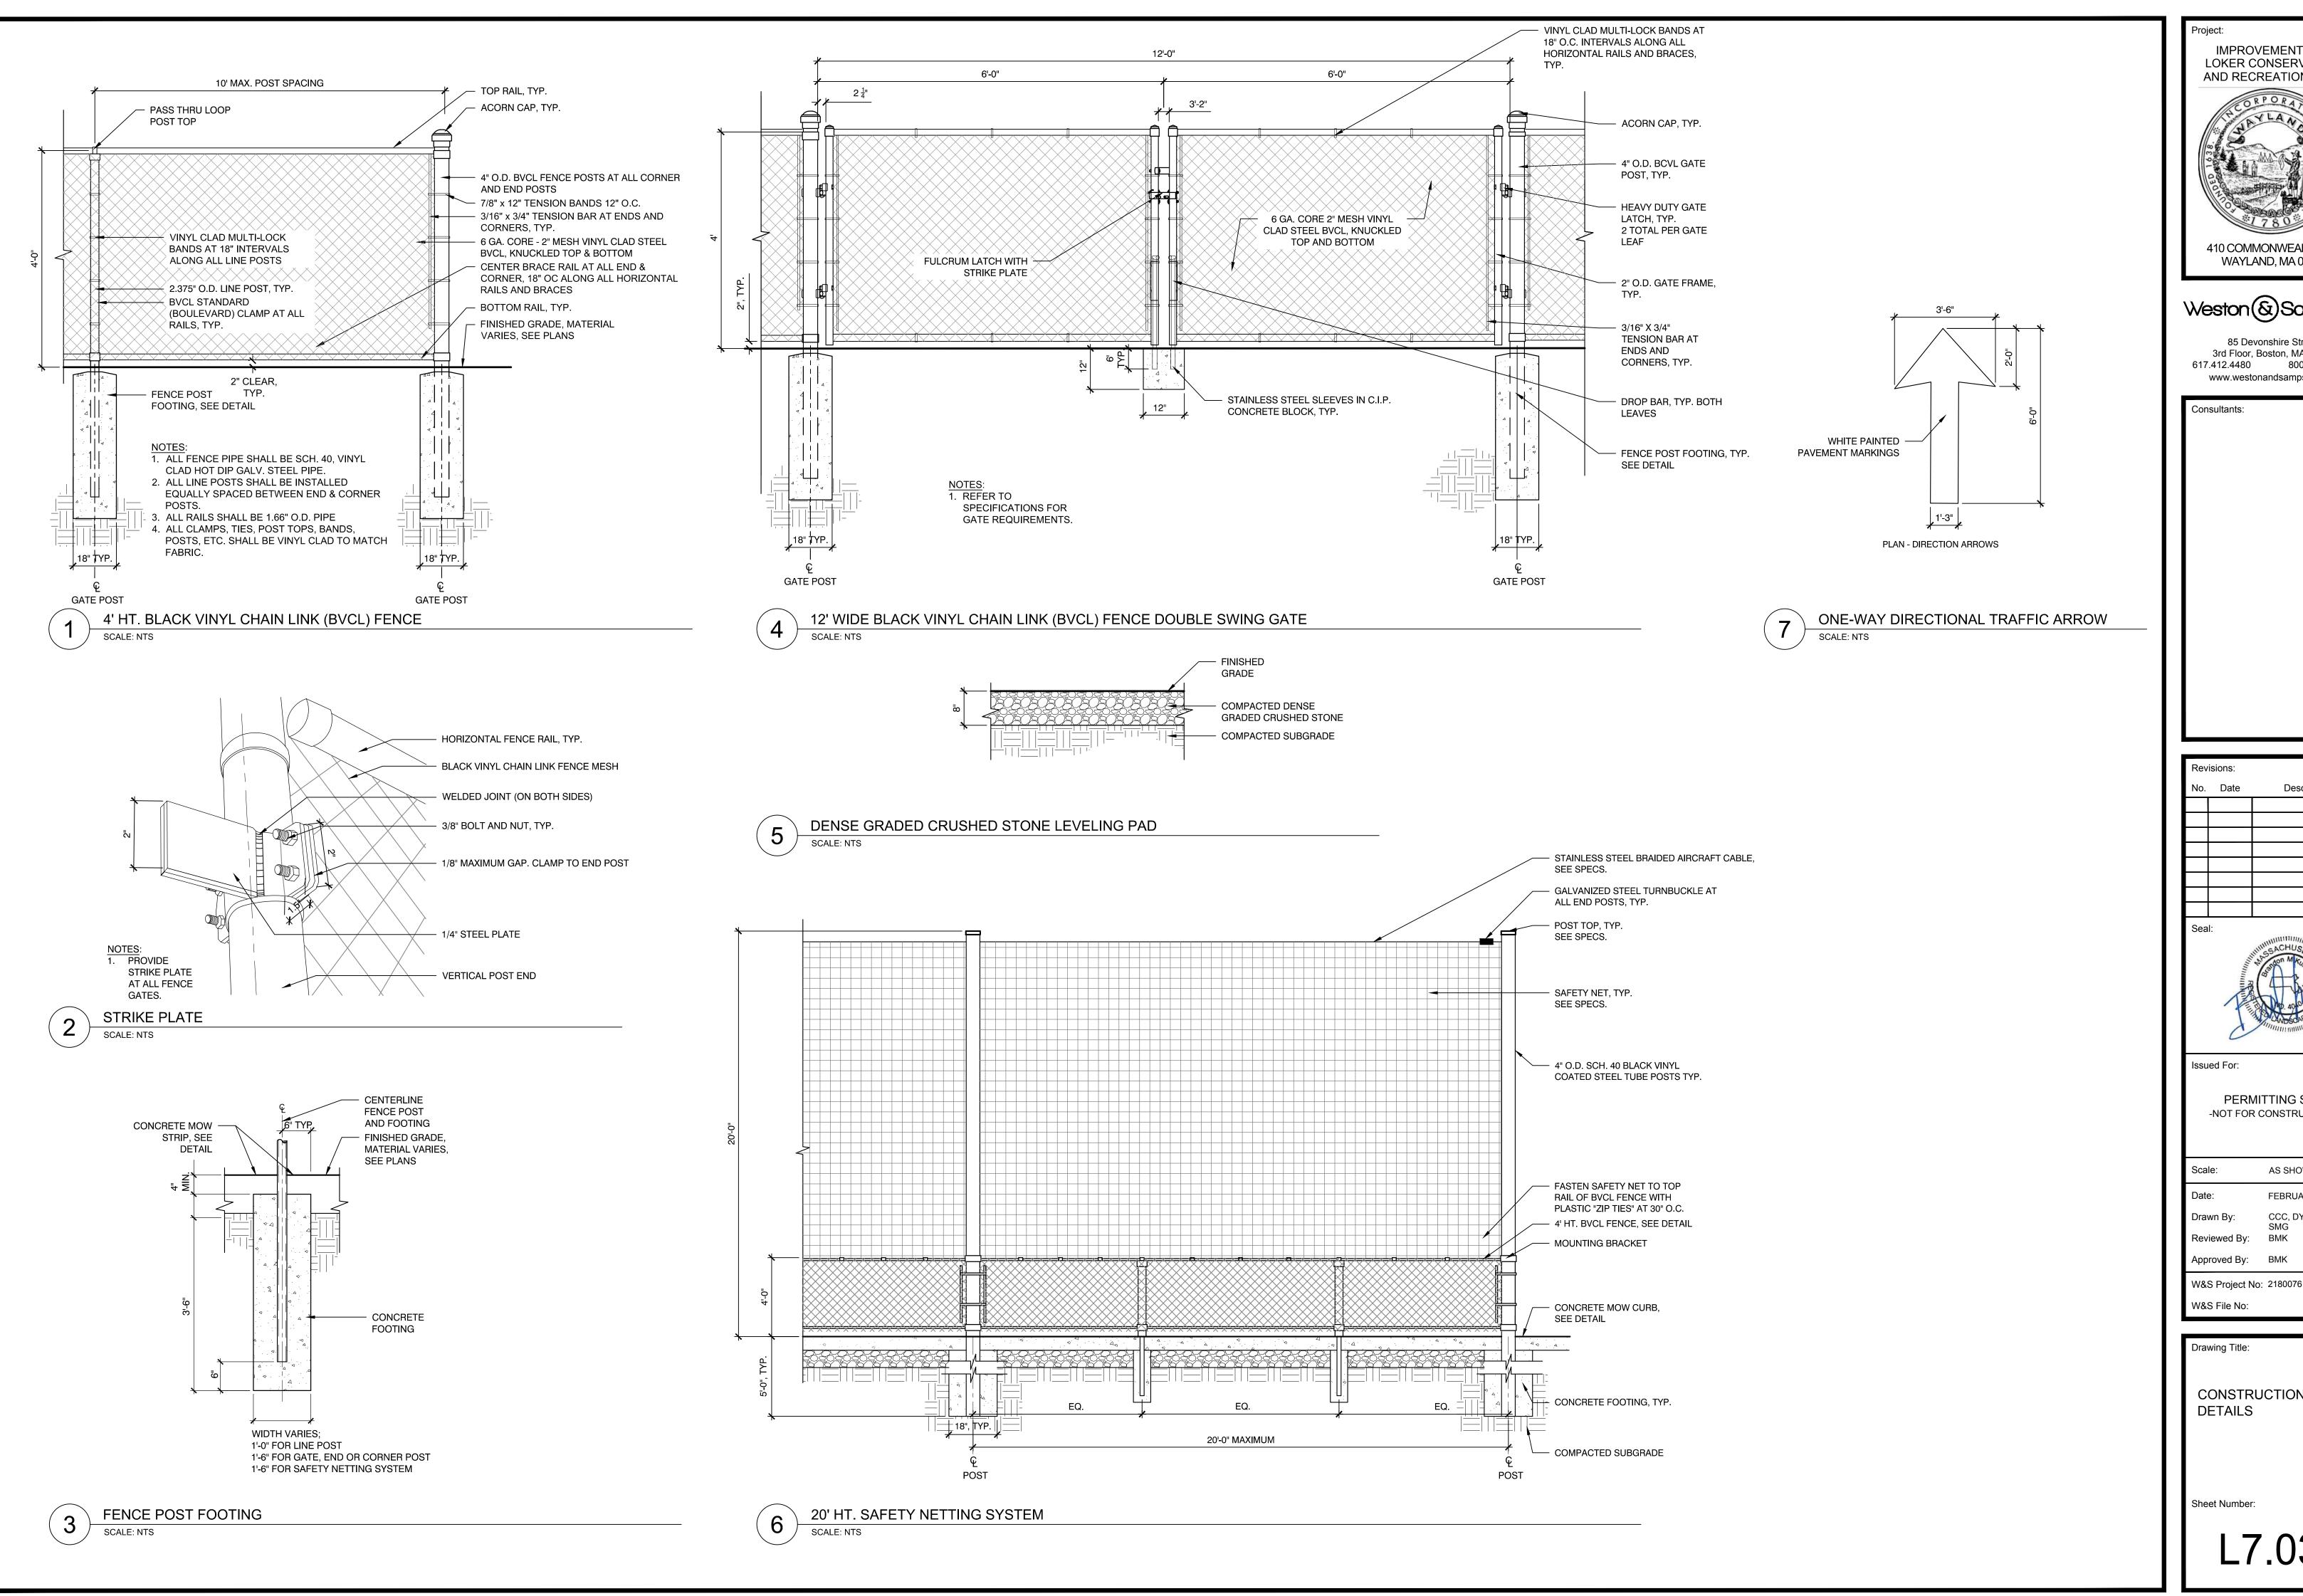




CONSTRUCTION
DETAILS

Sheet Number:
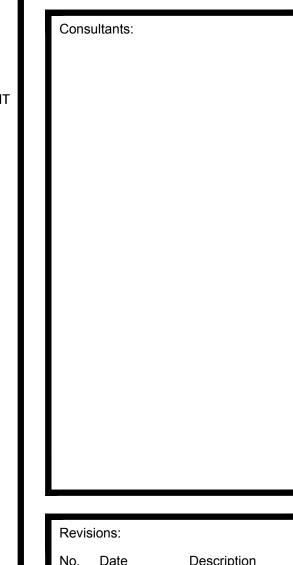
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IMPROVEMENTS TO LOKER CONSERVATION AND RECREATION AREA 410 COMMONWEALTH RD, WAYLAND, MA 01778


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	wn By:	CCC, DYF, LSR, SMG
Rev	iewed Bv:	BMK

Drawing Title: CONSTRUCTION **DETAILS**

Sheet Number:



SEGMENTAL BLOCK WALL —

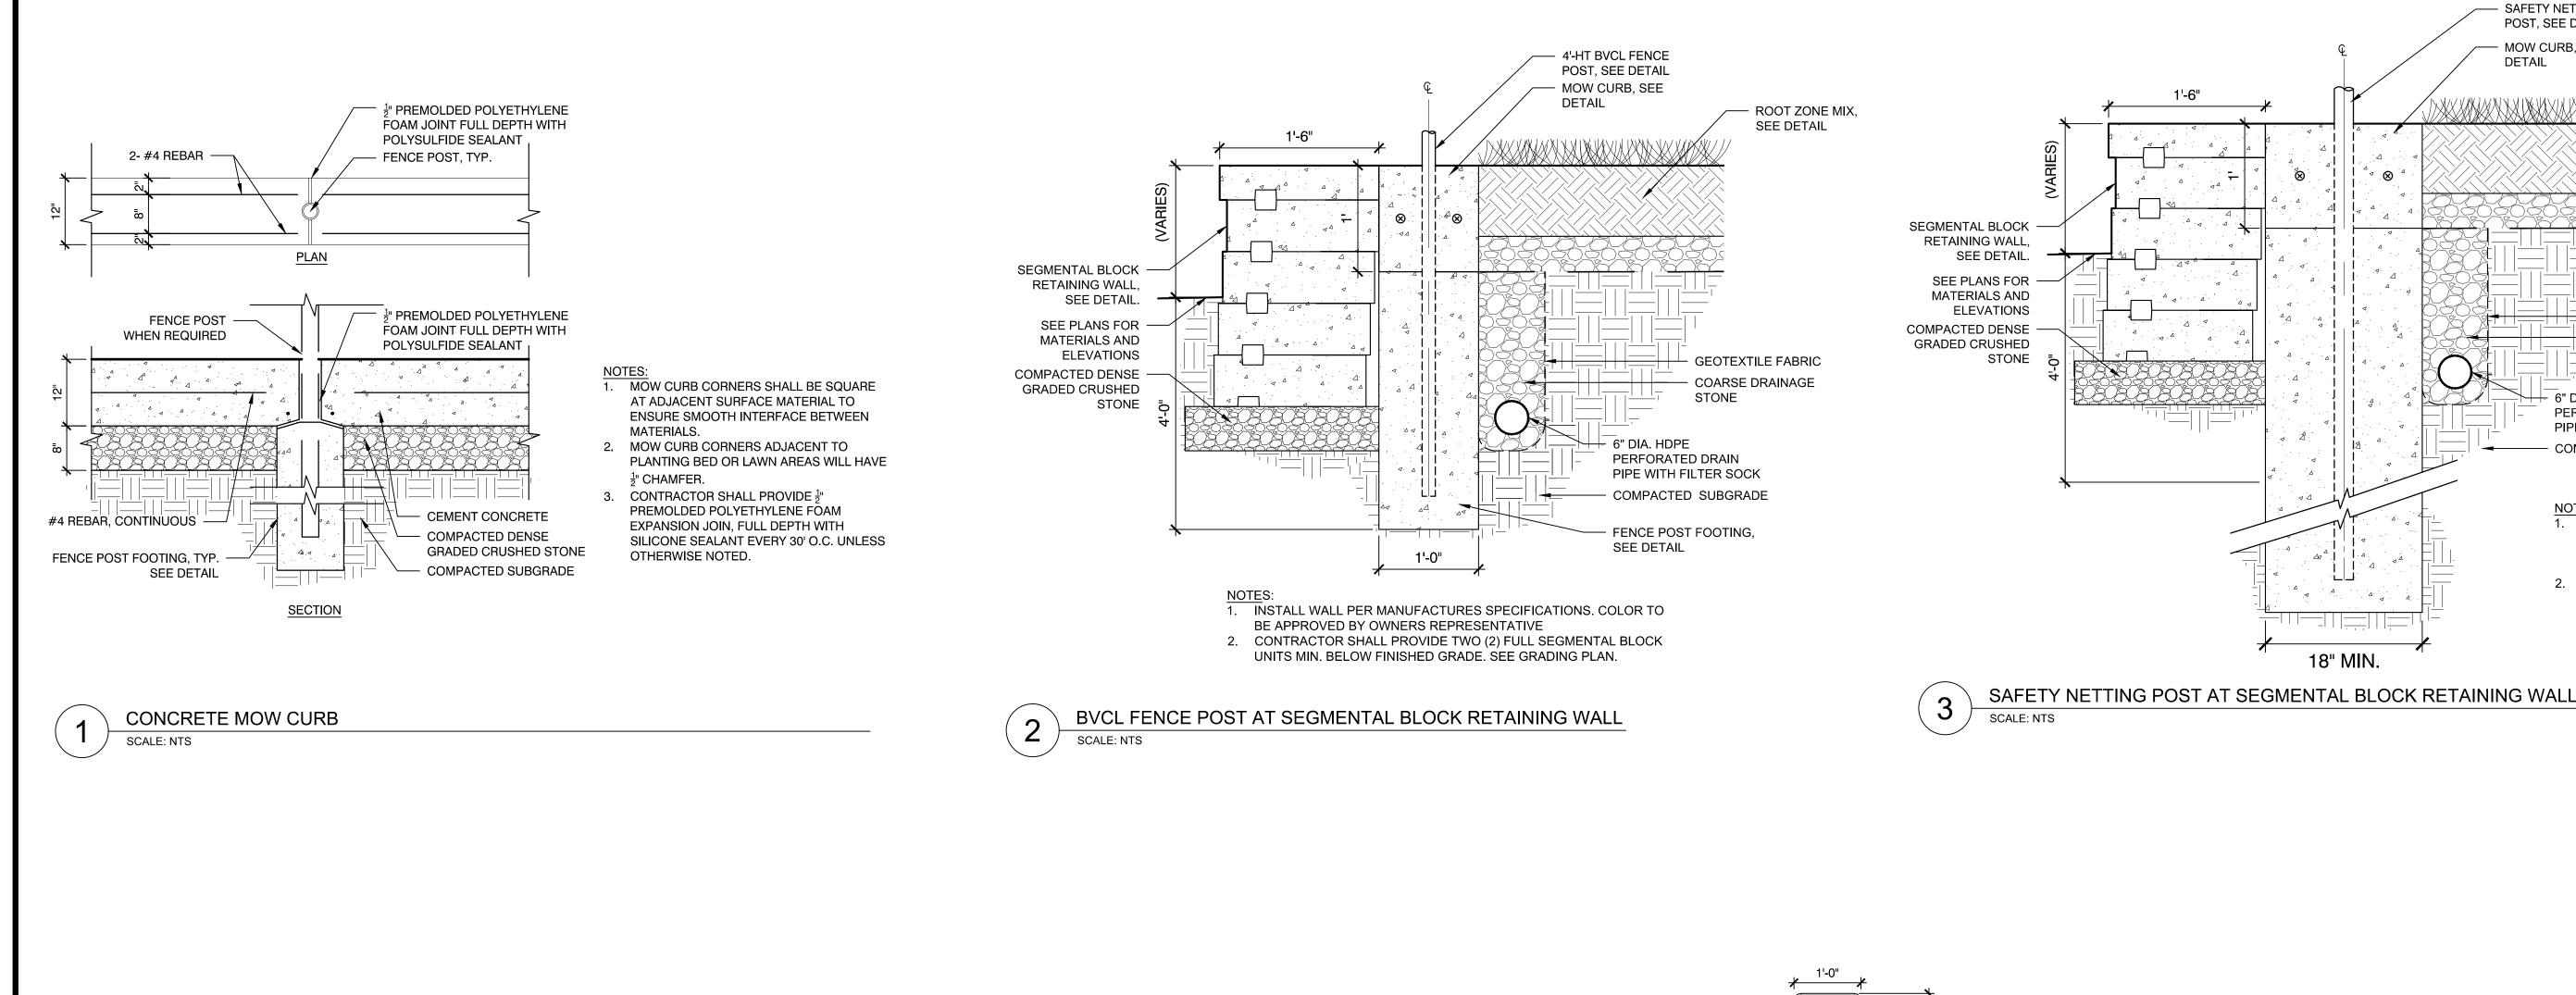SEE SPECIFICATIONS

PER MANUFACTURER'S

CONCRETE ---

PAVEMENT, TYP.

COMPACTED DENSE ---

SCALE: NTS

GRADED CRUSHED

ADHESIVE OR PINS -

REQUIREMENTS

20"

SEGMENTAL BLOCK RETAINING WALL

24" MIN.

- LOAM AND

SEED, SEE

STONE

- 6" DIA. HDPE

- GEOTEXTILE FABRIC

- COARSE DRAINAGE

PERFORATED DRAIN

- COMPACTED SUBGRADE

PIPE WITH FILTER SOCK

INSTALL WALL PER

REPRESENTATIVE

SPECIFICATIONS. COLOR TO BE APPROVED BY OWNERS

CONTRACTOR SHALL PROVIDE


TWO (2) FULL SEGMENTAL


BLOCK UNITS MIN. BELOW

FINISHED GRADE. SEE

GRADING PLAN.

MANUFACTURES

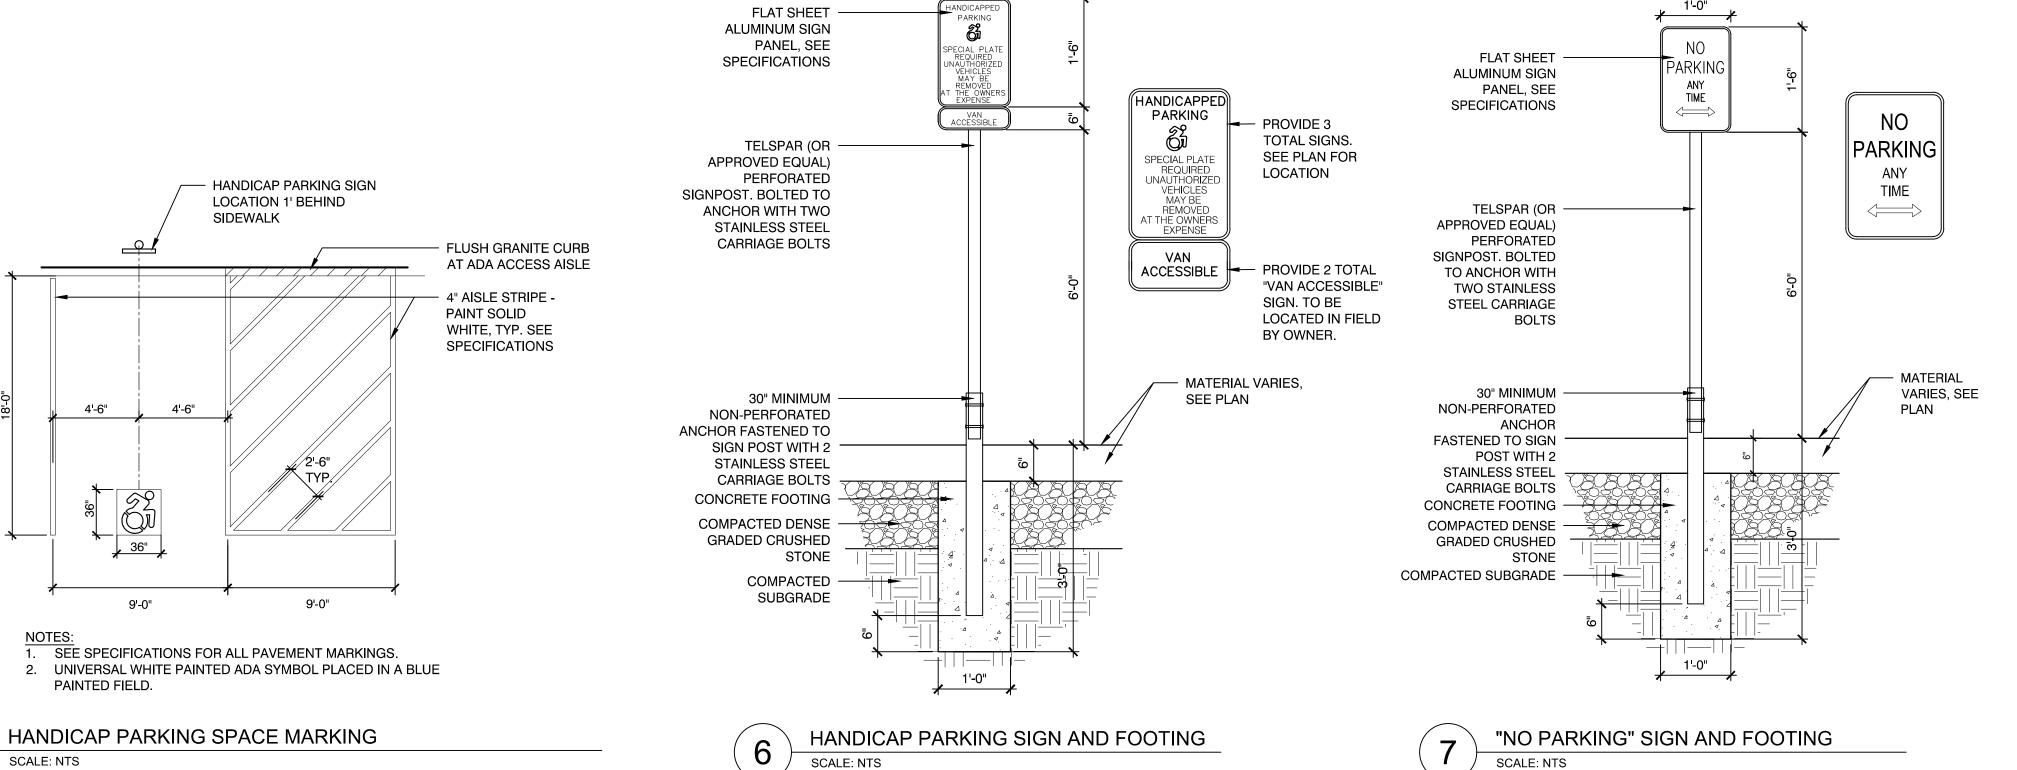

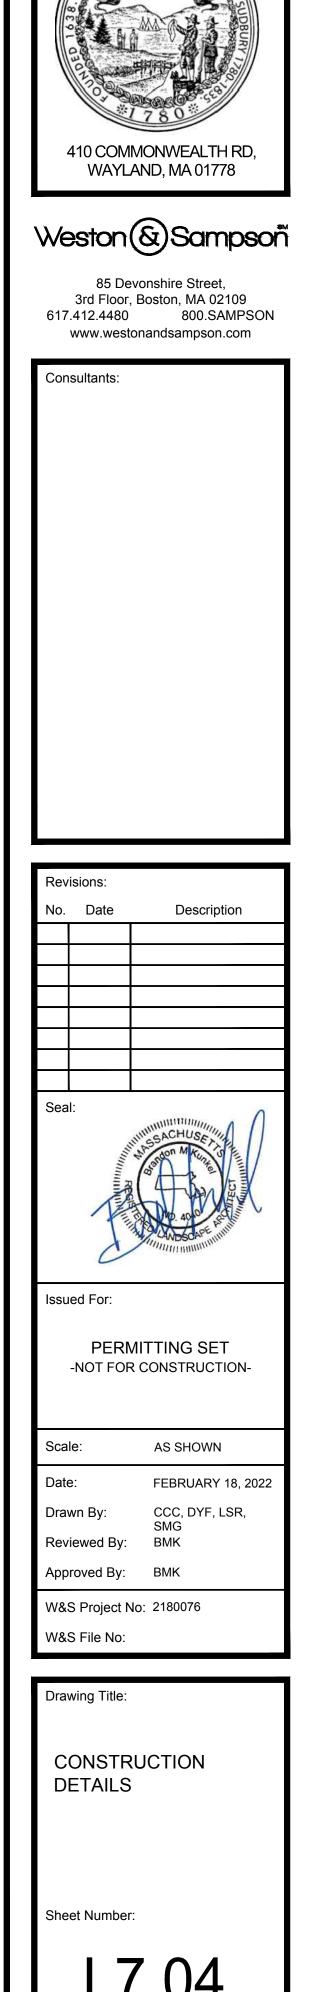

IMPROVEMENTS TO LOKER CONSERVATION AND RECREATION AREA

- SAFETY NETTING POST, SEE DETAIL

- MOW CURB, SEE

- ROOT ZONE MIX, SEE DETAIL

GEOTEXTILE FABRIC

STONE

1. INSTALL WALL PER MANUFACTURES

SPECIFICATIONS. COLOR TO BE

2. CONTRACTOR SHALL PROVIDE TWO (2) FULL SEGMENTAL BLOCK UNITS

MIN. BELOW FINISHED GRADE. SEE

APPROVED BY OWNERS

REPRESENTATIVE

GRADING PLAN.

COARSE DRAINAGE


- 6" DIA. HDPE

PERFORATED DRAIN

PIPE WITH FILTER SOCK


- COMPACTED SUBGRADE


DETAIL

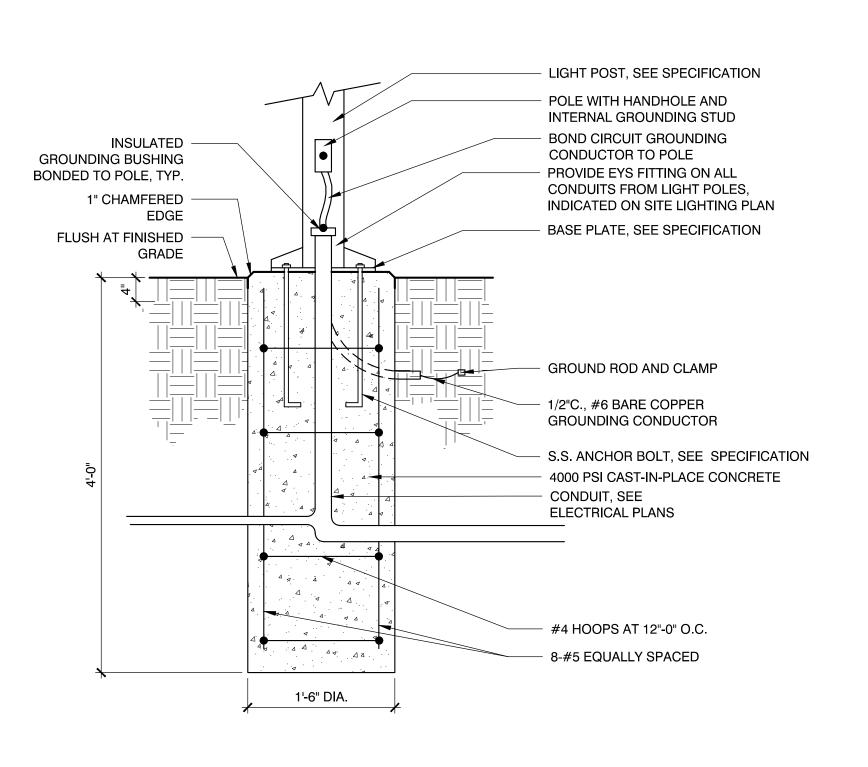


NOTES:

- 1. ELECTRICAL CONTRACTOR SHALL COORDINATE WITH THE GENERAL CONTRACTOR.
- ALL EXCAVATION, BACKFILL, & CONCRETE SHALL BE BY GENERAL CONTRACTOR.
- 2. REFER TO SPECIFICATIONS FOR MATERIALS.

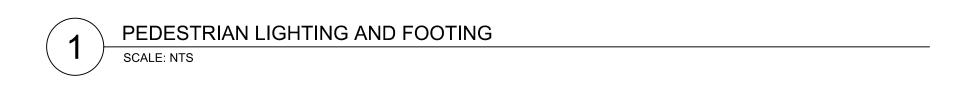

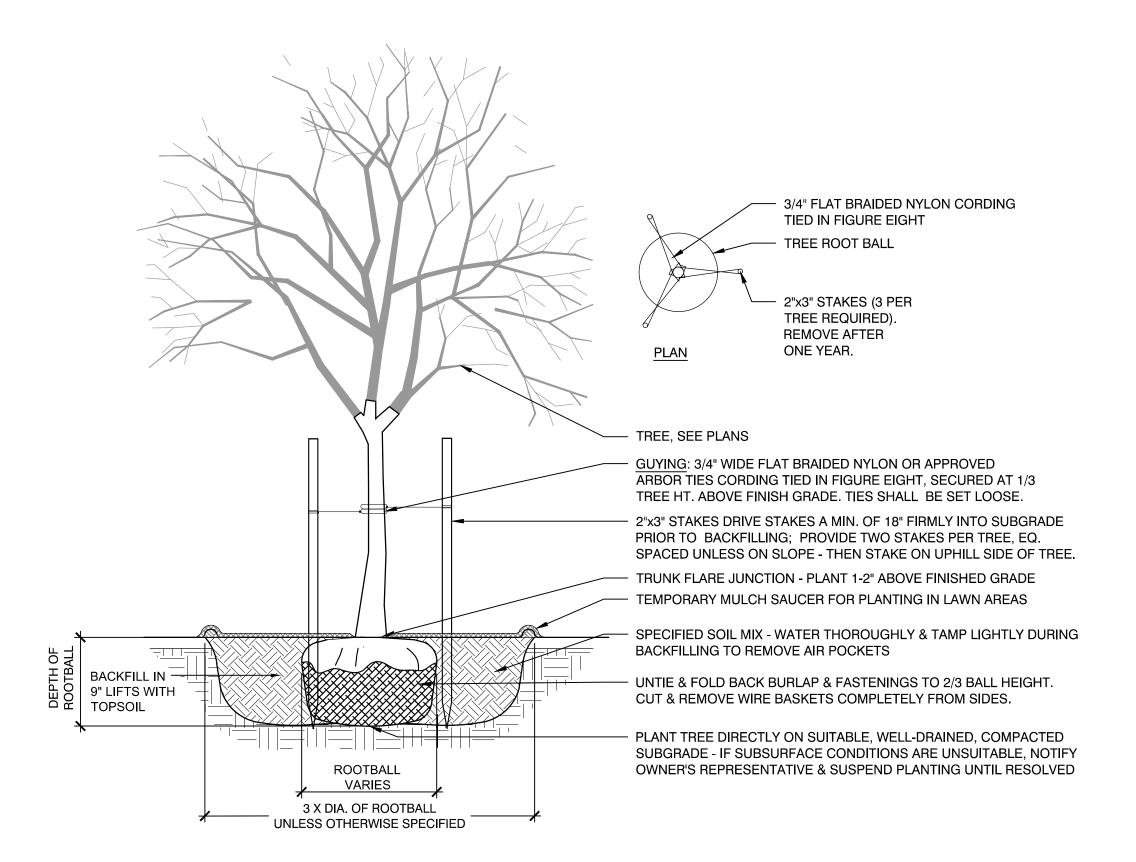

TREE STAKING AND PLANTING

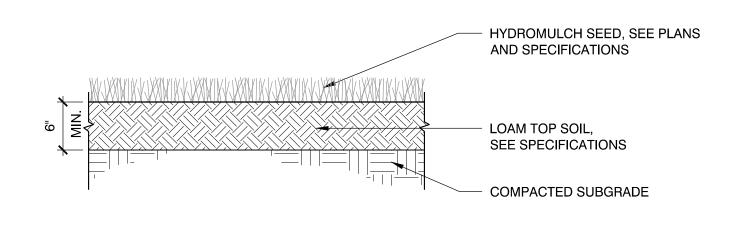


LOAM AND SEED


SCALE: NTS

SHRUB PLANTING

SCALE: NTS

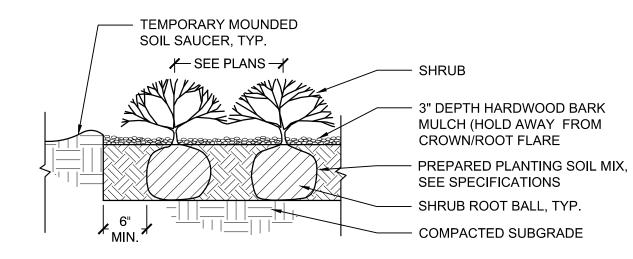

1. ALL MULCH MUST BE DARK IN COLOR. PROVIDE SAMPLE PRIOR TO INSTALLATION TO BE APPROVED BY OWNER'S REPRESENTATIVE.

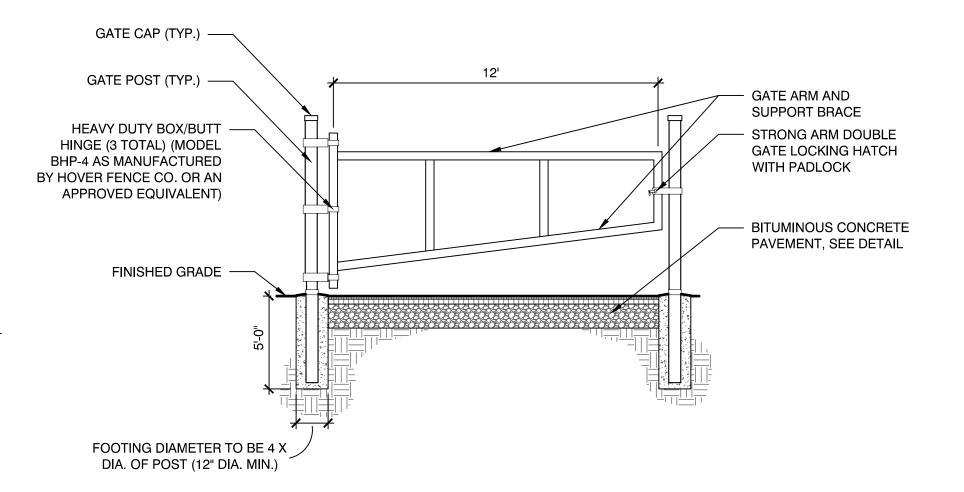


SCHEDULE 40 GALVANIZED STEEL, SIX (6) INCH DIA. GATE ARM AND SUPPORT BRACE: SCHEDULE 40 GALVANIZED STEEL FOUR (4) INCH DIA.

HEAVY DUTY GALVANIZED STEEL CONCRETE FOOTING: NORMAL WEIGHT CONCRETE AIR ENTRAINED WITH NOT LESS THAN 4,500 PSI COMPRESSIVE STRENGTH (28 DAYS), THREE (3) INCH SLUMP, AND ONE (1) INCH MAXIMUM SIZE AGGREGATE.

1. THE CONTRACTOR SHALL PROVIDE ALL GATE COMPONENTS. HARDWARE, ETC. FOR THE COMPLETE INSTALLATION OF THE NEW GATE. INSTALL IN STRICT COMPLIANCE WITH THE MANUFACTURER'S WRITTEN RECOMMENDATIONS AND SPECIFICATIONS. ALL MATERIALS SHALL BE HEAVY DUTY RATED AND APPROVED BY THE ENGINEER PRIOR TO INSTALLATION. ALL HARDWARE SHALL INSTALLED SO THAT THE GATE IS STRUCTURALLY SOUND AND DOES NOT SAG IN THE OPEN AND/OR CLOSED POSITION. COORDINATE LAYOUT AND LOCATION IN THE FIELD WITH THE ENGINEER PRIOR TO INSTALLATION.

VEHICLE SWING GATE SCALE: NTS

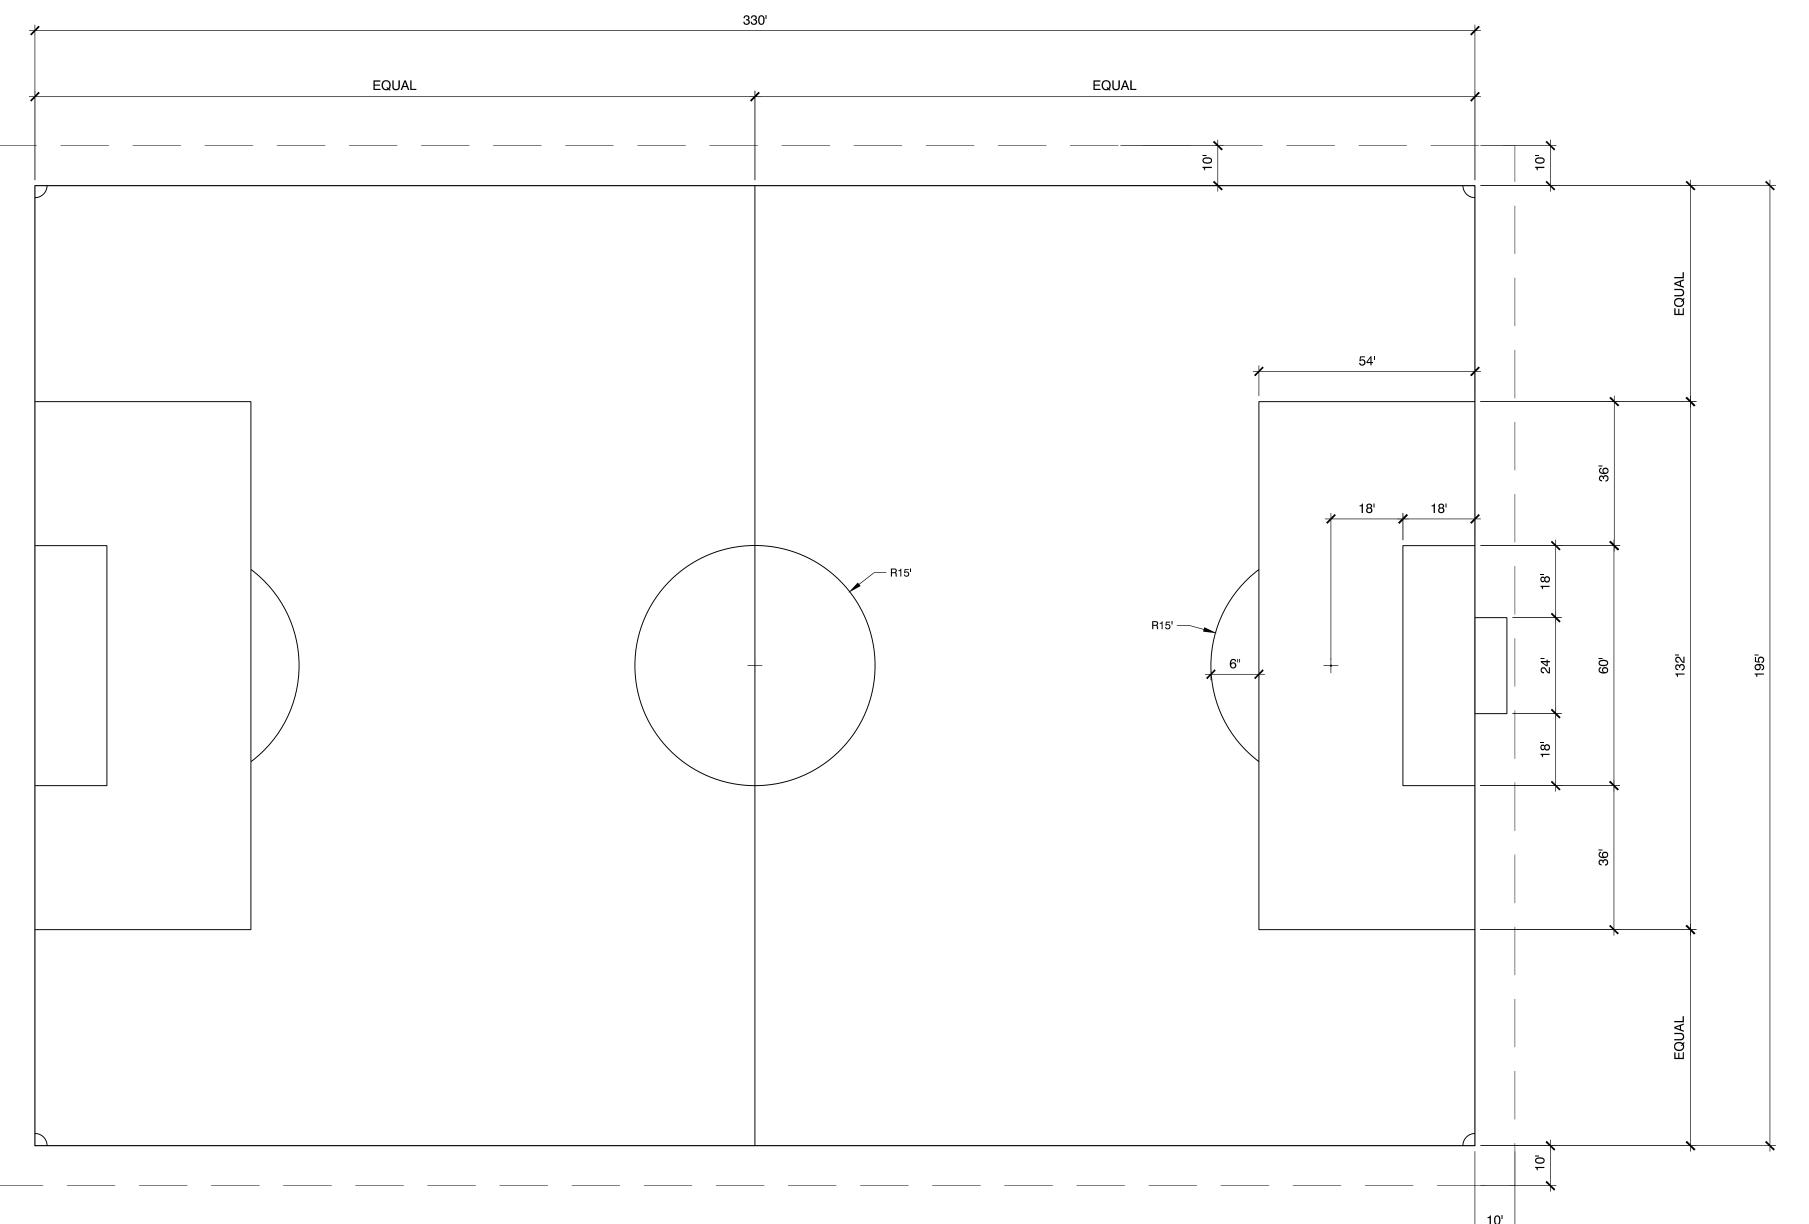

SOCCER STRIPING LAYOUT

IMPROVEMENTS TO LOKER CONSERVATION AND RECREATION AREA 410 COMMONWEALTH RD, WAYLAND, MA 01778


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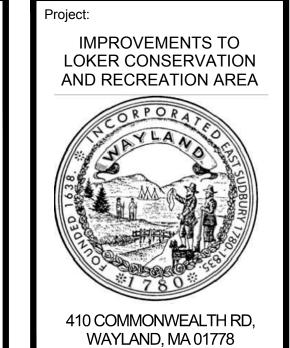
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Drawing Title: CONSTRUCTION DETAILS


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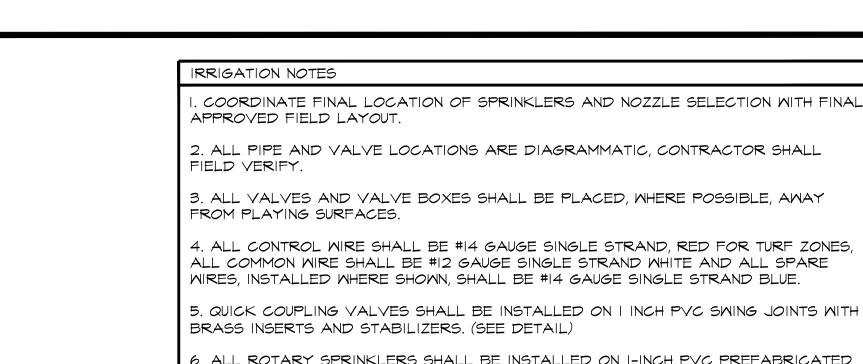


CONSTRUCTION
DETAILS

W&S File No:

Sheet Number:

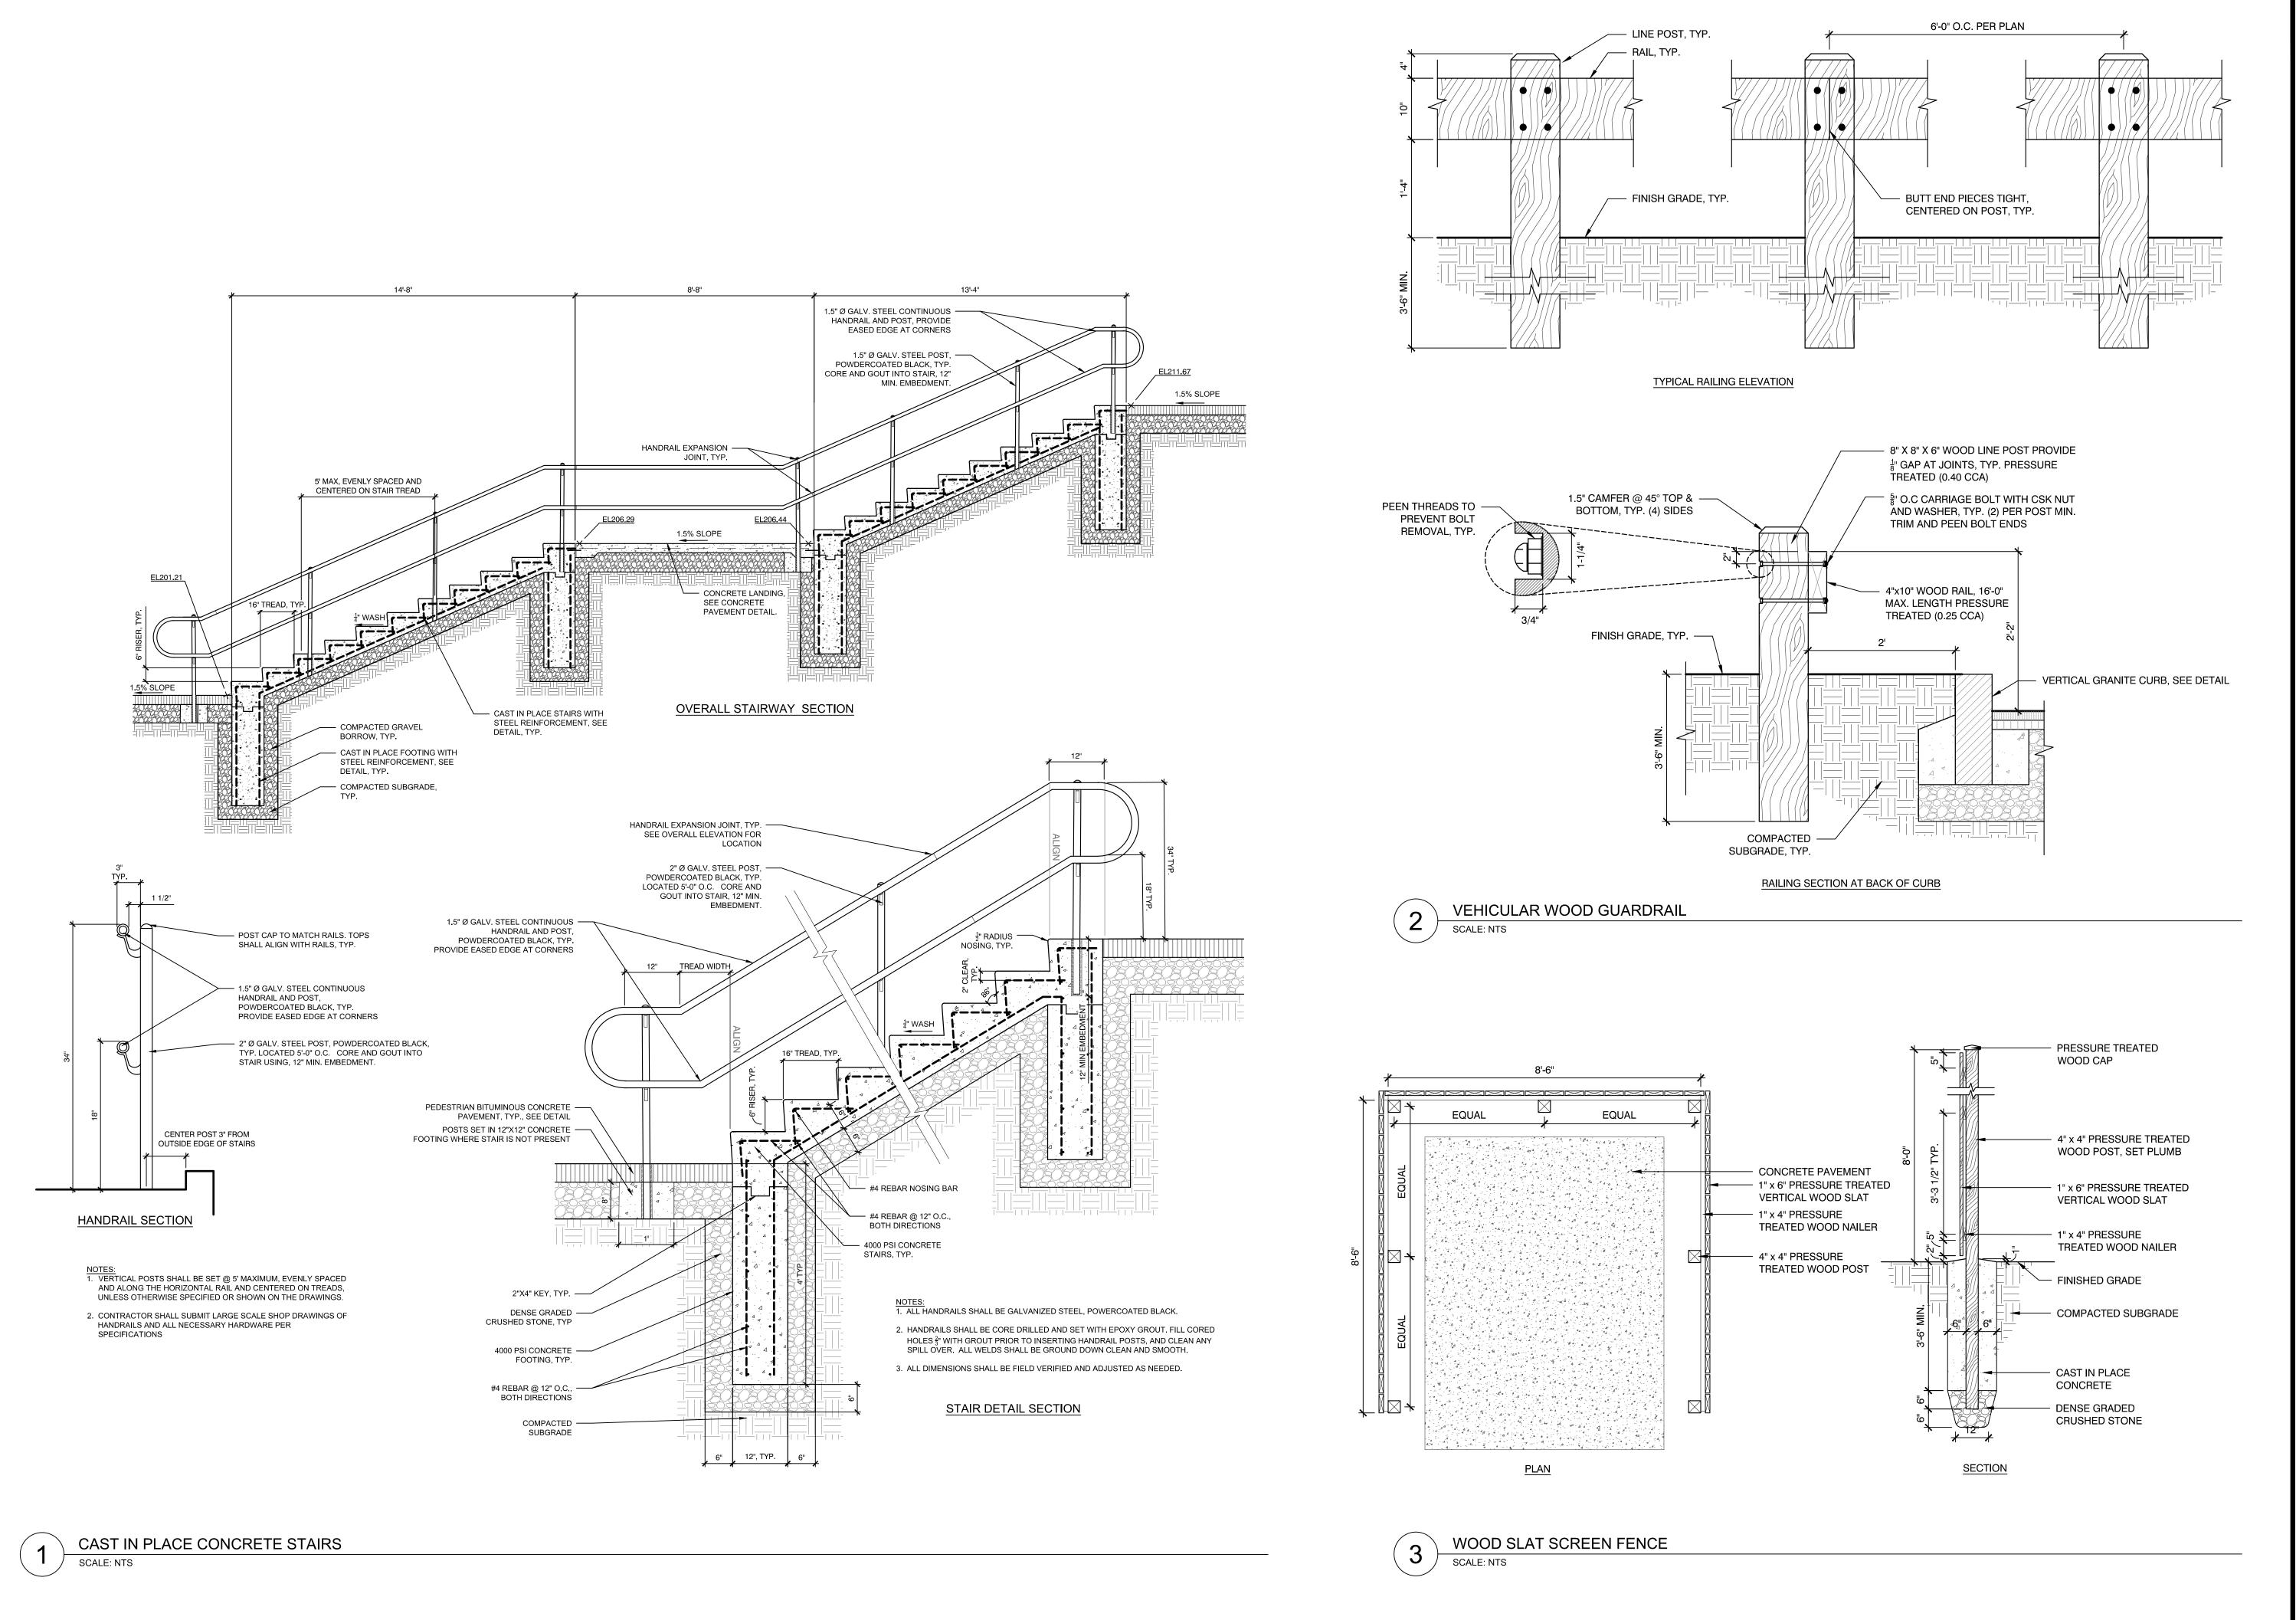1706

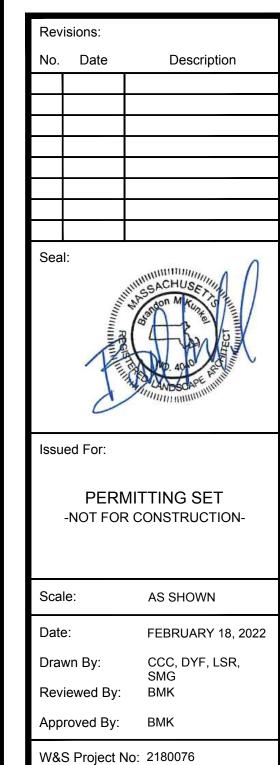

6. ALL ROTARY SPRINKLERS SHALL BE INSTALLED ON I-INCH PVC PREFABRICATED UNITIZED SWING JOINT ASSEMBLIES WITH INTEGRAL O-RINGS.

1. IRRIGATION SYSTEM IS DESIGNED FOR SEPARATE WATER SUPPLY TO PROVIDE 47 GPM MAX FROM EXISTING 4-INCH SERVICE. SYSTEM TO PRODUCE 75-PSI DYNAMIC PRESSURE AT IRRIGATION CONTRACTOR'S POINT OF CONNECTION IN LANDSCAPED

8. CONTRACTOR SHALL TEST DYNAMIC PRESSURE BEFORE STARTING WORK, REPORT ANY DEVIATION FROM PRESSURE REQUIRED TO OWNER'S REPRESENTATIVE BEFORE CONTINUING.

IRRIGATION NOTES

9. INSTALL CONTROLLER IN ENCLOSURE, GENERALLY WHERE SHOWN ON THE DRAWINGS, HARD WIRE TO 120 VOLT, DEDICATED 20 AMP CIRCUIT, POWER SUPPLY USING LICENSED ELECTRICIAN. ROUTE ALL ZONE AND SPARE WIRES TO CONTROLLER VIA CONDUIT THROUGH ENCLOSURE BASE.

10. INSTALL RAIN SENSOR ON OUTSIDE OF CONTROLLER ENCLOSURE. ROUTE RAIN SENSOR WIRING TO CONTROLLER THROUGH ENCLOSURE WALL.

I. COORDINATE LOCATION OF ALL EXISTING AND FUTURE UTILITIES ON SITE AND CONTACT PROPER AUTHORITIES AND UTILITY COMPANIES BEFORE THE START OF

12. FLUSH ALL LATERAL LINES BEFORE INSTALLING SPRINKLERS.

13. CONTRACTOR MUST SUBMIT SHOP PRODUCT DRAWINGS AS PER THE WRITTEN SPECIFICATIONS TO THE IRRIGATION CONSULTANT FOR APPROVAL PRIOR TO ORDERING MATERIAL AND BEGINNING WORK.


14. ANY AND ALL MATERIAL SUBSTITUTIONS WHICH VARY FROM THE SPECIFIED PRODUCTS MUST BE SUBMITTED TO THE IRRIGATION CONSULTANT FOR APPROVAL AS PART OF THE SUBMITTAL PROCESS.

15. ONCE APPROVED SUBMITTALS HAVE BEEN RETURNED TO THE CONTRACTOR, WORK MAY BEGIN. THE IRRIGATION CONSULTANT MUST BE NOTIFIED A MINIMUM OF 7-DAYS IN ADVANCE OF THE START OF WORK TO COORDINATE ON-SITE SUPERVISION AND ADMINISTRATION.


16. SEE IRRIGATION DETAILS AND SPECIFICATIONS SECTION FOR ADDITIONAL NECESSARY INFORMATION.

IRRIGATION LEGEND				
SYMBOL	PSI	SPACING	DESCRIPTION	
	60 60	55 ⁻ 45 ⁻	LARGE ROTARY SPRINKLER WITH CHECK VALVE (STANDARD NOZZLES)	
•			CTRIC ZONE VALVE DESIGNATOR FOR FLOW AND SIZES)	
H	150	ISOLATION GATE VALVE (MAINLINE SIZE)		
	I" QUICK COUPLING VALVE			
	CLASS-200 PVC LATERAL PIPING (SIZE AS INDICATED)			
	CLASS-200 PVC MAINLINE PIPING (SIZE AS INDICATED)			
A	AUTOMATIC CONTROLLER IN PEDESTAL			
R	AUTOMATIC RAIN SENSOR			


IRRIGATION LEG	IRRIGATION LEGEND		
SYMBOL	DESCRIPTION		
Θ	IRRIGATION WATER METER		
₿	BACK FLOW PREVENTION DEVICE		
•	BRONZE GATE VALVE FOR CONTROL VALVES (CONTROL VALVE SIZE)		
	2" DRAIN VALVE		
•	2" CURB STOP		
VALVE DESIGN	ATION:		
	STATION NO.		
A 20	FLOW		

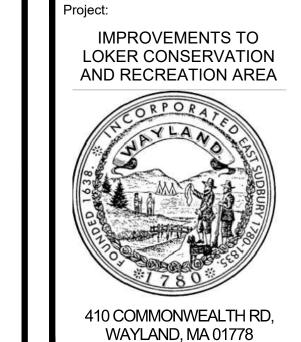

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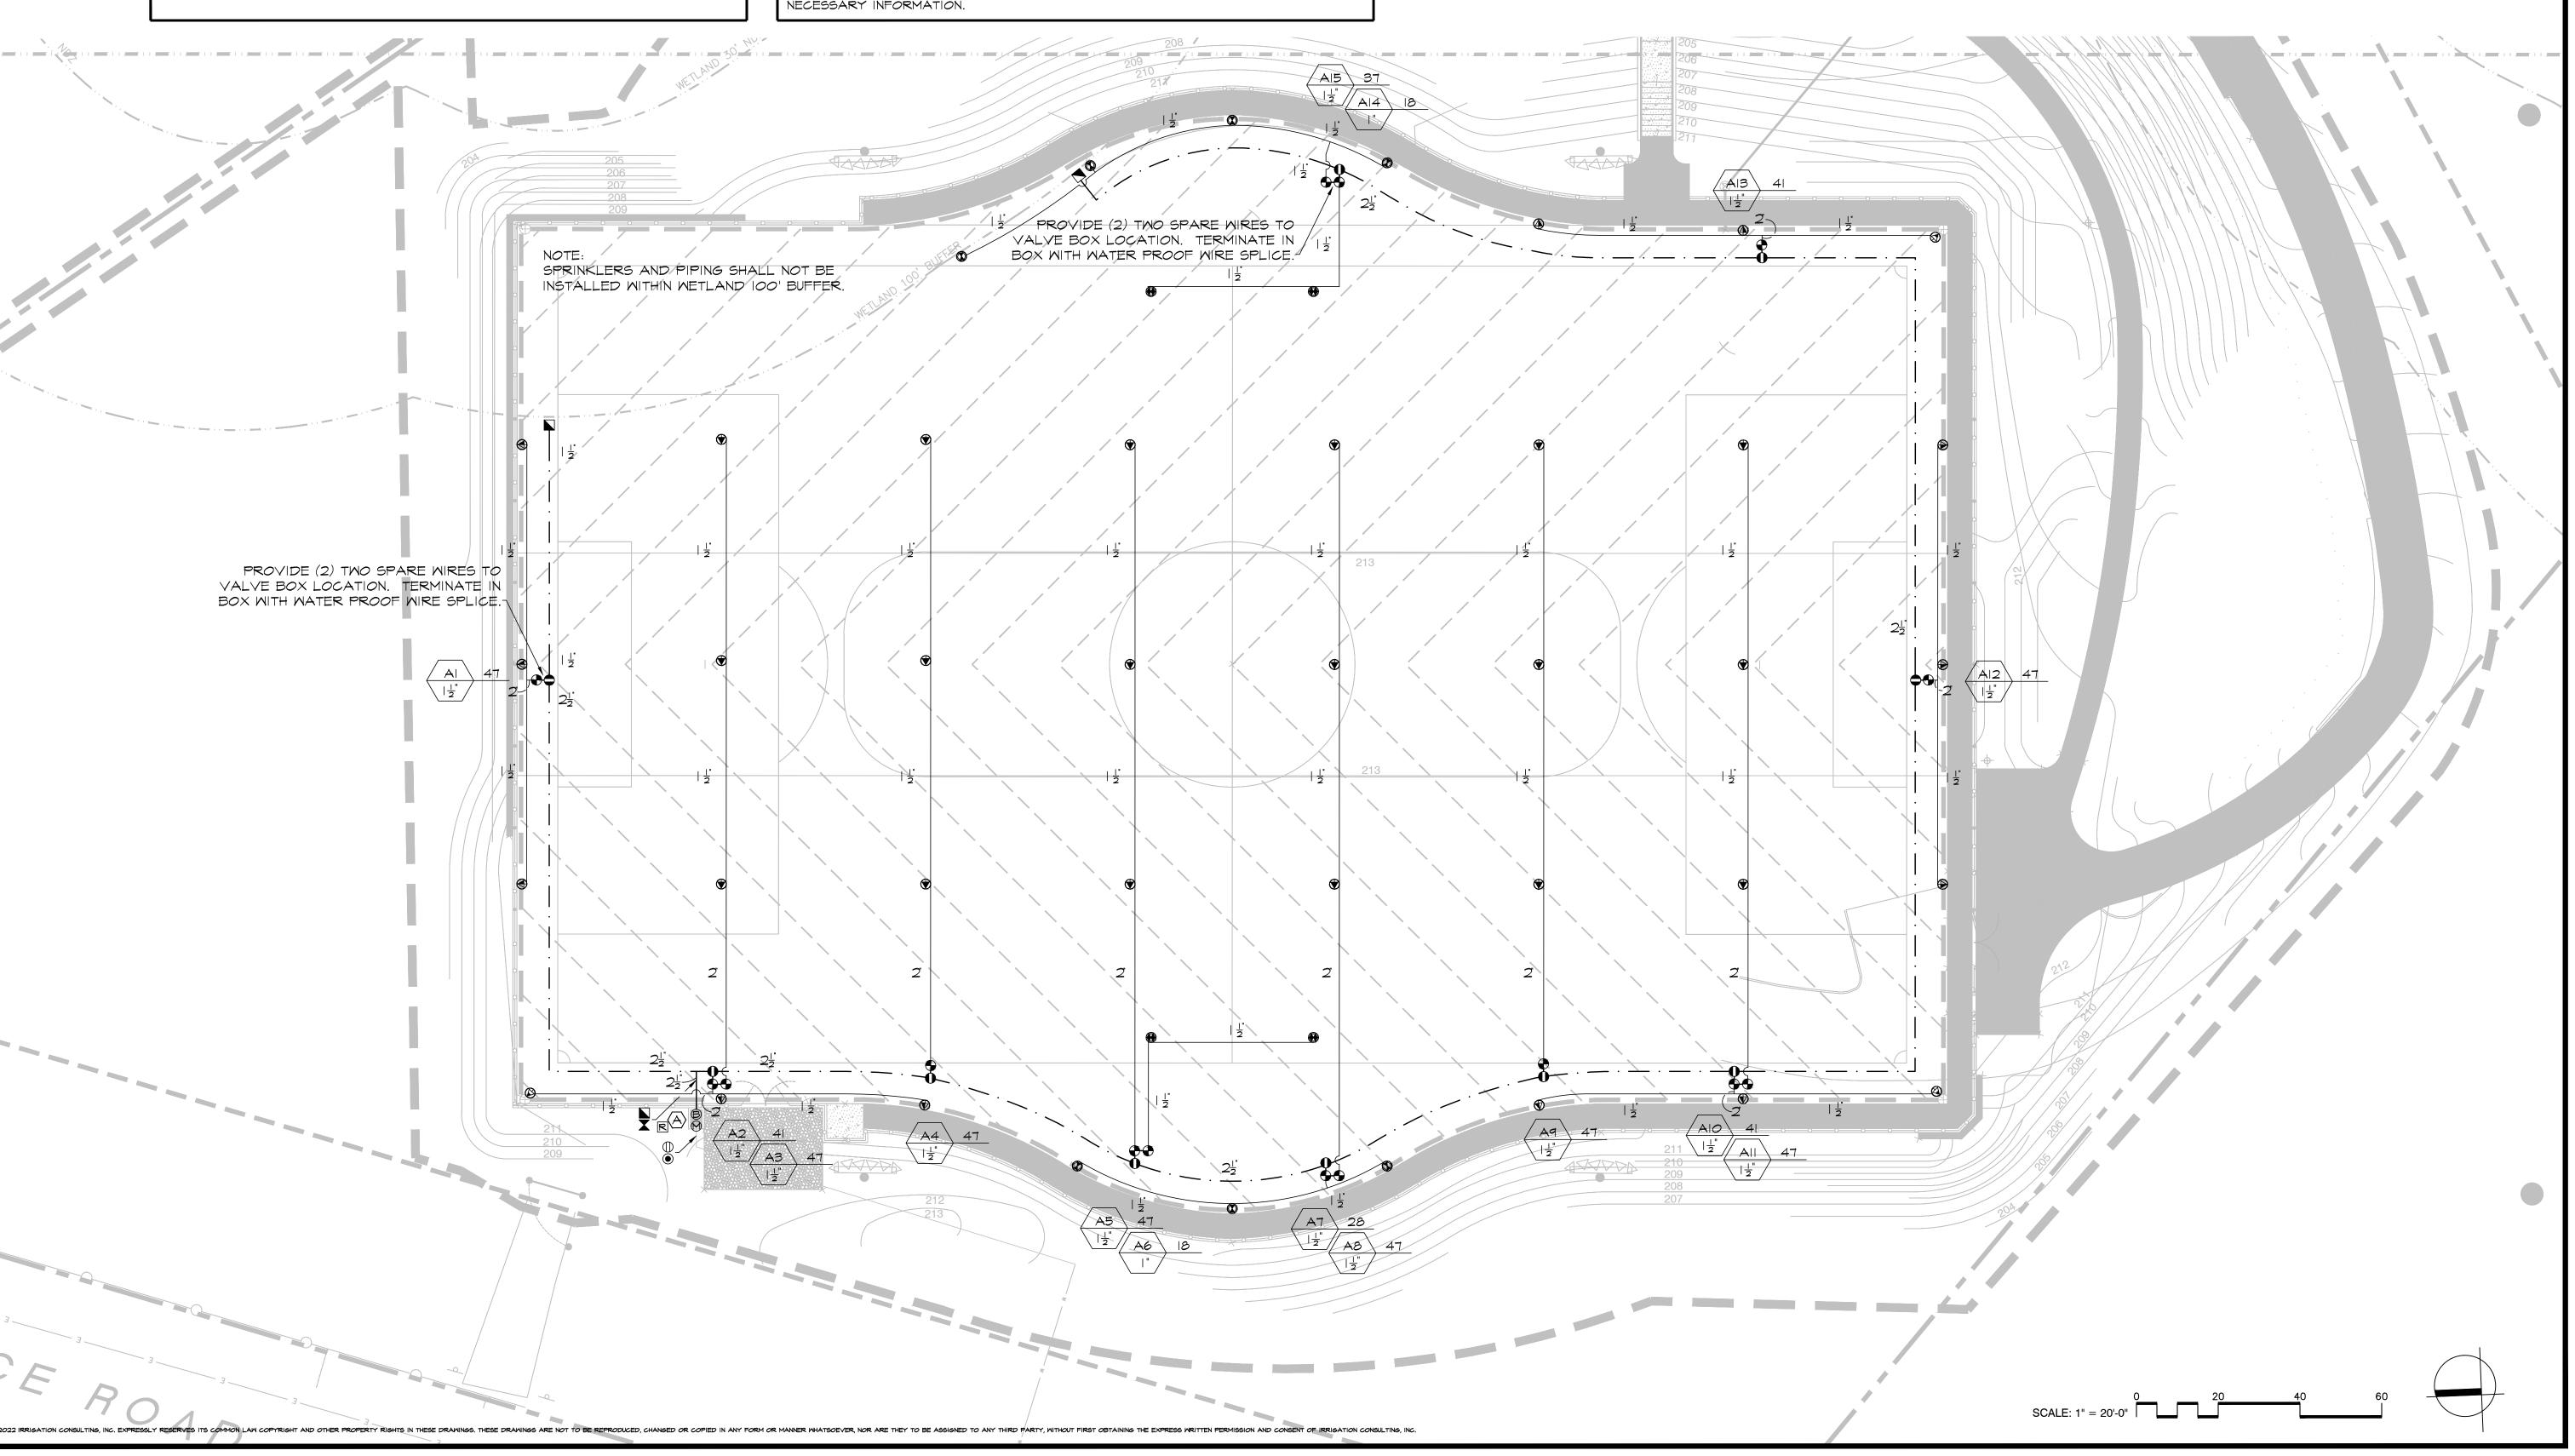
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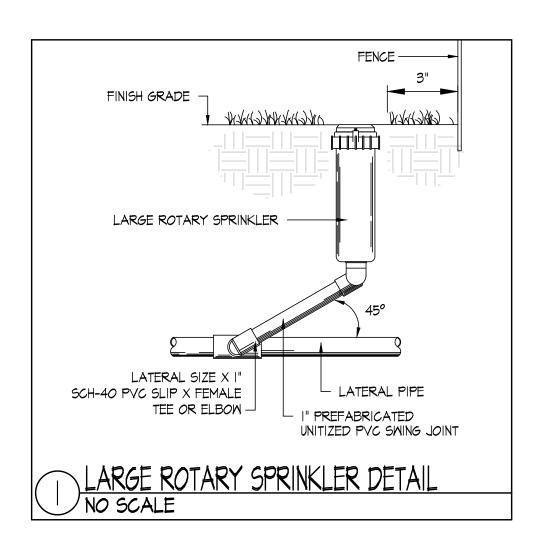
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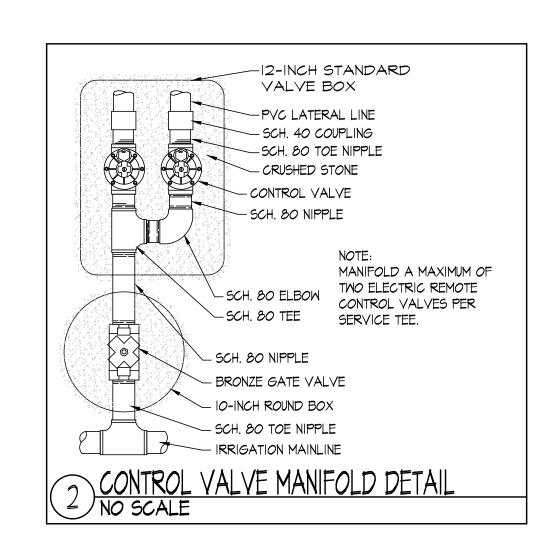
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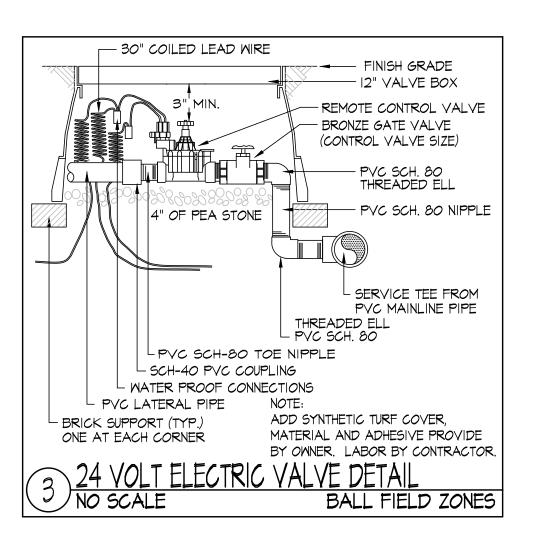
IRRIGATION PLAN

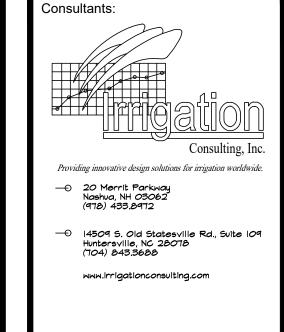Sheet Number:



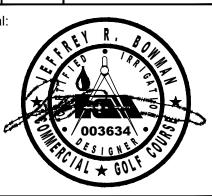





- FINISH GRADE

BRONZE GATE VALVE -

SCH-80 PVC TOE NIPPLE (TYP.) -


4 ISOLATION GATE VALVE DETAIL
NO SCALE


SCH-40 PVC COUPLING -


4" LEVEL CRUSHED STONE BASE


10" ROUND VALVE BOX


PVC MAINLINE

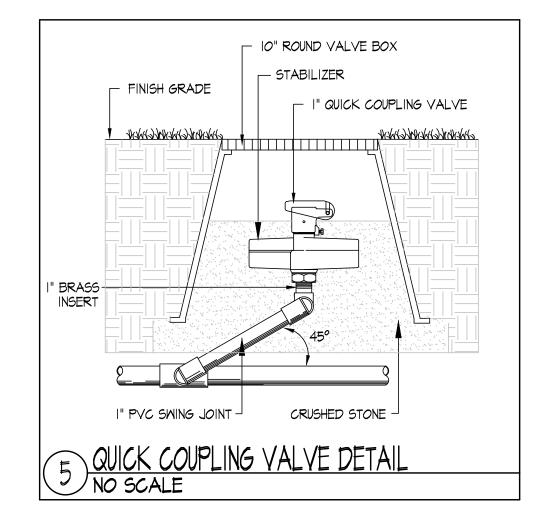


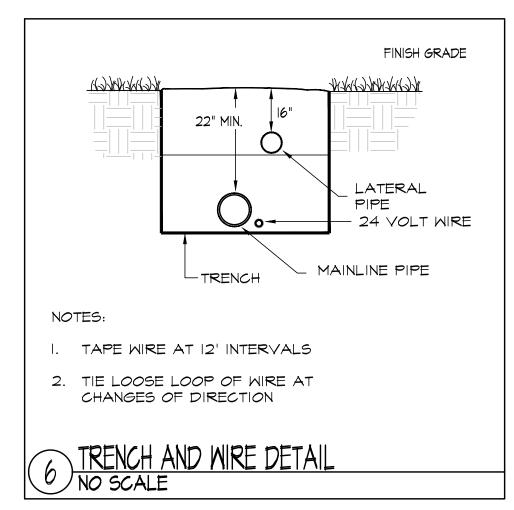

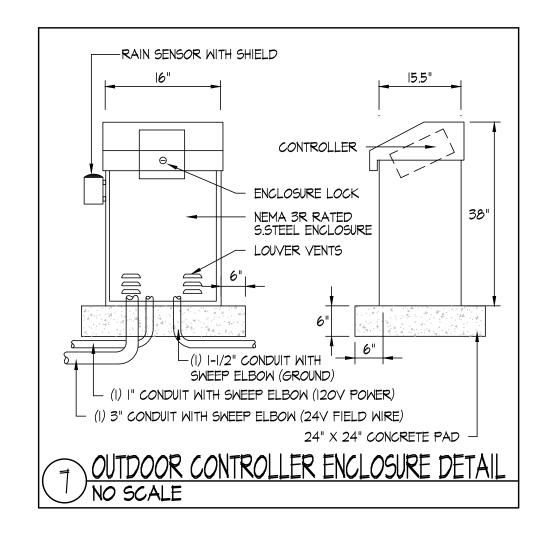


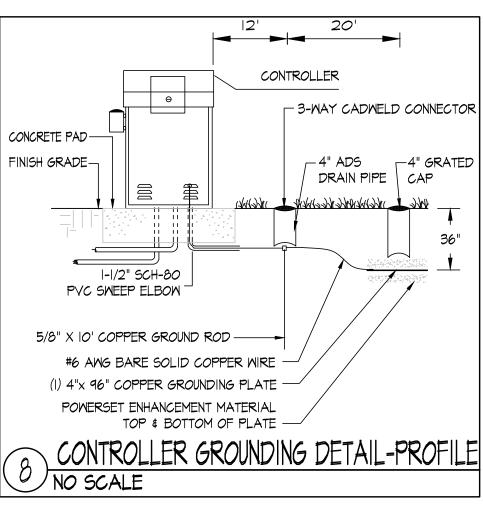


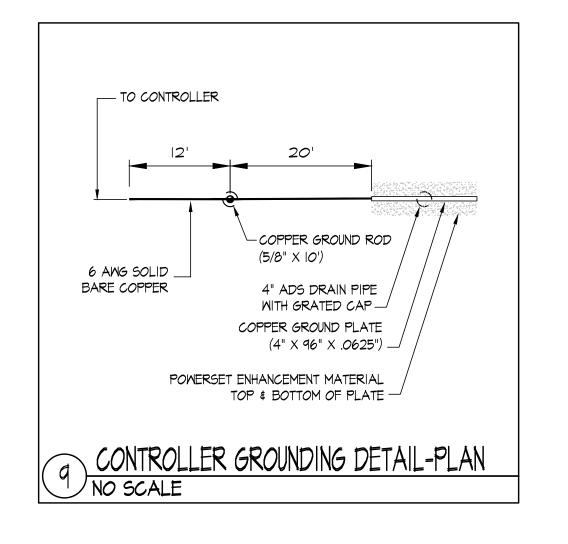

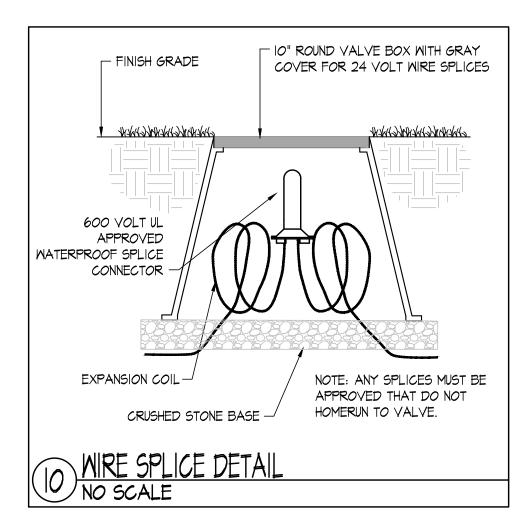


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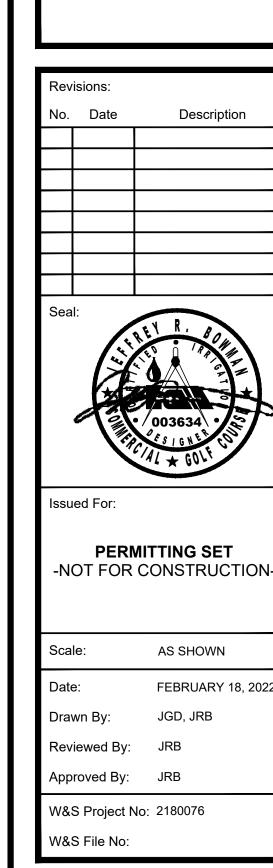


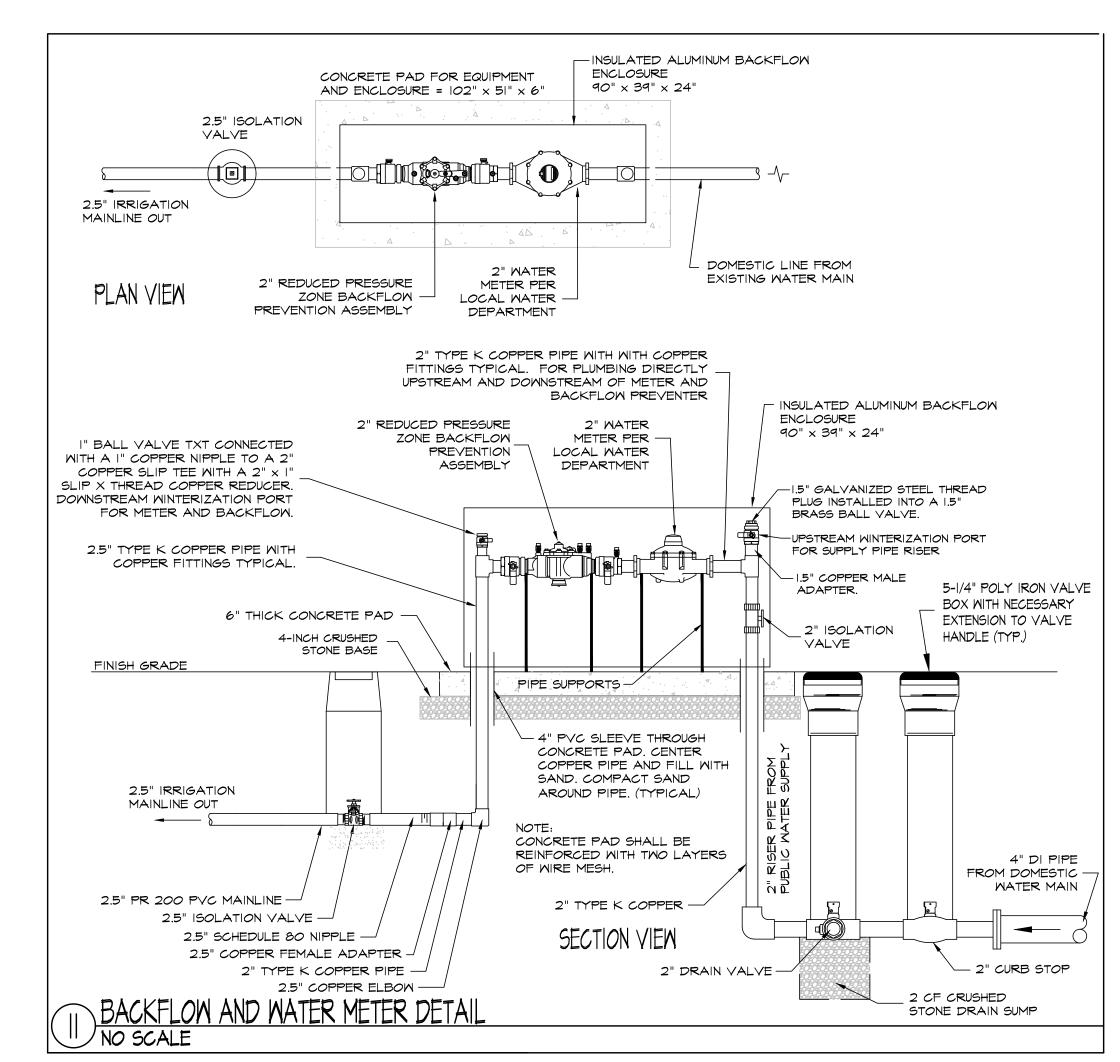

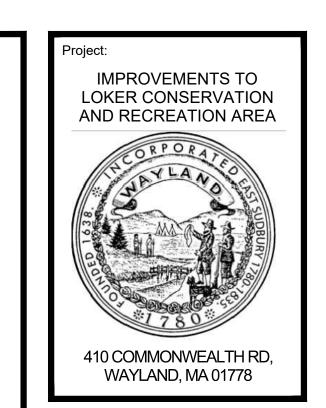
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Sheet Number:

ABBREVIATIONS ABOVE FINISHED FLOOR ALTERNATING CURRENT ATC AUTOMATIC TEMPERATURE CONTROLS ATS AUTOMATIC TRANSFER SWITCH BKR BREAKER CONDUIT CIRCUIT CIRCUIT BREAKER ELECTRICAL CONTRACTOR EMT ELECTRIC METALLIC TUBING **EWC** ELECTRIC WATER COOLER EWH ELECTRIC WATER HEATER EXHAUST FAN FLOOR FLA FULL LOAD AMPERE GC GENERAL CONTRACTOR GFI GROUND FAULT INTERRUPTER GND GROUND HOA HAND OFF AUTOMATIC HORSEPOWER ISOLATED GROUND JUNCTION BOX KILOVOLT AMPERES KILOWATT MCB MAIN CIRCUIT BREAKER MLO MAIN LUGS ONLY MC MECHANICAL CONTRACTOR MOUNTED MOUNTING NMC NON-METALLIC CONDUIT NORMALLY CLOSED NORMALLY OPEN NOT APPLICABLE NOT IN CONTRACT NTS NOT TO SCALE PNL PANELBOARD PHASE PVC POLYVINYL CHLORIDE CONDUIT RSC RIGID GALVANIZED STEEL CONDUIT SUPPLY FAN SAFETY SWITCH TELEPHONE TRANSFORMER VOLTS WATTS OR WIRE WEATHERPROOF 4WSN 4-WIRE SOLID NEUTRAL

RECEPTACLE ABBREVIATIONS

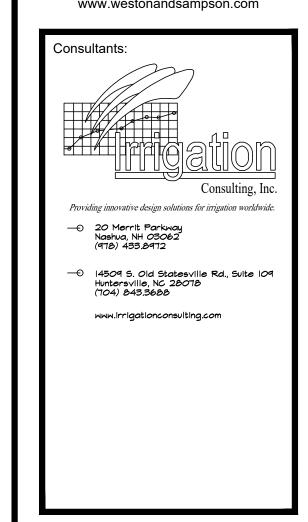PLUG INSERTED.

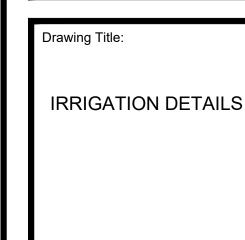PERSONAL PROTECTION

GROUND FAULT CIRCUIT INTERUPTER,

WEATHERPROOF RECEPTACLE WITH

COVERPLATE LISTED FOR WET LOCATION WITH AN ATTACHMENT

ELECTRICAL LEGEND HOMERUN TO PANELBOARD, NUMBER OF TICKS INDICATES NUMBER OF #12 AWG CONDUCTORS CONTAINED IN RACEWAY. TWO (2) #12 AWG SHALL NOT BE INDICATED BY TICKS, NUMERALS 1 AND 3 INDICATE CIRCUITS IN PANELBOARD. RACEWAYS LARGER THAN 1/2" AND CONDUCTORS LARGER THAN #12 AWG SHALL BE INDICATED ON THE DRAWINGS. PROVIDE AN INSULATED GREEN GROUND WIRE IN ALL RACEWAYS MINIMUM SIZE TO BE RACEWAY RUN ABOVE GROUND RACEWAY RUN UNDERGROUND PULL BOX. TYPE AS NOTED ON THE DRAWINGS OR AS REQUIRED BY N.E.C. DUPLEX CONVENIENCE OUTLET RATED 20A, 125V, U-SLOT GROUNDED TYPE MOUNTED 18" ABOVE FINISHED FLOOR TO CENTER LINE. ALL OTHER MOUNTING HEIGHTS SHALL BE AS NOTED ADJACENT TO THE SYMBOL. REFER TO RECEPTACLE ABBREVIATIONS FOR SPECIAL PURPOSE RECEPTACLES. SINGLE POLE SWITCH (120/277V) MOUNTED 4'-0" ABOVE FINISHED FLOOR. ALL OTHER MOUNTING HEIGHTS SHALL BE AS NOTED ON THE DRAWINGS. "a" SUBSCRIPT DENOTES CIRCUITS CONTROLLED. SPORTS LIGHT POLE - 'T1' INDICATES POLE NUMBER PEDESTRIAN LIGHT FIXTURE

"PHH" POWER HAND HOLE

"CHH" COMMUNICATIONS HAND HOLE

GENERAL NOTES

- 1. DRAWINGS ARE DIAGRAMMATIC ONLY. THE EXACT LOCATION, MOUNTING HEIGHTS, SIZE OF EQUIPMENT AND ROUTING OF RACEWAYS SHALL BE COORDINATED AND DETERMINED IN THE FIELD.
- 2. ALL STRAIGHT FEEDER, BRANCH CIRCUIT AND AUXILIARY SYSTEM CONDUIT RUNS SHALL BE PROVIDED WITH SUFFICIENT PULL BOXES TO LIMIT THE MAXIMUM LENGTH OF ANY SINGLE CABLE PULL TO 150 FEET. EXACT SIZES OF PULL BOXES AND LOCATIONS TO BE DETERMINED IN THE FIELD BY THE ELECTRICAL CONTRACTOR.
- 3. SLEEVES ARE TO BE UTILIZED FOR PASSAGE OF CONDUITS THROUGH FLOORS OR WALLS. CONDUITS AND BOXES ARE TO BE SUPPORTED BY THE USE OF PRESET FASTENERS INSTALLED IN FLOORS, WALLS OR COLUMNS. CONDUITS AND BOXES ARE TO BE INSTALLED CONCEALED IN MASONRY WALLS AND ABOVE HUNG CEILINGS. ALL SLEEVES ARE TO BE SEALED WITH APPROVED FIRE STOPPING SEALANT.
- . WORK SHALL CONFORM TO THE MASSACHUSETTS ELECTRICAL CODE, MASSACHUSETTS BUILDING CODE, NFPA AND REQUIREMENTS OF LOCAL AUTHORITIES HAVING JURISDICTION.
- 5. THE WORD "CONTRACTOR" AS USED IN THE "ELECTRICAL WORK" SHALL MEAN THE ELECTRICAL
- 6. CONTRACTOR SHALL PAY FOR ALL PERMITS, INSURANCE AND TESTS, AND SHALL PROVIDE LABOR AND MATERIAL TO COMPLETE THE ELECTRICAL WORK SHOWN.
- 7. CONTRACTOR SHALL PAY ELECTRIC UTILITY COMPANY BACK CHARGES. UTILITY BACK CHARGES ARE \$15,000.
- 8. THE ELECTRICAL CONTRACTOR SHALL PROVIDE ALL COORDINATION WITH THE UTILITY.
- 9. EXCEPT AS OTHERWISE NOTED, THE ELECTRICAL WORK SHALL INCLUDE DEMOLITION, PANELBOARDS, CIRCUIT BREAKERS, FEEDERS, WIRING, RACEWAYS, LIGHTING FIXTURES, DEVICES, SAFETY SWITCHES, TRANSFORMERS AND CONNECTION NECESSARY TO OPERATE MOTORS AND OTHER EQUIPMENT.
- 10. THE CONTRACTOR SHALL PROVIDE ALL TEMPORARY LIGHTING AND POWER AND THE GENERAL CONTRACTOR SHALL PAY ALL ENERGY CHARGES.
- 11. DURING CONSTRUCTION, THE ELECTRICAL CONTRACTOR SHALL KEEP HIS PORTION OF THE WORK NEAT, CLEAN AND ORDERLY.
- 12. ALL SYSTEMS SHALL BE TESTED FOR SHORT CIRCUIT AND GROUNDS PRIOR TO ENERGIZING AND ANY DEFECTS SHALL BE CORRECTED.
- 13. ALL CUTTING AND PATCHING REQUIRED FOR ELECTRICAL WORK SHALL BE INCLUDED AS PART OF THIS SECTION.
- 14. COMPLETE SHOP DRAWINGS SHALL BE SUBMITTED FOR ELECTRICAL EQUIPMENT. WHERE SPECIFIED ELECTRICAL EQUIPMENT IS SUBSTITUTED, THE ELECTRICAL CONTRACTOR SHALL SUBMIT COMPLETE SPECIFICATIONS ON THE SUBSTITUTE AS WELL AS THE ITEM ORIGINALLY SPECIFIED.
- 15. MATERIALS SHALL BE SPECIFICATION GRADE AND UL LISTED.
- 16. WHERE MATERIAL IS CALLED OUT IN THE LEGEND BY MANUFACTURER, TYPE OR CATALOG NUMBER, SUCH DESIGNATIONS ARE TO ESTABLISH STANDARDS OR DESIRED QUALITY. ACCEPTANCE OR REJECTIONS OF PROPOSED SUBSTITUTIONS SHALL BE SUBJECT TO THE APPROVAL OF THE OWNER.
- 17. WORK SHALL BE COORDINATED WITH THAT OF OTHER TRADES TO ELIMINATE INTERFERENCES.
- 18. EXACT LOCATIONS OF MECHANICAL EQUIPMENT, DEVICES, ETC. SHALL BE VERIFIED WITH THE GENERAL CONTRACTOR PRIOR TO ROUGHING FOR SAME.
- 19. ELECTRICAL CONTRACTOR SHALL OBTAIN SHOP DRAWINGS/SPECIFICATIONS OF ALL EQUIPMENT FROM THE GENERAL CONTRACTOR PRIOR TO PURCHASING AND INSTALLING ELECTRICAL EQUIPMENT FOR SAME. NOTIFY ENGINEER OF ANY DISCREPANCIES BETWEEN ACTUAL EQUIPMENT INSTALLED AND CONTRACT DOCUMENTS.
- 20. ELECTRICAL WORK SHALL BE GUARANTEED FOR A PERIOD OF ONE YEAR FROM DATE OF WHICH SYSTEM IS PUT INTO SERVICE.
- 21. WORK SHALL BE GROUNDED IN ACCORDANCE WITH CODE REQUIREMENTS. COMPLETE EQUIPMENT (INSULATED GREEN WIRE) GROUNDING SYSTEM SHALL BE INSTALLED.
- 22. PANELBOARDS SHALL BE DEAD FRONT, THERMAL MAGNETIC BOLT-ON CIRCUIT BREAKER TYPE, DESIGNED FOR SURFACE OR FLUSH MOUNTING AS INDICATED ON PLAN, AND HAVING CONNECTIONS TO 120/208 OR 277/480 VOLT, 3 PHASE, 4 WIRE SERVICE. ALL BUS BARS SHALL BE COPPER. CABINETS SHALL BE MADE OF CODE GAUGE GALVANIZED SHEET STEEL, WITH A MINIMUM OF 4 INCH GUTTERS, DOOR IN DOOR CONSTRUCTION, LOCKED DOOR, AND FLUSH HINGES. TYPEWRITTEN INDEX SHALL BE MOUNTED ON DOOR INSIDE TRANSPARENT COVER INDICATING LOAD SERVED. PANELS SHALL INCLUDE SEPARATE EQUIPMENT GROUND BUS.
- 23. PANELBOARDS, DISCONNECT SWITCHES, AND CONTROLLERS SHALL HAVE NAMEPLATES OF BLACK LAMINATED PLASTIC WITH ENGRAVED WHITE LETTERS, SECURED WITH SELF-TAPPING SCREWS.
- 24. CONNECTIONS AT MOTORS SHALL BE MADE WITH 18" LENGTH OF 1/2 INCH FLEXIBLE LIQUID TIGHT CONDUIT.
- 25. CONTRACTOR SHALL PHASE BALANCE PANELBOARDS IN THE FIELD. LOAD ON EACH PHASE SHALL BE BALANCED WITHIN 10% OF EACH OTHER.
- 26. TOGGLE SWITCHES SHALL BE OF THE SINGLE POLE A.C. QUIET TOGGLE TYPE FOR MOUNTING IN A SINGLE-GANG SPACING. TOGGLE SWITCHES SHALL BE FULLY RATED 20 AMPERES AT 120/277 VOLT.
- 27. DUPLEX WALL RECEPTACLES SHALL BE 2 POLE, 3 WIRE, GROUNDING TYPE 20 AMPERE, 125 VOLT WITH METAL PLASTER EARS. RECEPTACLES SHALL BE NEMA STANDARD CONFIGURATION 5-20R.
- 28. FUSED OR UNFUSED SAFETY SWITCHES SHALL BE TOTALLY ENCLOSED, HEAVY DUTY TYPE. SWITCHES SHALL HAVE VOLTAGE, HORSEPOWER AND AMPERE RATING SUITABLE FOR THE APPLICATION. PROVIDE NUMBER OF POLES AS REQUIRED. SWITCHES LOCATED EXTERIOR TO THE BUILDING OR IN DAMP/WET LOCATIONS SHALL BE IN
- 29. FUSES SHALL BE DUAL ELEMENT, TIME DELAY TYPE, AS MANUFACURED BY BUSSMAN, RELIANCE OR APPROVED
- 30. FURNISH AND INSTALL SLEEVES IN FLOORS, BEAMS, WALLS, ETC. REQUIRED FOR INSTALLING THIS WORK.
- 31. CONDUIT PASSING THROUGH FIRE RATED WALLS AND FLOORS SHALL BE PROVIDED WITH ALL NECESSARY MATERIALS TO ENSURE THAT THE FIRE RATED INTEGRITY IS MAINTAINED.
- 32. LFEEDER TAPS WILL NOT BE ALLOWED IN PANELBOARD GUTTERS.

A NEMA 3R ENCLOSURE.

- 33. CONTRACTOR SHALL CHECK EXISTING CONDITIONS TO DETERMINE EXACT EXTENT OF WORK TO BE PERFORMED PRIOR TO BIDDING. DIMENSIONS RELEVANT TO EXISTING WORK SHALL BE VERIFIED IN THE FIELD.
- 34. IN AREAS NOT AFFECTED BY THIS RENOVATION, THIS SUBCONTRACTOR SHALL MAINTAIN CONTINUITY OF ELECTRIC SERVICE.
- 35. WHERE CONNECTIONS ARE MADE IN EXISTING PANELS, THE PANEL INDEX SHALL BE REVISED TO INDICATE THE NEW LOADS SERVED. NEW CIRCUIT BREAKERS ADDED TO EXISTING PANELS SHALL BE THE SAME FRAME SIZE, VOLTAGE RATING AND INTERRUPTING CAPACITY AS EXISTING PANEL AND CIRCUIT BREAKERS.
- 36. ELECTRICAL SHUTDOWN SHALL BE AT A TIME AND DATE APPROVED BY THE OWNER.
- 37. PROVIDE AS-BUILT "CADD" DRAWINGS AT THE COMPLETION OF THE PROJECT.

IMPROVEMENTS TO LOKER CONSERVATION AND RECREATION AREA

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Drawn By: DNM

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Reviewed By: RFM
Approved By: RFM

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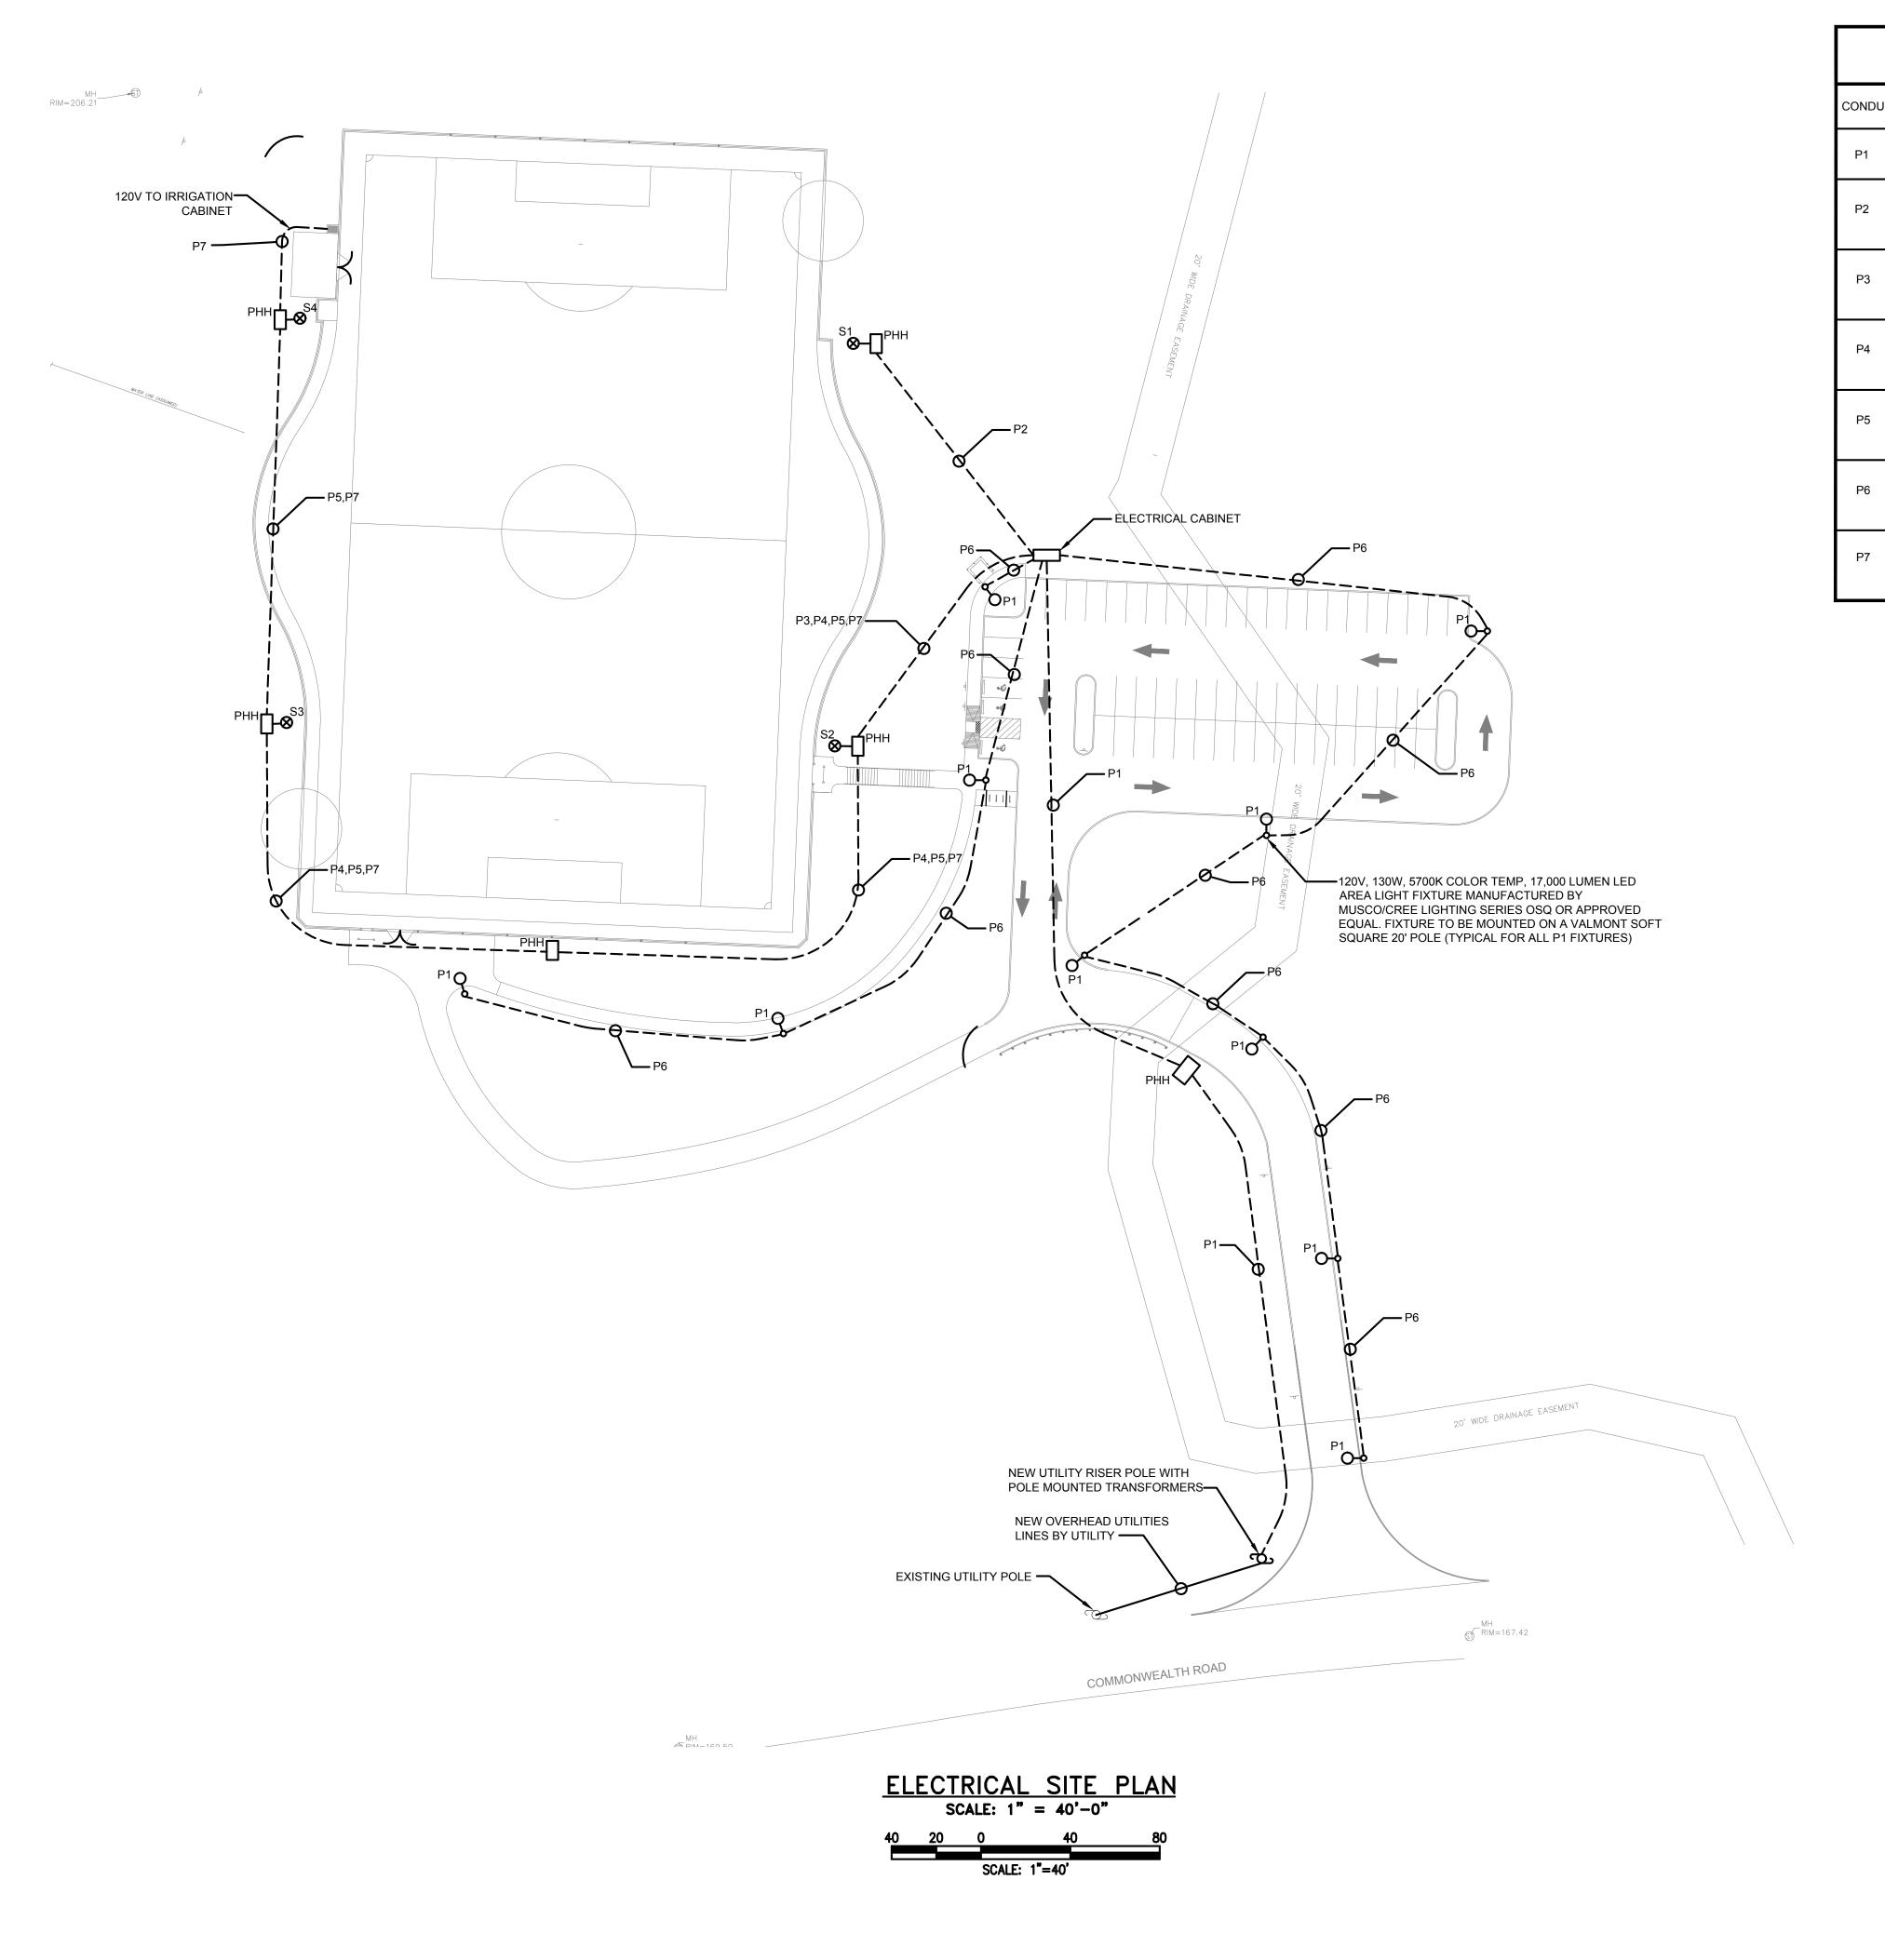
W&S Project No: 2180076
W&S File No:

Drawing Title:

ELECTRICAL LEGEND, ABBREVIATIONS AND GENERAL NOTES

Sheet Number:


F0 01



	CONDUIT & WIRING SCHEDULE									
CONDUIT	FEEDER	FROM	CONTACTOR NUMBER	ТО	FIXTURES	LOAD	CONTACTOR SIZE	REMARKS		
P1	2"C., 4#1 & 1#4GND	UTILITY TRANSFORMER	-	PANEL PPH2	-	100A	-	UNDERGROUND		
P2	2"C., 3#10 & 1#10GND	MUSCO LIGHTING CONTROL CABINET NO.3 IN ELECTRICAL CABINET	C1	FIXTURE S1	6 @ 1150W	6.9 KW	30A			
P3	2"C., 3#10 & 1#10GND	MUSCO LIGHTING CONTROL CABINET NO.3 IN ELECTRICAL CABINET	C2	FIXTURE S2	6 @ 1150W	6.9 KW	30A			
P4	1"C., 3#8 & 1#8GND	MUSCO LIGHTING CONTROL CABINET NO.3 IN ELECTRICAL CABINET	СЗ	FIXTURE S3	6 @ 1150W	6.9 KW	30A			
P5	2"C., 3#8 & 1#8GND	MUSCO LIGHTING CONTROL CABINET NO.3 IN ELECTRICAL CABINET	C4	FIXTURE S4	6 @ 1150W	6.9 KW	30A			
P6	2"C., 2#6 & 1#8GND	PANEL PPL2 IN ELECTRICAL CABINET	-	PARKING LOT LIGHTING	-	-	-	VIA NEW TIME CLOC ELECTRICAL CABINE		
P7	2"C	PANEL PPL2 IN ELECTRICAL CABINET		IRRIGATION CABINET		120 V				

DRAWING NOTES:

- REFER TO DRAWING E0.01 FOR ELECTRICAL LEGEND, ABBREVIATIONS AND GENERAL NOTES.
- CONTRACTOR SHALL BE RESPONSIBLE FOR DOWNSIZING FEEDERS AT ELECTRICAL DEVICES FOR CONNECTION IN FIELD. FEEDERS HAVE BEEN OVERSIZED FOR VOLTAGE DROP.
- 3. THE CONTRACTOR SHALL FURNISH & INSTALL A HANDHOLE AT EACH LIGHT POLE BASE FOR TRANSITIONING TO LIGHT POLE RISER CONDUIT. RUN CONDUIT UP POLE APPROXIMATELY 10' TO LIGHT POLE JUNCTION BOX. ADDITIONAL HANDHOLES SHALL BE INSTALLED AS REQUIRED TO FACILITATE THE INSTALLATION OF WIRING. HANDHOLES SHALL NOT BE INSTALLED ON FIELD.

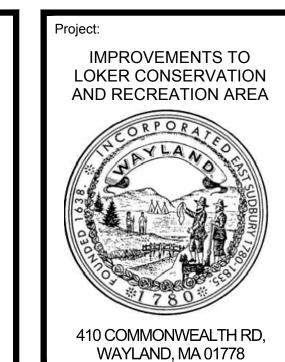



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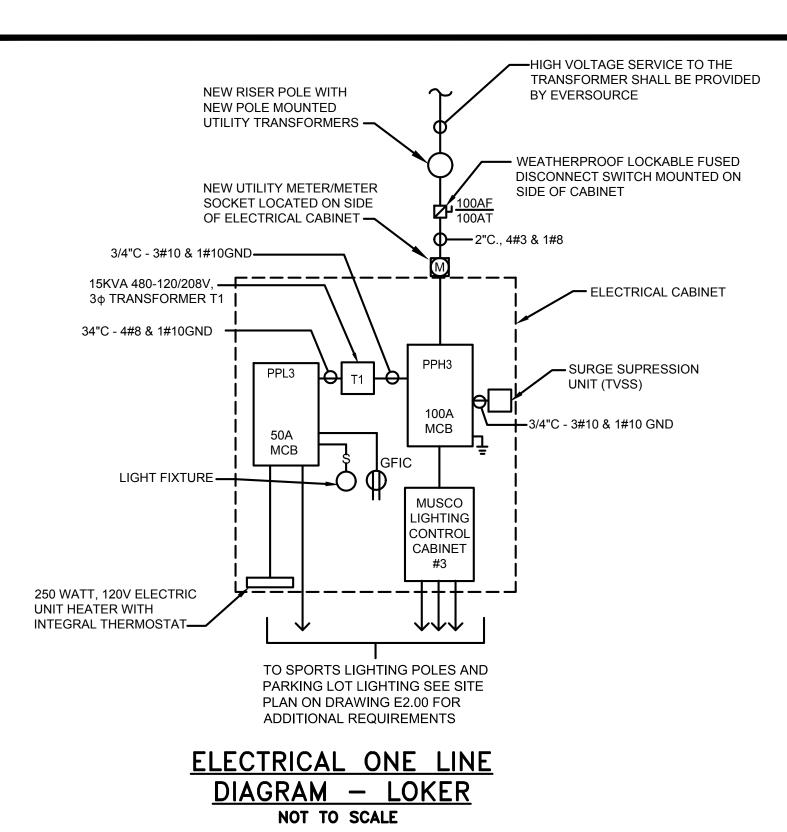
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ELECTRICAL SITE PLAN

Sheet Number:

F1 00



1/2"C 2#12&1#12G
120V CONTROL POWER FROM
PANEL PPL1 CIRCUIT #1.

4-3/4"C EACH WITH 3#10&1#10G
FROM (4) 30A-3P BREAKERS
INSTALLED IN PANEL "PPH1"

WUSCO
LIGHTING
CONTROL
CABINET #3
(LCC3)

C4 FIXTURE S4

NOTES:

1. TYPICAL FOR CONTACTORS C1 THROUGH C4, CONTRACTOR SHALL RUN CONDUIT AND WIRING AS INDICATED IN SCHEDULE FROM EACH CONTACTOR TO DESIGNATED LIGHTING POLE. CONTRACTOR SHALL RUN CONDUIT TO 10'-0" AFG FOR CONNECTION TO POLE MOUNTED LIGHTING CONNECTION BOX.

SPORTS LIGHTING CONTROL CABINET

DIAGRAM — LOKER

NOT TO SCALE

PANELBOARD SCHEDULE - LOKER

DESIGNATION: PPH3 S.C. RATING: 22,000A RMS SYM. REMARKS: SERVICE ENTRANCE RATED

LOCATION: ELECTRICAL CABINET SERVICE: 277/480V, 3Ø, 4W

RATING: 100 AMPS MOUNTING: SURFACE

MAIN: 100 MCB

CKT.	LOAD	BREAKER		PHASE		BREAKER		LOAD	CK
NO.	DESIGNATION	TRIP	POLE	A E	3 C	POLE	TRIP	DESIGNATION	NO
1	-	-	- %-		\dashv	₽	-	-	2
3	FIXTURE POLE S1/CONTACTOR C1	30	₽		\dashv	₽	30	FIXTURE POLE S2/CONTACTOR C2	4
5	-	-	8	H	\dashv	S	-	-	6
7	-	-	₽			₽	-	-	8
9	FIXTURE POLE S3/CONTACTOR C3	30	├ �	\blacksquare	$\overline{+}$	- �	30	FIXTURE POLE TS/CONTACTOR C4	10
11	-	-	~	H	\rightarrow	8	_	-	12
13	-	-	├ �	+		8	20	SPARE	14
15	15KVA CABINET TRANSFORMER	50	├ �	\blacksquare	\dashv	8	20	SPARE	16
17	-	-	─	\Box	\dashv	8	20	SPARE	18
19	SPARE	20	₽		4	8	20	SPARE	20
21	SPARE	20	─	\Box	\dashv	8	20	SPARE	22
23	SPARE	20	~	\Box	\dashv	8	20	SPARE	24
25	SPARE	20	8	$\overline{+}$	7	8	20	SPARE	26
27	SPARE	20	8	\Box	\dashv	8	20	SPARE	28
29	SPARE	20	~		\Rightarrow	S.	20	SPARE	30

DESIGNATION: PPL3 S.C. RATING: 10,000A RMS SYM. REMARKS:

LOCATION: ELECTRICAL CABINET SERVICE: 120/208V, 3Ø, 4W

RATING: 100 AMPS MOUNTING: SURFACE

MAIN: 50A MCB

CKT.	LOAD	BREAK	PHASE		BREAKER		LOAD	CKT.	
NO.	DESIGNATION	TRIP	POLE	Α	в с	POLE	TRIP	DESIGNATION	
1	LIGHTING IN ELECTRICAL CABINET	20	6	+	\mathbf{H}	8	20	ELECTRIC HEATER IN ELECTRICAL CABINET	2
3	RECEPTACLE IN ELECTRICAL CABINET	20	8	H		S	20	PARKING LOT LIGHTING	4
5	SPARE	20	6	H	$\overline{}$	Ş	20	SPARE	6
7	SPARE	20	8	+	\vdash	8	20	SPARE	8
9	SPARE	20	6	H		Ş	20	SPARE	10
11	SPARE	20	6	H		م	20	SPARE	12

IMPROVEMENTS TO LOKER CONSERVATION AND RECREATION AREA

Weston & Sampson

410 COMMONWEALTH RD,

WAYLAND, MA 01778

85 Devonshire Street, 3rd Floor, Boston, MA 02109 617.412.4480 800.SAMPSON www.westonandsampson.com

Consultants:


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Date	e:	FEBRUARY 18, 2022		
Dra	wn By:	DNM		
Rev	riewed By:	RFM		
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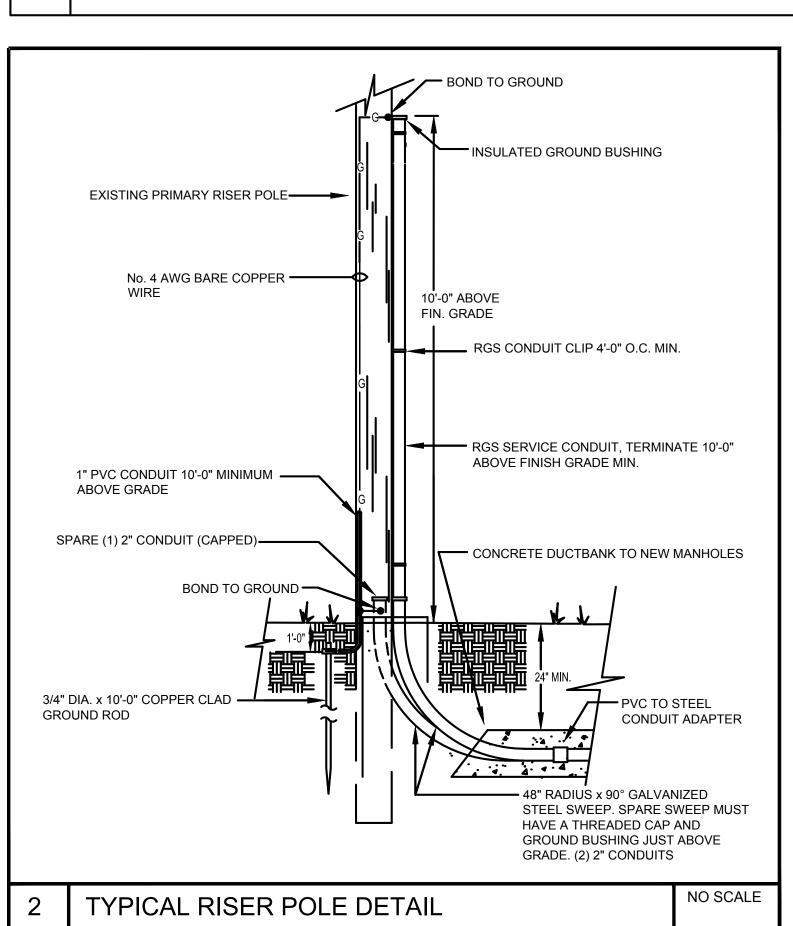
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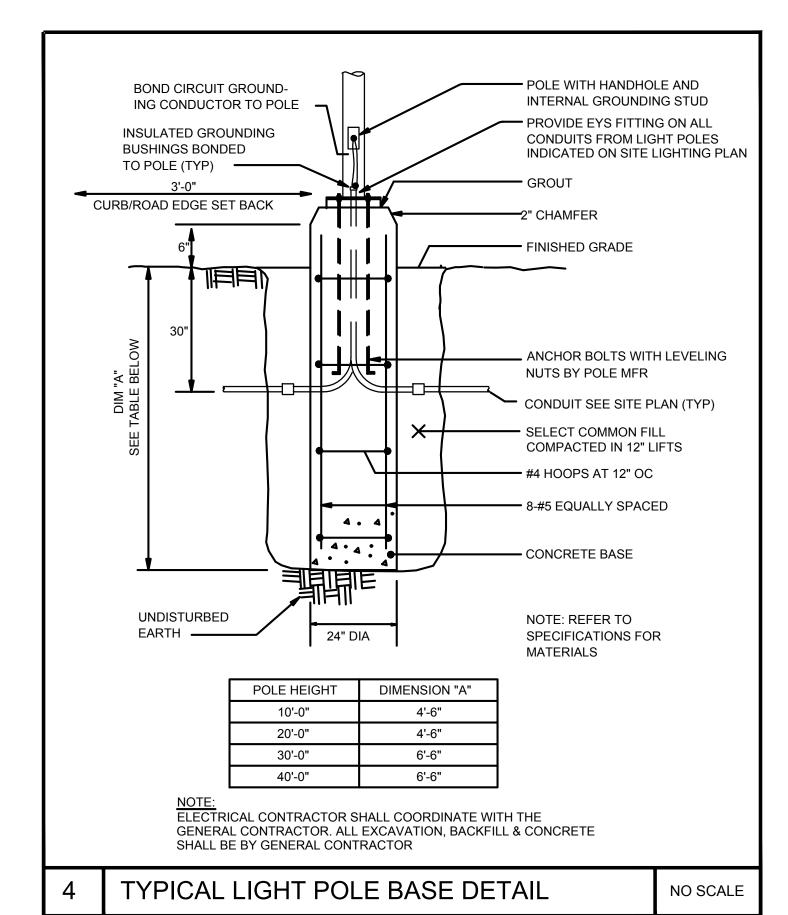
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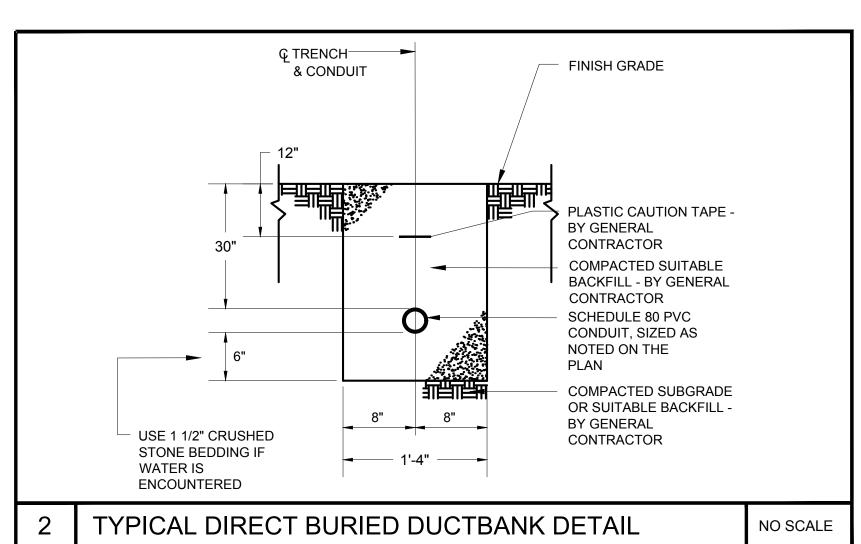
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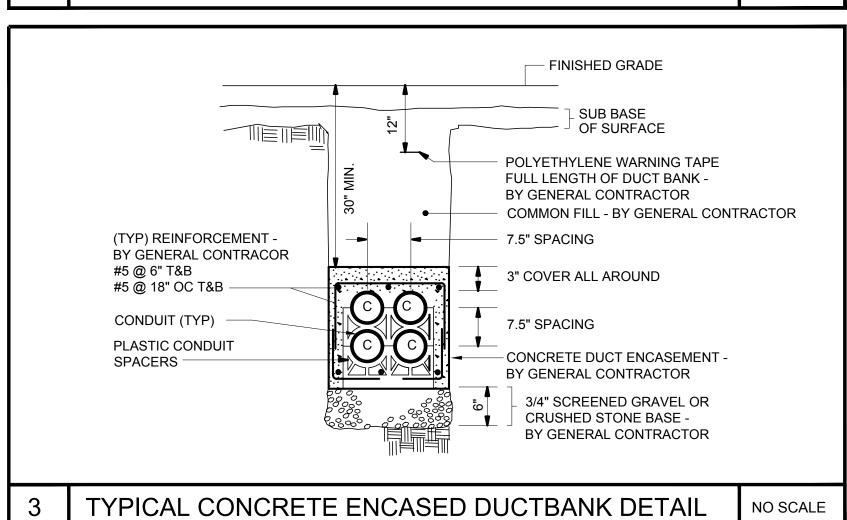
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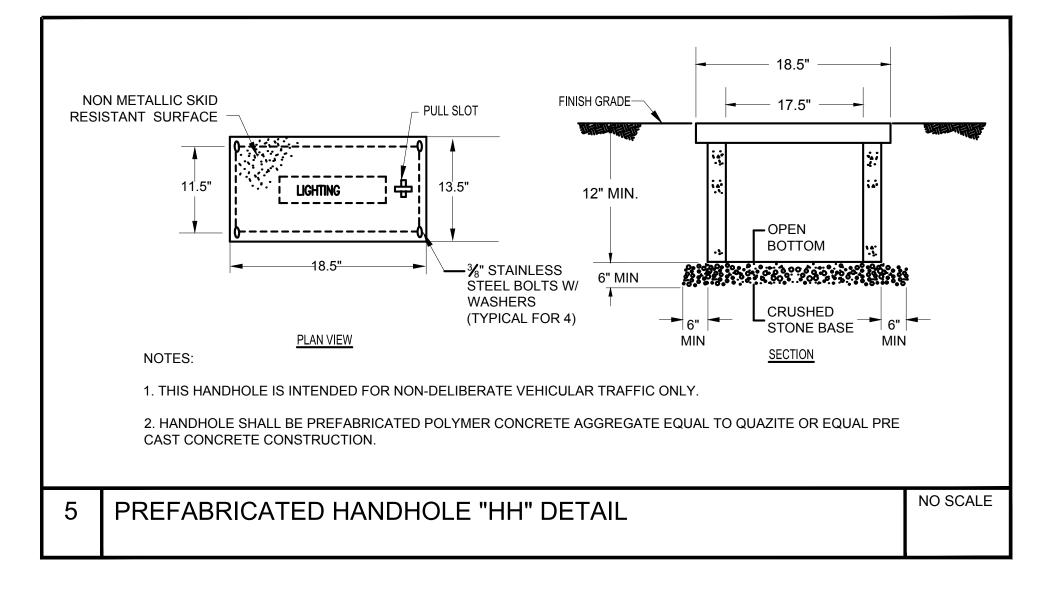












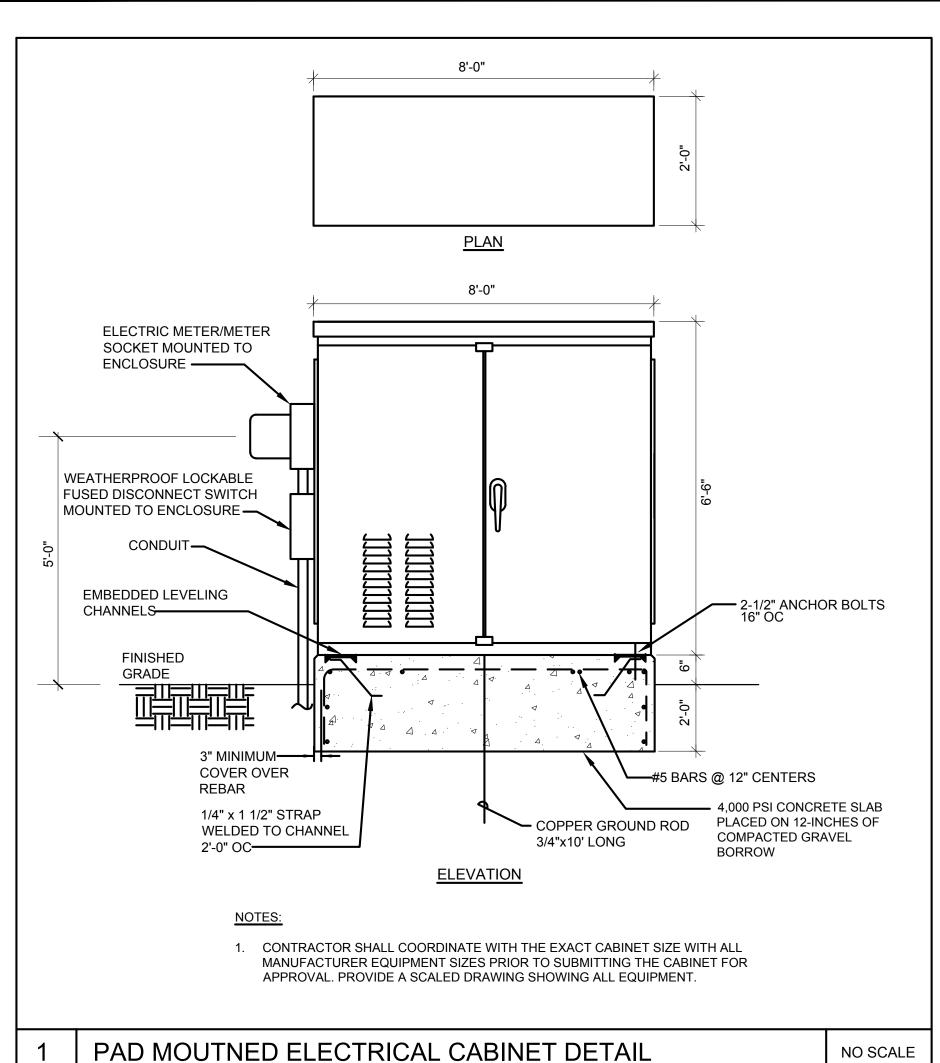

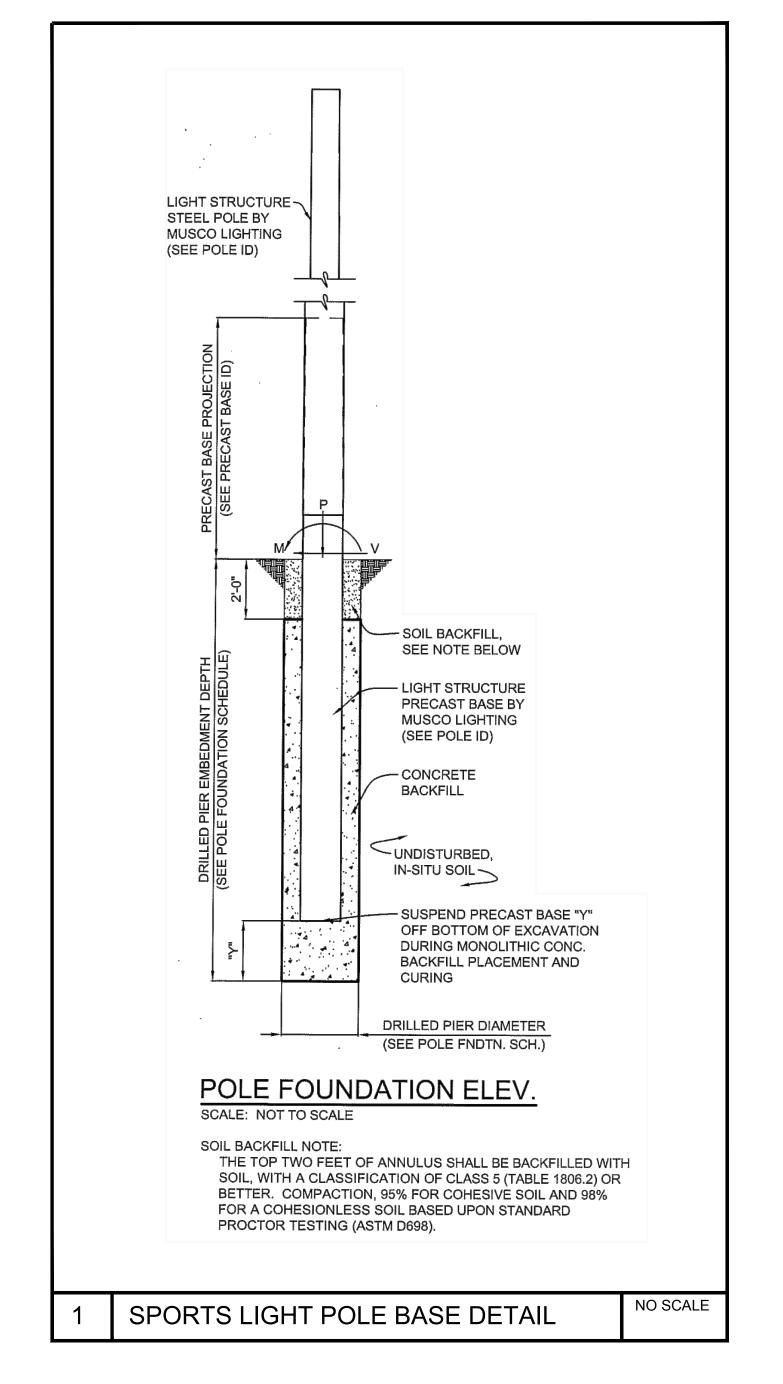

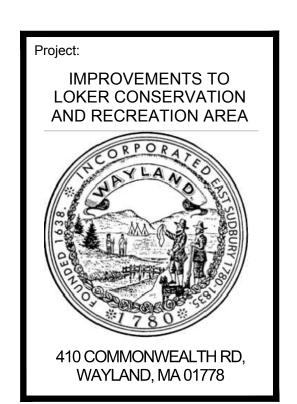

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