

APPLICANT/OWNER: WEST SUBURBAN YMCA **276 CHURCH STREET** NEWTON, MA 02458

400 HARVEY ROAD


SURVEYOR: ALLEN & MAJOR ASSOCIATES, INC. **100 COMMERCE WAY WOBURN, MA 01801**

ARCHITECT:


CIVIL ENGINEER: ALLEN & MAJOR ASSOCIATES, INC. MANCHESTER, NH 03103


GORMAN RICHARDSON LEWIS ARCHITECTS 239 SOUTH STREET HOPKINTON, MA 01748

SITE DEVELOPMENT PLANS FOR CAMP CHICKAMI 139 BOSTON POST ROAD WAYLAND, MA 01778 MAP 29, LOT 42

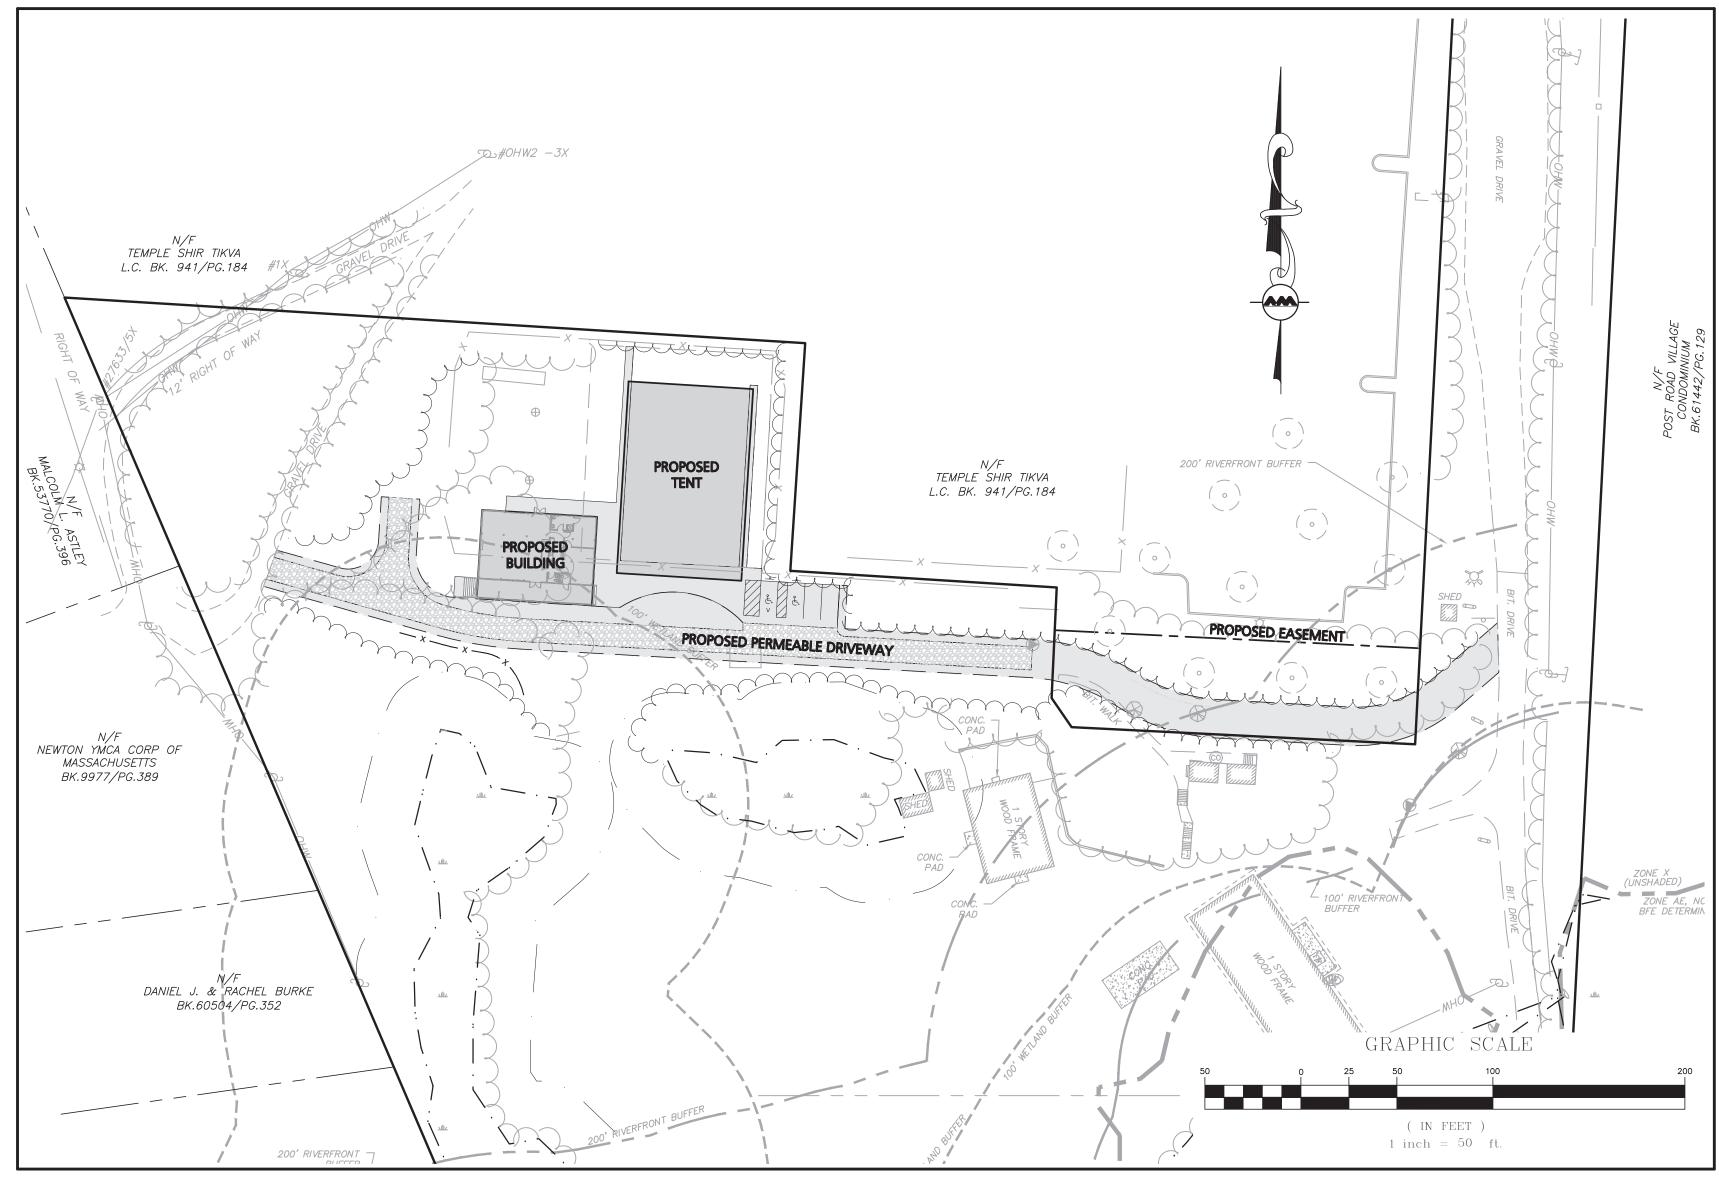

LIST OF DRAWINGS					
DRAWING TITLE	SHEET NO.	ISSUED	REVISION 1		
EXISTING CONDITIONS	V-101	11-10-21	12-22-21		
EXISTING CONDITIONS	V-102	11-10-21	12-22-21		
SITE PREPARATION PLAN	C-101	11-10-21	12-23-21		
LAYOUT & MATERIALS PLAN	C-102	11-10-21	12-23-21		
GRADING & DRAINAGE PLAN	C-103	11-10-21	12-23-21		
UTILITIES PLAN	C-104	11-10-21	12-23-21		
TRUCK TURN PLAN	C-105	11-10-21	12-23-21		
DETAILS	C-501	11-10-21	12-23-21		
DETAILS	C-502	11-10-21	12-23-21		
SUBSURFACE SEWAGE DISPOSAL SYSTEM	SSDS-1	11-10-21	12-08-21		
SUBSURFACE SEWAGE DISPOSAL SYSTEM	SSDS-2	11-10-21	12-08-21		
SUBSURFACE SEWAGE DISPOSAL SYSTEM	SSDS-3	11-10-21	12-08-21		
SUBSURFACE SEWAGE DISPOSAL SYSTEM	SSDS-4	11-10-21	12-08-21		
FLOOR PLAN - LEVEL 1	A1.1	11-10-21	12-23-21		
FLOOR PLAN - LOFT LEVEL	A1.2	11-10-21	12-23-21		
EXTERIOR ELEVATIONS	A3.1	11-10-21	12-23-21		
EXTERIOR ELEVATIONS	A3.2	11-10-21	12-23-21		
BUILDING WALL SECTIONS	A6.1	11-10-21	12-23-21		

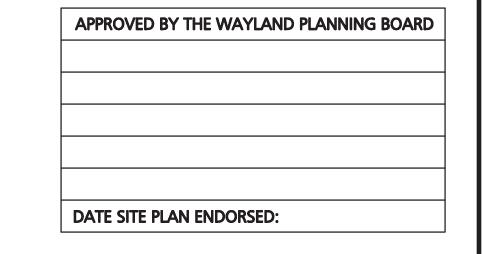


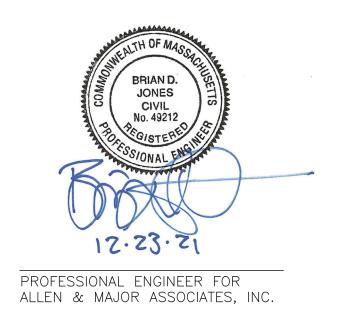




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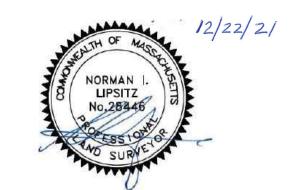
ISSUED FOR SITE PLAN REVIEW: NOVEMBER 10, 2021 REVISION 1: DECEMBER 23, 2021

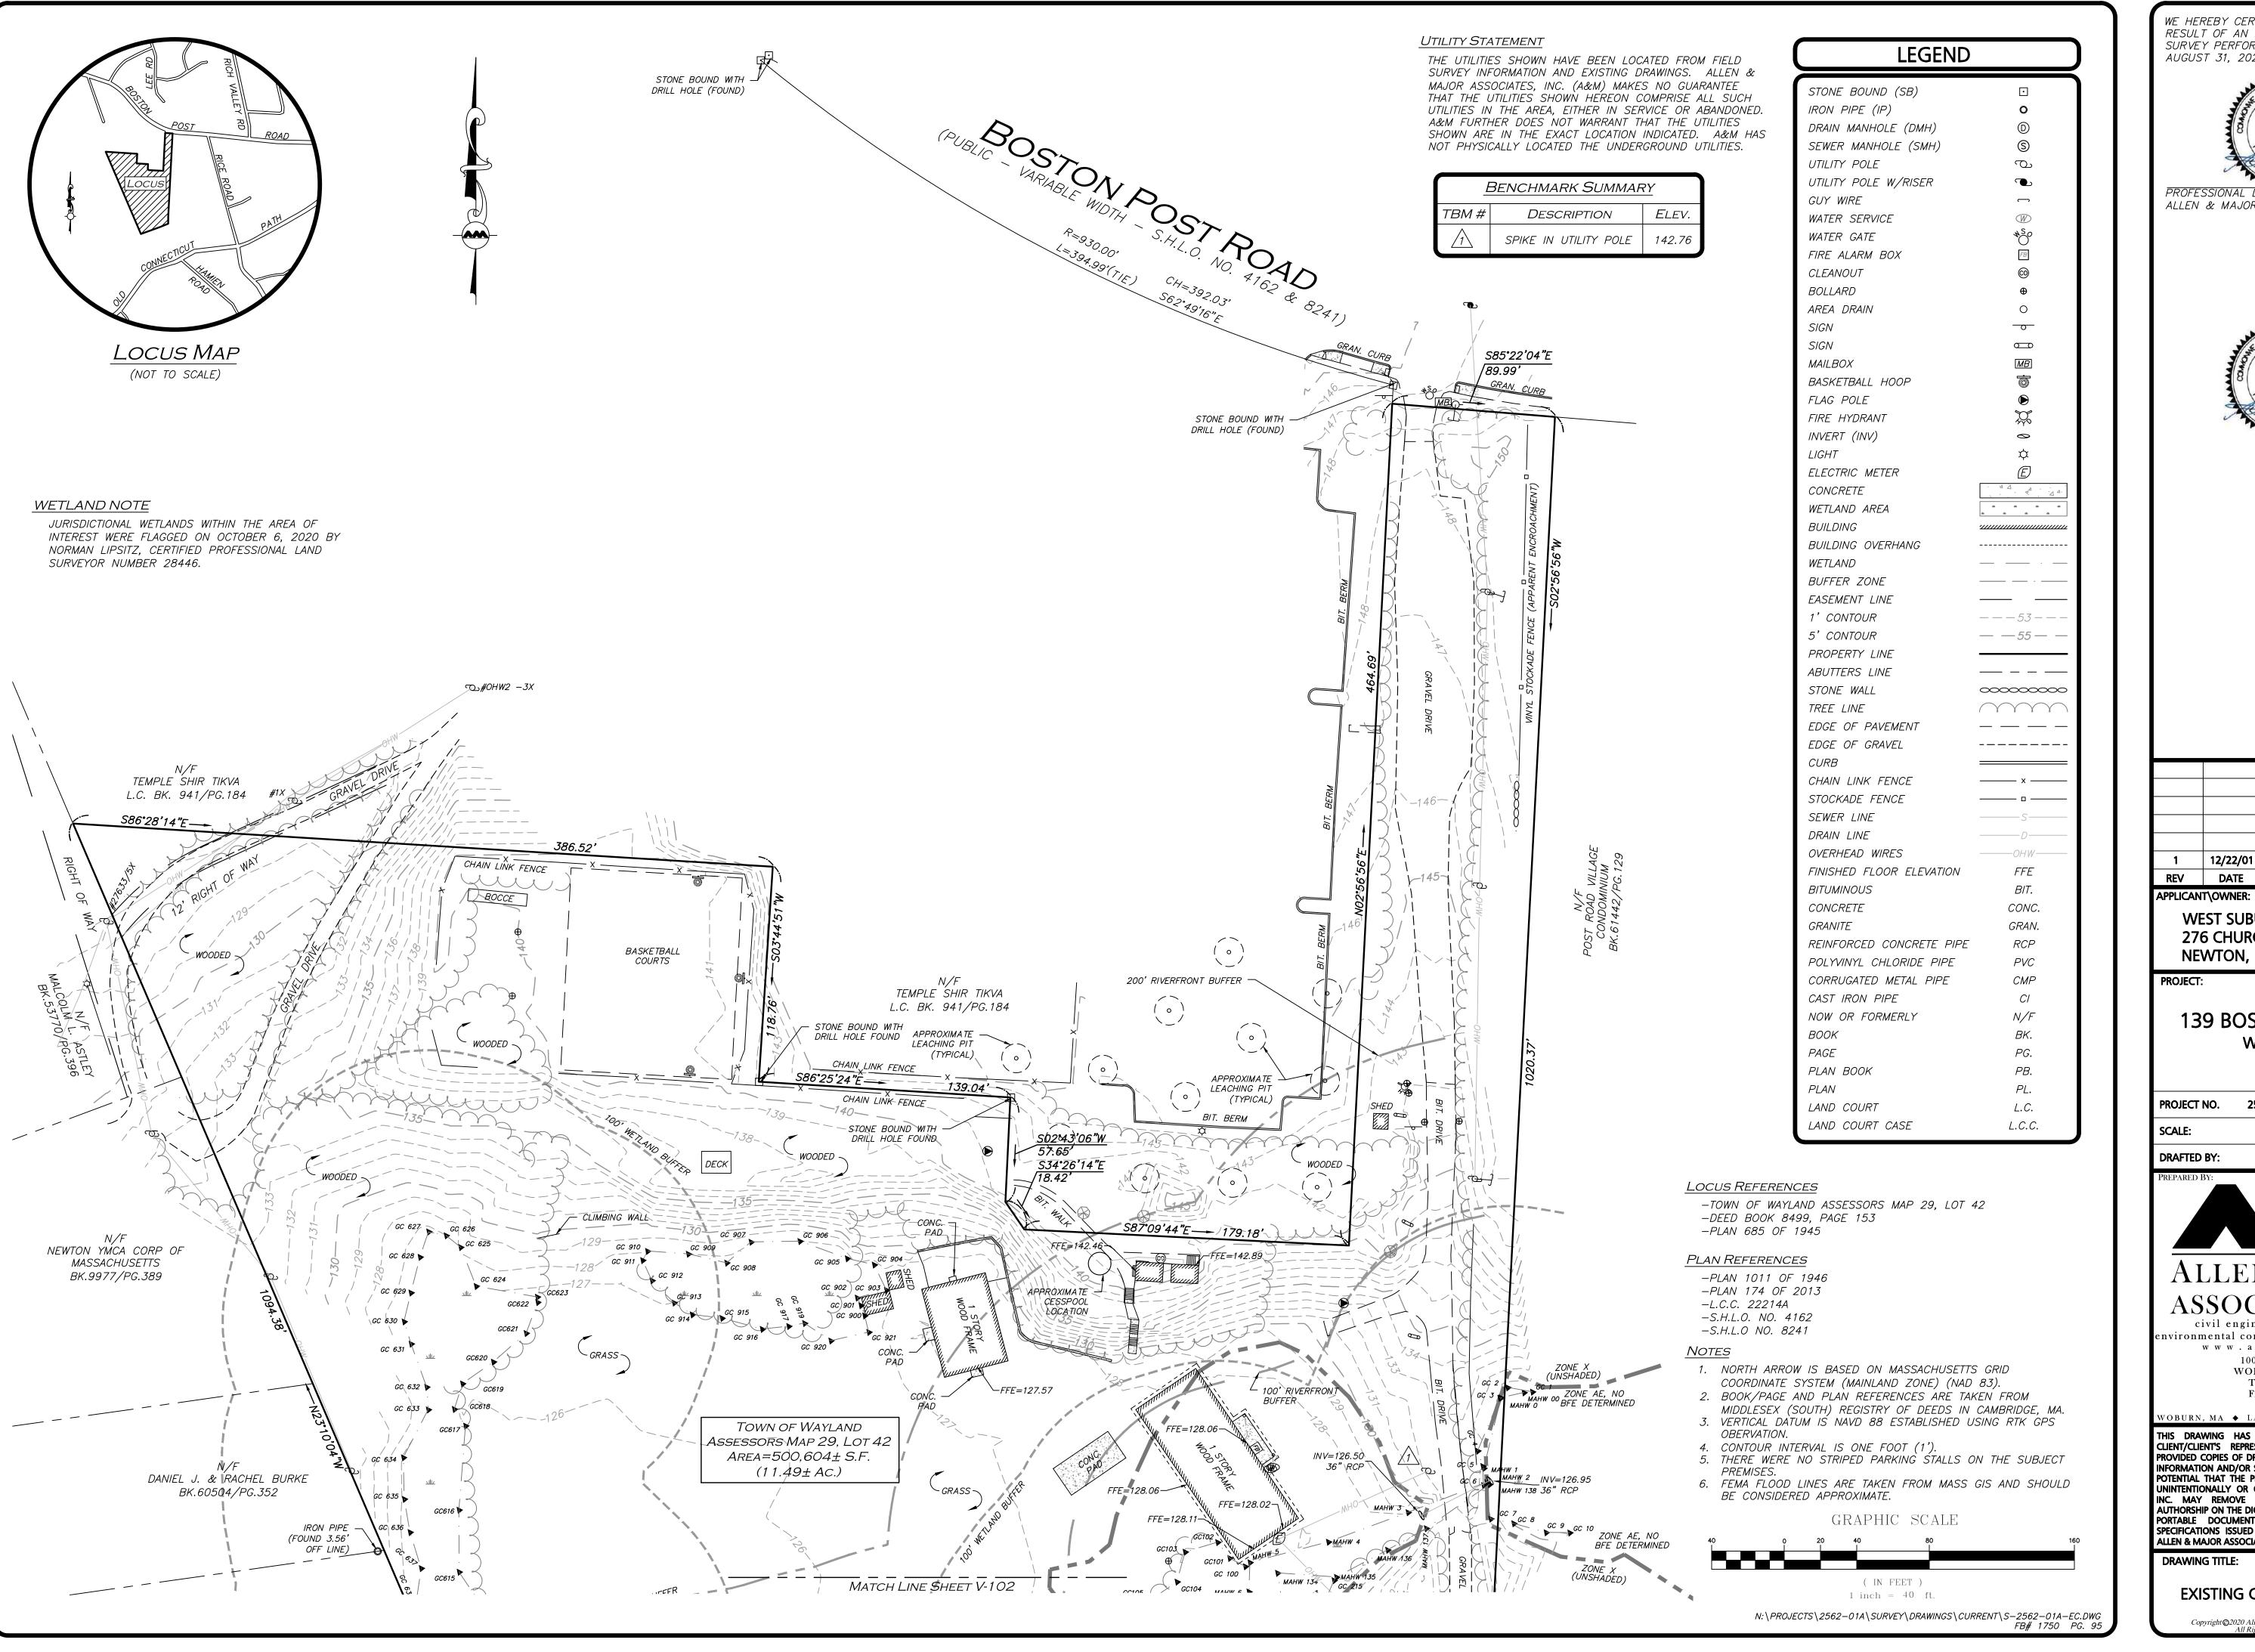

WE HEREBY CERTIFY THAT THIS PLAN IS THE RESULT OF AN ACTUAL ON THE GROUND SURVEY PERFORMED ON OR BETWEEN AUGUST 31, 2020 AND SEPTEMBER 30, 2020.

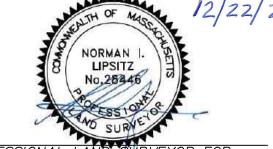

ALLEN & MAJOR ASSOCIATES, INC.



| 12/22/01 | ADD SEPTIC INFORMATION REV DATE DESCRIPTION

WEST SUBURBAN YMCA 276 CHURCH STREET **NEWTON, MA 02458**

PROJECT:

139 BOSTON POST ROAD WAYLAND, MA

2562-01A DATE: 10/02/20 1" = 40' DWG. NAME: S-2562-01A DRAFTED BY: AJR | CHECKED BY:



ASSOCIATES, INC.

civil engineering • land surveying nvironmental consulting • landscape architecture www.allenmajor.com 100 COMMERCE WAY WOBURN MA 01801-8501

TEL: (781) 935-6889 FAX: (781) 935-2896

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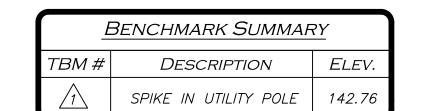
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SHEET No.

V-101

DRAWING TITLE:

EXISTING CONDITIONS



MATCH LINE SHEET V-101

TOWN OF WAYLAND

AREA=500,604± S.F.

(1 1.49± Ac.)

ASSESSORS MAP 29, LOT 42

GC109

ZONE AE, NO BFE DETERMINED

GRASS ~

NEWTON YMCA CORP OF

MASSACHUSETTS

BK.9977/PG.389

200' RIVERFRONT

100' RIVERFRONT

GC 641 🍗

GC 642 🕨

GC 643

NEWTON YMCA CORP OF

MASSACHUSETTS

BK.9977/PG.389

► MAHW 110

WETLAND NOTE

JURISDICTIONAL WETLANDS WITHIN THE AREA OF INTEREST WERE FLAGGED ON OCTOBER 6, 2020 BY NORMAN LIPSITZ, CERTIFIED PROFESSIONAL LAND SURVEYOR NUMBER 28446.

UTILITY STATEMENT

INV=127.24

IRON PIPE

POST ROAD VILLAGE CONDOMINIUM

BK.61442/PG.129

-INV(4" PVC)=146.27

RIM=140.25 INV(a)=134.07

INV(b)=RECESSED

INV(a)=145.73INV(b) = 147.63

NEWTON YMCA CORP OF

MASSACHUSETTS

BK.9340/PG.597

RIM=159.17

INV(a)=154.97

INV(b) = 154.57

(FOUND ON-LINE)

GC 302 (12" CMP)

THE UTILITIES SHOWN HAVE BEEN LOCATED FROM FIELD SURVEY INFORMATION AND EXISTING DRAWINGS. ALLEN & MAJOR ASSOCIATES, INC. (A&M) MAKES NO GUARANTEE THAT THE UTILITIES SHOWN HEREON COMPRISE ALL SUCH UTILITIES IN THE AREA, EITHER IN SERVICE OR ABANDONED. A&M FURTHER DOES NOT WARRANT THAT THE UTILITIES SHOWN ARE IN THE EXACT LOCATION INDICATED. A&M HAS NOT PHYSICALLY LOCATED THE UNDERGROUND UTILITIES.

LEGEND STONE BOUND (SB) IRON PIPE (IP) DRAIN MANHOLE (DMH) SEWER MANHOLE (SMH) UTILITY POLE UTILITY POLE W/RISER GUY WIRE WATER SERVICE WATER GATE FIRE ALARM BOX CLEANOUT BOLLARD AREA DRAIN SIGN SIGN MAILBOX BASKETBALL HOOP FLAG POLE FIRE HYDRANT INVERT (INV) LIGHT ELECTRIC METER A A . CONCRETE WETLAND AREA BUILDING BUILDING OVERHANG WETLAND BUFFER ZONE _____ EASEMENT LINE 1' CONTOUR ---53---5' CONTOUR — *— 55* — *–* PROPERTY LINE ABUTTERS LINE _____ STONE WALL 00000000 TREE LINE EDGE OF PAVEMENT _ _ _ _ EDGE OF GRAVEL -----CHAIN LINK FENCE _____ × ____ STOCKADE FENCE _____ SEWER LINE DRAIN LINE OVERHEAD WIRES FINISHED FLOOR ELEVATION FFE BITUMINOUS BIT. CONC. CONCRETE GRANITE GRAN.

LOCUS REFERENCES

-TOWN OF WAYLAND ASSESSORS MAP 29, LOT 42 -DEED BOOK 8499, PAGE 153 -PLAN 685 OF 1945

PLAN REFERENCES

-PLAN 1011 OF 1946 -PLAN 174 OF 2013 -L.C.C. 22214A -S.H.L.O. NO. 4162

-S.H.L.O NO. 8241

1. NORTH ARROW IS BASED ON MASSACHUSETTS GRID

REINFORCED CONCRETE PIPE

POLYVINYL CHLORIDE PIPE

CORRUGATED METAL PIPE

CAST IRON PIPE NOW OR FORMERLY

BOOK

PAGE


PLAN

PLAN BOOK

LAND COURT


LAND COURT CASE


- COORDINATE SYSTEM (MAINLAND ZONE) (NAD 83). 2. BOOK/PAGE AND PLAN REFERENCES ARE TAKEN FROM
- MIDDLESEX (SOUTH) REGISTRY OF DEEDS IN CAMBRIDGE, MA. 3. VERTICAL DATUM IS NAVD 88 ESTABLISHED USING RTK GPS
- OBERVATION. 4. CONTOUR INTERVAL IS ONE FOOT (1').
- 5. THERE WERE NO STRIPED PARKING STALLS ON THE SUBJECT
- 6. FEMA FLOOD LINES ARE TAKEN FROM MASS GIS AND SHOULD BE CONSIDERED APPROXIMATE.

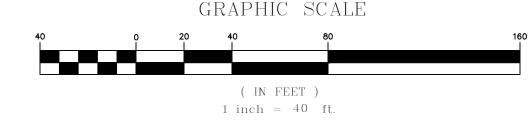

N:\PROJECTS\2562-01A\SURVEY\DRAWINGS\CURRENT\S-2562-01A-EC.DWG FB# 1750 PG. 95

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12/22/01 | ADD SEPTIC INFORMATION REV DATE DESCRIPTION

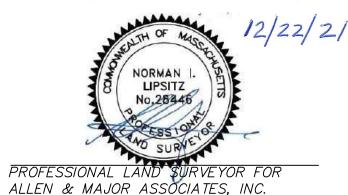APPLICANT\OWNER: WEST SUBURBAN YMCA **276 CHURCH STREET**

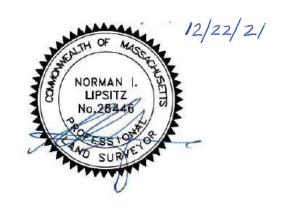NEWTON, MA 02458

PROJECT:

RCP

PVC

CMP

N/F

PG.

PB.

L.C.

L.C.C.

139 BOSTON POST ROAD WAYLAND, MA

2562-01A DATE: PROJECT NO. 10/02/20 1" = 40' DWG. NAME: S-2562-01A

DRAFTED BY: AJR | CHECKED BY:



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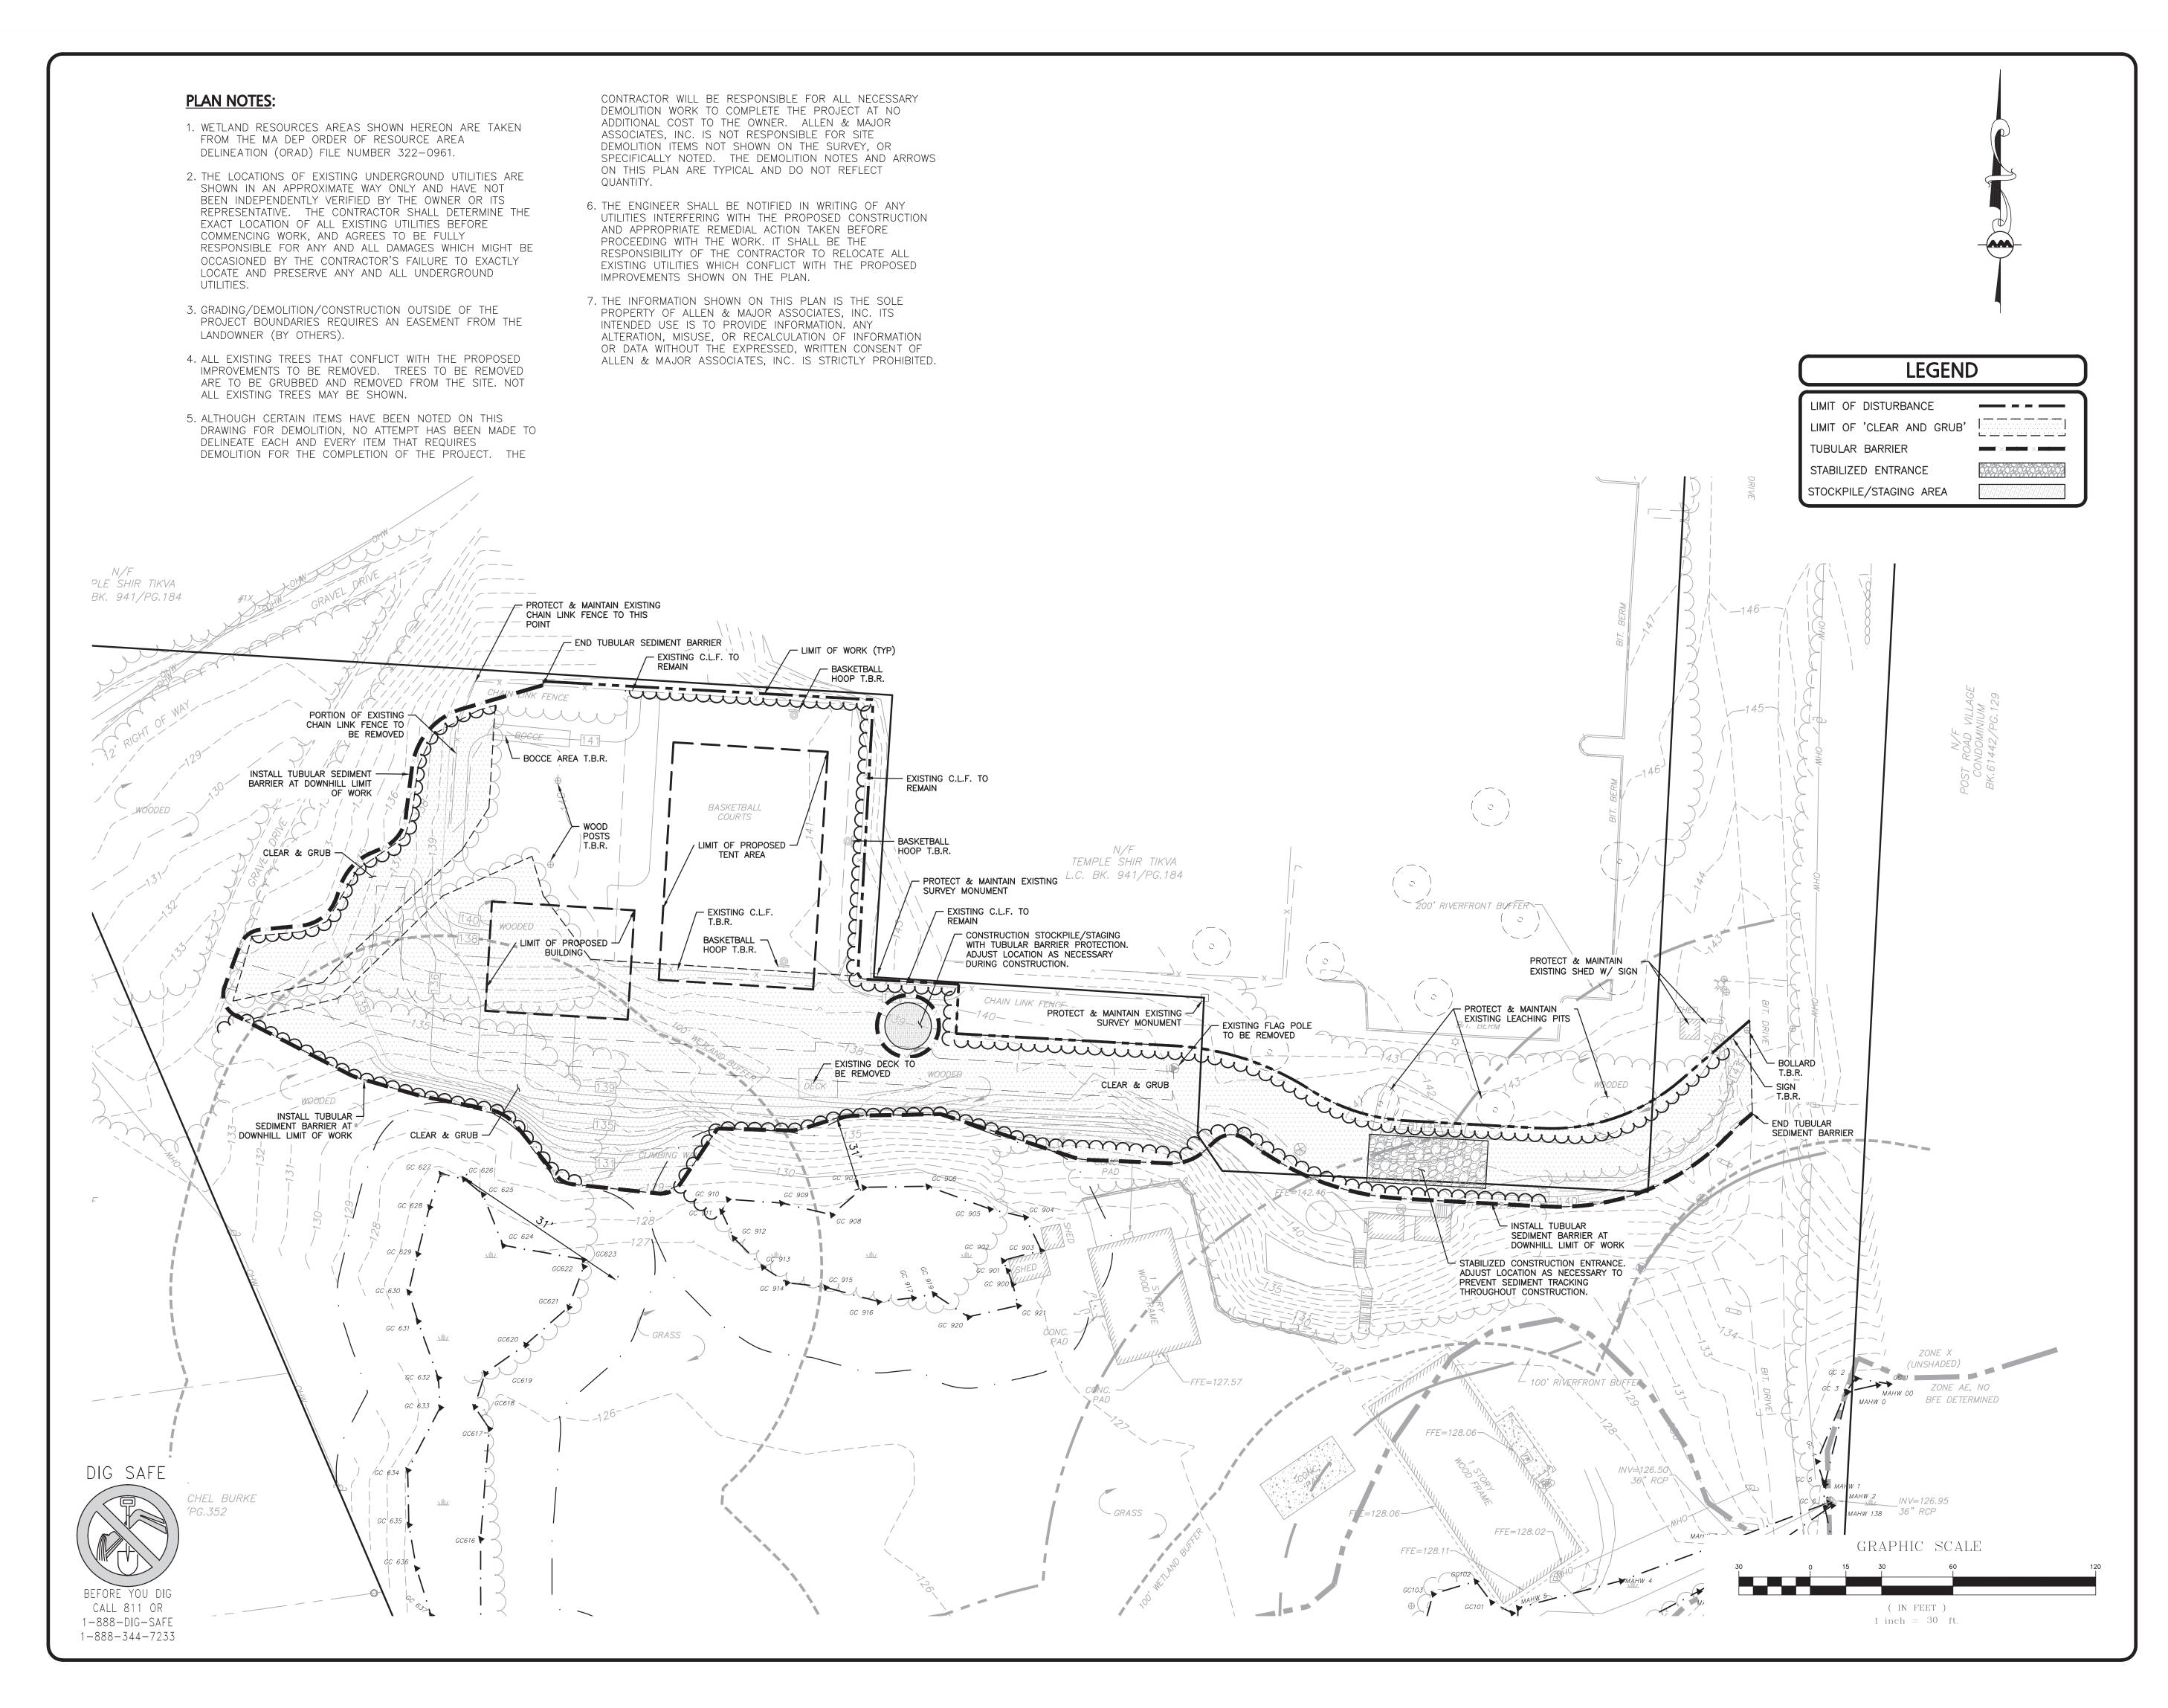
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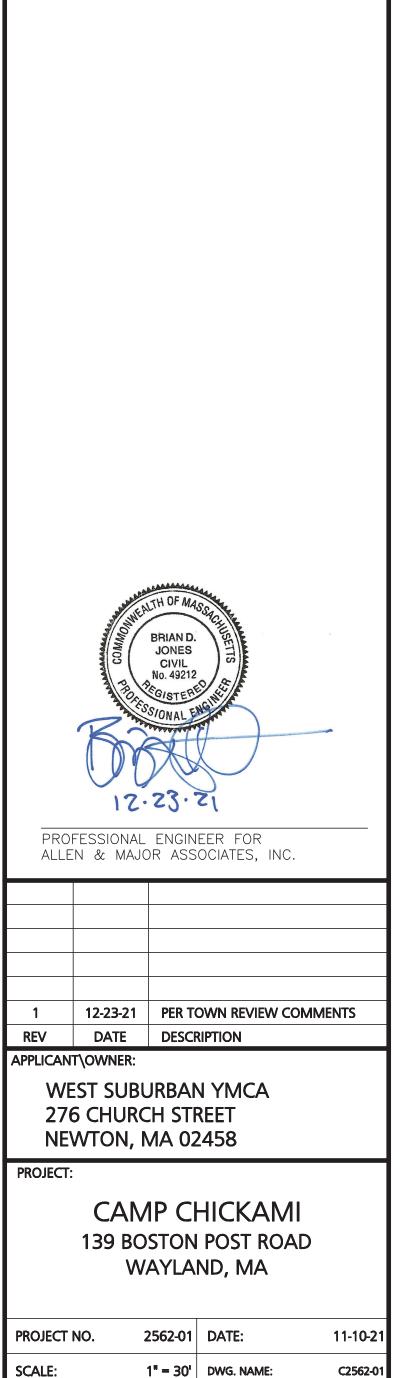
SHEET No. **DRAWING TITLE:**

V-102

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EXISTING CONDITIONS





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SHEET No.

C-101

ALLEN & MAJOR ASSOCIATES, INC.'S WORK PRODUCT.

SITE PREPARATION PLAN

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DRAWING TITLE:

DESIGNED BY:





USE	MINIMUM REQUIRED CALCULATION	MIN REQUIRED	TOTAL PROVIDED
MULTI-USE BUILDING	AS NEEDED PER § 198-506.1.10 "OFF-STREET PARKING"	N/A	7


- 1. ADA SPACES REQUIRED: FOR 1-25 TOTAL PARKING, 1 SHALL BE THE MINIMUM ADA PARKING PROVIDED ALSO BEING VAN ACCESSIBLE.
- 2. 506.1.10. FOR ANY AND ALL USES, BUILDINGS, OR STRUCTURES NOT SPECIFICALLY PROVIDED FOR IN THE FOREGOING ENUMERATION, SUCH PARKING SPACES AS THE SITE PLAN APPROVAL GRANTING AUTHORITY, IN ACCORDANCE WITH § 198-603, SHALL DETERMINE TO BE NECESSARY, CONSIDERING THE ACTIVITIES INVOLVED, TO PROVIDE A MAXIMUM OF SAFETY AND A MINIMUM OF CONGESTION ON THE ADJACENT ROADWAYS.

TOWN OF WAYLAND **R30 & R40 ZONES**

ITEM	REQUIRED/ALLOWED	EXISTING	PROPOSED
II EM	REQUIRED/ ALLOWED	EXISTING	PROPUSED
DIMENSIONAL REQUIREMENTS			
R30 — SINGLE RESIDENCE (0.92± AC.)			
LOT AREA (MIN)	30,000 SF	39,934± SF	39,934± SF
MINIMUM FRONTAGE (FT)	150 FT	N/A	N/A
FRONT SETBACK (FT)	30 FT	N/A	N/A
REAR SETBACK (FT)	30 FT	N/A	N/A
SIDE SETBACK (FT)	20 FT	N/A	N/A
PERCENT OF LOT COVERAGE (%)	20%	0%	0%
MAXIMUM STRUCTURE HEIGHT (FT)	35 FT	N/A	N/A
R40 - SINGLE RESIDENCE (10.57± AC.)			
LOT AREA (MIN)	40,000 SF	460,655± SF	460,655± SF
MINIMUM FRONTAGE (FT)	180 FT	90.0 FT	90.0 FT
FRONT SETBACK (FT)	30 FT	390.4 FT	390.4 FT
REAR SETBACK (FT)	30 FT	24.3 FT	24.3 FT
SIDE SETBACK (FT)	25 FT	10.0 FT	10.0 FT
PERCENT OF LOT COVERAGE (%)	20%	1.58%	3.43%
MAXIMUM STRUCTURE HEIGHT (FT)	35 FT	_	21.25 FT

NOTES:

- 1. DIMENSIONAL REQUIREMENTS ARE BROKEN UP BY ZONE AS THE SUBJECT PARCEL IS WITHIN BOTH THE R30
- 2. THE DAY CAMP USE IS ALLOWED WITHIN THE R30 & R40 ZONES BY ZBA SPECIAL PERMIT.

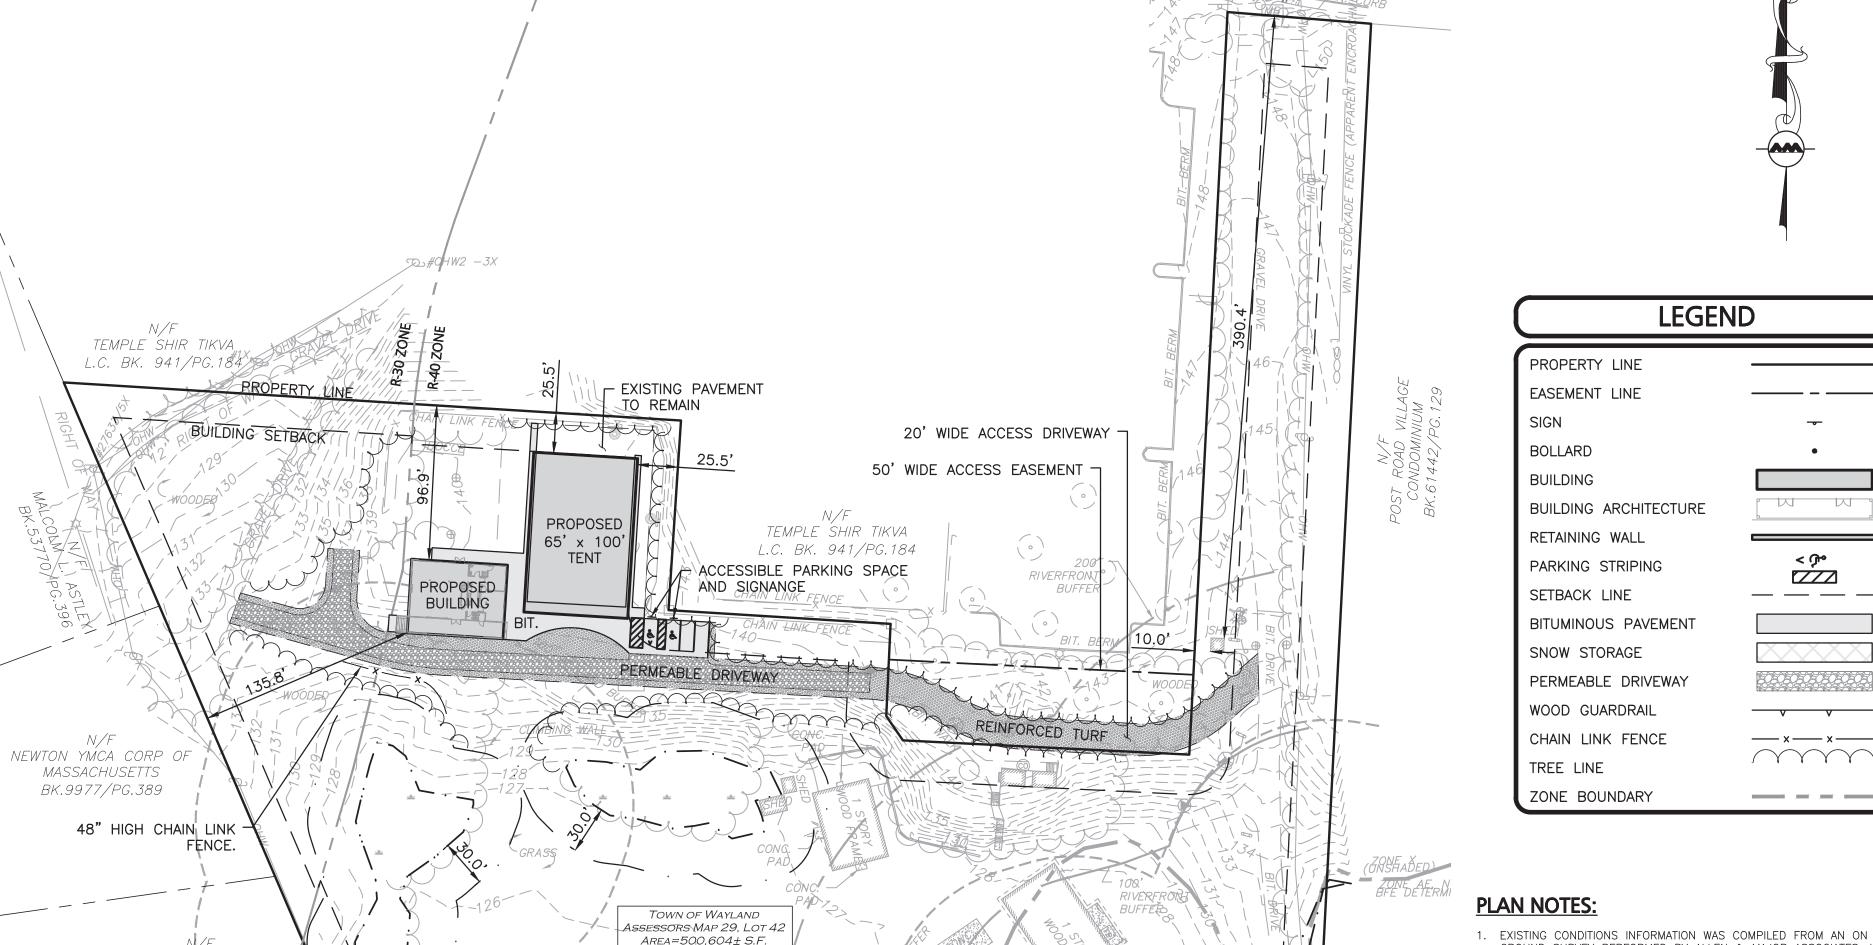

- 1. EXISTING CONDITIONS INFORMATION WAS COMPILED FROM AN ON THE GROUND SURVEY PERFORMED BY ALLEN & MAJOR ASSOCIATES, INC. IN OCTOBER OF 2020 AS WELL AS AVAILABLE RECORD PLANS
- 2. WETLAND RESOURCES AREAS SHOWN HEREON ARE TAKEN FROM THE MA DEP ORDER OF RESOURCE AREA DELINEATION (ORAD) FILE
- AND/OR ELEVATION OF EXISTING UTILITIES AND STRUCTURES AS SHOWN ON THESE PLANS IS BASED ON RECORDS OF VARIOUS UTILITY COMPANIES AND WHERE POSSIBLE, MEASUREMENTS TAKEN IN THE FIELD. THIS INFORMATION IS NOT TO BE RELIED ON AS BEING EXACT OR COMPLETE. THE LOCATION OF ALL UNDERGROUND UTILITIES AND STRUCTURES SHALL BE VERIFIED IN THE FIELD BY THE CONTRACTOR PRIOR TO THE START OF CONSTRUCTION.
- 4. THE CONTRACTOR MUST CONTACT THE APPROPRIATE UTILITY COMPANY, ANY GOVERNING PERMITTING AUTHORITY, AND "DIGSAFE" AT LEAST 72 HOURS PRIOR TO ANY EXCAVATION WORK. THE CONTRACTOR SHALL ALSO CONTACT THE CITY DEPARTMENT OF PUBLIC WORKS AT LEAST 72 HOURS PRIOR TO ANY EXCAVATION WORK TO REQUEST EXACT
- 5. THE ENGINEER SHALL BE NOTIFIED IN WRITING OF ANY UTILITIES INTERFERING WITH THE PROPOSED CONSTRUCTION AND APPROPRIATE REMEDIAL ACTION TAKEN BEFORE PROCEEDING WITH THE WORK. IT SHALL BE THE RESPONSIBILITY OF THE CONTRACTOR TO RELOCATE ALL EXISTING UTILITIES WHICH CONFLICT WITH THE PROPOSED
- 6. WRITTEN DIMENSIONS ON THIS PLAN TAKE PRECEDENCE OVER SCALED DIMENSIONS. THE CONTRACTOR SHALL USE CAUTION WHEN SCALING REPRODUCED PLANS. IN THE EVENT OF A CONFLICT BETWEEN THIS PLAN SET AND ANY OTHER DRAWINGS AND/OR SPECIFICATIONS OR CONDITIONS, THE ENGINEER SHALL BE NOTIFIED
- 7. THE INFORMATION SHOWN ON THIS PLAN IS THE SOLE PROPERTY OF ALLEN & MAJOR ASSOCIATES, INC. ITS INTENDED USE IS TO PROVIDE INFORMATION. ANY ALTERATION, MISUSE, OR RECALCULATION OF INFORMATION OR DATA WITHOUT THE EXPRESSED, WRITTEN CONSENT OF ALLEN & MAJOR ASSOCIATES,

GRAPHIC SCALE

(IN FEET)

1 inch = 60 ft.



PROFESSIONAL ENGINEER FOR ALLEN & MAJOR ASSOCIATES, INC.

DATE DESCRIPTION

WEST SUBURBAN YMCA

CAMP CHICKAMI

139 BOSTON POST ROAD

WAYLAND, MA

2562-01 DATE:

1" = 60' DWG. NAME:

JG | CHECKED BY:

11-10-21

C2562-01

276 CHURCH STREET

NEWTON, MA 02458

REV

PROJECT:

PROJECT NO.

DESIGNED BY:

SCALE:

APPLICANT\OWNER:

12-23-21 PER TOWN REVIEW COMMENTS

DRAWING TITLE:

LAYOUT & MATERIALS PLAN

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SHEET No. C-102

AREA=500,604± S.F. (11.49± Ac.) DANIEL J. & RACHEL BURK OBTAINED FROM THE TOWN OF WAYLAND AND OTHER SOURCES. BK.60504/PG.352 NUMBER 322-0961. 3. THE CONTRACTOR IS SPECIFICALLY CAUTIONED THAT THE LOCATION RIVERFRONT BUFFER , FIELD LOCATION OF LOCAL UTILITIES. RIVERFRONT IMPROVEMENTS SHOWN ON THE PLANS. EWTON YMCA CORP OF *MASSACHUSETTS* BK.9977/PG.389 BY THE CONTRACTOR. ST ROAD VILLAGE CONDOMINIUM 3K.61442/PG.129 INC. IS STRICTLY PROHIBITED.


> NEWTON YMCA CORP OF MASSACHUSETTS

> > BK.9340/PG.597

NEWTON YMCA CORP

MASSACHUŞETTS

BK.9977/PG.389

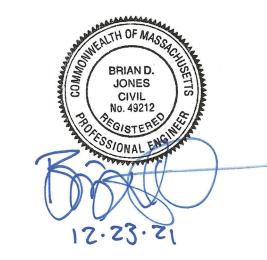

PROFESSIONAL ENGINEER FOR ALLEN & MAJOR ASSOCIATES, INC.

12-23-21 PER TOWN REVIEW COMMENTS

DATE DESCRIPTION REV

APPLICANT\OWNER:

WEST SUBURBAN YMCA **276 CHURCH STREET NEWTON, MA 02458**

PROJECT:

CAMP CHICKAMI 139 BOSTON POST ROAD WAYLAND, MA

2562-01 DATE: PROJECT NO. 11-10-21 SCALE: 1" = 30' DWG. NAME:

DESIGNED BY: JG | CHECKED BY:

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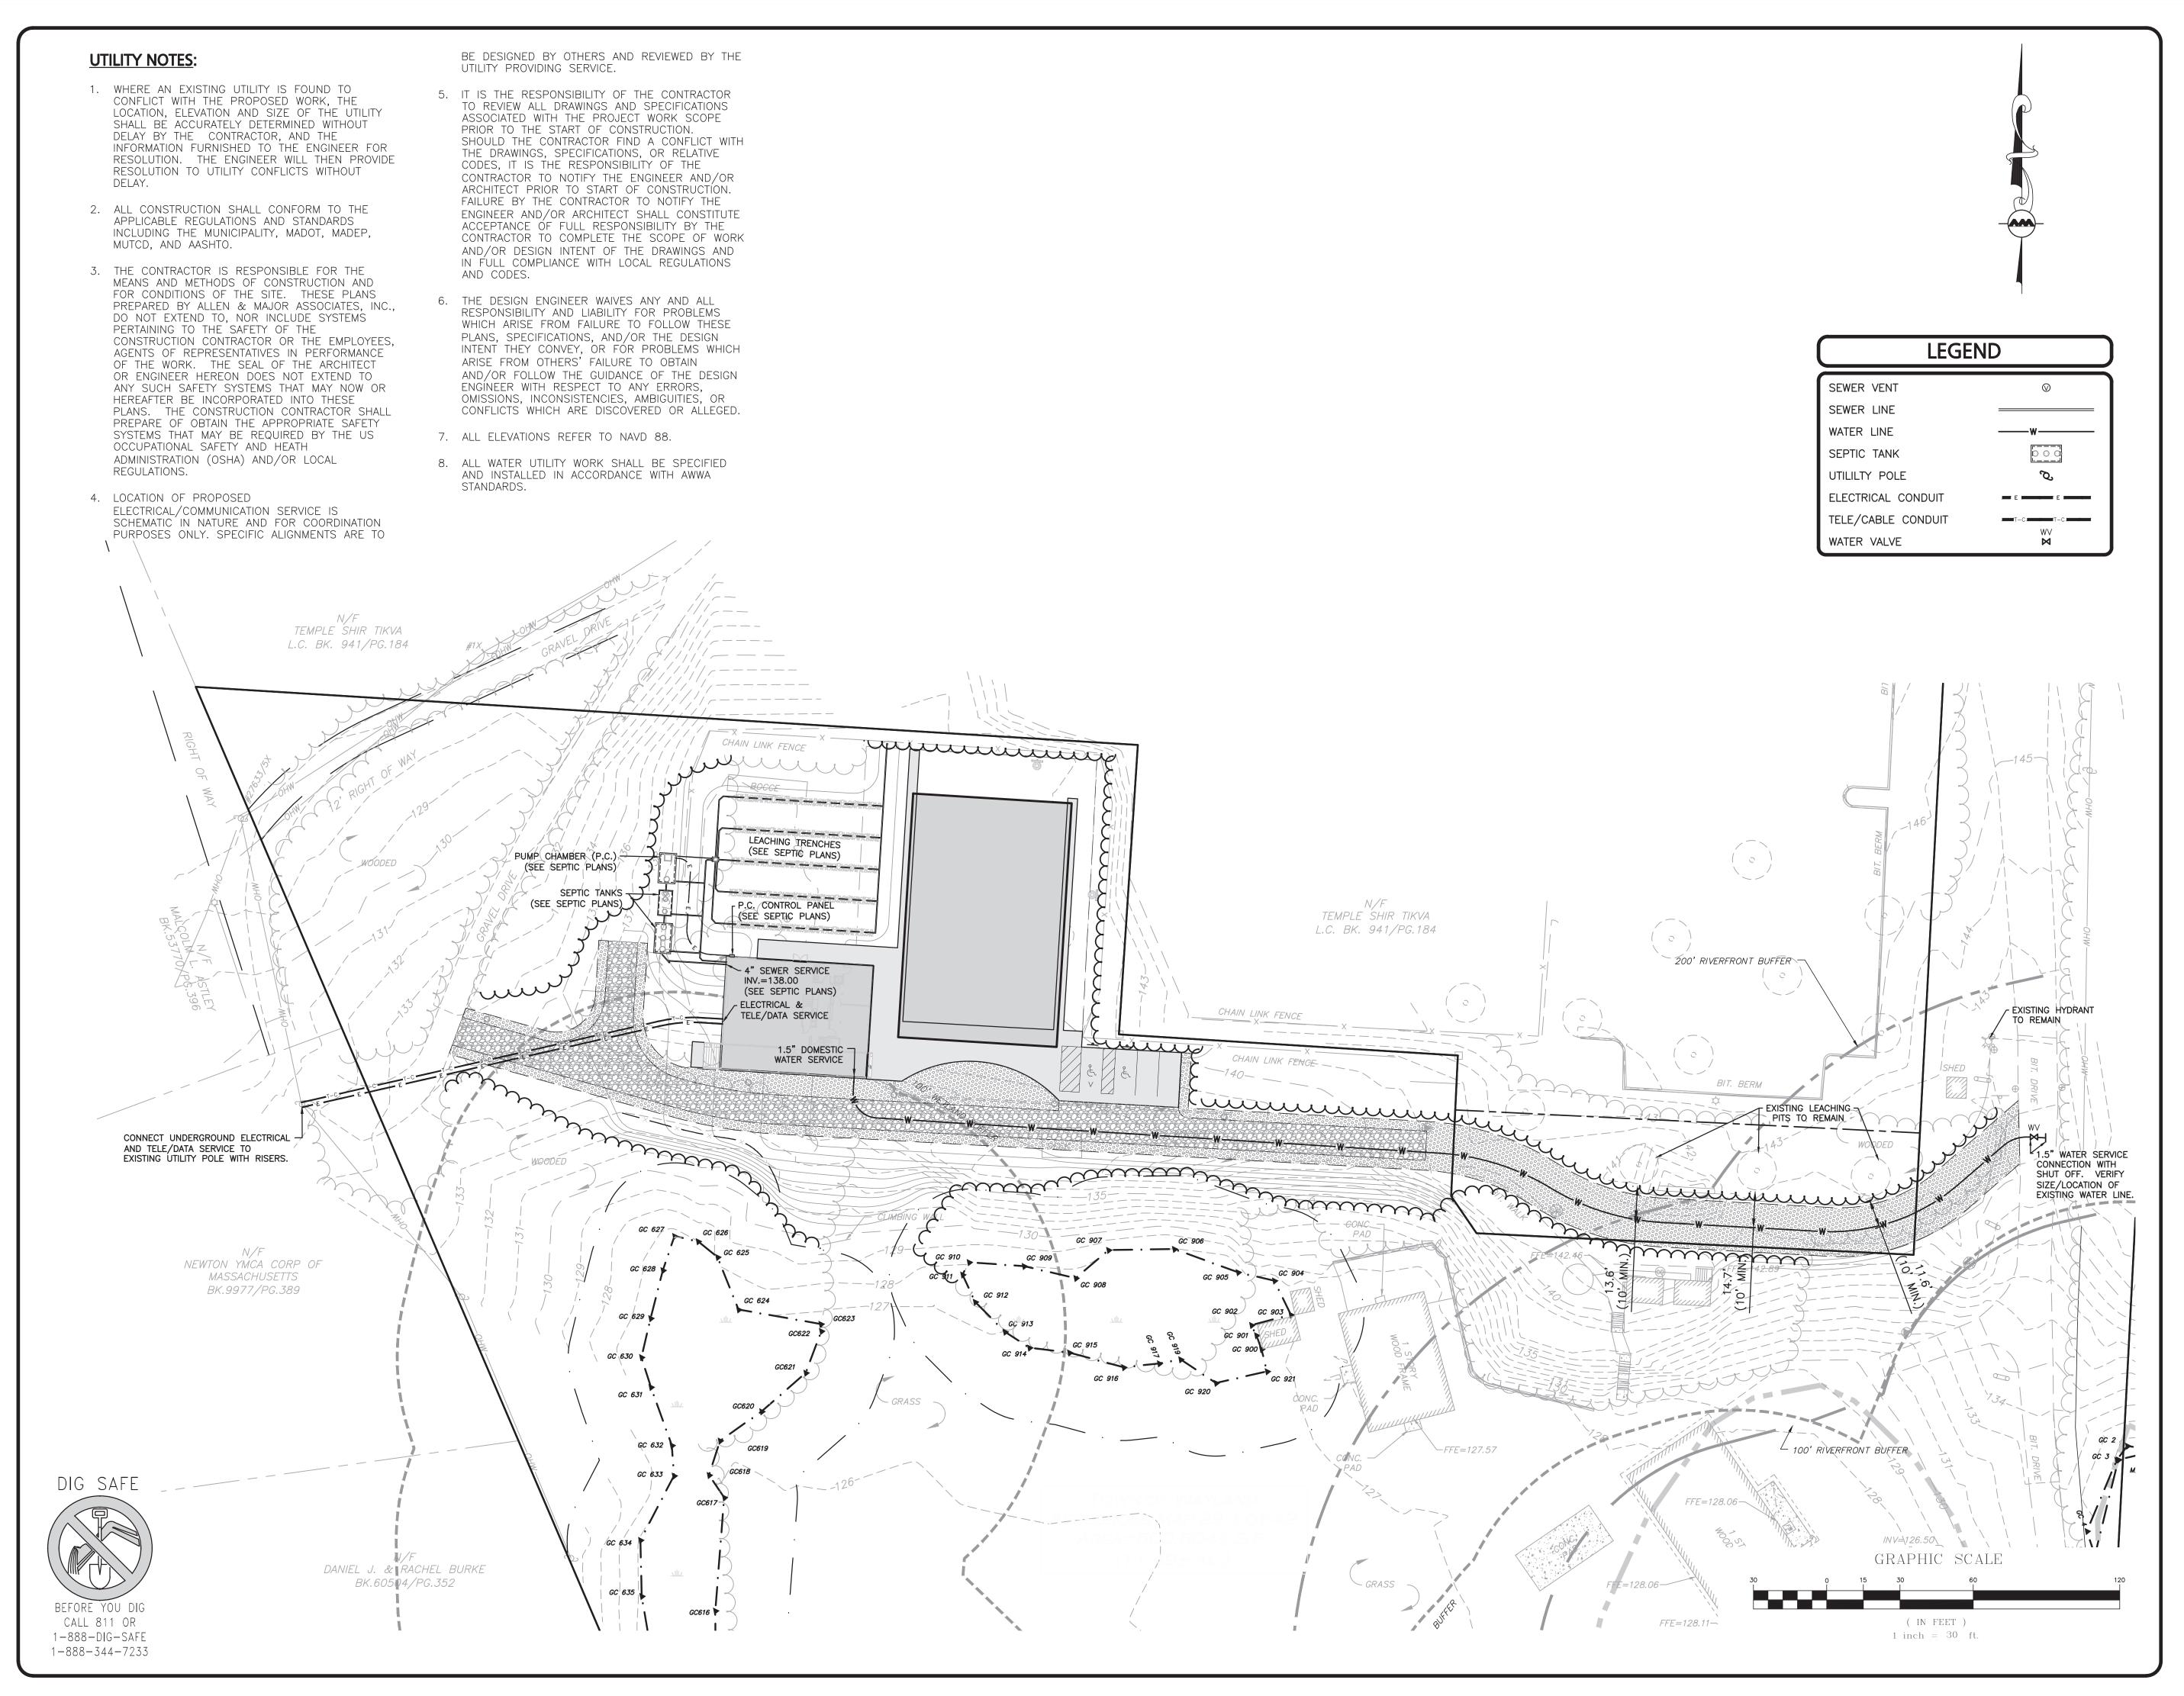
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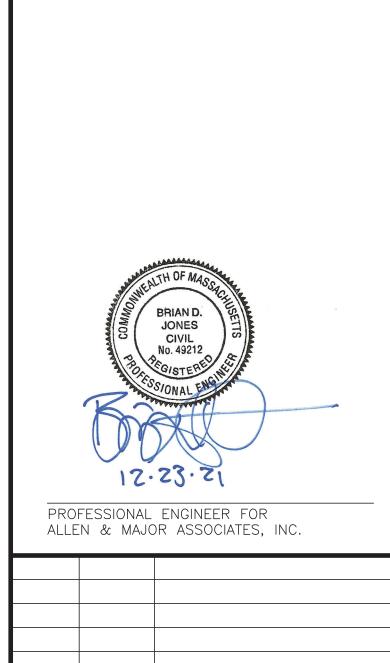
DRAWING TITLE:

SHEET No.

GRADING & DRAINAGE PLAN C-103







276 CHURCH STREET
NEWTON, MA 02458

PROJECT:

CAMP CHICKAMI
139 BOSTON POST ROAD
WAYLAND, MA

12-23-21 PER TOWN REVIEW COMMENTS

REV DATE DESCRIPTION

WEST SUBURBAN YMCA

APPLICANT\OWNER:

 PROJECT NO.
 2562-01
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 11-10-21

 SCALE:
 1" = 30'
 DWG. NAME:
 C2562-01

 DESIGNED BY:
 JG
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DRAWING TITLE:

SHEET No.

UTILITIES PLAN

C-104



12-23-21 PER TOWN REVIEW COMMENTS

REV DATE DESCRIPTION APPLICANT\OWNER:

WEST SUBURBAN YMCA 276 CHURCH STREET

NEWTON, MA 02458 PROJECT:

> CAMP CHICKAMI 139 BOSTON POST ROAD WAYLAND, MA

2562-01 DATE: PROJECT NO.

SCALE: 1" = 30' DWG. NAME:

JG CHECKED BY:

DESIGNED BY:



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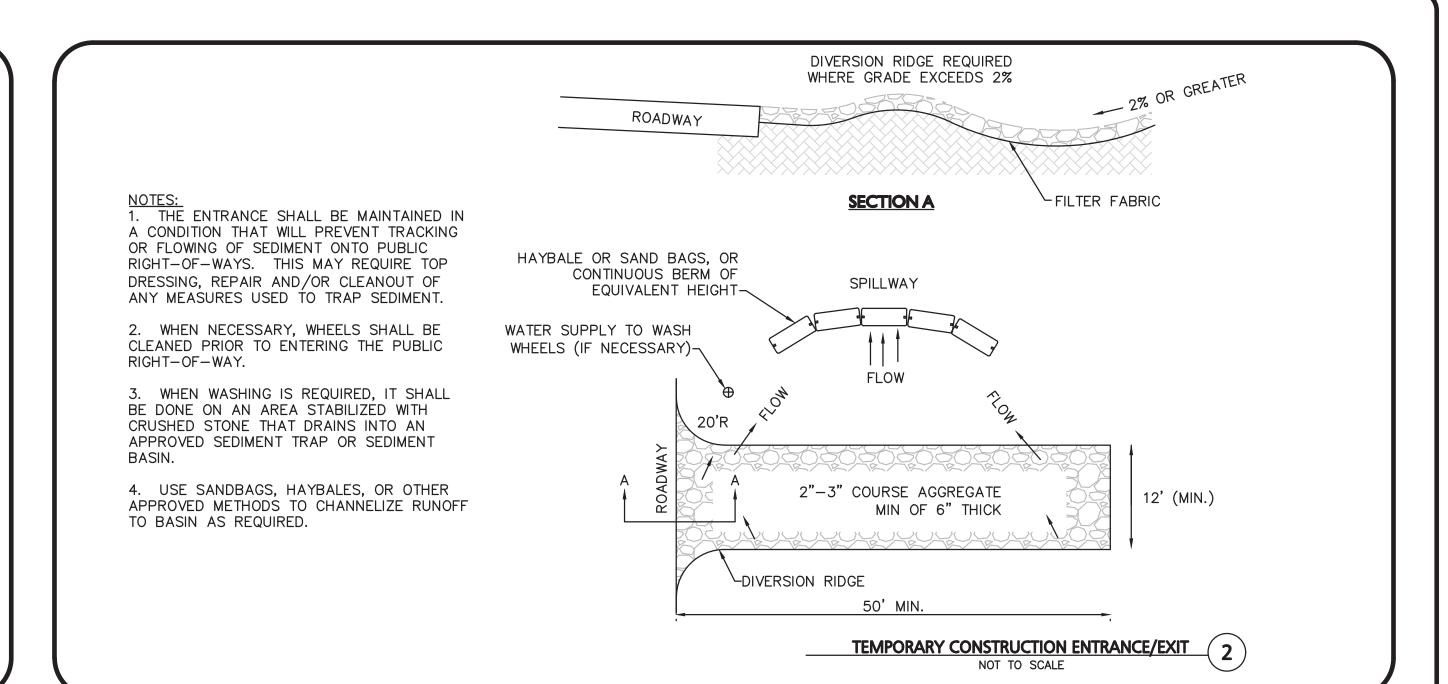
11-10-21


C-105 TRUCK TURN PLAN

1. ALL MATERIALS TO MEET MANUFACTURERS SPECIFICATIONS.


- 2. INSTALL WOODEN STAKES IN A CRISS-CROSS PATTERN EVERY 8' ON CENTER.
- 3. OVERLAP TURBULAR BARRIER SEGMENTS A MINIMUM OF 12".
- 4. THE CONTRACTOR SHALL MAINTAIN THE TUBULAR SEDIMENT CONTROLS IN A FUNCTIONAL CONDITION AT ALL TIMES. THE CONTROLS SHALL BE ROUTINELY INSPECTED BY THE CONTRACTOR.
- 5. WHERE THE TUBULAR SEDIMENT CONTROLS REQUIRE REPAIR OR SEDIMENT, IT WILL BE ROUTINELY COMPLETED BY THE CONTRACTOR AT NO ADDITIONAL COST.
- 6. AT A MINIMUM, THE CONTRACTOR SHALL REMOVE SEDIMENTS COLLECTED AT THE BASE WHEN THEY REACH 1/3 THE EXPOSED HEIGHT OF THE BARRIER, OR IF MORE FREQUENTLY AS DIRECTED BY THE ENGINEER.

TUBULAR SEDIMENT BARRIER NOT TO SCALE



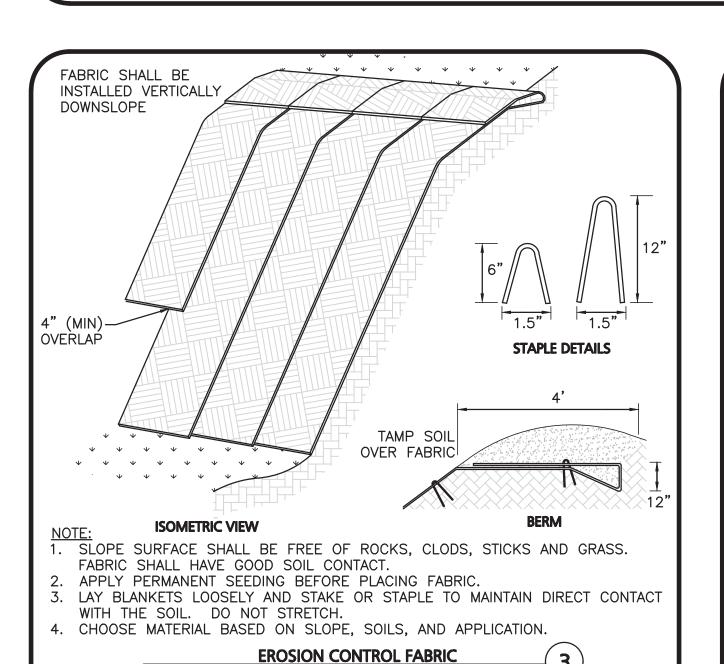

NOT TO SCALE

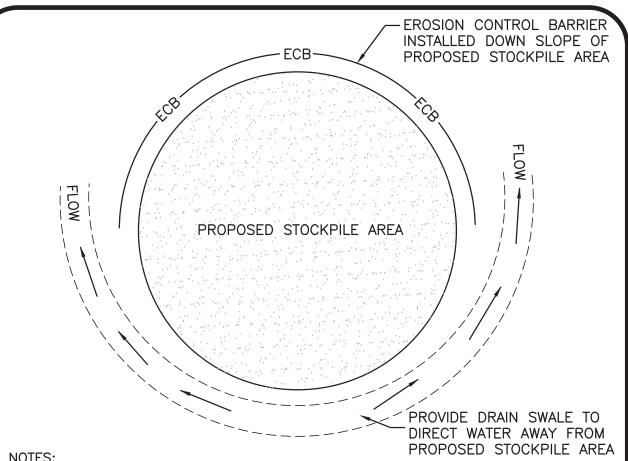

NOTES:

1. SOIL AND FILL STOCKPILES EXPECTED TO REMAIN IN PLACE FOR LESS THAN 90 DAYS SHALL BE COVERED WITH STRAW AND MULCH (AT 100LBS/1,000 SF), OR WITH AN ANCHORED TARP WITHIN 7 DAYS OR PRIOR TO ANY RAINFALL. 2. SOIL AND FILL STOCKPILES EXPECTED TO REMAIN IN PLACE FOR 90 DAYS OR MORE SHALL BE SEEDED WITH WINTER RYE (FOR FALL SEEDING AT 1LB/1,000 SF) OR OATS (FOR SUMMER SEEDING AT 2LB/1,000 SF) AND THEN COVERED WITH HAY MULCH (AT 100LB/1.000 SF) OR AN ANCHORED TARP WITHIN 7 DAYS OR PRIOR TO ANY RAINFALL.


STOCKPILE PROTECTION DETAIL


NOT TO SCALE


NOTES:

- 1. MINIMUM BURIAL DEPTH (FINISH GRADE TO TOP OF PIPE) GRAVITY PIPE (SEWER & DRAIN) - SEE PLAN OR PROFILE PRESSURE PIPE UNDER PAVING - 4' PRESSURE PIPE BENEATH UNPAVED - 3' WATER PIPE - 5'
- 2. WHERE BACKFILL IS DESIGNATED AS COMPACTED, THIS MEANS 90 TO 95% STANDARD PROCTOR. AASHTO T-99. ALL FILL PLACED BELOW PIPES AND STRUCTURES MUST MEET THIS REQUIREMENT.
- 3. WHERE WASTE FILLS ARE ENCOUNTERED AT SUBGRADE LEVEL FOR NEW UTILITIES. THE FILL SHOULD BE OVER-EXCAVATED, THE SUBGRADE SHOULD BE RE-COMPACTED, AND BACKFILL CONSISTING OF PIPE BEDDING MATERIAL, CRUSHED STONE OR OTHER SUITABLE GRANULAR FILL SHOULD BE PLACED TO A SUFFICIENT DEPTH TO CREATE A FIRM AND STABLE SUBGRADE (TYPICALLY 12 TO 18 INCHES OVER-EXCAVATIO
- 4. REFER TO EZ R

EXCAVATION). TO EZ ROLL PERMEABLE GRASS & GRAVEL PAVER DETAIL.			SUITABLE FOR REUSE ON—SITE AS BACKFILL	
FILTER FABRIC USE		34" CRUSHED STONE BEDDING USED FOR RCP, HDPE, PVC AND DI PIPES. OTHER MATERIALS PER MANUFACTURER RECOMMENDATIONS	6"	
	SOIL	TYPE	RECOMMENDATIONS	
	SILT OR CLAY	GRANULAR SOIL	FILTER FABRIC	_
ABOVE GROUND WATER	FILTER FABRIC NOT REQUIRED	FILTER FABRIC NOT REQUIRED	(SEE TABLE)	
BELOW GROUND WATER	FILTER FABRIC REQUIRED	FILTER FABRIC NOT REQUIRED	U	TILITY TRENCH
				NOT TO SCALE

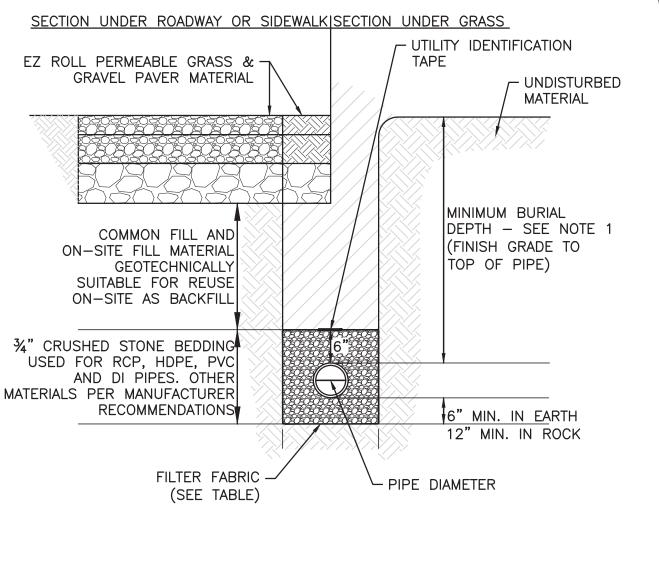

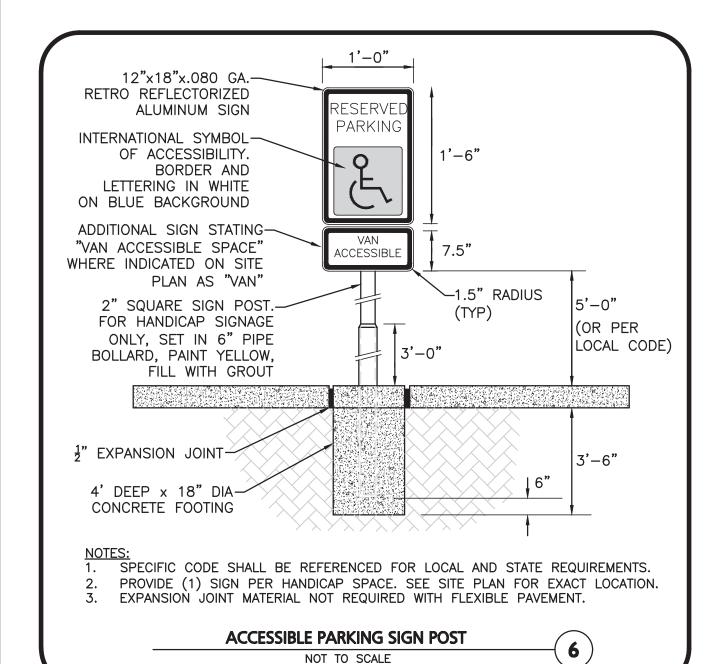

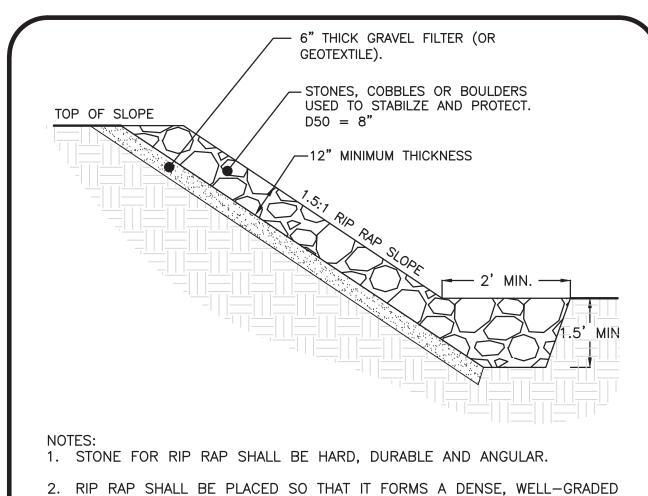


3. CARE SHALL BE TAKEN NOT TO DISLODGE THE FILTER LAYER WHEN


RIP RAP SLOPE


NOT TO SCALE

MASS OF STONE WITH MINIMUM OF VOIDS.

PLACING THE STONES.

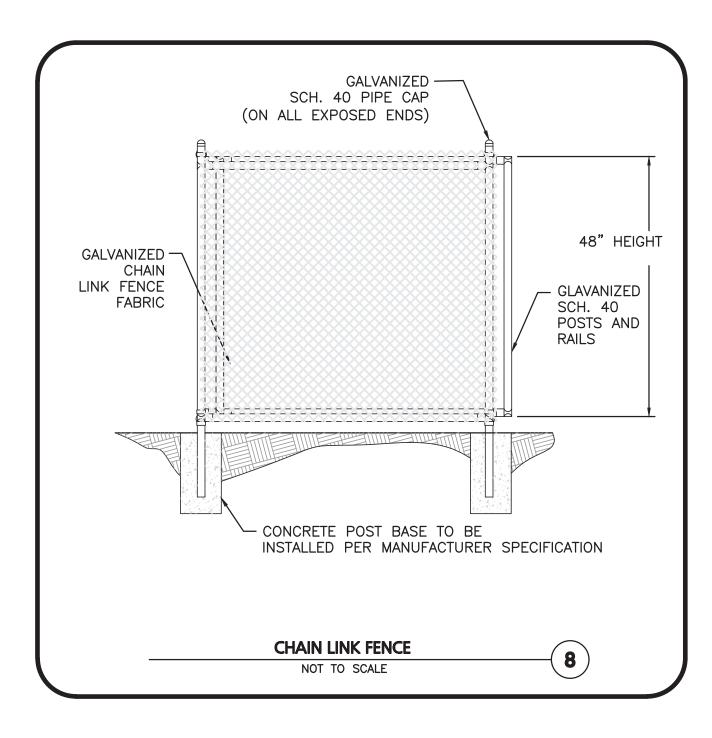

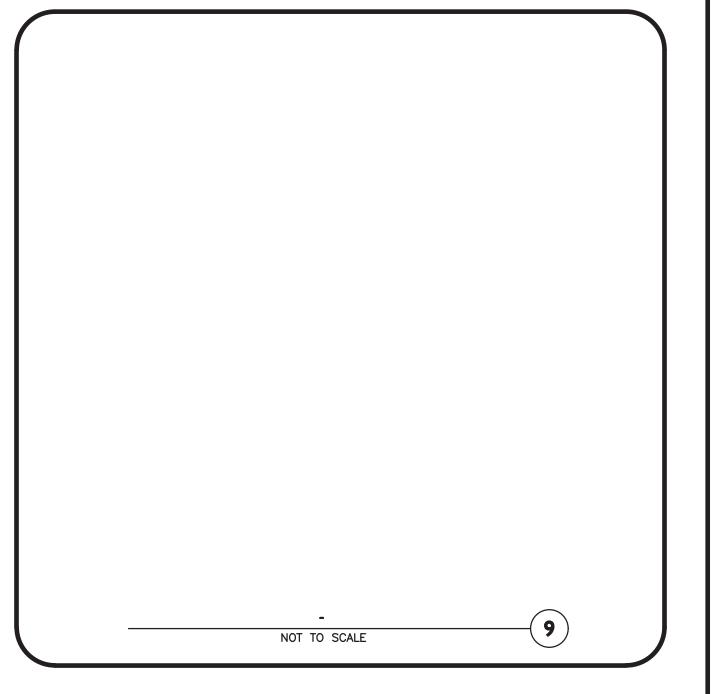

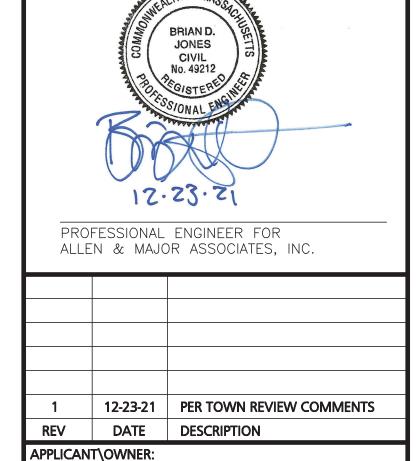

PROJECT:

(5)

CAMP CHICKAMI 139 BOSTON POST ROAD WAYLAND, MA

WEST SUBURBAN YMCA

276 CHURCH STREET

NEWTON, MA 02458

2562-01 DATE: PROJECT NO. 11-10-21 AS SHOWN DWG. NAME: C2562-01 **DESIGNED BY:** JG | CHECKED BY:



ASSOCIATES, INC. civil engineering • land surveying nvironmental consulting • landscape architecture www.allenmajor.com 100 COMMERCE WAY, SUITE 5

WOBURN MA 01801 TEL: (781) 935-6889 FAX: (781) 935-2896

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SHEET No.

C-501

DRAWING TITLE:

DETAILS

PLAN VIEW

EZ ROLL GRASS PAVER PRODUCT DESCRIPTION CELL SIZE: 2-1/4" HEXAGONAL CELLS

STOCK ROLL SIZES: 4'W X 150'L (600 SQ. FT.)

EZ ROLL GRASS PAVER NOTES:

ENGINEERING PROPERTIES:

1. COMPRESSIVE STRENGTH OF EZ ROLL: EMPTY PAVERS: ULTIMATE LOAD = 53,683 LBS / 373 PSI

FILLED PAVERS: ULTIMATE LOAD = 400,000 LBS

2. NDS RECOMMENDS NATIVE TOP SOIL FOR BACKFILL INSIDE THE PAVERS.

- EXTEND TOP SOIL INSIDE PAVER AN ADDITIONAL \$\frac{1}{4}\$ TO \$\frac{1}{2}\$ INCH ABOVE PAVER SURFACE AND MATCH SURROUNDING GRADE. PROPOSED FINISHED GRADE SLOPE PER PROJECT GRADING PLAN. PROTECT PAVER AREA UNTIL GRASS IS SUFFICIENTLY ESTABLISHED TO HANDLE TRAFFIC. PROVIDE 1" (MIN.) CLEARANCE BETWEEN ANY CONCRETE EDGE AND PAVER.
- GRASS PAVERS ARE TO BE USED FOR AREAS OF PEDESTRIAN USE, EROSION CONTROL, AND OCCASIONAL VEHICULAR TRAFFIC USE (E.G., OVERFLOW PARKING AND EMERGENCY/FIRE LANES).

AASHTO #57 BASE ROCK:

- 5. GRADATION OF AASHTO #57 COARSE BASE ROCK: 100% PASSING 12" SCREEN, 95-100% PASSING 1", 25-60% PASSING $\frac{1}{2}$ ", AND 0-10% PASSING #8 SCREEN.
- THICKNESS OF AGGREGATE LAYER IS AS FOLLOWS: NO BASE REQUIRED FOR EROSION CONTROL AND PEDESTRIAN-ONLY LOADS (COMPACTION OF NATIVE SOIL RECOMMENDED FOR SLOPES UP TO 3%); 4 INCHES FOR LIGHT LOADS (GOLF CARTS); 6 INCHES FOR MEDIUM LOADS (CARS AND PICKUP TRUCKS); 8 INCHES FOR HEAVY LOADS (FIRE TRUCKS).
- COMPACT WITH ONE TO THREE PASSES OF 5-TON STEEL WHEEL ROLLER SINCE IT IS DIFFICULT TO MEASURE DENSITY OF COARSE AGGREGATE, APPROACH OF REQUIRING A FIXED DENSITY IS NOT

SUBGRADE NATIVE SOIL:

- COMPACT SUBGRADE NATIVE SOILS TO 95% STANDARD PROCTOR DENSITY PER ASTM D696 FOR SOILS WITH CALIFORNIA BEARING RATIO >20%, R VALUE >30, AASHTO A-1, A-2, AND A-3 SOILS.
- NDS RECOMMENDS THAT ENGINEER-OF-RECORD CONSIDER HIGHER LEVEL OF COMPACTION FOR CBR 5 TO 20%, R-VALUE 10 TO 30, AASHTO A-4 SOILS FOR HEAVY LOADS WHERE INFILTRATION INTO NATIVE SOILS IS NOT A REQUIREMENT.
- 10. NDS RECOMMENDS THAT ENGINEER-OF-RECORD CONSULT WITH PROJECT GEOTECHNICAL ENGINEER FOR POTENTIAL SOIL MODIFICATION (E.G., LIME TREATMENT) AND COMPACTION LEVEL FOR CBR <5% AND R-VALUE <10, AASHTO A-5, A-6, AND A-7 SOILS.

LATERAL SNAP LOCKS -

PLAN VIEW

EZ ROLL GRAVEL PAVER -

EZ ROLL GRAVEL PAVER PRODUCT DESCRIPTION CELL SIZE: 2-1/4" HEXAGONAL CELLS

STOCK ROLL SIZES: 4'W X 150'L (600 SQ. FT.)

EZ ROLL GRAVEL PAVER NOTES:

ENGINEERING PROPERTIES:

- 1. COMPRESSIVE STRENGTH OF EZ ROLL: EMPTY PAVERS: ULTIMATE LOAD = 53,683 LBS / 373 PSI
 - FILLED PAVERS: ULTIMATE LOAD = 500,000 LBS
- 2. POROSITY OF AASHTO #57 AGGREGATE = 0.4

3. NDS RECOMMENDS UNIFORMLY-GRADED 3/8" CLEAN CRUSHED ANGULAR STONE OR AASHTO #6.

4. EXTEND § "GRAVEL INSIDE PAVER AN ADDITIONAL \$\frac{1}{4}\$ TO \$\frac{1}{2}\$ INCH ABOVE PAVER SURFACE AND MATCH SURROUNDING GRADE. PROPOSED FINISHED GRADE SLOPE PER PROJECT GRADING PLAN. PROVIDE 1" (MIN.) CLEARANCE BETWEEN ANY CONCRETE EDGE AND PAVER.


AASHTO #57 BASE ROCK:

GRAVEL FILL:


- 5. GRADATION OF AASHTO #57 COARSE BASE ROCK: 100% PASSING 1₺" SCREEN, 95-100% PASSING 1", 25-60% PASSING $\frac{1}{2}$ ", AND 0-10% PASSING #8 SCREEN.
- THICKNESS OF AGGREGATE LAYER IS AS FOLLOWS: NO BASE REQUIRED FOR EROSION CONTROL AND PEDESTRIAN-ONLY LOADS (COMPACTION OF NATIVE SOIL RECOMMENDED FOR SLOPES UP TO 3%); 4 INCHES FOR LIGHT LOADS (GOLF CARTS); 6 INCHES FOR MEDIUM LOADS (CARS AND PICKUP TRUCKS); 8 INCHES FOR HEAVY LOADS (FIRE TRUCKS).
- COMPACT WITH ONE TO THREE PASSES OF 5-TON STEEL WHEEL ROLLER SINCE IT IS DIFFICULT TO MEASURE DENSITY OF COARSE AGGREGATE, APPROACH OF REQUIRING A FIXED DENSITY IS NOT APPLICABLE.

SUBGRADE NATIVE SOIL:

- 8. COMPACT SUBGRADE NATIVE SOILS TO 95% STANDARD PROCTOR DENSITY PER ASTM D696 FOR SOILS WITH CALIFORNIA BEARING RATIO >20%, R VALUE >30, AASHTO A-1, A-2, AND A-3 SOILS.
- 9. NDS RECOMMENDS THAT ENGINEER-OF-RECORD CONSIDER HIGHER LEVEL OF COMPACTION FOR CBR 5 TO 20%, R-VALUE 10 TO 30, AASHTO A-4 SOILS FOR HEAVY LOADS WHERE INFILTRATION INTO NATIVE SOILS IS NOT A REQUIREMENT.
- 10. NDS RECOMMENDS THAT ENGINEER-OF-RECORD CONSULT WITH PROJECT GEOTECHNICAL ENGINEER FOR POTENTIAL SOIL MODIFICATION (E.G., LIME TREATMENT) AND COMPACTION LEVEL FOR CBR <5% AND R-VALUE <10, AASHTO A-5, A-6, AND A-7 SOILS.

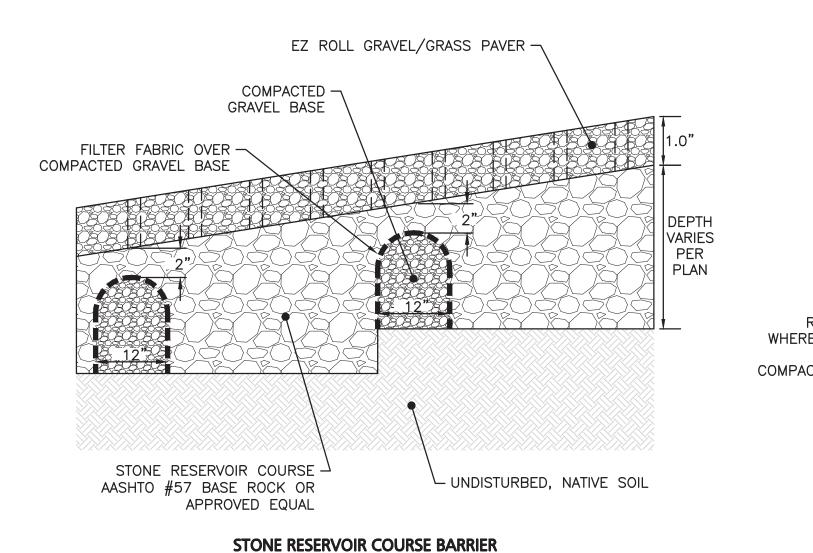


(THREE TOTAL)

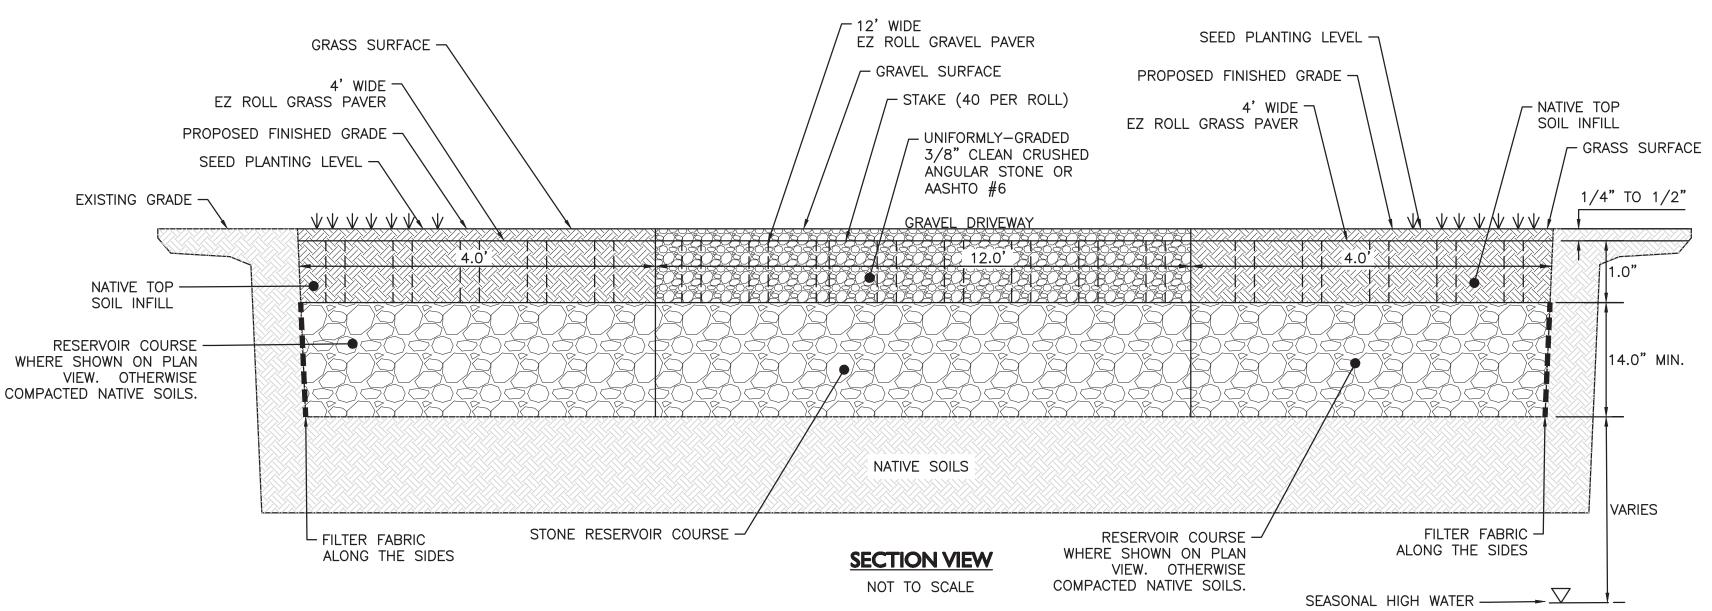

EZ ROLL GRASS & GRAVEL PAVER DETAIL NOT TO SCALE

TABLE (VARIES)

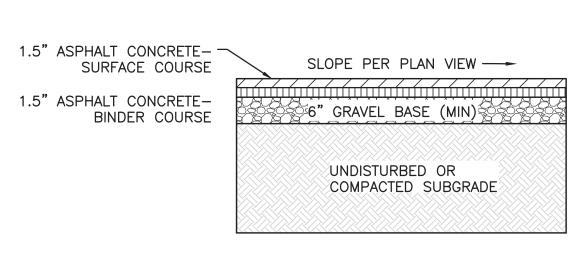


NOTES:

1. REFERENCE PLANS FOR ELEVATIONS.

FIXED OBJECT.

- 2. COMPACT SOIL SUBGRADE UNIFORMLY TO AT LEAST 95% OF ASTM D 1557 LABORATORY DENSITY.
- 3. BASE COURSE SHALL EXTEND 6 INCHES BEYOND PAVEMENT EDGE WHERE PAVEMENT DOES NOT ABUT DEEP CURB, WALL, STEPS, OR
- 4. PAVEMENT EDGES SHALL BE TAMPED WHERE WALKWAY DOES NOT ABUT DEEP CURB, WALL, STEPS, OR FIXED OBJECT.

BITUMINOUS PAVEMENT

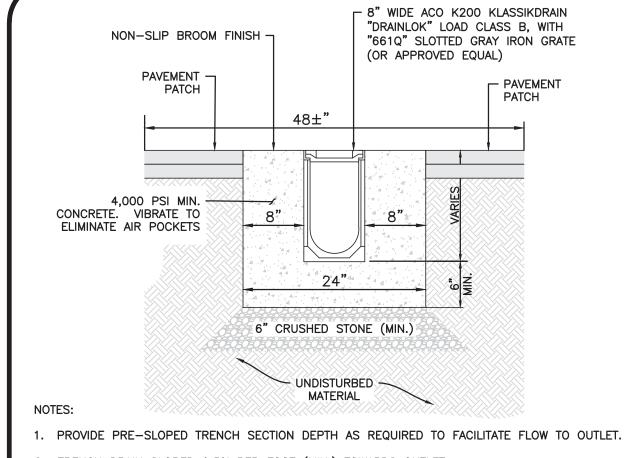


2. TRENCH DRAIN SLOPED 0.5% PER FOOT (MIN.) TOWARDS OUTLET.


3. FINAL SECTION OF THE TRENCH DRAIN SHALL USE THE ACO K2 TYPE 900 "CATCH BASIN" TO PROVIDE ADDITIONAL DEPTH/COVER FOR OUTLET PIPE.


SPECIFICATIONS AND RECOMMENDATIONS. . CONTRACTOR SHALL SUBMIT SHOP DRAWING FOR REVIEW PRIOR TO PURCHASE OF MATERIALS.

4. TRENCH DRAIN SHALL BE INSTALLED IN STRICT ACCORDANCE WITH MANUFACTURER'S

TRENCH DRAIN

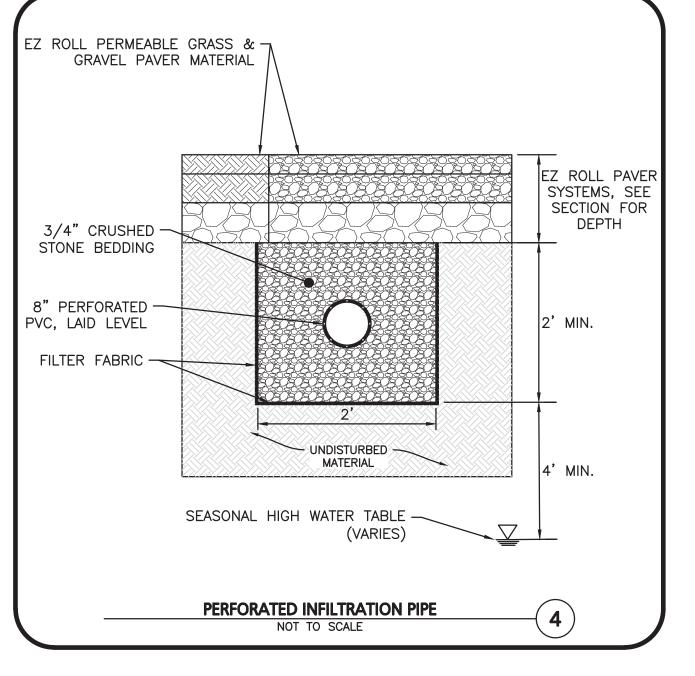

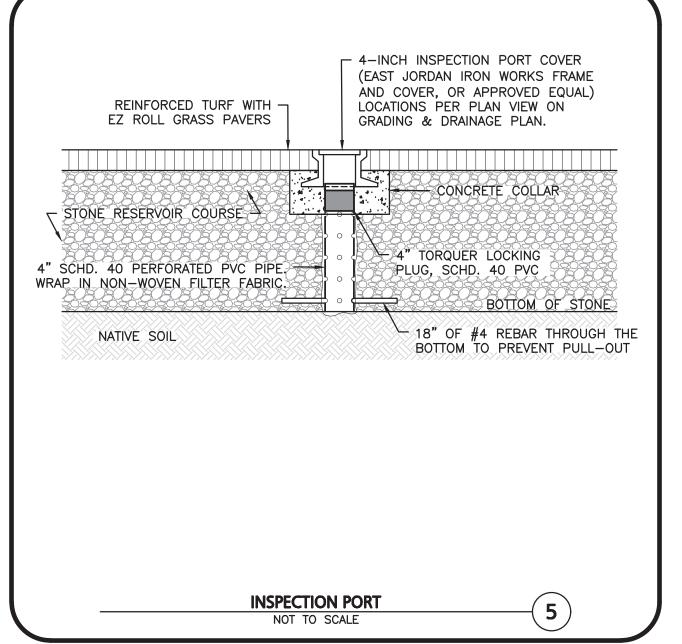

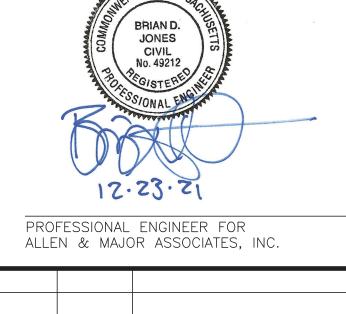

12-23-21 PER TOWN REVIEW COMMENTS

REV DATE DESCRIPTION APPLICANT\OWNER:

> WEST SUBURBAN YMCA **276 CHURCH STREET** NEWTON, MA 02458

PROJECT:

PROJECT NO.

CAMP CHICKAMI 139 BOSTON POST ROAD WAYLAND, MA

SCALE: AS SHOWN DWG. NAME: C2562-01 **DESIGNED BY:** JG | CHECKED BY:

2562-01 DATE:

11-10-21

SHEET No.

C-502



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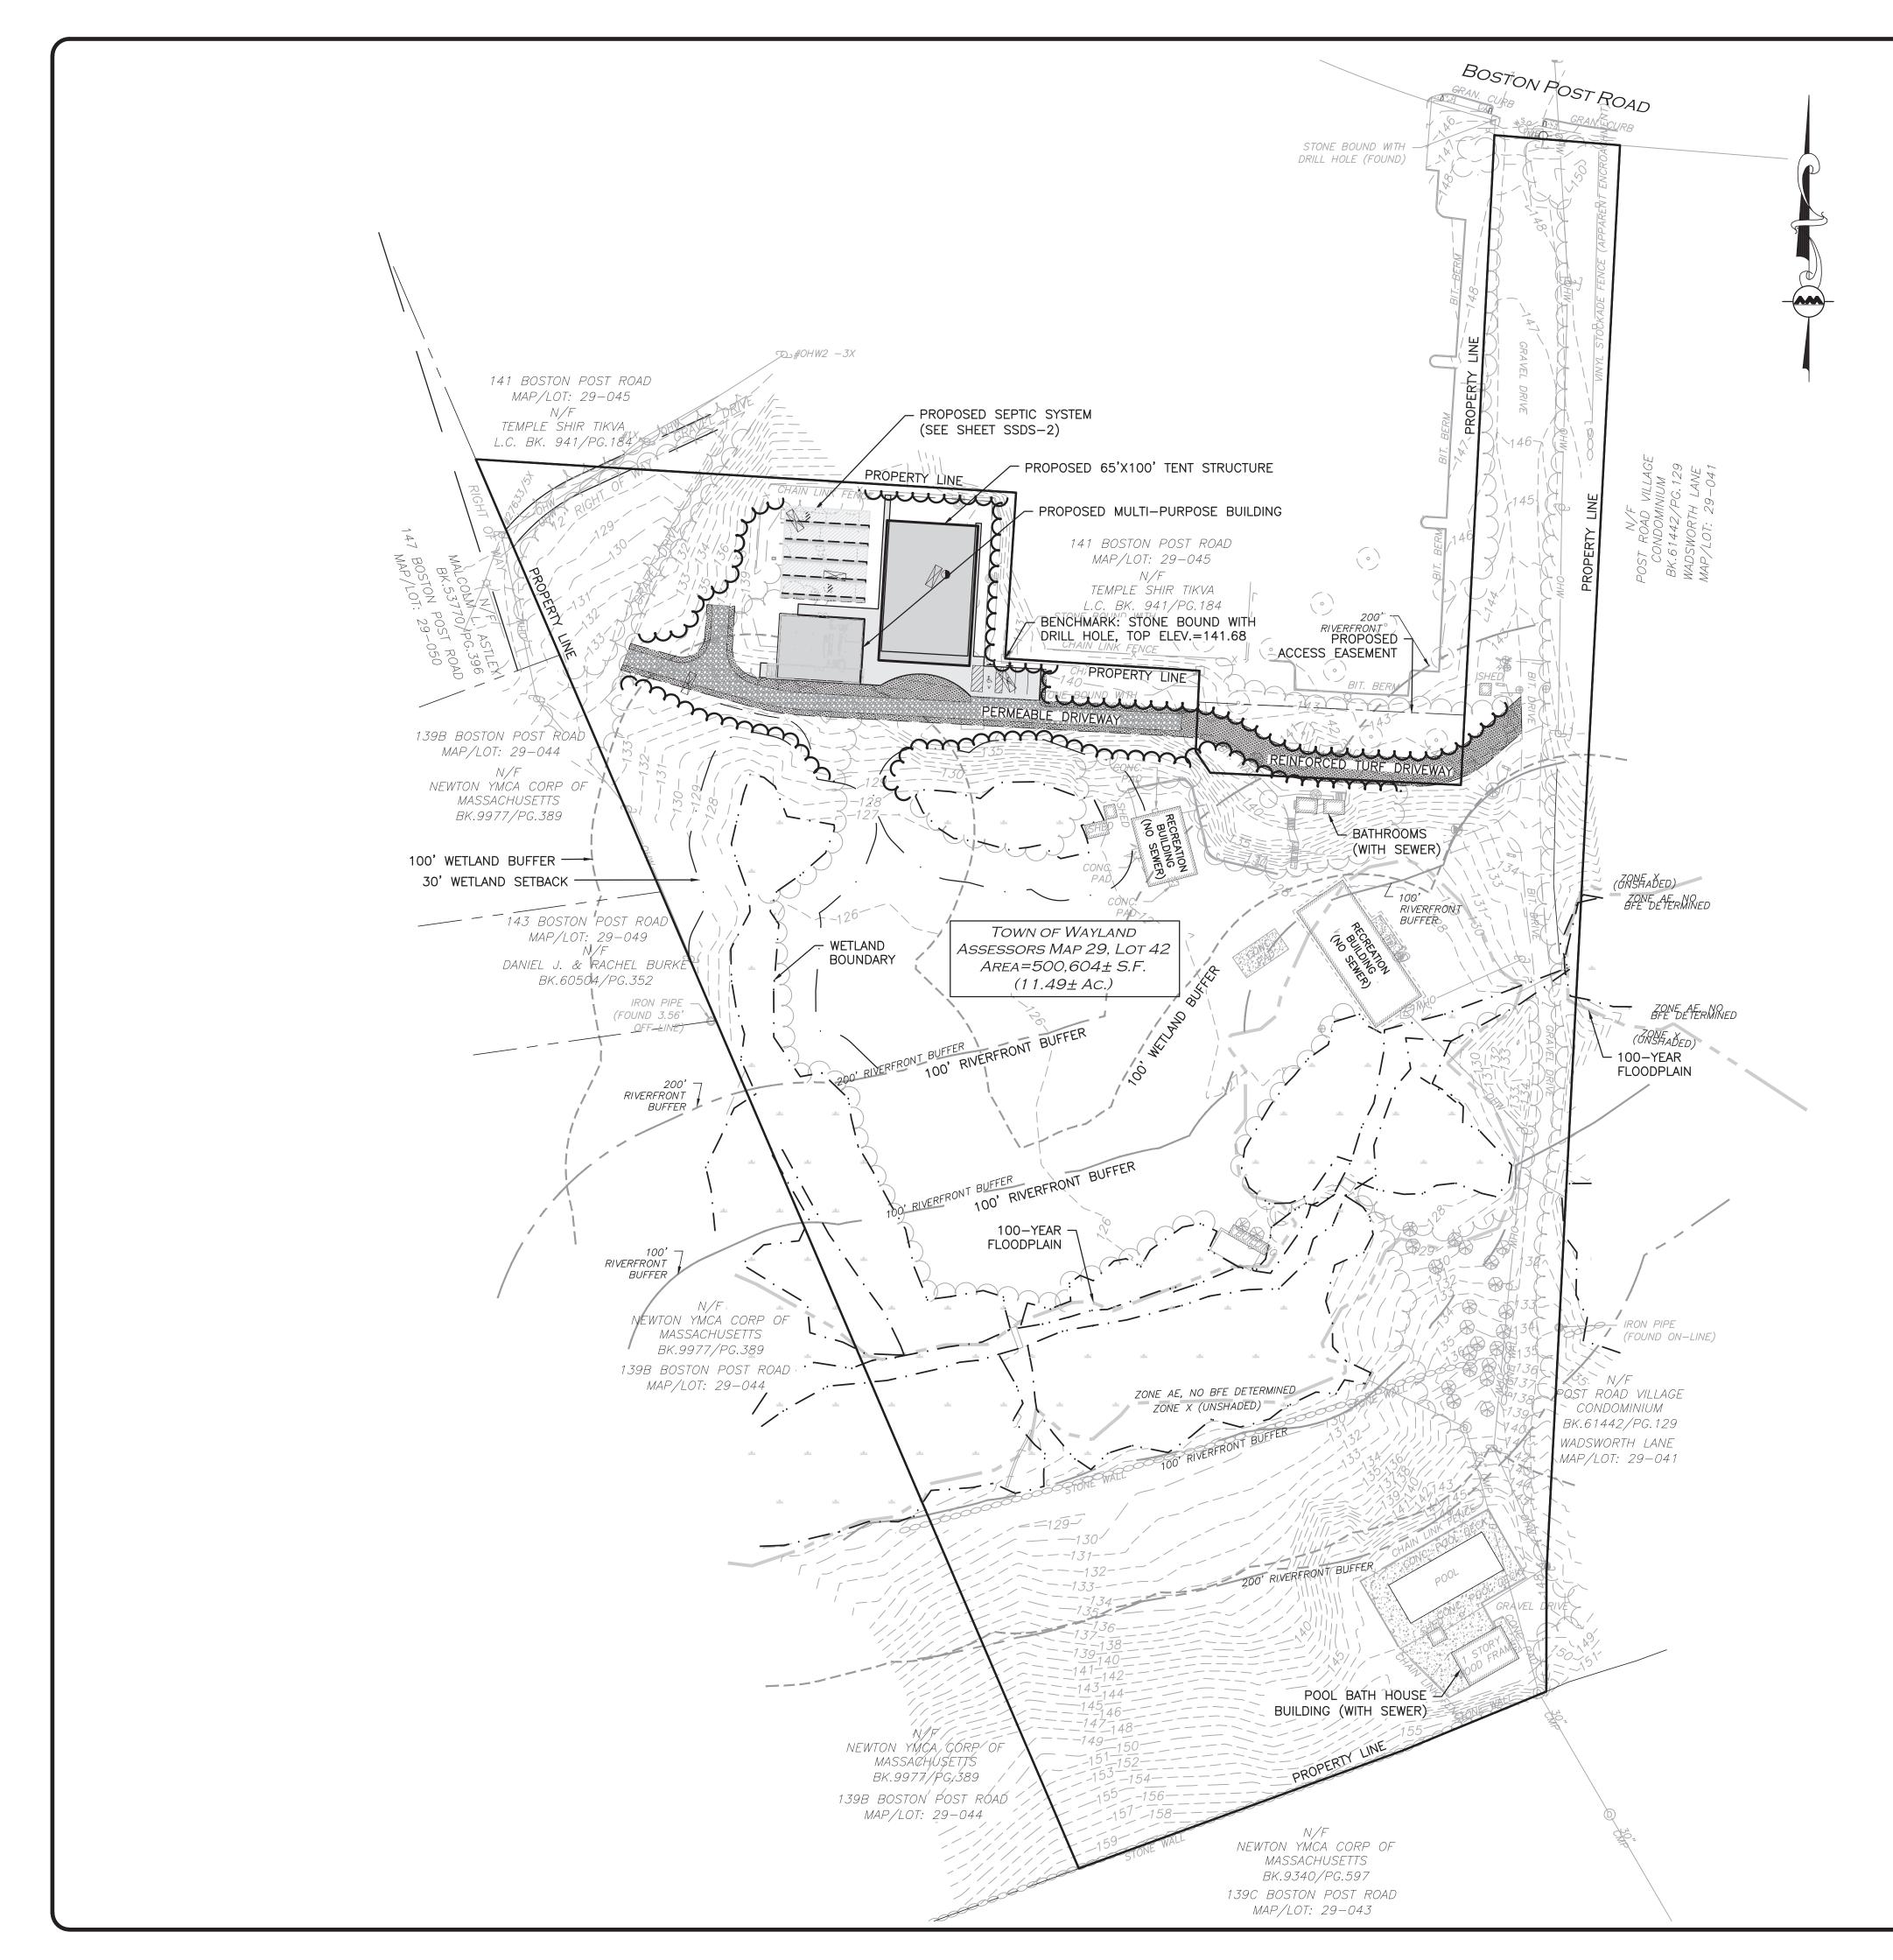
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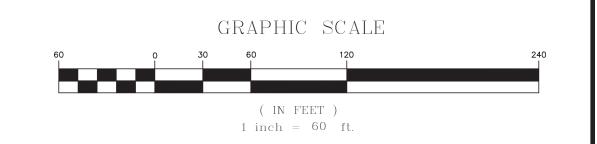
ALLEN & MAJOR ASSOCIATES, INC.'S WORK PRODUCT. **DRAWING TITLE:**

DETAILS



GENERAL NOTES

- 1. ALL CONSTRUCTION SHALL CONFORM TO THE CURRENT TITLE 5 OF THE STATE ENVIRONMENTAL CODE AND THE BOARD OF HEALTH REQUIREMENTS FOR THE TOWN OF WAYLAND.
- 2. FILL MATERIAL FOR THE LEACHING AREA SHALL CONFORM WITH SECTION 15.255 OF THE STATE ENVIRONMENTAL CODE. FILL SHALL CONSIST OF SELECT ON-SITE OR IMPORTED SOIL MATERIAL. THE FILL SHALL BE CLEAN, GRANULAR SAND, FREE FROM ORGANIC MATTER AND DELETERIOUS SUBSTANCES. THE PARTICLE SIZE DISTRIBUTION SHALL CONFORM WITH SECTION 15.255 (3) OF THE STATE ENVIRONMENTAL CODE, TITLE 5.
- 3. REMOVE ALL TOPSOIL, SUBSOIL, AND OTHER IMPERVIOUS LAYERS WITHIN FIVE (5) FEET HORIZONTALLY OF THE PROPOSED LEACHING FACILITY AND REPLACE WITH MATERIAL SPECIFIED IN SECTION 15.255 (3) OF THE STATE ENVIRONMENTAL CODE, TITLE 5.
- 4. THE BOARD OF HEALTH SHALL REQUIRE INSPECTION OF ALL CONSTRUCTION BY THE DESIGN ENGINEER AND/OR BY AN AGENT OF THE BOARD OF HEALTH AND THE DESIGN ENGINEER.
- 5. SHOP DRAWINGS SHALL BE SUBMITTED TO THE APPROVING AUTHORITY.
- 6. THE INSTALLER IS RESPONSIBLE FOR MAKING ARRANGEMENTS FOR INSPECTION OF THE THE INSTALLATION OF THE SYSTEM WITH THE TOWN OF WAYLAND BOARD OF HEALTH AND THE DESIGN ENGINEER.
- 7. ALL PIPING SHALL CONSIST OF PVC PIPE, SCHEDULE 40, GENERAL PURPOSE SEWER PIPE UNLESS OTHERWISE NOTED. ALL FITTINGS SHALL BE SCHEDULE 40. ALL JOINTING SHALL BE CEMENT. INSTALLATION SHALL BE IN ACCORDANCE WITH MANUFACTURER'S RECOMMENDATIONS.
- 8. ANY ALTERATIONS MUST BE APPROVED IN WRITING PRIOR TO CONSTRUCTION. FOR PROPER PERFORMANCE, THE SEPTIC TANK SHOULD BE INSPECTED AT LEAST ONCE A YEAR. WHEN THE TOTAL DEPTH OF SCUM AND/OR SOLIDS EXCEEDS 1/3 OF THE LIQUID DEPTH OF THE TANK, THE TANK MUST BE PUMPED.
- 9. ALL EXISTING STRUCTURES IN THE SYSTEM SHALL BE LOCATED BY CONTRACTOR AND THE HORIZONTAL AND VERTICAL LOCATION VERIFIED PRIOR TO CONSTRUCTION. IF THERE ARE CONFLICTS BETWEEN EXISTING AND PROPOSED UTILITIES, THE ENGINEER SHALL BE NOTIFIED IMMEDIATELY BEFORE CONSTRUCTION MAY BEGIN.
- 10. THE INSTALLER IS TO BE RESPONSIBLE FOR ALL HORIZONTAL AND VERTICAL CONTROL OF ALL COMPONENTS.
- 11. ALL DISTURBED AREAS SHALL BE RESTORED IN ACCORDANCE WITH THE REQUIREMENTS OF THE SITE PLANS.
- 12. THE CONTRACTOR SHALL CONTACT DIGSAFE IN ORDER TO COMPLY WITH THE REQUIREMENTS OF MASSACHUSETTS GENERAL LAWS CHAPTER 82 AND SECTION 40, AS AMENDED.
- 13. SYSTEM INSTALLER IS TO BE LICENSED BY THE LOCAL BOARD OF HEALTH. INSTALLER MUST PROVIDE WRITTEN CERTIFICATION OF SYSTEM CONSTRUCTION.
- 14. SYSTEM AREA SHALL BE STAKED AND FLAGGED FROM DATE OF INSTALLATION UNTIL CERTIFICATE OF COMPLIANCE IS ISSUED.
- 15. GENERAL CONTRACTOR SHALL COORDINATE THEIR ACTIVITIES WITH THOSE OF ANY OTHER CONTRACTORS ON-SITE SO AS TO INSURE THAT WORK PROCEEDS AS SMOOTHLY AS POSSIBLE AND THAT DELAYS ARE KEPT TO A
- 16. CONTRACTOR SHALL TAKE ALL STEPS NECESSARY TO INSURE THAT UNAUTHORIZED INDIVIDUALS ARE NOT ALLOWED TO ENTER THE WORK AREAS. LIMIT OF WORK SHALL HAVE ADEQUATE MARKINGS TO INSURE THAT ONLY AUTHORIZED PERSONNEL ENTER THE WORK AREA.
- 17. CONTRACTOR IS RESPONSIBLE FOR ANY DEWATERING OF EXCAVATIONS AS MAY BE REQUIRED. CONTRACTOR SHALL TAKE ALL NECESSARY PRECAUTIONS TO ENSURE THAT NO DAMAGE IS DONE DURING DEWATERING OPERATIONS.
- 18. ALL CONCRETE STRUCTURES AND MANHOLE FRAMES AND COVERS, SHALL BE DESIGNED FOR MINIMUM OF H-10 WHEEL LOADING OR OR GREATER AS SPECIFIED ON THE DETAIL SHEETS.
- 19. ALL ELEVATIONS REFER TO NAVD 1988.
- 20. WETLAND RESOURCES AREAS SHOWN HEREON ARE TAKEN FROM THE MA DEP ORDER OF RESOURCE AREA DELINEATION (ORAD) FILE NUMBER 322-0961.
- 21. THE COMPONENTS OF THE SOIL ABSORPTION SYSTEM SHALL BE MARKED WITH MAGNETIC TAPE PURSUANT TO SECTION 15.221 OF THE TITLE 5 STATE ENVIRONMENTAL CODE.
- 22. WETLAND RESOURCE AREAS WERE FLAGGED BY GODDARD CONSULTING, LLC, AND FIELD SURVEY LOCATED BY ALLEN & MAJOR ASSOCIATES, INC. THE WETLAND RESOURCE AREAS SHOWN HEREON REFERENCE AN ORDER OF RESOURCE AREA DELINEATION (ORAD) ISSUED BY THE TOWN OF WAYLAND CONSERVATION COMMISSION ON NOVEMBER 24, 2020 AND RECORDED AT THE MIDDLESEX SOUTH REGISTRY OF DEEDS, BOOK 76637, PAGE 75. THE ORAD IS VALID UNTIL NOVEMBER 24, 2023.





PROFESSIONAL ENGINEER FOR ALLEN & MAJOR ASSOCIATES, INC.

12-08-21 PER BOH 12-07-21 REVIEW

REV DATE DESCRIPTION

APPLICANT\OWNER:

WEST SUBURBAN YMCA **276 CHURCH STREET** NEWTON, MA 02458

PROJECT:

PROJECT NO.

SCALE:

CAMP CHICKAMI 139 BOSTON POST ROAD WAYLAND, MA

2562-01 DATE:

1" = 60' DWG. NAME:

11-10-21

JG | CHECKED BY: **DESIGNED BY:**

ALLEN & MAJOR ASSOCIATES, INC. civil engineering • land surveying

nvironmental consulting + landscape architecture www.allenmajor.com 100 COMMERCE WAY, SUITE 5 WOBURN MA 01801 TEL: (781) 935-6889 FAX: (781) 935-2896

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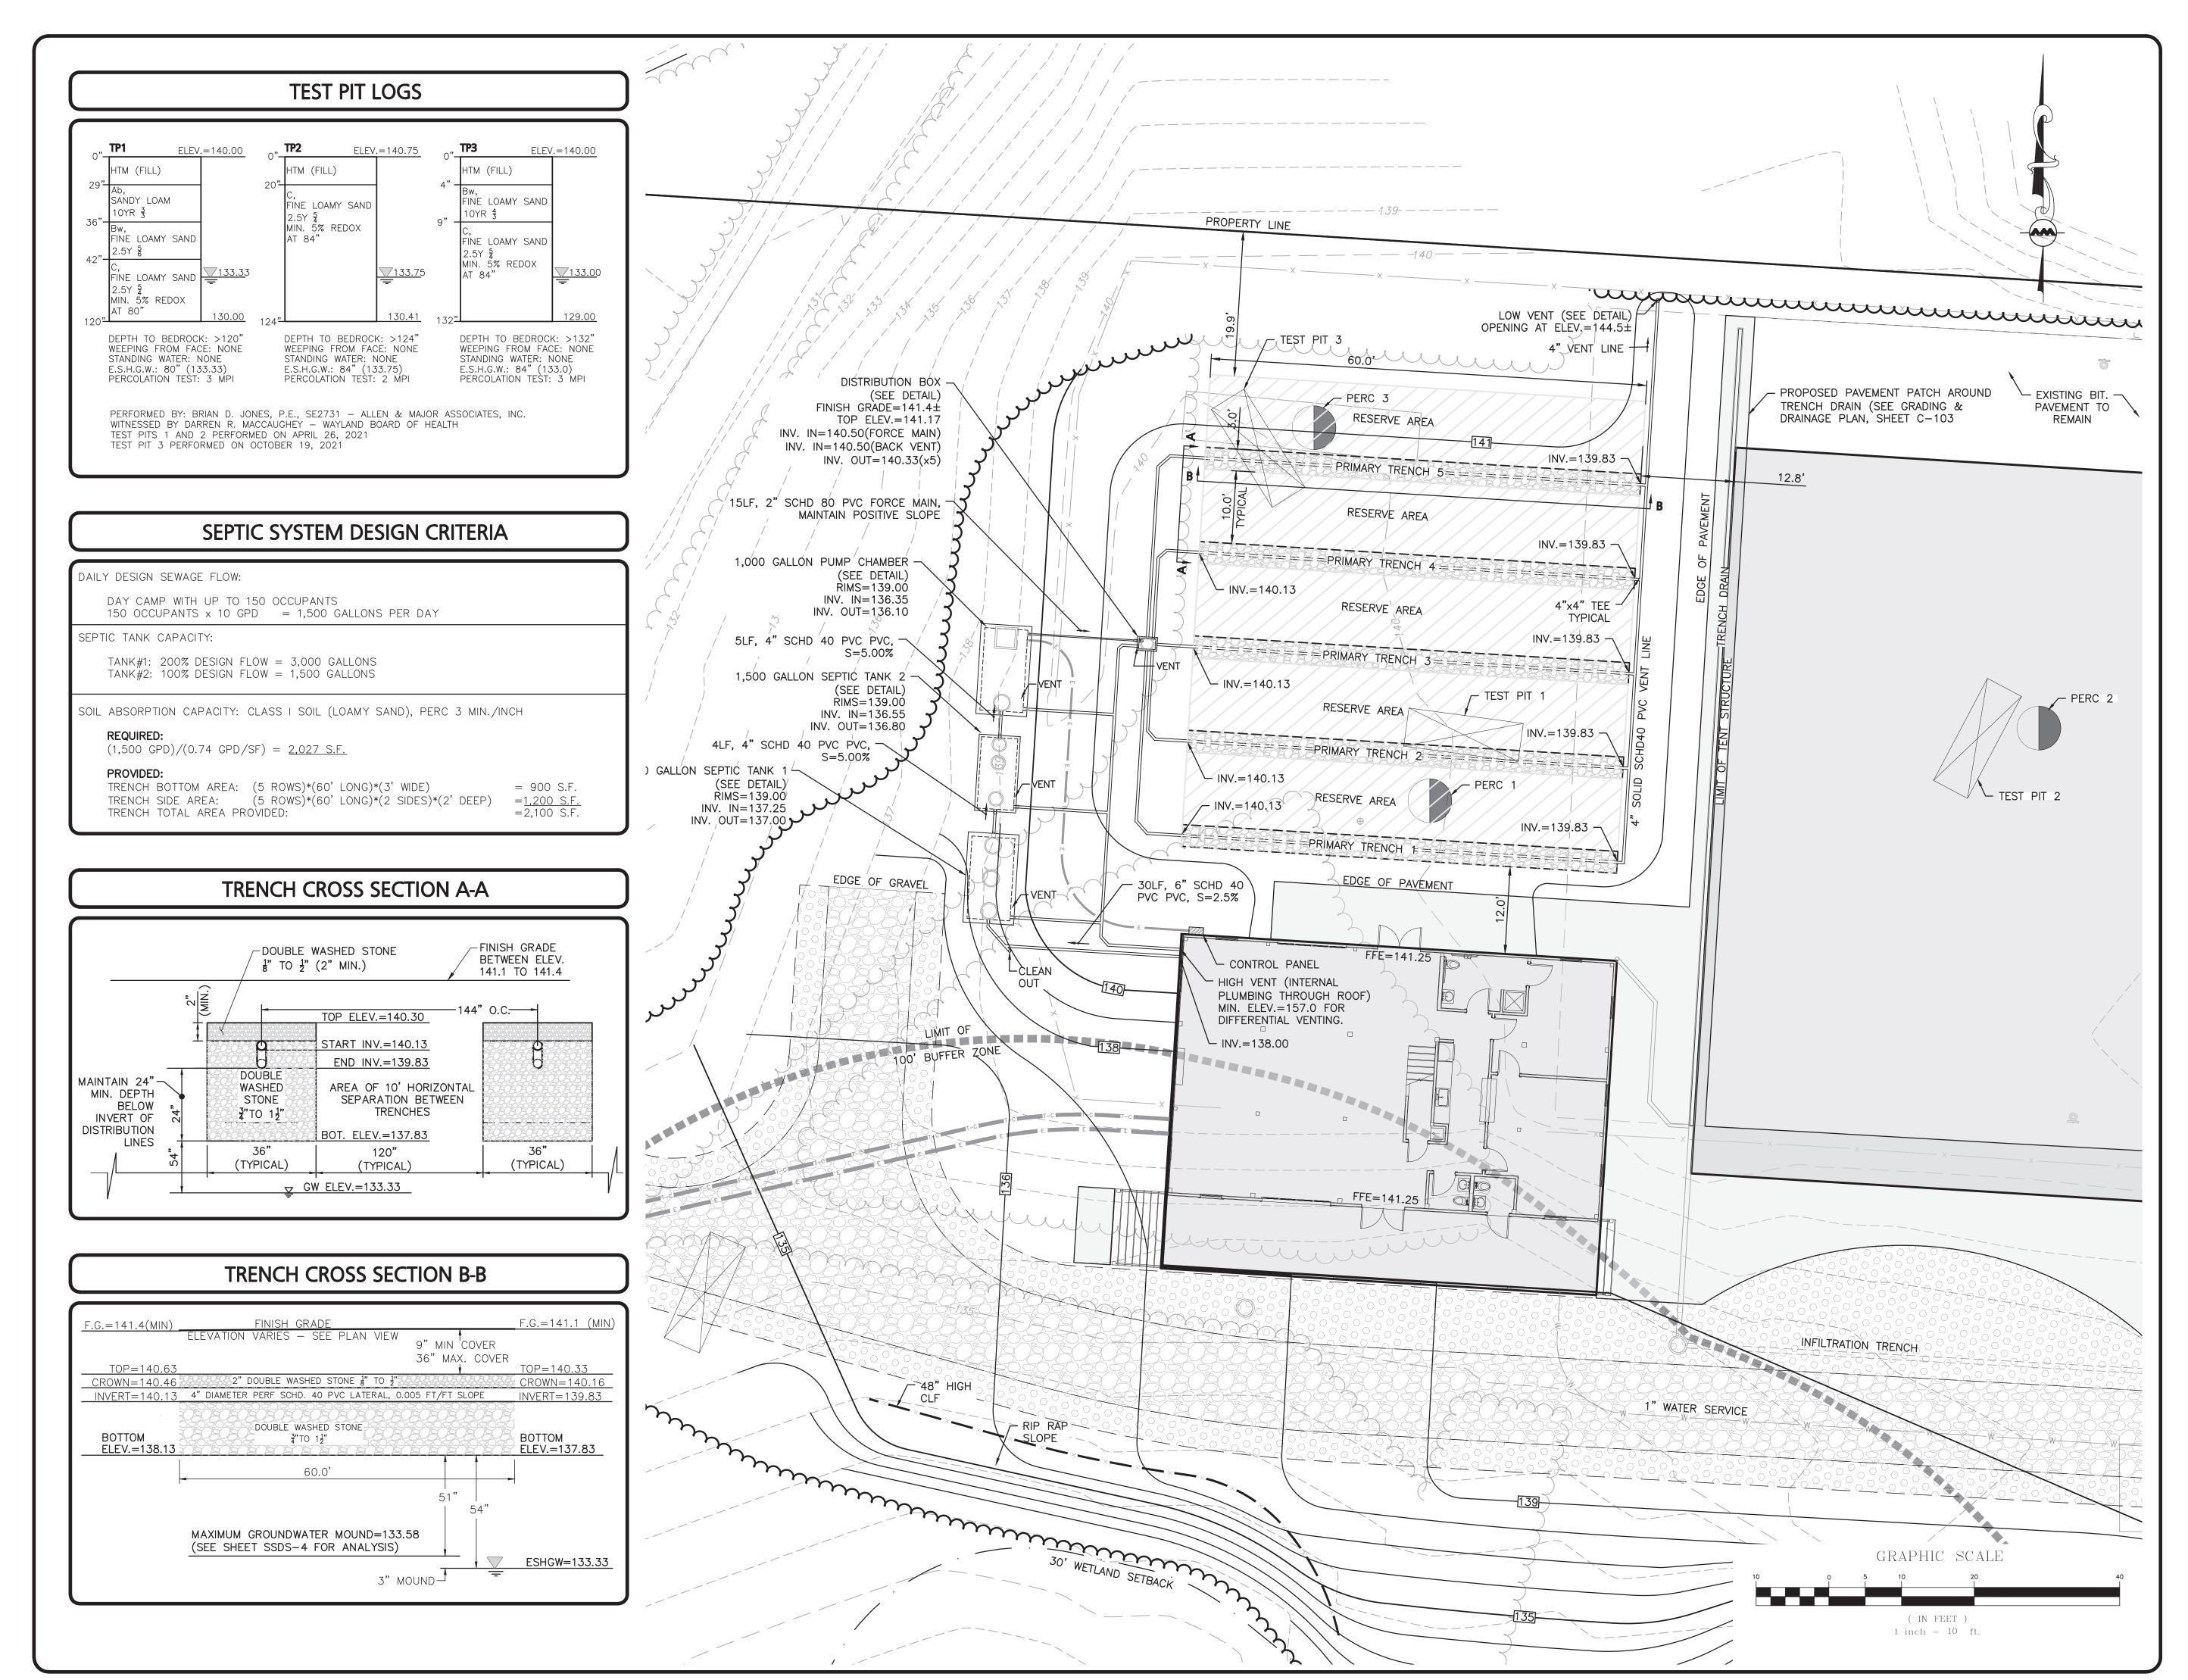
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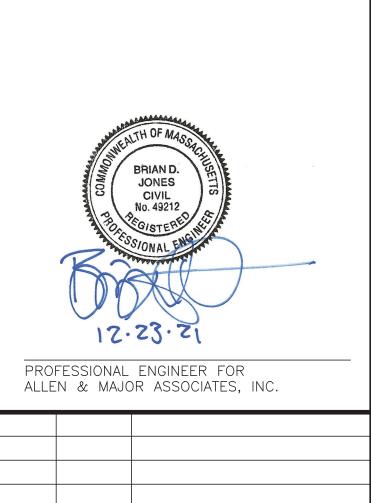
SUBSURFACE SEWAGE DISPOSAL SYSTEM OVERALL SITE PLAN

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SHEET No.







1 12-08-21 PER BOH 12-07-21 REVIEW
REV DATE DESCRIPTION

WEST SUBURBAN YMCA 276 CHURCH STREET NEWTON, MA 02458

PROJECT:

PROJECT NO.

SCALE:

APPLICANT\OWNER:

CAMP CHICKAMI 139 BOSTON POST ROAD WAYLAND, MA

2562-01 DATE:

1" = 10' DWG. NAME:

DESIGNED BY:

PREPARED BY:

ALLEN & MAJOR ASSOCIATES, INC.

nmental consulting ◆ landscape architecture
w w w . a l l e n m a j o r . c o m

100 COMMERCE WAY, SUITE 5

WOBURN MA 01801

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WOBURN, MA ♦ LAKEVILLE, MA ♦ MANCHESTER, N

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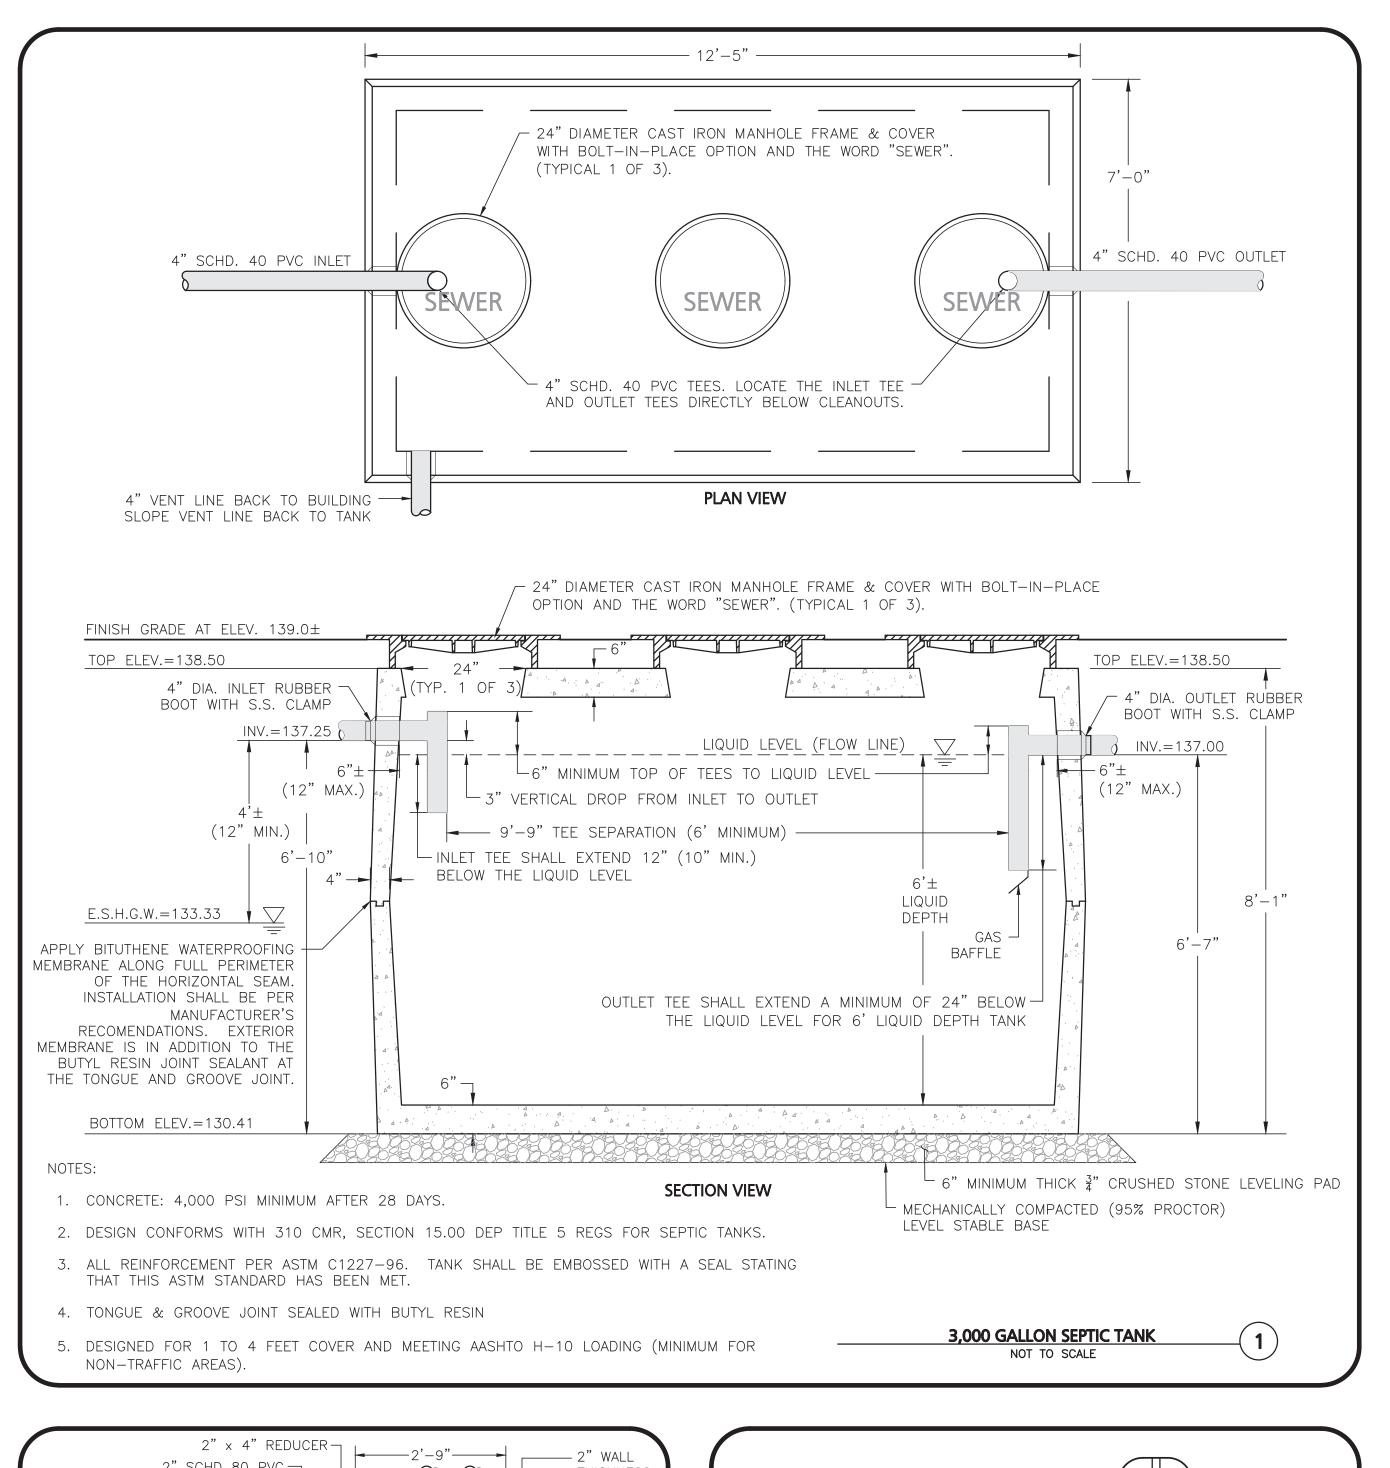
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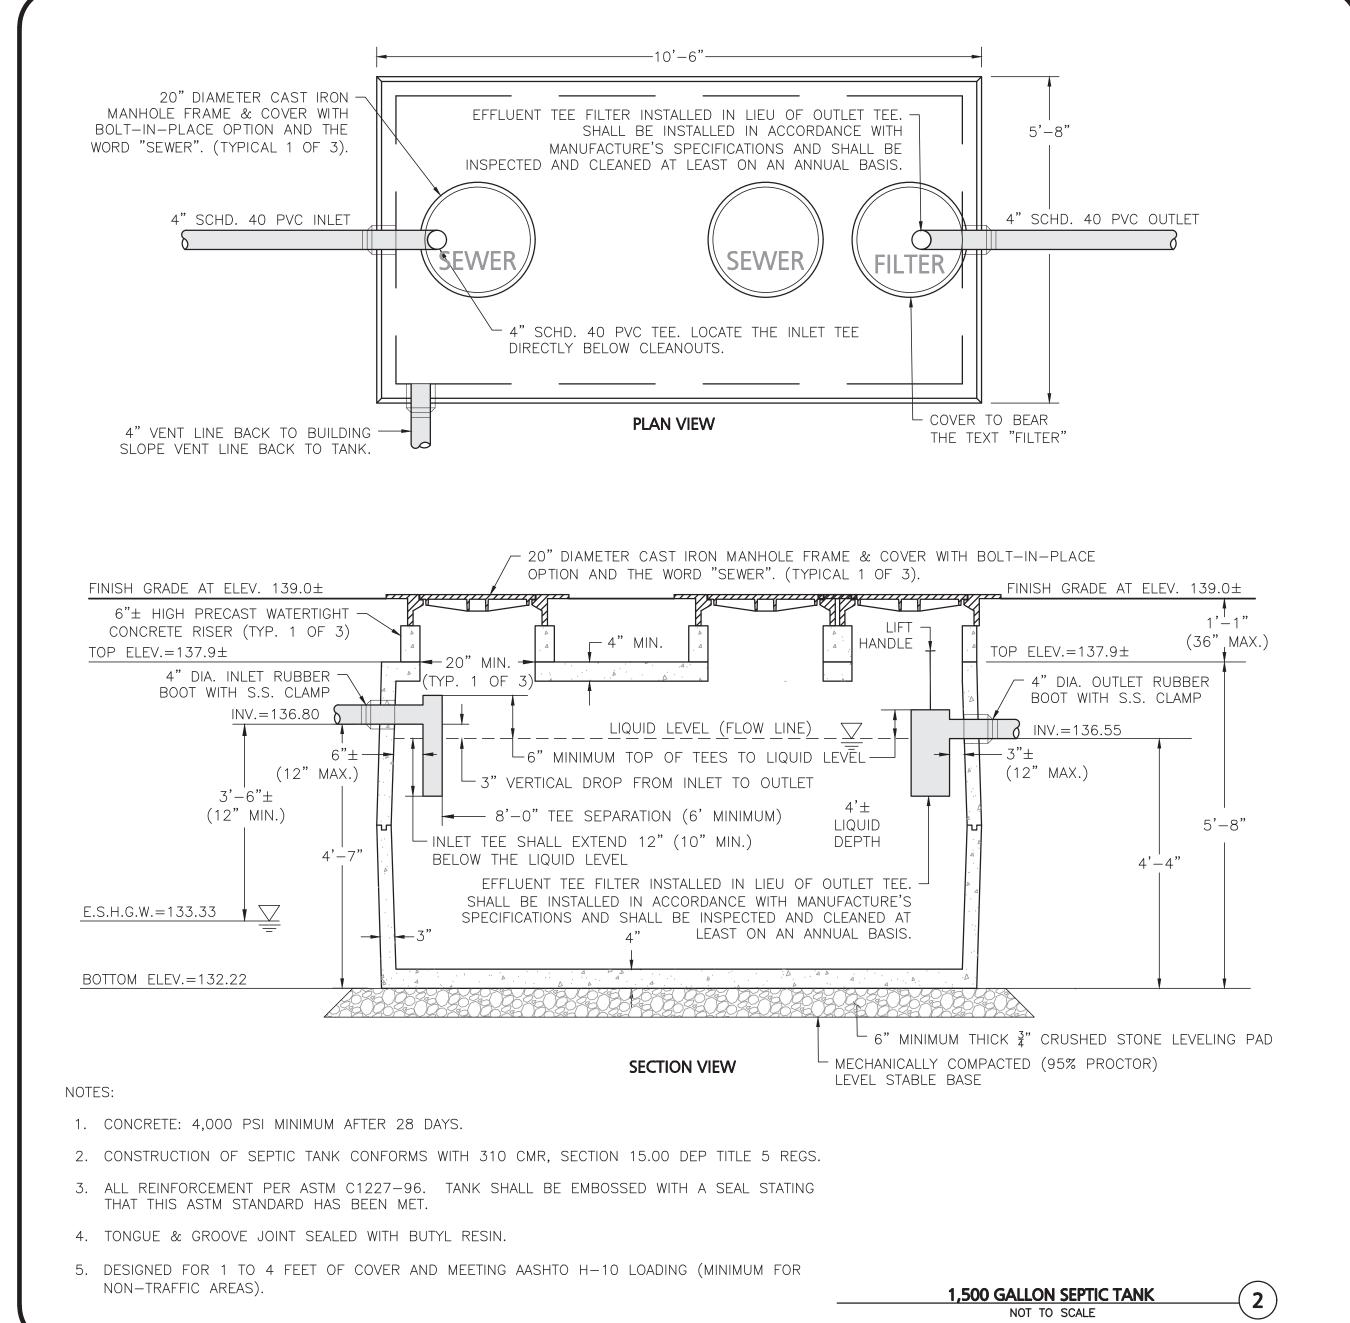
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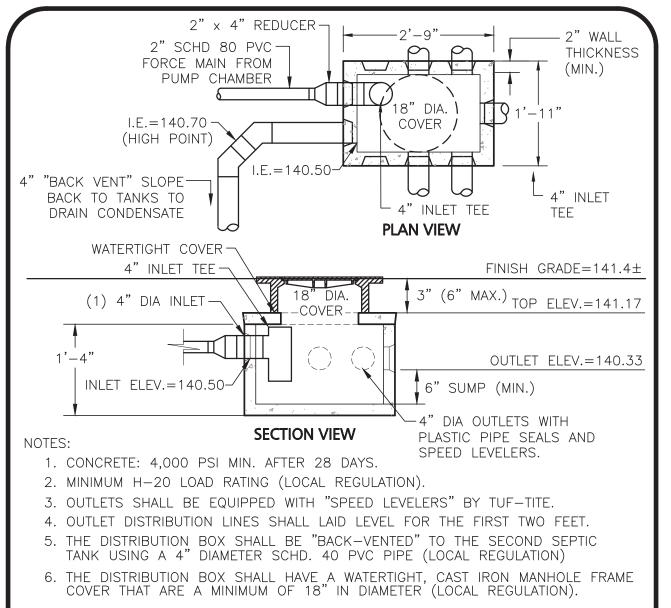
SUBSURFACE SEWAGE
DISPOSAL SYSTEM
LAYOUT

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11-10-21








DISTRIBUTION BOX


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3. EACH DISTRIBUTION LINE SHALL CONNECT TO THE VENT LINE.

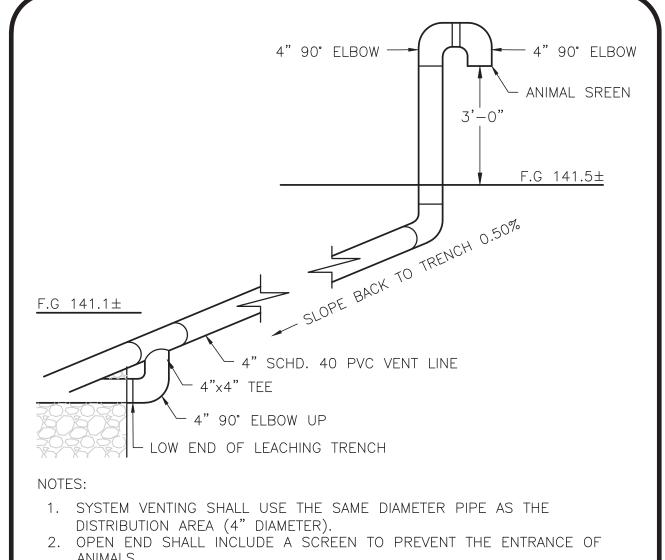
LOW VENT DETAIL


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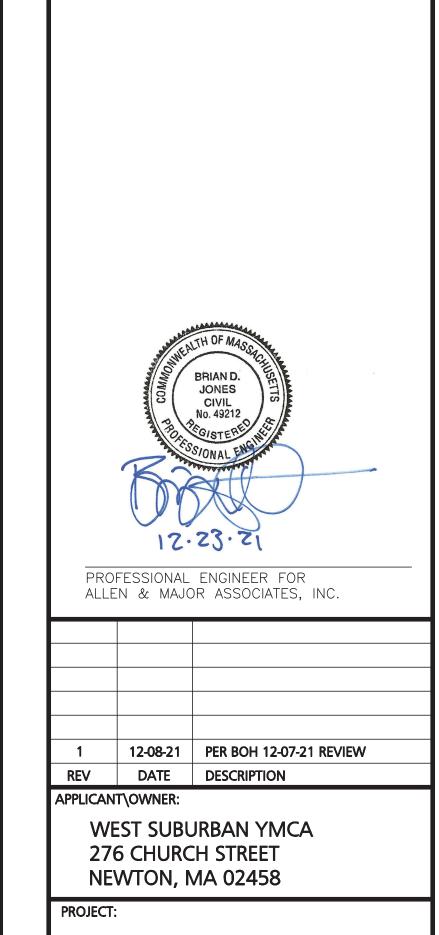


EFFLUENT TEE FILTER

NOT TO SCALE

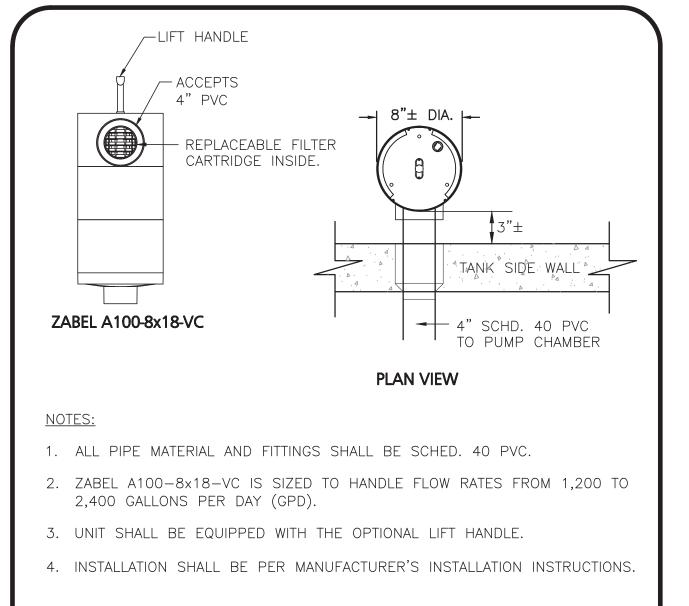

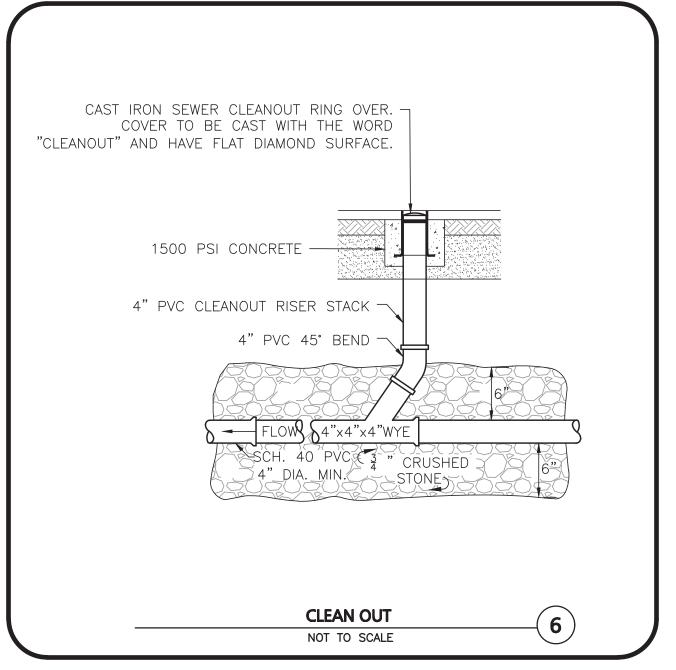

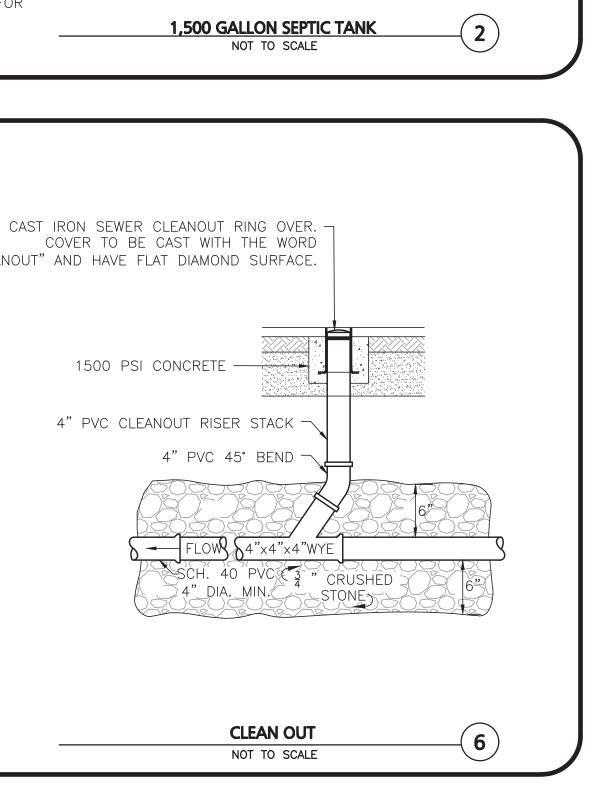

2562-01 DATE: PROJECT NO. 11-10-21 1" = ##' DWG. NAME: C2562-0 **DESIGNED BY:** JG | CHECKED BY:

CAMP CHICKAMI

139 BOSTON POST ROAD

WAYLAND, MA



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DRAWING TITLE:

SSDS-3 **DETAILS**

SHEET No.

SUBSURFACE SEWAGE DISPOSAL SYSTEM Copyright©2021 Allen & Major Associates, Inc. All Rights Reserved

NOTES:


- 1. ALL CONSTRUCTION SHALL CONFORM TO THE CURRENT TITLE 5 (310 CMR) OF THE STATE ENVIRONMENTAL CODE AND THE BOARD OF HEALTH REQUIREMENTS FOR THE TOWN OF WAYLAND.
- 2. THE TANK SHALL BE CONSTRUCTED OF PRECAST OR CAST IN PLACE REINFORCED CONCRETE; WATERTIGHT AND ABLE TO WITHSTAND H20 LOADING. THE CHAMBER MAY BE SEGMENTAL PROVIDED THE JOINTS ARE
- 3. THE TANK SHALL BE MEET THE MINIMUM REQUIREMENTS OF 310 CMR 15.226 "CONSTRUCTION OF SEPTIC TANKS", WHICH INCLUDES THE FOLLOWING MINIMUM STANDARDS:
 - (a.) CONCRETE SHALL HAVE A MINIMUM COMPRESSIVE STRENGTH OF 4,000 PSI @ 28 DAYS AND A MINIMUM DENSITY OF 140 PCF.
 - (b.) CEMENT SHALL BE PORTLAND TYPE 1 OR 3 PER ASTM C150-96.
 - (c.) ADMIXTURES SHALL CONFORM TO ASTM C233-95.
 - (d.) REINFORCING SHALL CONFORM TO ASTM A615 FOR WIRE FABRIC. GRADE 👭 R'd OR EQUIVALENT. (e.) THE MINIMUM WALL THICKNESS SHALL BE FOUR INCHES.
- 4. THE TANK SHALL BE SET LEVEL ON A STABLE BASE WHICH HAS BEEN MECHANICALLY COMPACTED TO 95%
- 5. THE TANK AND COVERS SHALL BE CONSTRUCTED TO WITHSTAND MINIMUM H-10 LOADING (NON-TRAFFIC
- 6. THE TANK PIPE PENETRATIONS SHALL BE MADE WITH A KOR—N—SEAL BOOT OR EQUAL FLEXIBLE WATERTIGHT CONNECTION.
- 7. THE TANK SHALL BE EMBOSSED WITH A SEAL STATING THAT ASTM C1227-96 HAS BEEN MET.
- 8. THE TANK SHALL HAVE A MINIMUM EMERGENCY STORAGE CAPACITY ABOVE THE WORKING LEVEL EQUAL TO THE DAILY DESIGN FLOW (1,500 GPD) OF THE SYSTEM.
- 9. THE TANK SHALL BE EQUIPPED WITH TWO PUMPS THE DISCHARGE LINES OF WHICH SHALL BE VALVED TO ALLOW DOSING OF THE ENTIRE LEACHING AREA BY EITHER PUMP.
- 10. PUMPS SHALL BE MEET THE FOLLOWING PERFORMANCE REQUIREMENTS:
 - (a.) 37.5 GALLONS PER MINUTE (GPM) AT 12 FEET TOTAL DYNAMIC HEAD (TDH)
 - (b.) DESIGN PUMP (OR APPROVED EQUAL): MODEL SE-411, 0.4 BHP WITH A 4.25" IMPELLER DIAMETER AS MANUFACTURED BY BARNES. (SINGLE PHASE, 115 VOLT)
 - (c.) CAPABLE OF PASSING A MINIMUM SOLID SIZE $1\frac{1}{4}$ " DIAMETER.
 - (d.) 2" DISCHARGE.


DENSITY (PROCTOR).

- (e.) PUMPS SHALL BE SUBMERSIBLE NON-CLOG PUMPS MOUNTED ON GUIDE RAILS AND BE EQUIPPED WITH QUICK DISCONNECT SYSTEM AT THE DISCHARGE.
- 11. PUMPS SHALL OPERATE IN THE FOLLOWING SEQUENCE:
 - (a) PUMPS OFF
 - (b) PRIMARY (LEAD) PUMP ON
 - (c) BACKUP (LAG) PUMP ON AND ALARM ON (d) PUMPS MUST ALTERNATE DURING NORMAL USE.
- 12. PUMPS SHALL BE EQUIPPED WITH AN AUDIBLE AND VISUAL HIGH WATER ALARM LOCATED IN THE BUILDING
- SERVED WHICH IS POWERED BY A SEPARATE CIRCUIT FROM THE CIRCUIT TO THE PUMPS.
- 13. PUMP CONTROLS SHALL BE MOUNTED ON THE BUILDING AS SHOWN ON THE SITE PLAN AND SHALL MEET THE FOLLOWING PERFORMANCE STANDARDS (MINIMUM):
- (a). WEATHERPROOF OUTDOOR NEMA 3R ENCLOSURE OF GALVANIZED STEEL WITH ENAMEL FINISH. (b). DESIGNED FOR USE WITH STANDARD FLOAT SWITCHES (FOUR SWITCHES FOR DUPLEX OPERATION).
- (c). ALTERNATOR RELAY TO EQUALIZE PUMP WEAR.
- (d). OVERRIDE RELAY FOR LAG PUMP IF FIRST PUMP FAILS.
- (e). LAG PUMP DELAY CIRCUITRY
- f). AUXILIARY ALARM CONTACTS
- (g). CONDENSATION HEATER
- (h). LIGHTNING ARRESTOR
- (i). FULL INNER DOOR (j). A HAND-OFF-AUTO SELECTOR SWITCH FOR EACH PUMP.
- 14. CONTRACTOR SHALL SUBMIT SHOP DRAWINGS TO ENGINEER FOR APPROVAL PRIOR TO PURCHASE AND

INSTALLATION OF DOSING CHAMBER, PUMPS AND CONTROLS.

3,000 GALLON PUMP CHAMBER SCALE: AS SHOWN

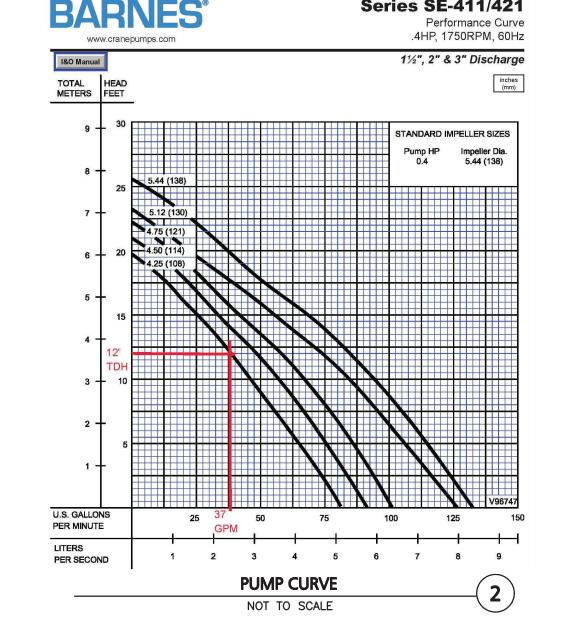

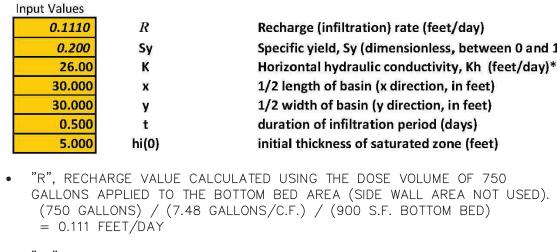

• "Sy", SPECIFIC YIELD OF 20% TAKEN FROM PUBLISHED DATA FOR LOAMY

— 12'-5" ——

- "K", HYDRAULIC CONDUCTIVITY TAKEN FROM NRCS PUBLISHED DATA FOR MAPPED SOILS: 92 MICROMETERS / SECOND, WHICH CONVERTS TO 26 FEET
- "x" AND "y" DIMENSIONS TAKEN FROM OUTSIDE DIMENSIONS OF THE LEACHING TRENCHES
- "t", DURATION IS ½ DAY FOR THE 750 GALLONS DOSE.

MOUNDING ANALYSIS RESULTS

Δh(max)

• "hi", INITIAL SATURATED THICKNESS IS CONSERVATIVELY ASSUMED TO BE 5', SINCE NO BEDROCK WAS ENCOUNTERED TO A DEPTH OF ELEVATION 127.0 (TEST PIT 5)

0.100 DISTANCE FROM CENTER OF SEPTIC FIELD 0.050 60 80 100 120 NOTES: 1. THE SPREADSHEET USED IN SOLVING THE HANTUSH (1967) EQUATION FOR GROUND-WATER MOUNDING BENEATH A SEPTIC SYSTEM IS BASED ON THE USGS SCIENTIFIC INVESTIGATIONS REPORT 2010-5102 "GROUNDWATER MOUNDING BENEATH HYPOTHETICAL STORMWATER INFILTRATION BASINS". 2. THE MAXIMUM GROUNDWATER MOUND WAS DETERMINED TO BE 0.225 FEET OR APPROXIMATELY 3" AT THE CENTER OF THE LEACHING AREA. maximum thickness of saturated zone (beneath center of basin at end of infiltration period) **MOUNDING ANALYSIS** maximum groundwater mounding (beneath center of basin at end of infiltration period)

NOT TO SCALE


Groundwater Mounding, in feet

(36" MAX.)

0.250

0.200

0.150

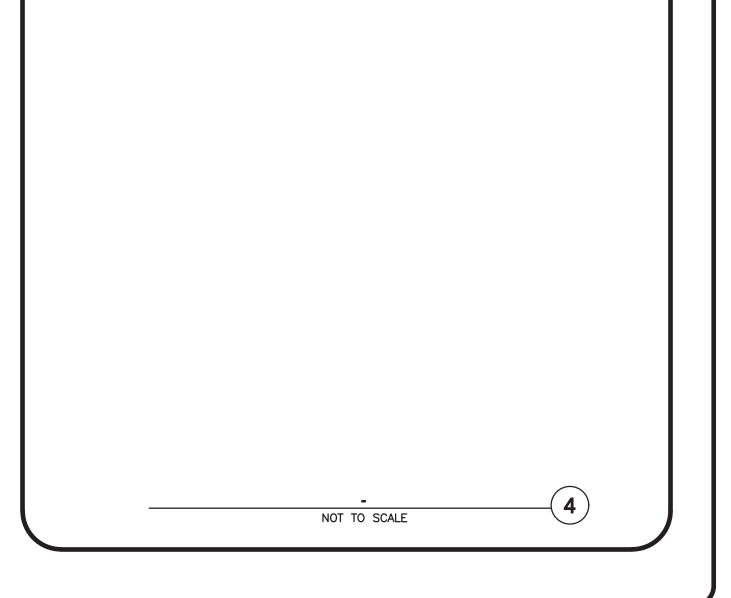



ALLEN & MAJOR ASSOCIATES, INC.

12-08-21 PER BOH 12-07-21 REVIEW

REV DATE DESCRIPTION

APPLICANT\OWNER: WEST SUBURBAN YMCA 276 CHURCH STREET

NEWTON, MA 02458 PROJECT:

> CAMP CHICKAMI 139 BOSTON POST ROAD WAYLAND, MA

2562-01 DATE: PROJECT NO. 11-10-21 SCALE: 1" = ##' DWG. NAME: **DESIGNED BY:** JG | CHECKED BY:



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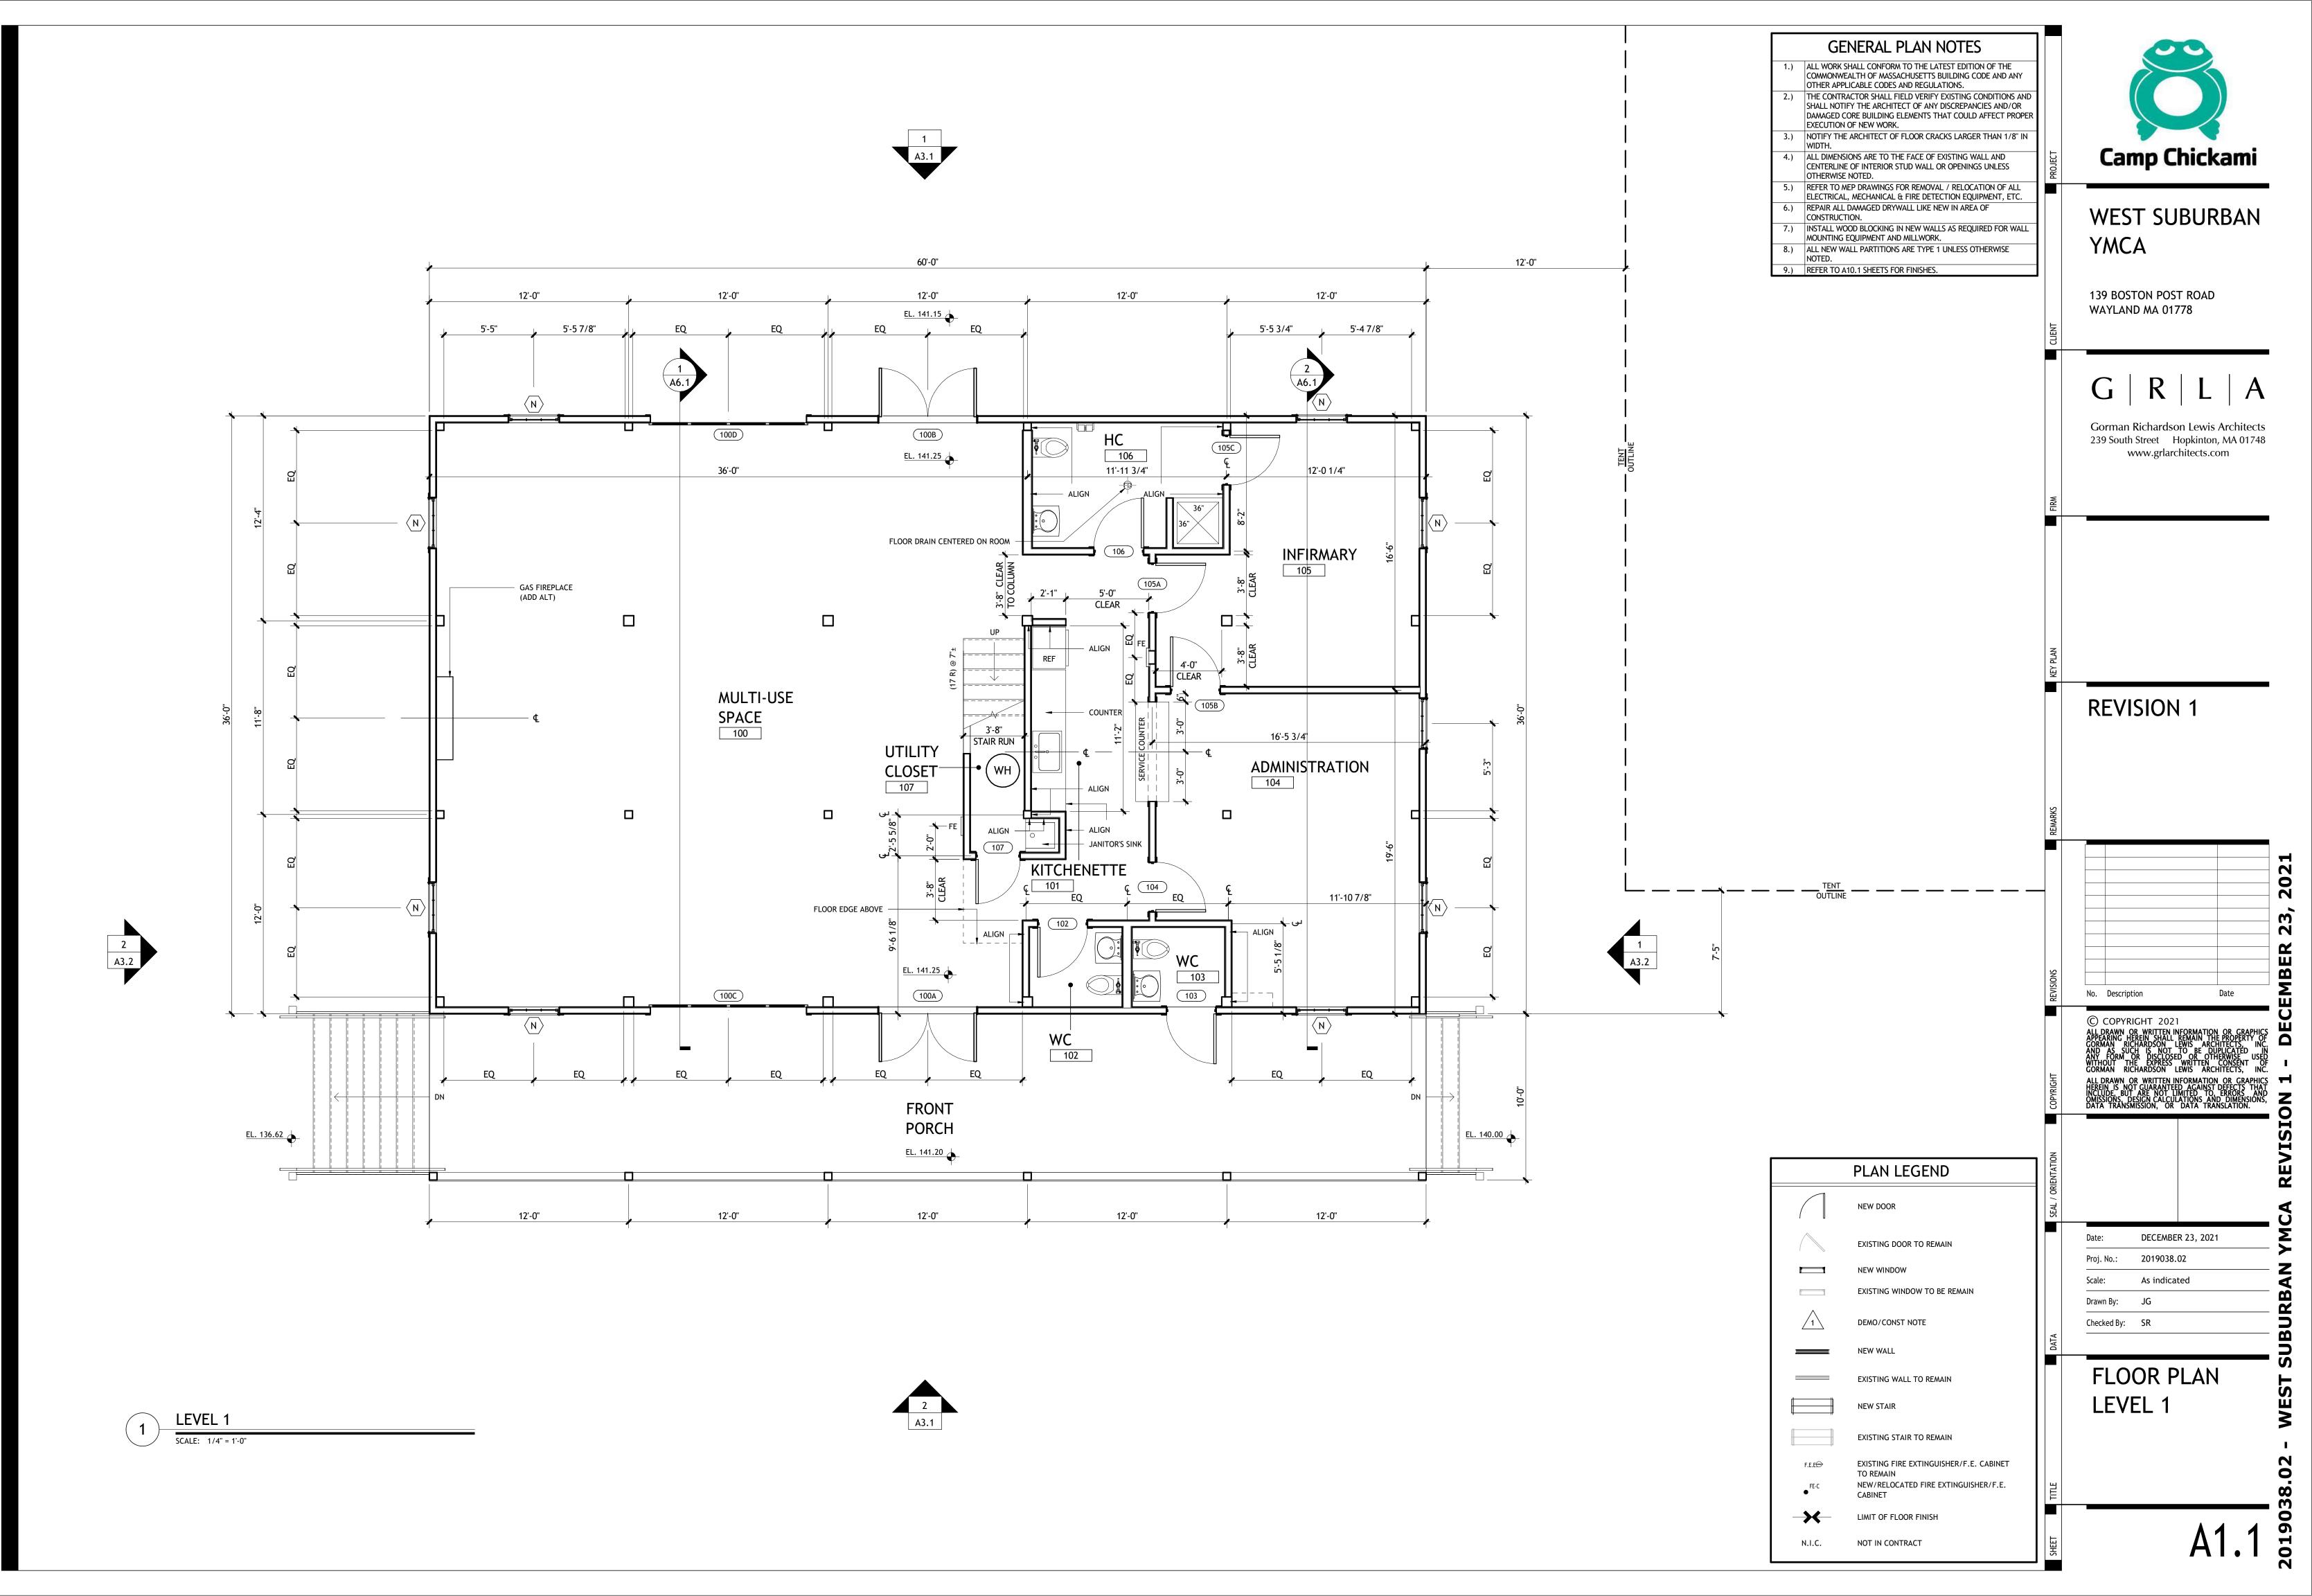
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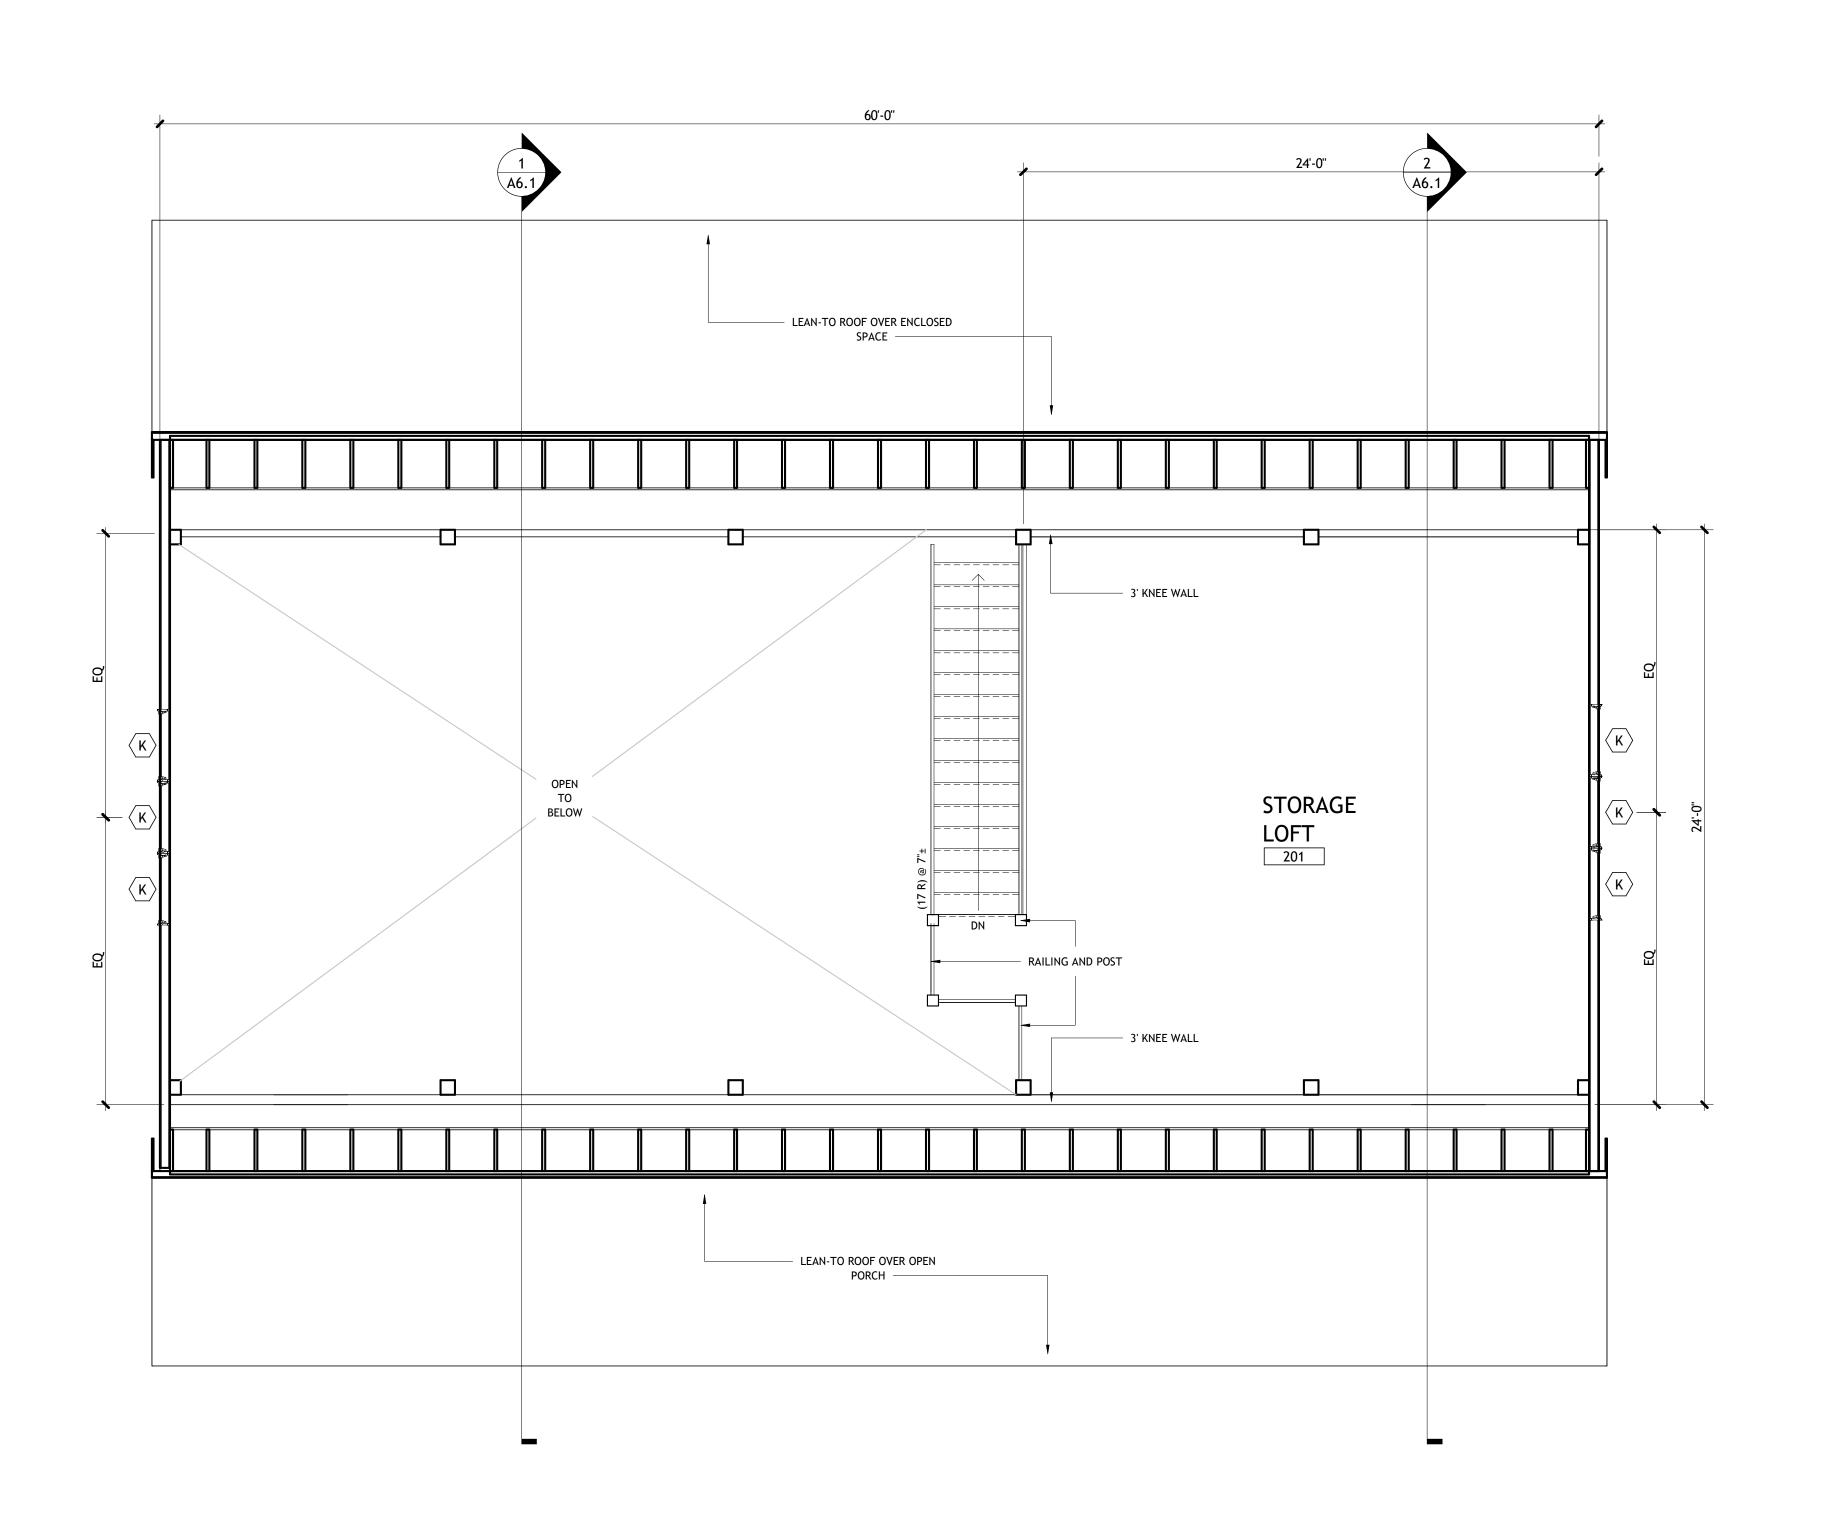
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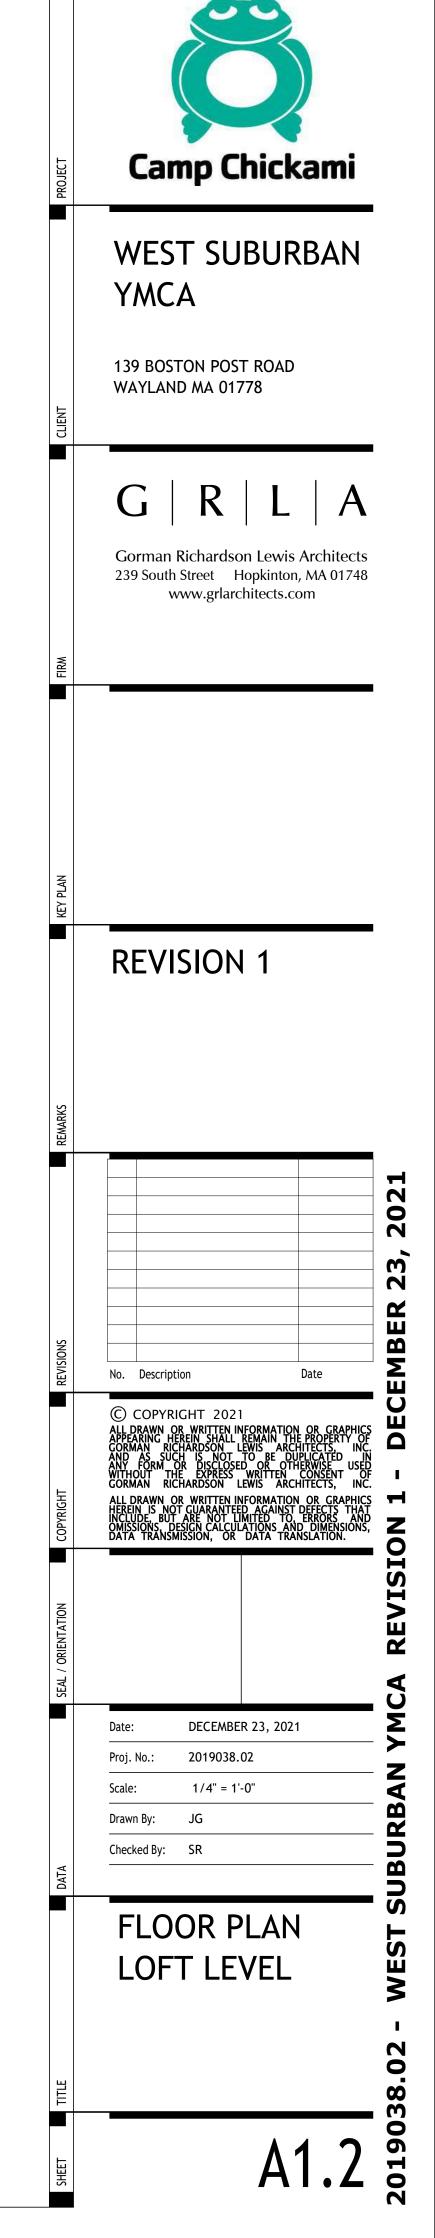
SUBSURFACE SEWAGE DISPOSAL SYSTEM DETAILS

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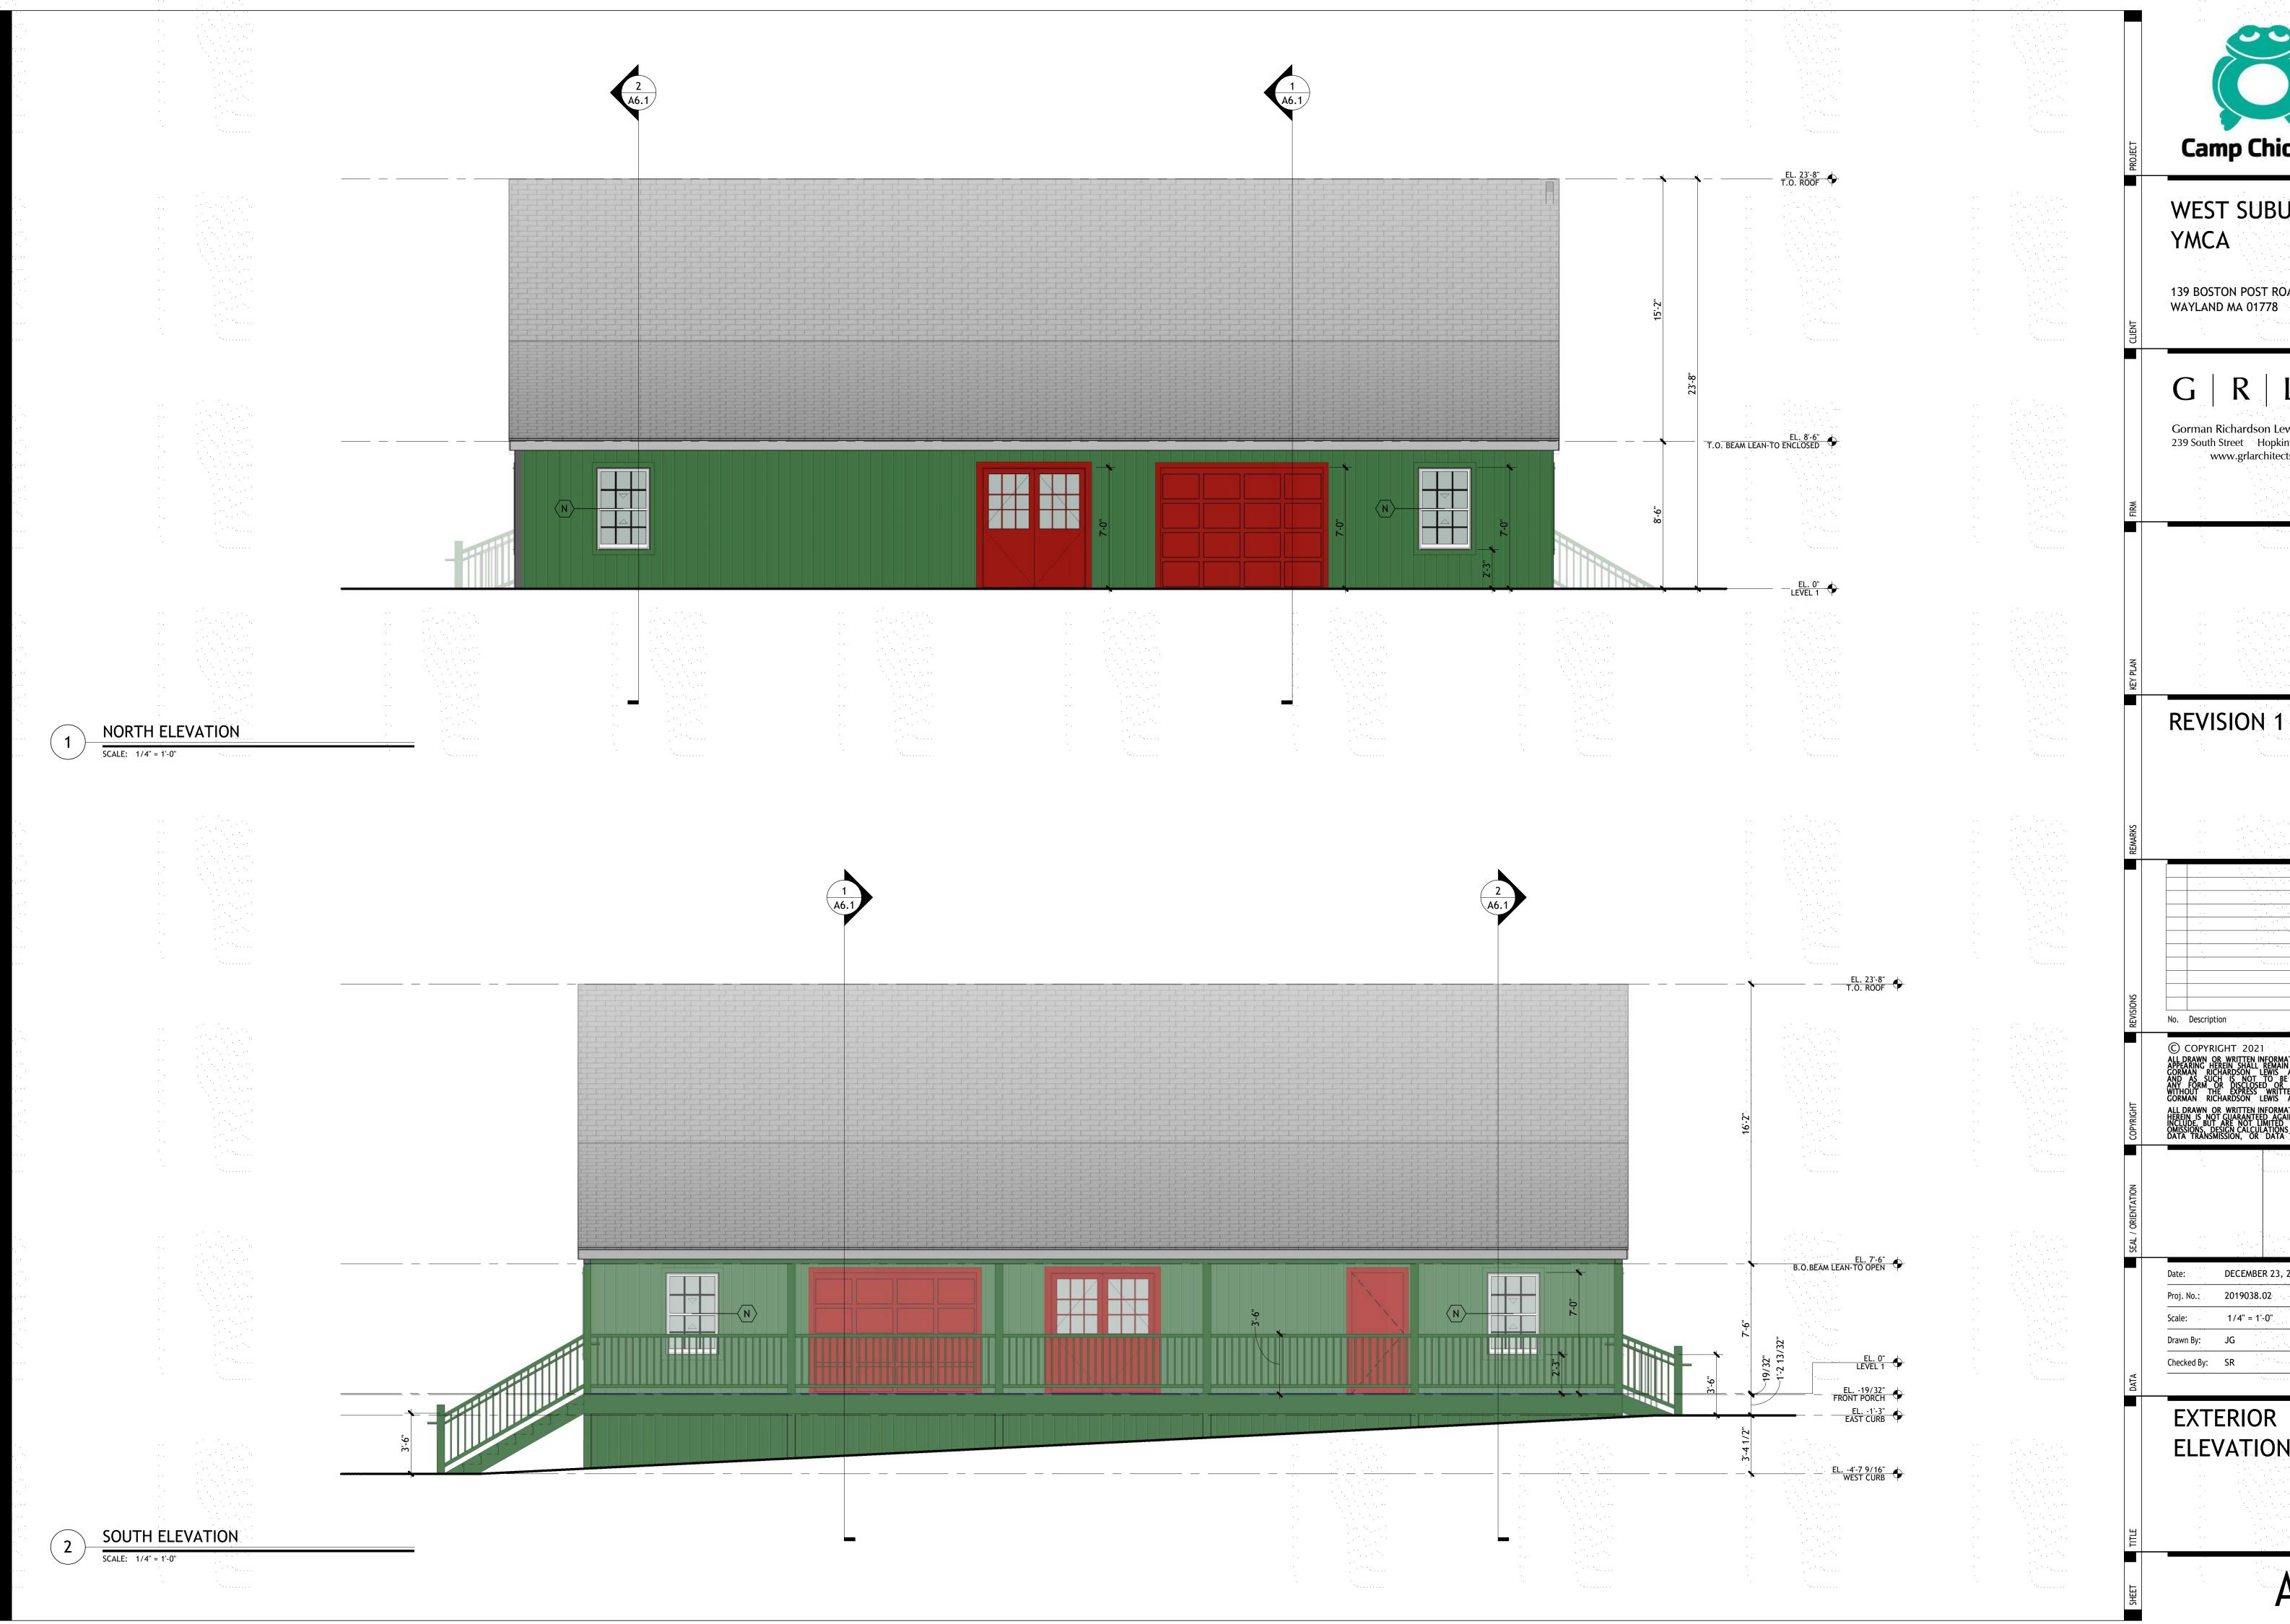






LOFT LEVEL

SCALE: 1/4" = 1'-0"



Camp Chickami

WEST SUBURBAN

139 BOSTON POST ROAD WAYLAND MA 01778

R

Gorman Richardson Lewis Architects 239 South Street Hopkinton, MA 01748 www.grlarchitects.com

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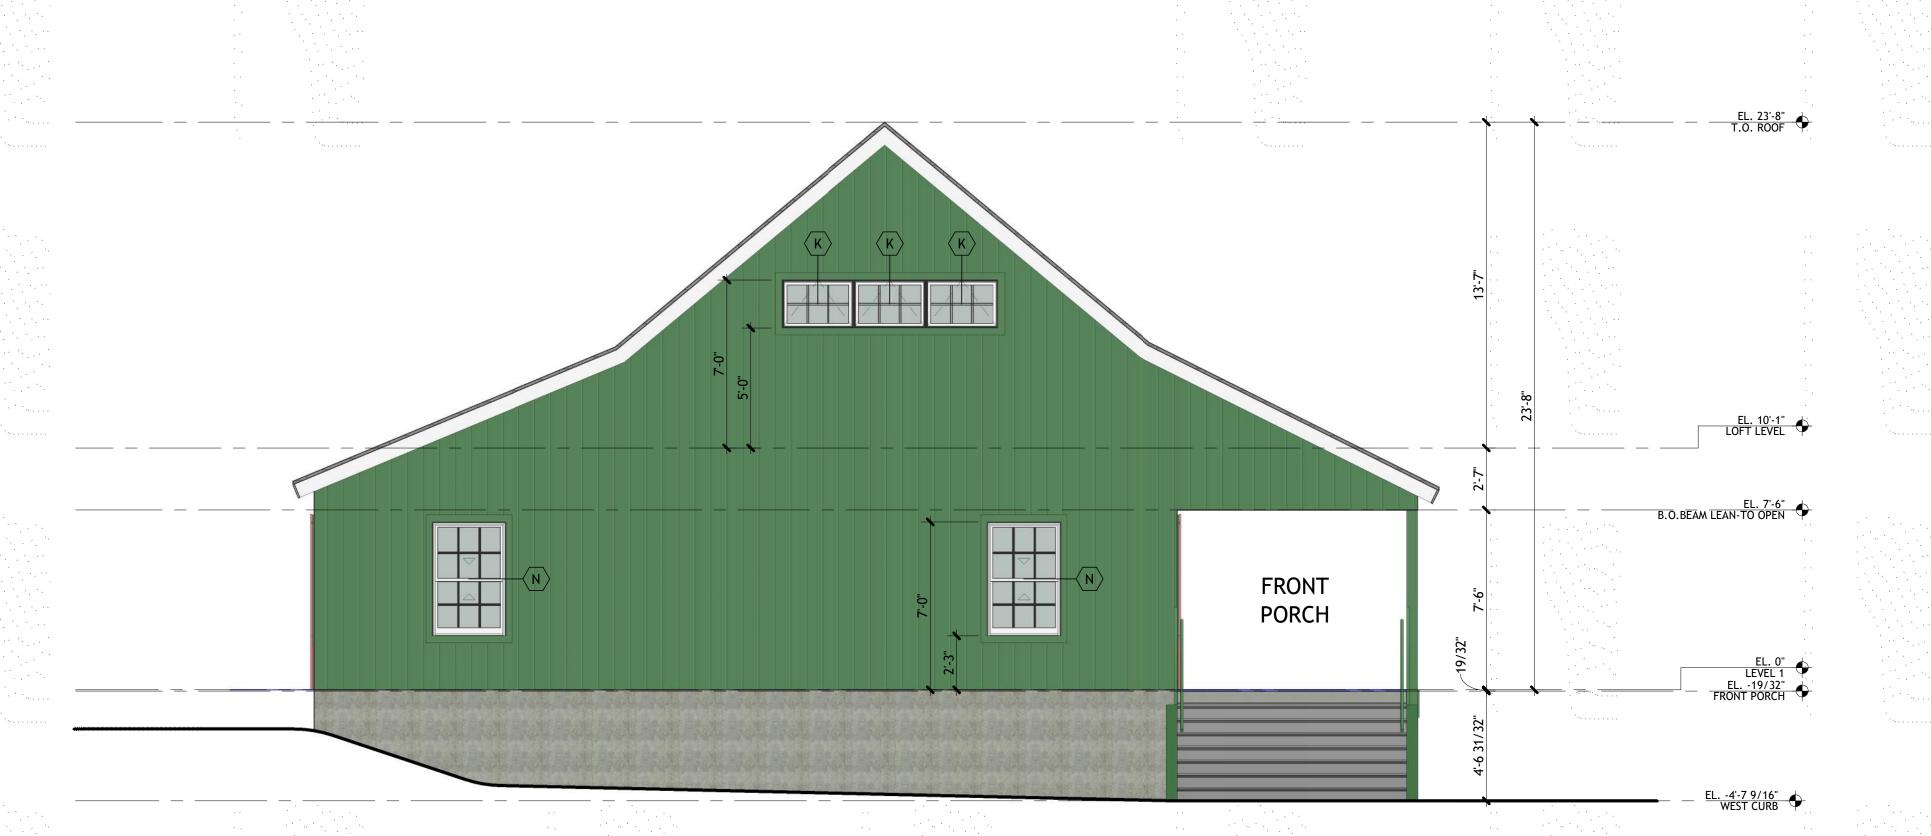
DECEMBER 23, 2021 Proj. No.: 2019038.02 1/4" = 1'-0"

Drawn By: JG Checked By: SR

EXTERIOR ELEVATIONS



EAST ELEVATION



Camp Chickami

WEST SUBURBAN YMCA

139 BOSTON POST ROAD WAYLAND MA 01778

R

Gorman Richardson Lewis Architects 239 South Street Hopkinton, MA 01748 www.grlarchitects.com

REVISION 1


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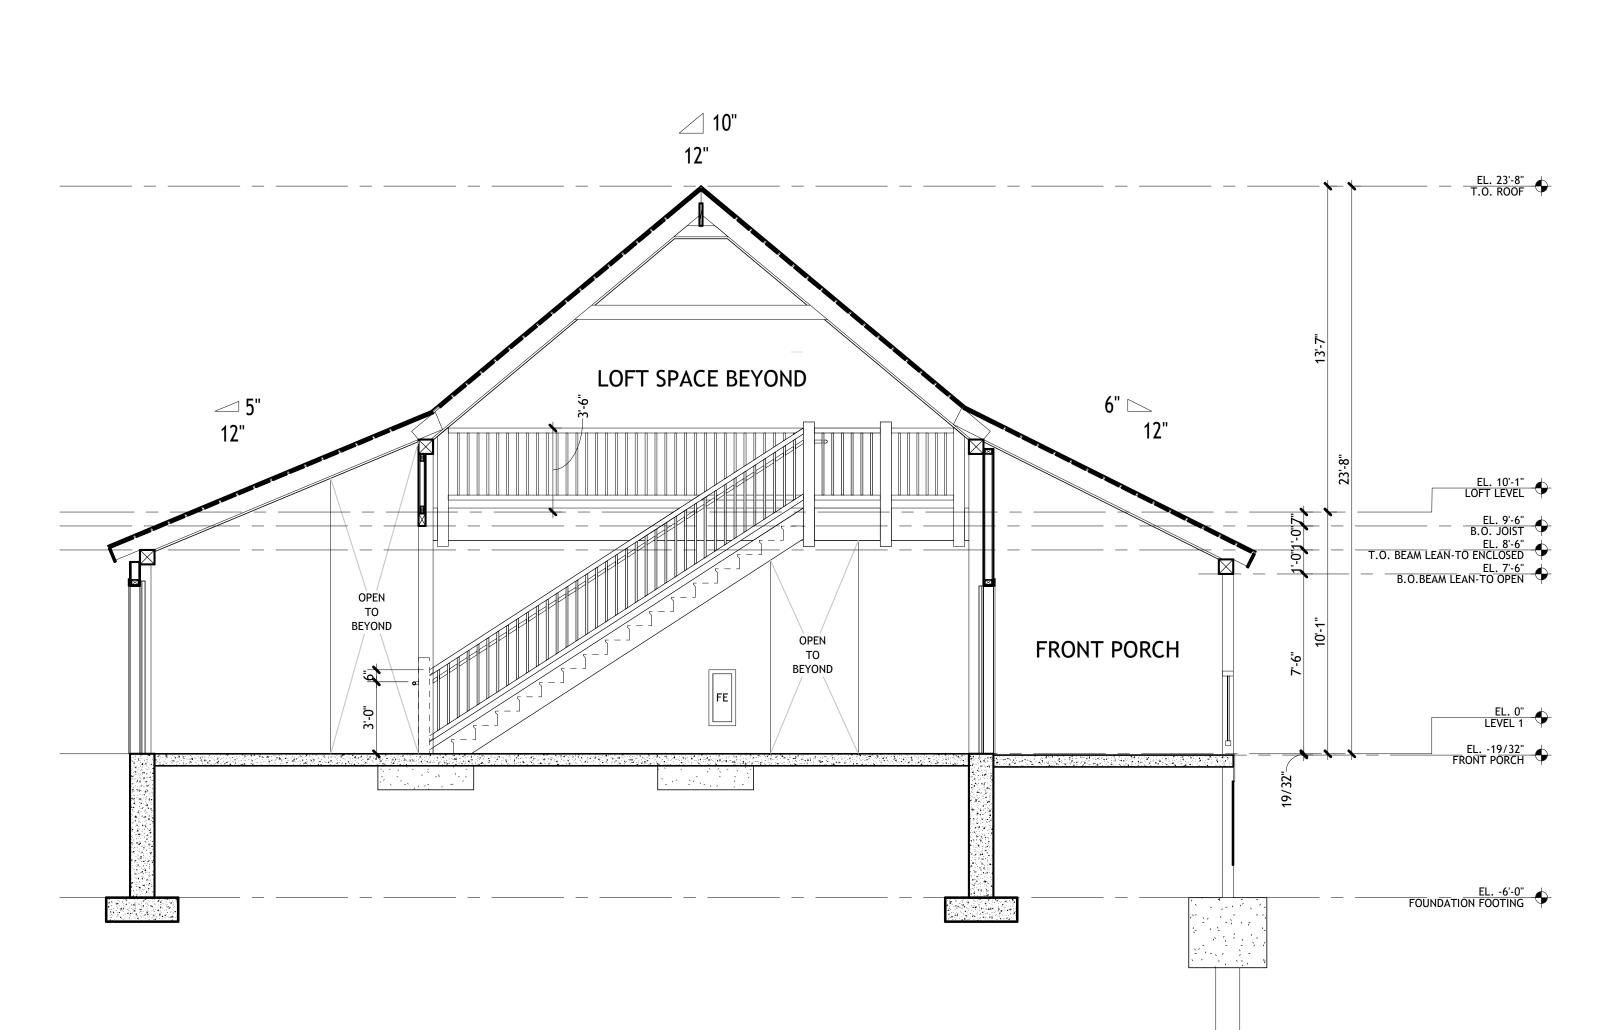
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EXTERIOR

ELEVATIONS

WEST ELEVATION SCALE: 1/4" = 1'-0"



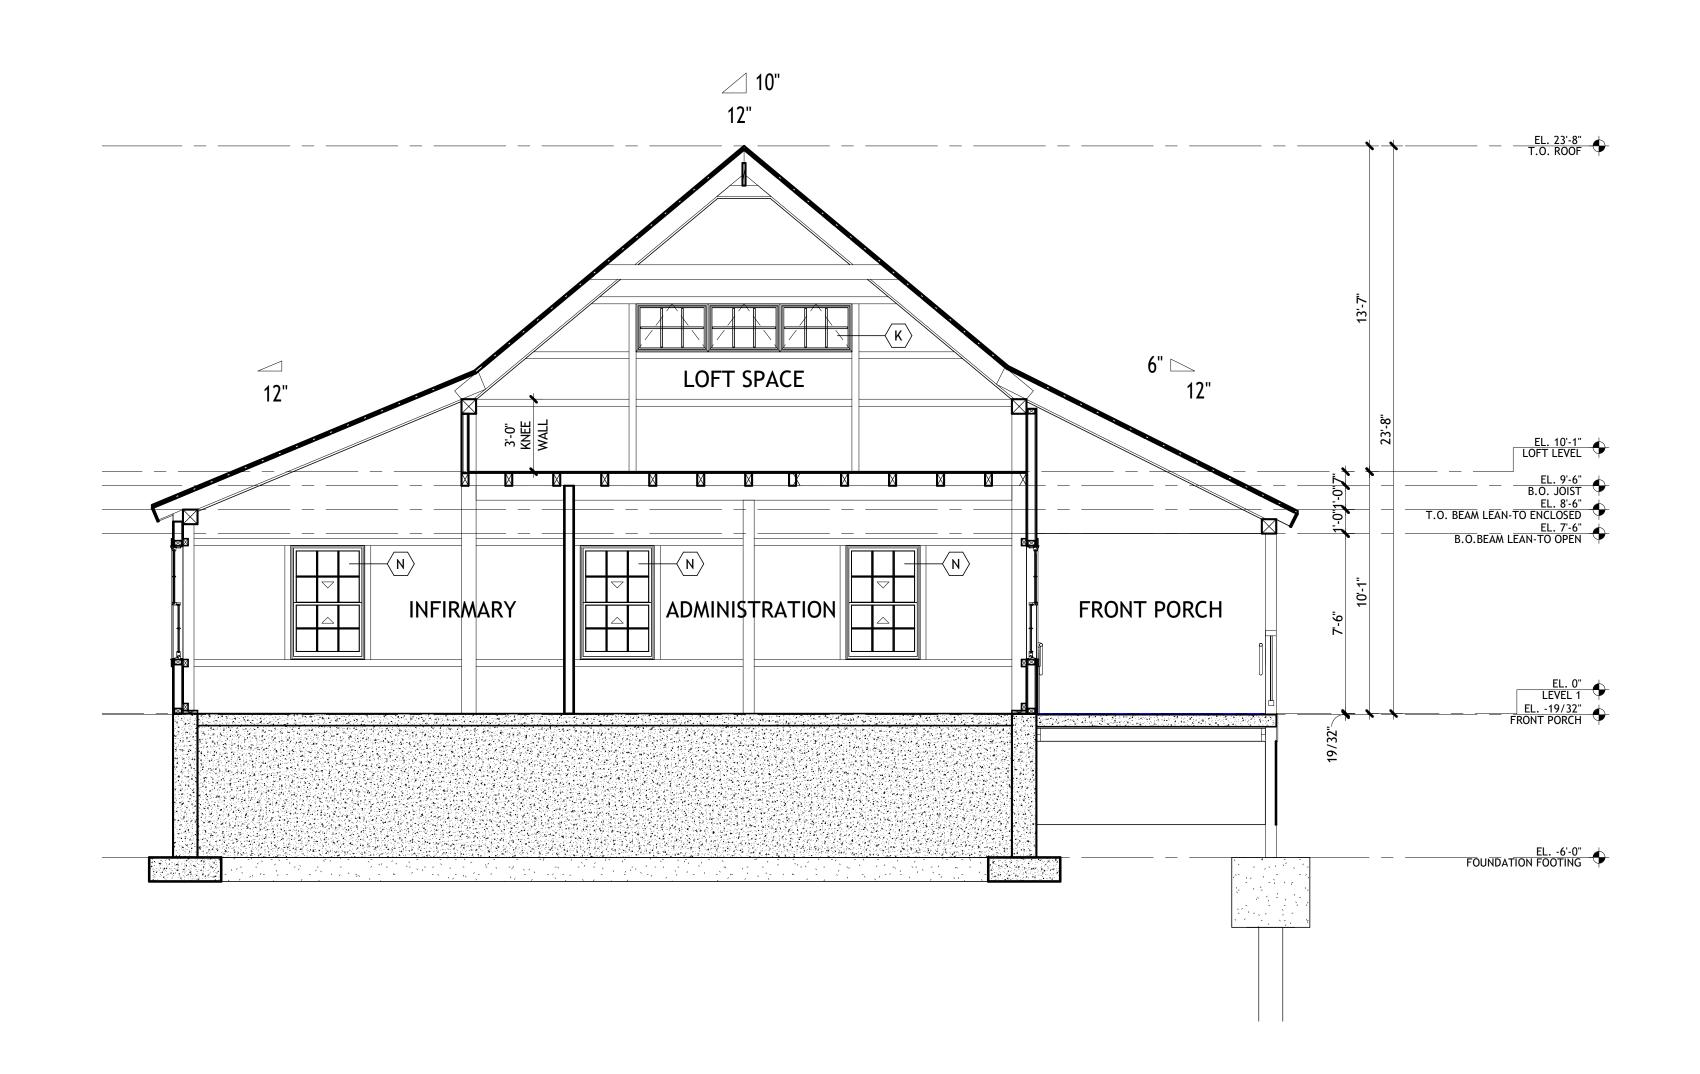

2 CROSS BUILDING SECTION @ LOFT

CROSS BUILDING SECTION

SCALE: 1/4" = 1'-0"

Camp Chickami

WEST SUBURBAN

Gorman Richardson Lewis Architects

239 South Street Hopkinton, MA 01748 www.grlarchitects.com

139 BOSTON POST ROAD

WAYLAND MA 01778

REVISION 1

No. Description

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DECEMBER 23, 2021

1/4" = 1'-0"

Proj. No.: 2019038.02

BUILDING

SECTIONS

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YMCA