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Consultant:



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WOBURN, MA ♦ LAKEVILLE, MA ♦ MANCHESTER, NH

Revision: ALLEN & MAJOR ASSOCIATES, INC.

Engineer of Record:

Drawn:

REV DATE DESCRIPTION APPLICANT\OWNER:

WE HEREBY CERTIFY THAT:

THIS PLAN IS THE RESULT OF AN ACTUAL ON

THE GROUND SURVEY PERFORMED ON OR BETWEEN MARCH 27, 2019 AND MAY 9, 2019.

THIS PLAN WAS PREPARED IN ACCORDANCE

REGISTERS OF DEEDS DATED JANUARY 1, 1976

WITH THE RULES AND REGULATIONS OF THE

ACCORDING TO DEEDS AND PLANS OF

PRIVATE STREETS AND WAYS ALREADY

NEW WAYS ARE SHOWN.

INFORMATION.

AND BELIEF.

RECORD, THE PROPERTY LINES SHOWN ON

THIS PLAN ARE THE LINES DIVIDING EXISTING

OWNERSHIP, AND THE LINES OF THE STREETS

OR WAYS SHOWN ARE THOSE OF PUBLIC OR

ESTABLISHED, AND THAT NO NEW LINES FOR

THE ABOVE CERTIFICATION IS INTENDED TO MEET REGISTRY OF DEEDS REQUIREMENTS FOR

THE RECORDING OF PLANS AND IS NOT A

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ADJOINING PROPERTIES ARE SHOWN

AND TOWN OF SUDBURY ASSESSOR'S

ALLEN & MAJOR ASSOCIATES, INC.

CERTIFICATION TO THE TITLE OR OWNERSHIP

ACCORDING TO CURRENT TOWN OF WAYLAND

THE ABOVE IS CERTIFIED TO THE BEST OF

MY PROFESSIONAL KNOWLEDGE, INFORMATION

LIPSITZ NO. 28446

THE DIVISION OF EXISTING OWNERSHIP OR FOR

AND REVISED JANUARY 12, 1988.

WP EAST ACQUISITIONS, LLC 91 HARTWELL AVENUE - 3RD FLOOR LEXINGTON, MA 02421

490 BOSTON POST ROAD WAYLAND, MA

PROJECT NO. 1670-09A DATE: 06/17/19 1" = 40' DWG. NAME: S-1670-09A-E DRAFTED BY: COB/KAC CHECKED BY:

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COURTYARD

Project Name:

ALTA AT RIVER'S **EDGE**

490, 492, 494 BOSTON POST RD WAYLAND, MA 01778

Sheet Name:

RECORD EXISTING CONDITIONS


Project Number: 1670-09A

Issue Date:


SEPTEMBER 23, 2020

Sheet Number:



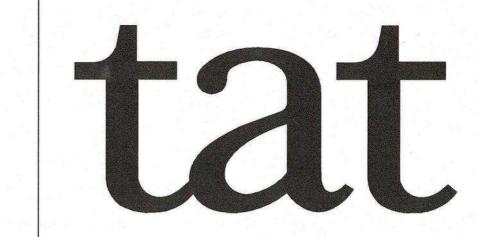


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- ALTHOUGH CERTAIN ITEMS HAVE BEEN NOTED ON THIS DRAWING FOR DEMOLITION, NO ATTEMPT HAS BEEN MADE TO DELINEATE EACH AND EVERY ITEM THAT REQUIRES DEMOLITION FOR THE COMPLETION OF THE PROJECT. THE CONTRACTOR WILL BE RESPONSIBLE FOR ALL NECESSARY DEMOLITION WORK TO COMPLETE THE PROJECT. ALLEN & MAJOR ASSOCIATES, INC. IS NOT RESPONSIBLE FOR SITE DEMOLITION ITEMS NOT SHOWN ON THE SURVEY, OR SPECIFICALLY NOTED. THE DEMOLITION NOTES AND ARROWS ON THIS PLAN
- FINAL LOCATIONS OF ALL EROSION CONTROL MEASURED THROUGHOUT CONSTRUCTION SHALL BE CONSERVATION DEPARTMENT AND DEPARTMENT OF
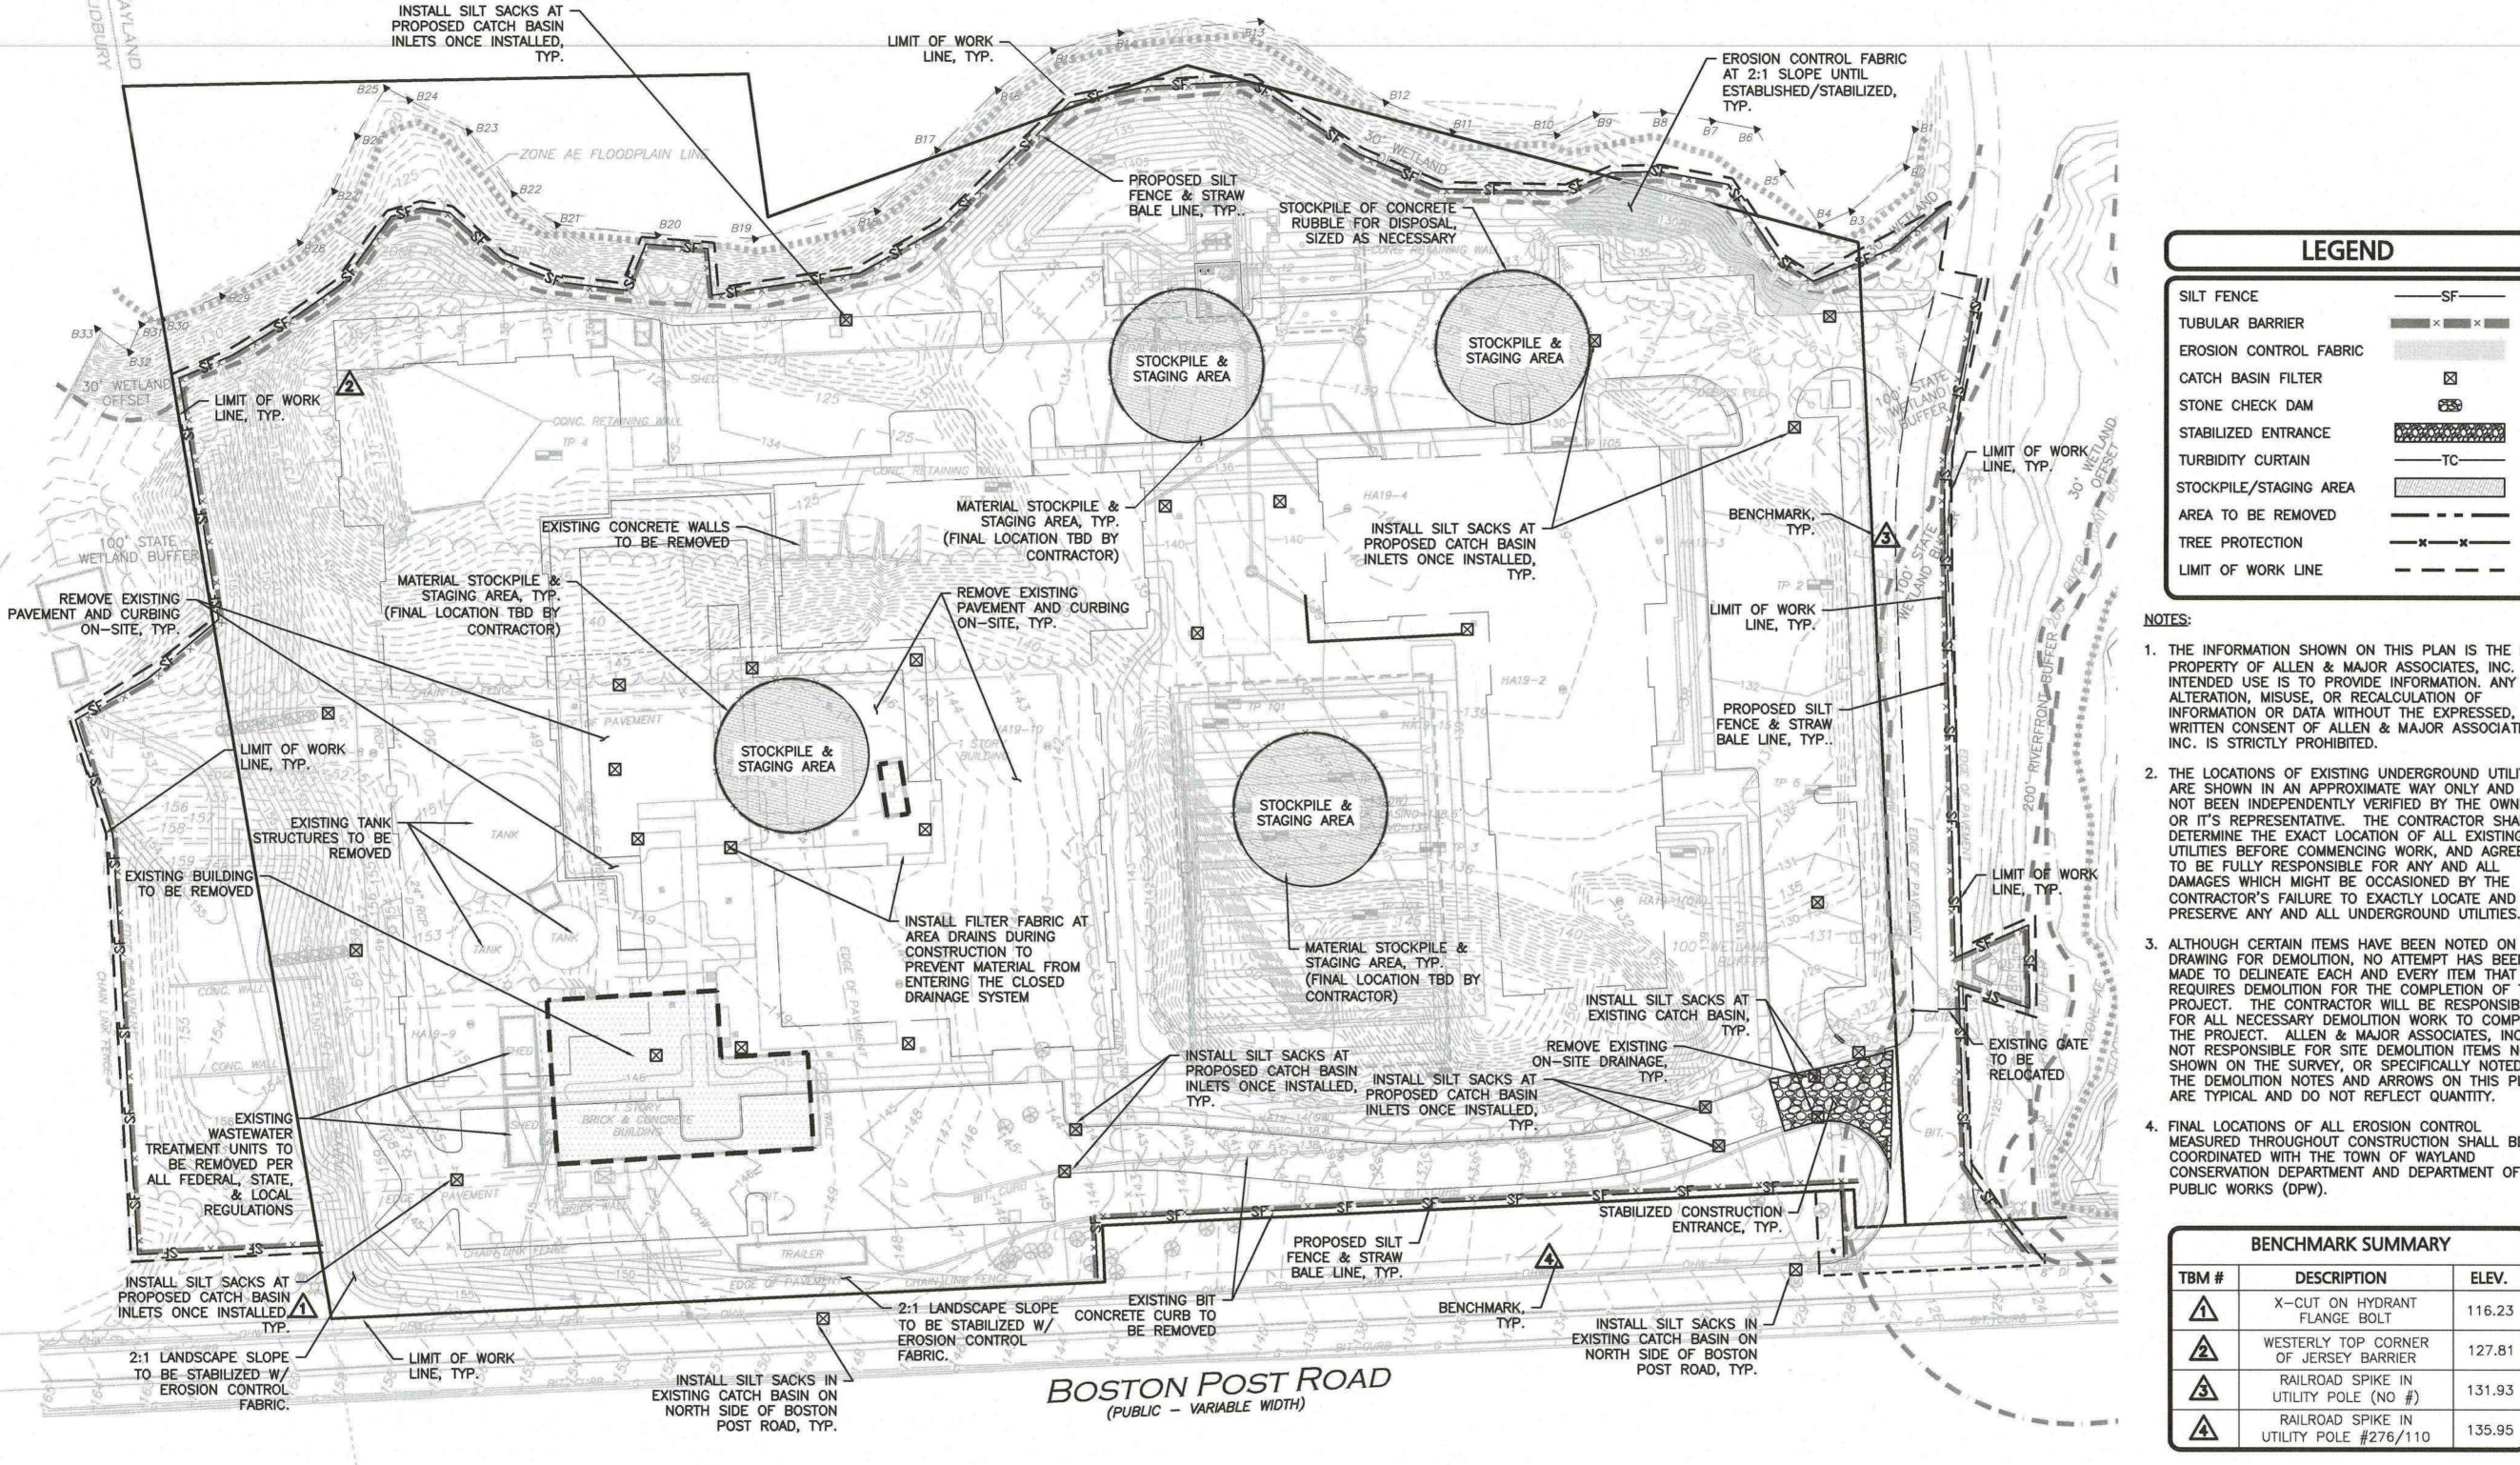
| | BENCHMARK SUMMARY | |
|-----------|--|--------|
| TBM # | DESCRIPTION | ELEV. |
| Λ | X-CUT ON HYDRANT FLANGE BOLT | 116.23 |
| A | WESTERLY TOP CORNER OF JERSEY BARRIER | 127.81 |
| 3 | RAILROAD SPIKE IN UTILITY POLE (NO #) | 131.93 |
| A | RAILROAD SPIKE IN UTILITY POLE #276/110 | 135.95 |





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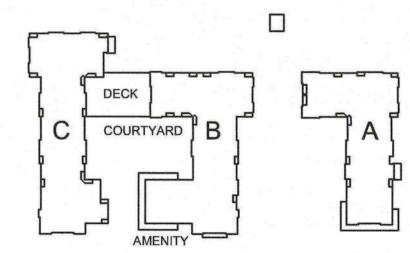


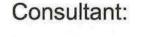SJL/ND Drawn:

Checked: CMQ

Scale: 1'' = 40'

Key Plan:



Project Name:

ALTA AT RIVER'S **EDGE**

490, 492, 494 BOSTON POST RD WAYLAND, MA 01778

Sheet Name:

DEMOLITION & EROSION CONTROL PLAN

Project Number:


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LEGEND PROPERTY LINE SIGN BOLLARD BUILDING BUILDING ARCHITECTURE CURB RETAINING WALL < 9° PARKING STRIPING TRAFFIC ARROWS HEAVY DUTY CONCRETE SIDEWALK ADA ACCESSIBLE RAMP ADA DET. WARNING SURFACE SETBACK LINE PARKING COUNT TREE LINE TRANSFORMER MONOLITHIC CURBING MONO.

NOTES:

1. THE LOCATIONS OF EXISTING UNDERGROUND UTILITIES ARE SHOWN IN AN APPROXIMATE WAY ONLY AND HAVE NOT BEEN INDEPENDENTLY VERIFIED BY THE OWNER OR ITS REPRESENTATIVE. THE CONTRACTOR SHALL DETERMINE THE EXACT LOCATION OF ALL EXISTING UTILITIES BEFORE COMMENCING WORK, AND AGREES TO BE FULLY RESPONSIBLE FOR ANY AND ALL DAMAGES WHICH MIGHT BE OCCASIONED BY THE CONTRACTOR'S FAILURE TO EXACTLY LOCATE AND PRESERVE ANY AND ALL UNDERGROUND UTILITIES.

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3. THE CONTRACTOR SHALL CONTACT "DIGSAFE" AND THE TOWN OF WAYLAND DEPARTMENT OF PUBLIC WORKS AT LEAST 72 HOURS PRIOR TO ANY EXCAVATION WORK TO REQUEST THE LOCATION OF THE EXISTING

DIGSAFE: 1-800-344-7233 WAYLAND DEPT. OF PUBLIC WORKS: (508) 358-3672

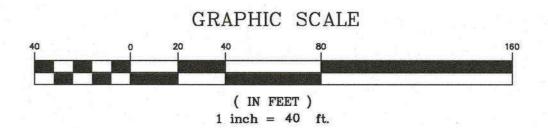4. SEE THE ABBREVIATIONS AND NOTES PLAN AND DETAILS FOR FURTHER INFORMATION.

5. ALL CURBING RADII SHALL BE 3' UNLESS OTHERWISE NOTED. ALL RADII

6. ALL ADA RAMPS ARE TO BE CONCRETE UNLESS SPECIFIED OTHERWISE.

7. EXISTING CONDITIONS BASE PLAN TAKEN FROM AN EXISTING CONDITIONS BASE PLAN ENTITLED "EXISTING CONDITIONS", PREPARED BY ALLEN &

8. RIVERFRONT FLAGGINGS (RA SERIES) AND A&B SERIES WETLANDS FLAGGINGS TAKEN FROM A PLAN ENTITLED "EXSITING CONDITIONS SURVEY - 484-490 BOSTON POST ROAD - WAYLAND, MASSACHUSETTS, PREPARED BY WSP SELLS DATED JULY 16, 2015, SCALE 1"=60'.

9. ALL PAVEMENT MARKINGS AND SIGNAGE SHALL BE COORDINATED WITH THE WAYLAND DPW AND SHALL CONFIRM TO THE LATEST MUTCD STANDARDS.

10. ALL SIDEWALK MEASUREMENTS TAKEN FROM FACE OF CURB.

11. THE EXISTING PAVEMENT SHALL BE MILLED AND PAVED, PER DPW SPECIFICATIONS, FROM BOSTON POST ROAD TO THE PROPOSED GATE LOCATION ONCE CONSTRUCTION IS COMPLETE.

12. ALL EXISTING SIGNS WITHIN THE LIMIT OF WORK SHALL BE RETAINED UNLESS OTHERWISE INDICATED ON THE DRAWINGS.

13. ALL MARKINGS OUTSIDE THE DEVELOPMENT PARCEL SHALL BE THERMOPLASTIC UNLESS OTHERWISE NOTED. 14. THE MINIMUM MOUNTING HEIGHT OF POST MOUNTED SIGNS, MEASURED

OR SIDEWALK, OR ELEVATION OF THE NEAR EDGE OF TRAVEL WAY, SHALL BE 7 FEET, UNLESS OTHERWISE NOTED. 15. REMOVE THE EXISTING PASSING ZONE BY STRIPING NEW CENTERLINE PAVEMENT MARKINGS AS SHOWN, RELOCATE EXISTING SIGNAGE FROM THE EXISTING ZONE TERMINUS TO THE PROPOSED ZONE TERMINUS. ERADICATE

CONFLICTING CENTERLINE PAVEMENT MARKINGS AS NECESSARY.

VERTICALLY FROM THE BOTTOM OF THE SIGN TO THE TOP OF THE CURB

1670-09A Issue Date:

SEPTEMBER 23, 2020

Sheet Number:

ELECTRICAL MOVING TRUCK -EQUIPMENT, TYP. PARKING AREA 20' WIDE FIRE WOODEN C448488888888 TOWN OF WAYLAND GUARDRAIL WITH ACCESS-GRASSPAVE2 FALL PROTECTION WITH 10" MINIMUM BASE, TOWN OF WAYLAND TRANSFORMER PAD OR EQUIVALENT FIRE LANE NO -PARKING WITH BOLLARDS - FLAGGED BORDERING VEGETATED WETLANDS MODULAR BLOCK -RETAINING WALL GENERATOR PADS (BVW), TYP. SURROUNDING (SEE GRADING & (SIZE TBD) ELECTRICAL DRAINAGE PLAN) DNE AE FLOODPLAIN LINE EQUIPMENT, TYP TREATMENT PLANT TRANSITION FROM PROPOSED VERTICAL BY OTHERS, TYP. MODULAR BLOCK -BLOCK RETAINING" AINTENANC BUILDING 475± S.F. GRANITE CURBING TO, PRECAST CONCRETE (SEE GRADING & TANGENT! DRAINAGE PLAN) RELOCATED EXISTING VEHICULAR ACCESS
GATE & ASSOCIATED MOUNTABLE CONCRETE CURB SIGNAGE TO THIS # LOCATION BUILDING ENTRANCE 2- VEHICLE . 6-ELECTRIC TYP. CHARGING/PARKING VEHICLE FUTURE CHARGING/ PARKING SPACES, TYP. WOODEN -**GUARDRAIL** DECORATIVE FENCE -WITH FALL FOR FALL PROTECTION (SEE PROTECTION Z GARAGE ENTRY, TYP. FRUCTURAL/ARCHITECTURAL - ADA ACCESSIBLE FENCING PLANS FOR FENCE CURB RAMP WITH MOUNTING DETAIL DETECTABLE WARNING ENTRANCE WALK WITH 3 5.5' WIDE SIDEWALK SHELTER BOLLARDS CLEAR SPACE AT ALL WALKWAYS 6-<u>FUTURE</u> ELECTRIC VEHICLE OFF/RIDE CHARGING/PARKING BUILDING C SPACES, TYP. ADA ACCESSIBLE 2-ELECTRIC VEHICLE WITH DETECTABLE CHARGING/PARKING WARNING PANEL, SPACES, TYP. - SITE AMENITIES & -1 TP 1 POOL AREA, TYP. BUILDING B STANDARD DUTY (SEE LANDSCAPE BIT. CONC. @ 151.83 HA19-8 6 STONEDUST SIGNS IN CONC. PAVEMENT, TYP SEATING AREA FILLED STEEL HARDSCAPE DETAILS) BOLLARDS AT HC (SEE LANDSCAPE HA19-13(OW) PARKING PLANS) - LAWN TAREA CASTO 5.5' WIDE (SEE LANDSCAPE PLANS CONCRETE PROPOSE FOR HARDSCAPE DETAILS SIDEWALK BUILDING LIGHT POLE AND SITE AMENITIES) FOOTPRINT. SEE "ALTA AT RIVER'S ARCHITECTURAL R1-1 "STOP" -PLANS FOR EDGE" MONUMENT FURTHER DETAIL SIGN, TYP. SIGN & RETAINING & DIMENSIONS, WALL (SIGNAGE BY - BUILDING OTHERS) OVERHANG ADA ACCESSIBLE CURB RAMP WITH DETECTABLE WARNING PANEL, TYP. - RELOCATE EXISTING - BUILDING ENTRANCE ACCESS GATE AND R7-8 SIGNS IN CONC. ASSOCIATED SIGNAGE FILLED STEEL BOLLARDS AT HC PARKING, TYP EXISTING PAVEMENT TO BE RESURFACED AFTER CONSTRUCTION (SEE NOTE TRANSITION FROM PROPOSED VERTICAL GRANITE CURBING TO PRECAST CONCRETE AT FIRE TRUCK TURN-AROUND PCC-SIGN, TYP. R25' -EDGE OF PAVEMENT INSTALL R-4-1-GRAVITY BLOCK -RADIUS=30' RETAINING WALL W/ PRESERVATIONS LIGHT POLE, -CURBING (R30") FALL PROTECTION STANDARD DUTY -R1-1 "STOP" ----(SEE DETAILS) BIT. CONC. LIGHT POLE, SIGN, TYP. PAVEMENT, TYP. 200.0' % MEET EXISTING DBYL STREET LINE OF WOODEN -/ (PER MASSDOT BOSTON POST ROAD GUARDRAIL, TYP. SPECIFICATIONS) STATE HIGHWAY LAYOUT TO BE REPAVED PER TRANSITION FROM -SAW-CUT -BOSTON POST ROAD MEET EXISTING PROPOSED VERTICAL MASS-DOT LINE, TYP. ADA ACCESSIBLE PICK UP/DROP GRANITE CURBING TO 6-FUTURE ELECTRIC VEHICLE STANDARD (PUBLIC - VARIABLE WIDTH) EXISTING BIT. BERM OFF/RIDE SHARING CURB RAMP WITH CHARGING/PARKING SPACES, TYP. DETECTABLE WARNING ERADICATE EXISTING MAINTAIN -2-ELECTRIC VEHICLE DASHED CENTERLINES EXISTING DBYL STRIPE THERMOPLASTC DBYL CHARGING/PARKING - REMOVE & (PER MASSDOT SPACES, TYP. (PER MASSDOT SPECIFICATIONS). RESET W14-3 SPECIFICATIONS) SEE SEE NOTE #15 NOTE #15

PARKING SUMMARY CHART

RIVER'S EDGE HOUSING OVERLAY DISTRICT (REHOD) PARKING SPACES SHALL BE PROVIDED AT A MINIMUM RATIO OF 1.25 PARKING SPACES PER DWELLING UNIT(1) (218 UNITS TOTAL) * (1.25 SPACES/UNITS) =273 SPACES TOTAL OFF-STREET PARKING REQUIREMENT =273 SPACES THEREFORE, 273 PARKING SPACES ARE REQUIRED AT A MINIMUM RATIO OF 1.25 SPACES PER 1 DWELLING UNIT. 345 TOTAL PARKING SPACES ARE CURRENTLY PROPOSED, INCLUDING 181 SPACES WITHIN THE PODIUM PARKING AREAS AND 164 SURFACE PARKING STALLS, FOR A PROPOSED PARKING RATIO OF 1.58 SPACES PER 1 DWELLING UNIT. 1.58 > 1.25, THEREFORE PROPOSED PARKING COUNT MEETS/EXCEEDS MINIMUM REQUIRED. THERE ARE BETWEEN 301 AND 400 TOTAL PARKING SPACES EQUIRING 8 ACCESSIBLE STALLS PER ADA REGULATIONS AND 2 OF THEM TO BE VAN ACCESSIBLE. ADA PROVIDED: 13 ADA ACCESSIBLE SPACES, 5 OF WHICH SHALL BE VAN **ACCESSIBLE** STRUCTURED PARKING STANDARD EV ADA STANDARD EV PROVIDED REQUIRED SPACES | SPACES | SPACES | SPACES | SPACES |

BEFORE YOU DIG CALL 811 OR 1-888-DIG-SAFE

1-888-344-7233

149

PARKING NOTES:

DIG SAFE

(1) ...AND MAXIMUM OF 15 PARKING SPACES FOR ANY ACCESSORY CAFE OR DINER IN ADDITION TO SAID DWELLING UNIT PARKING SPACES. IF OVER 50% OF THE TOTAL NUMBER OF DWELLING UNITS ARE AGE RESTRICTED AS SET FORTH IN § 198-2506.6 BELOW, PARKING MAY BE PROVIDED AT A MINIMUM OF 0.50 PARKING SPACE PER

AGE-RESTRICTED DWELLING UNIT. (2) INCLUDES 3 VAN ACCESSIBLE PARKING STALLS WITHIN STRUCTURED PODIUM PARKING. GRAPHIC SCALE (IN FEET) 1 inch = 40 ft.

PRECAST CONC. CURB Engineer of Record: -. 9.23,20 SJL/ND Drawn: Checked: CMQ 1" = 40' Scale: Key Plan: AND DIMENSIONS MEASURED AT FACE OF CURB. MAJOR ASSOCIATES, INC., ORIGINAL SCALE 1"=40', DATED MAY 8, 2019. DECK C COURTYARD

Project Name:

ALTA AT RIVER'S **EDGE**

490, 492, 494 BOSTON POST RD WAYLAND, MA 01778

Sheet Name:


LAYOUT & **MATERIALS** PLAN

Project Number:



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UNDERGROUND INFILTRATION SYSTEM #2-

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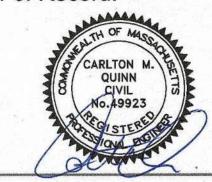
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Revision:

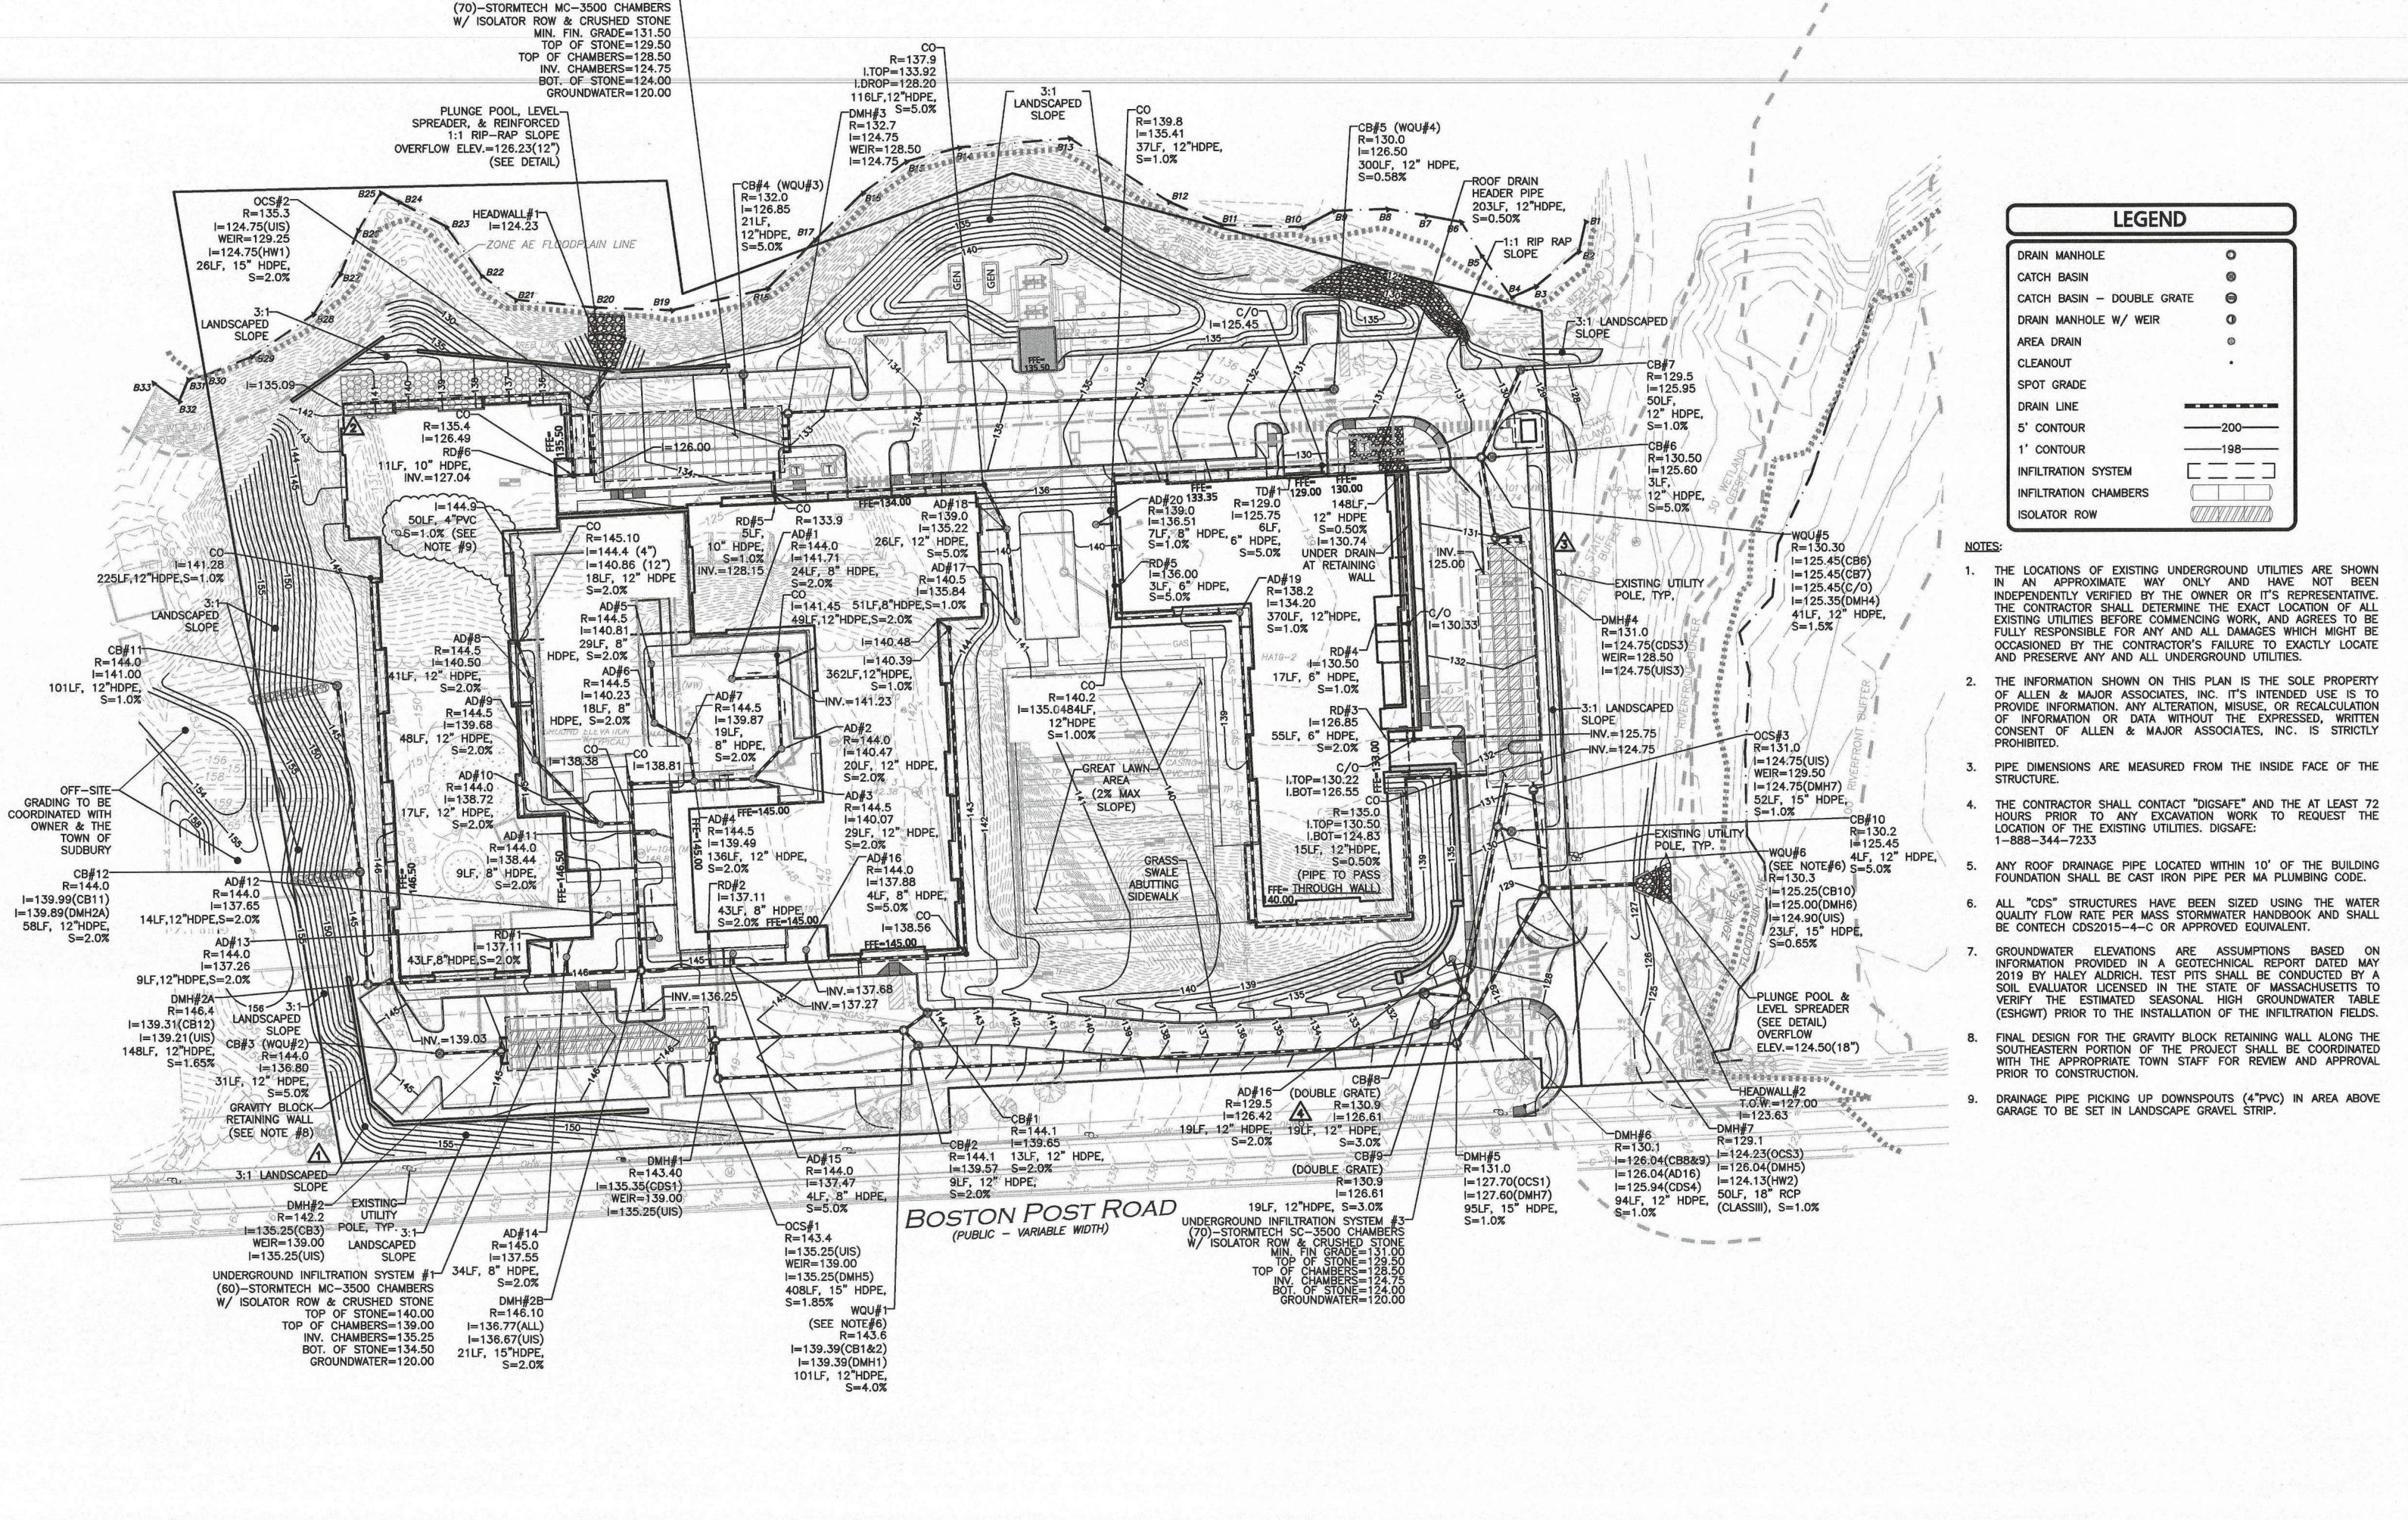Engineer of Record:



7.23,70

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Project Name:

ALTA AT RIVER'S EDGE

490, 492, 494 BOSTON POST RD WAYLAND, MA 01778

Sheet Name:

GRADING & DRAINAGE PLAN

Project Number:

1670-09A

Issue Date:

SEPTEMBER 23, 2020

Sheet Number:

C-103A

BENCHMARK SUMMARY

BM # DESCRIPTION ELEV.


X-CUT ON HYDRANT
FLANGE BOLT

WESTERLY TOP CORNER
OF JERSEY BARRIER

RAILROAD SPIKE IN
UTILITY POLE (NO #)

RAILROAD SPIKE IN
UTILITY POLE #276/110


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LEGEND

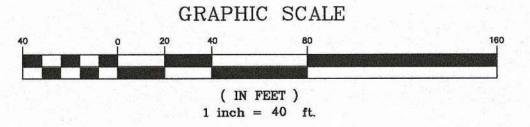SPOT GRADE ×148.00

NOTES

- 1. THE LOCATIONS OF EXISTING UNDERGROUND UTILITIES ARE SHOWN IN AN APPROXIMATE WAY ONLY AND HAVE NOT BEEN INDEPENDENTLY VERIFIED BY THE OWNER OR IT'S REPRESENTATIVE. THE CONTRACTOR SHALL DETERMINE THE EXACT LOCATION OF ALL EXISTING UTILITIES BEFORE COMMENCING WORK, AND AGREES TO BE FULLY RESPONSIBLE FOR ANY AND ALL DAMAGES WHICH MIGHT BE OCCASIONED BY THE CONTRACTOR'S FAILURE TO EXACTLY LOCATE AND PRESERVE ANY AND ALL UNDERGROUND UTILITIES.
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- 3. PIPE DIMENSIONS ARE MEASURED FROM THE INSIDE FACE OF THE STRUCTURE.
- 4. THE CONTRACTOR SHALL CONTACT "DIGSAFE" AND THE AT LEAST 72 HOURS PRIOR TO ANY EXCAVATION WORK TO REQUEST THE LOCATION OF THE EXISTING UTILITIES. DIGSAFE: 1-888-344-7233
- ANY ROOF DRAINAGE PIPE LOCATED WITHIN 10' OF THE BUILDING FOUNDATION SHALL BE CAST IRON PIPE PER MA PLUMBING CODE.
- 6. ALL "CDS" STRUCTURES HAVE BEEN SIZED USING THE WATER QUALITY FLOW RATE PER MASS STORMWATER HANDBOOK AND SHALL BE CONTECH CDS2015-4-C OR APPROVED EQUIVALENT.
- 7. GROUNDWATER ELEVATIONS ARE ASSUMPTIONS BASED ON INFORMATION PROVIDED IN A GEOTECHNICAL REPORT DATED MAY 2019 BY HALEY ALDRICH. TEST PITS SHALL BE CONDUCTED BY A SOIL EVALUATOR LICENSED IN THE STATE OF MASSACHUSETTS TO VERIFY THE ESTIMATED SEASONAL HIGH GROUNDWATER TABLE (ESHGWT) PRIOR TO THE INSTALLATION OF THE INFILTRATION FIELDS.
- 8. FINAL DESIGN FOR THE RETAINING WALL ALONG THE SOUTHEASTERN PORTION OF THE PROJECT SHALL BE COORDINATED WITH THE APPROPRIATE TOWN STAFF FOR REVIEW AND APPROVAL PRIOR TO CONSTRUCTION.
- 9. CONTRACTOR SHALL SUBMIT SHOP DRAWINGS FOR ALL RETAINING WALLS TO THE ENGINEER AND WHERE APPLICABLE THE APPROPRIATE TOWN STAFF FOR REVIEW AND APPROVAL PRIOR TO CONSTRUCTION.
- 10. EXTERIOR FINISHED SURFACE MATERIALS ABOVE GARAGE TO BE POROUS PER LANDSCAPE ARCHITECT. AREA IS INTENDED TO BE CONSTRUCTED RELATIVELY FLAT AND NO DRAINAGE IS PROPOSED AT THE FINISHED GRADE OF APPROXIMATELY 145.2.

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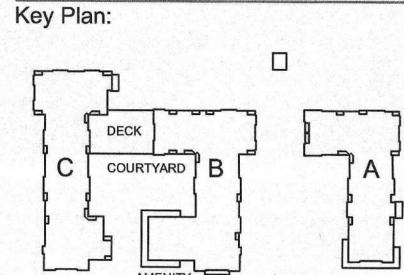

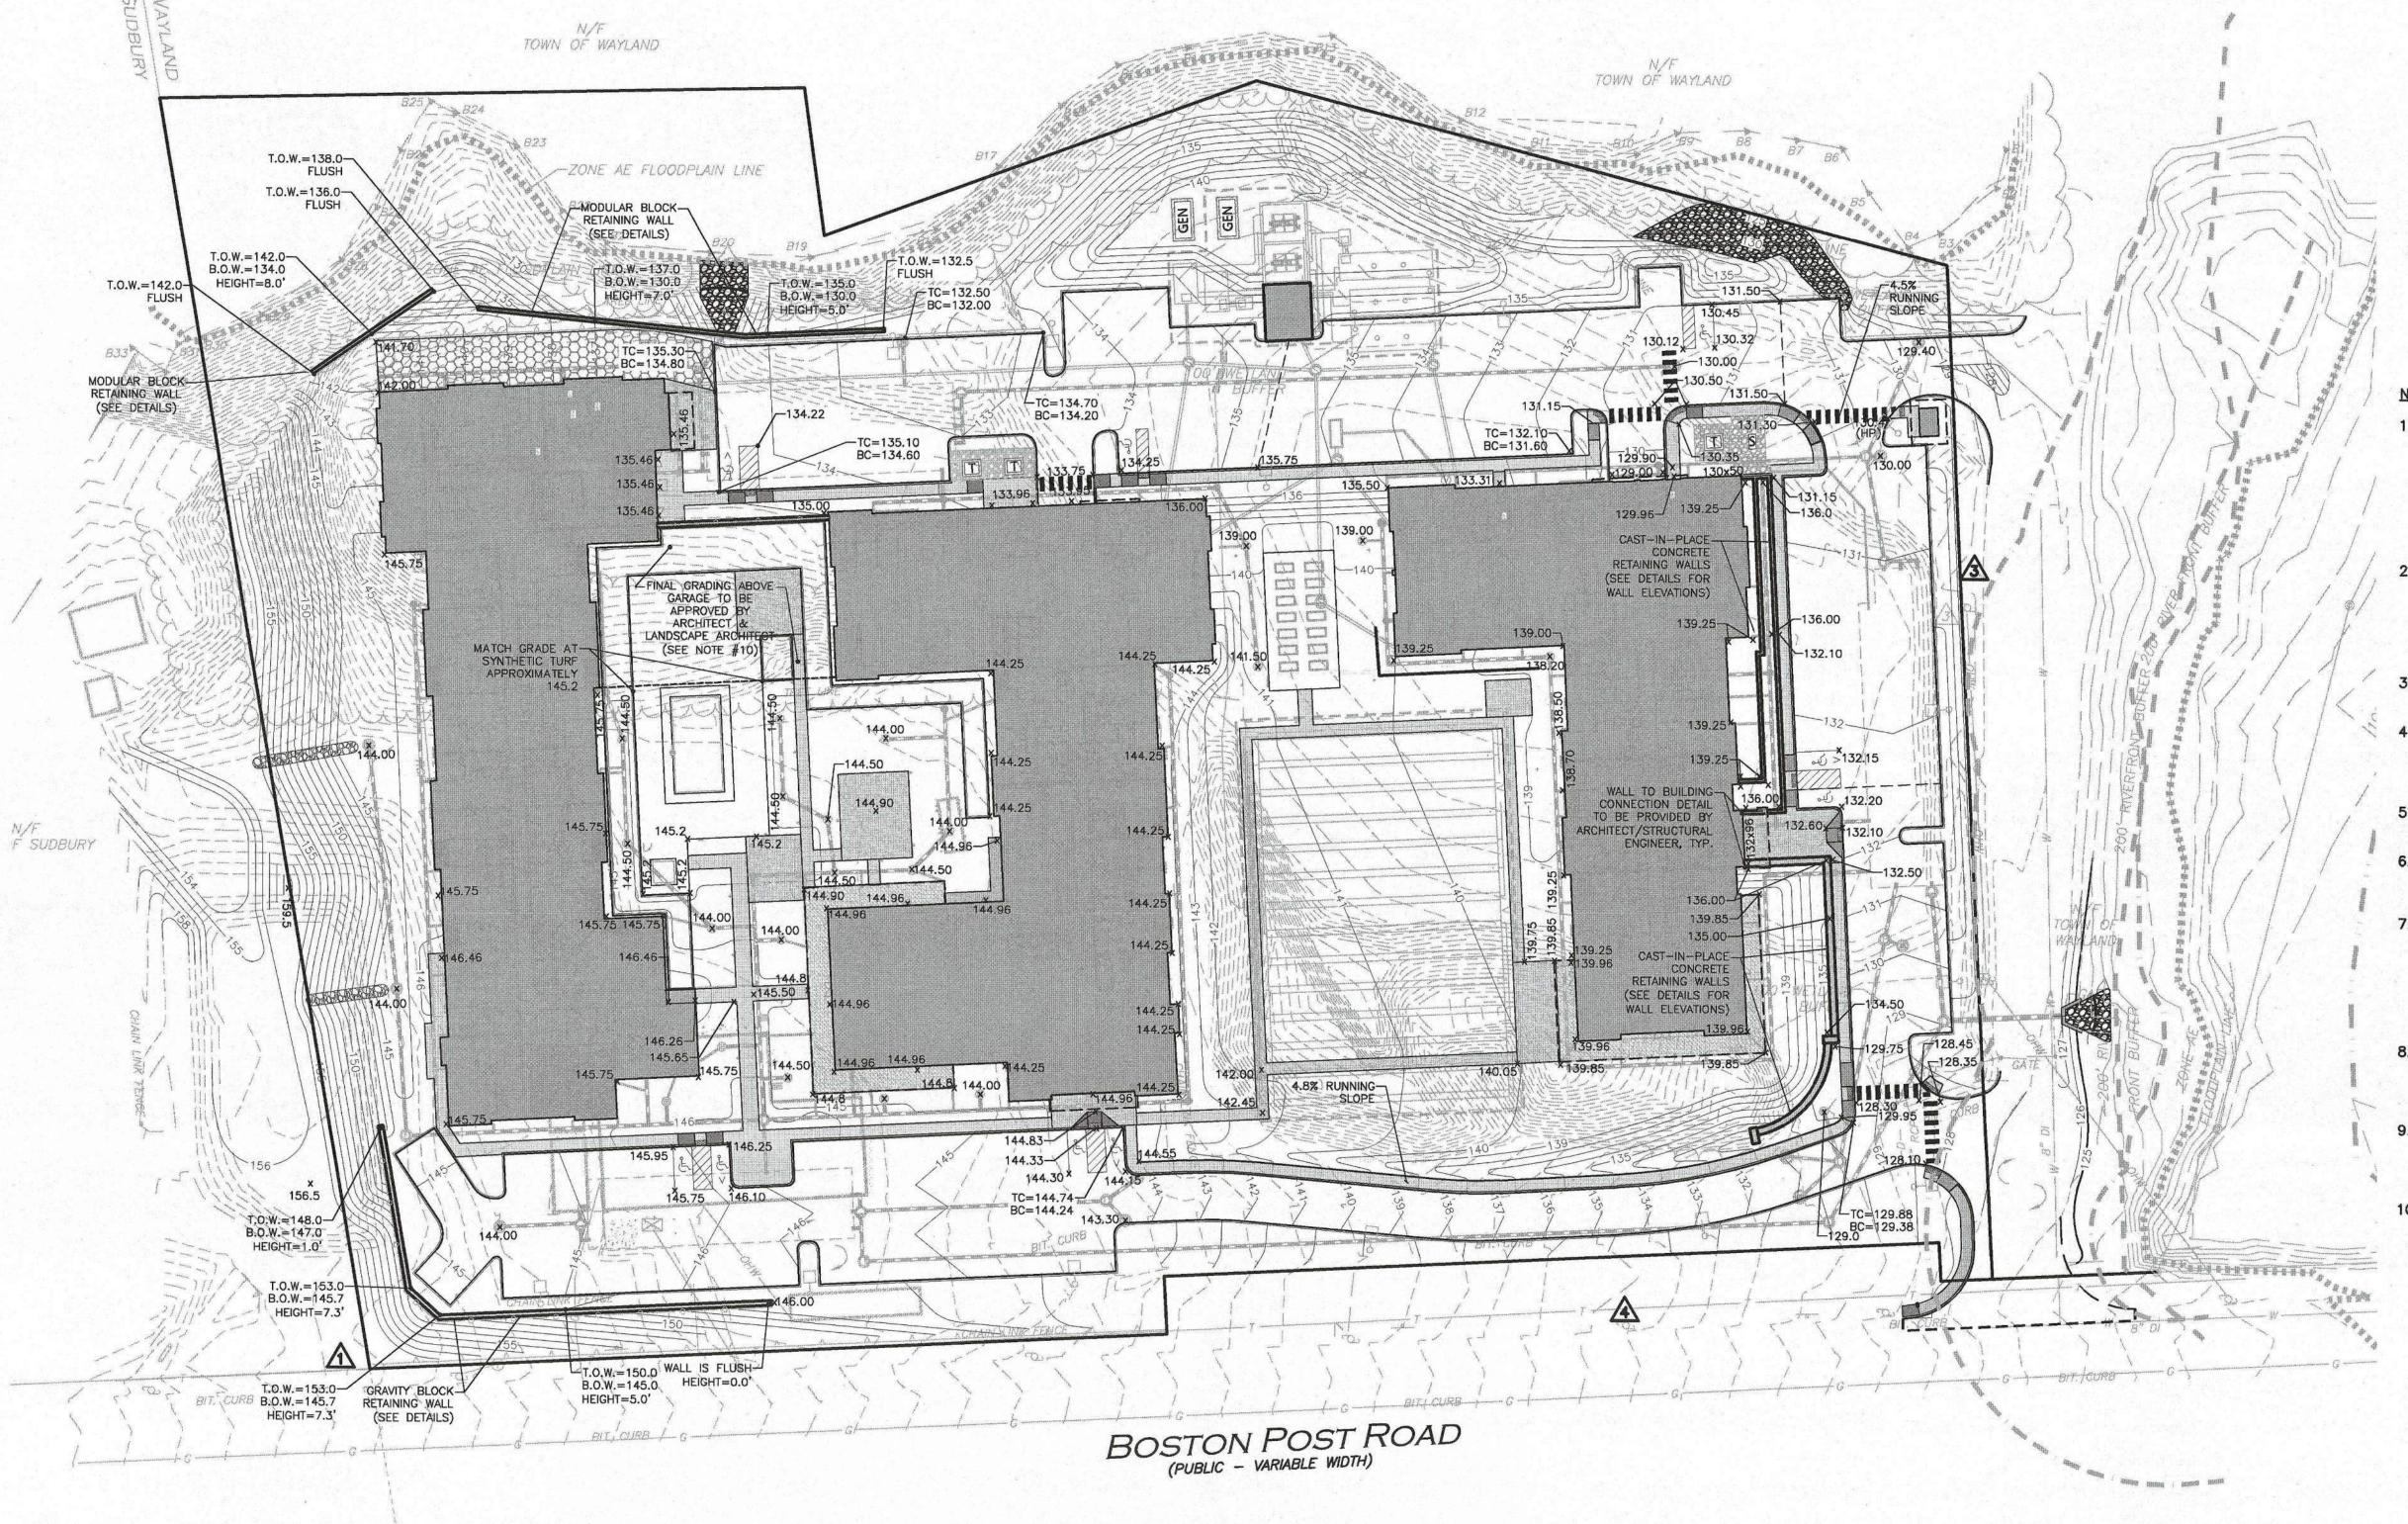
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Project Name:

ALTA AT RIVER'S EDGE

490, 492, 494 BOSTON POST RD WAYLAND, MA 01778

Sheet Name:

SPOT GRADE PLAN

Project Number:

1670-09A


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Project Name:

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Project Number:

1670-09A

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Issue Date:

PLAN

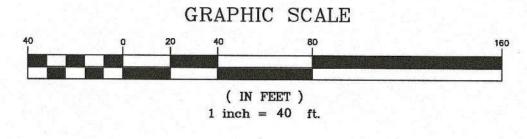WASTEWATER

ALTA AT RIVER'S

490, 492, 494 BOSTON

WAYLAND, MA 01778

SEPTEMBER 23, 2020

Engineer of Record:

SJL/ND

1" = 40'

LEGEND SEWER MANHOLE SEWER CLEANOUT SEWER VENT SEWER LINE WATER LINE WATER VALVE HYDRANT WATER LINE REDUCER GAS LINE GAS VALVE OVER HEAD WIRE ----OHW -----UTILILTY POLE HAND HOLE ELECTRICAL CONDUIT em E recommence E recommence

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THE LOCATIONS OF EXISTING UNDERGROUND UTILITIES ARE SHOWN IN AN APPROXIMATE WAY ONLY AND HAVE NOT BEEN INDEPENDENTLY VERIFIED BY THE OWNER OR IT'S REPRESENTATIVE. THE CONTRACTOR SHALL DETERMINE THE EXACT LOCATION OF ALL EXISTING UTILITIES BEFORE COMMENCING WORK, AND AGREES TO BE FULLY RESPONSIBLE FOR ANY AND ALL DAMAGES WHICH MIGHT BE OCCASIONED BY THE CONTRACTOR'S FAILURE TO EXACTLY LOCATE AND PRESERVE ANY AND ALL UNDERGROUND UTILITIES.


- THE INFORMATION SHOWN ON THIS PLAN IS THE SOLE PROPERTY OF ALLEN & MAJOR ASSOCIATES, INC. IT'S INTENDED USE IS TO PROVIDE INFORMATION. ANY ALTERATION, MISUSE, OR RECALCULATION OF INFORMATION OR DATA WITHOUT THE EXPRESSED, WRITTEN CONSENT OF ALLEN & MAJOR ASSOCIATES, INC. IS STRICTLY PROHIBITED.
- 3. ALL C.L.D.I. WATER PIPE SHALL BE CLASS 52.
- 4. GAS AND ELECTRIC SERVICE SIZE AND LOCATION SHALL BE DETERMINED BY SERVICE PROVIDER.
- FIRE & DOMESTIC WATER SERVICE SIZE & LOCATION TO BE CONFIRMED BY MEP ENGINEER.
- 6. THE PROPOSED IRRIGATION SYSTEM FOR THE DEVELOPMENT SHALL BE SUBMITTED TO WATER DEPARTMENT FOR APPROVAL PRIOR TO CONSTRUCTION.
- . HYDRANTS ARE TO BE INSTALLED PRIOR TO ANY COMBUSTIBLE MATERIALS BEING
- 8. PRIOR TO SUBMITTING FOR A BUILDING PERMIT, APPLICANT TO CONFIRM FINAL LOCATIONS OF FIRE HYDRANTS & FIRE DEPARTMENT CONNECTIONS WITH THE WAYLAND FIRE DEPARTMENT.
- 9. THE CONTRACTOR SHALL CONTACT "DIGSAFE" AND THE TOWN OF WAYLAND DEPARTMENT OF PUBLIC WORKS AT LEAST 72 HOURS PRIOR TO ANY EXCAVATION WORK TO REQUEST THE LOCATION OF THE EXISTING UTILITIES.

1-888-344-7233 DIGSAFE: 508-358-3672 WAYLAND DPW:


- 10. THE GRAVITY SEWER PIPE SHALL BE LEAKAGE TESTED IN ACCORDANCE WITH THE CURRENT REVISION OF THE UNI-BELL PVC PIPE ASSOCIATION'S UNI-B-6 STANDARD, AS MODIFIED.
- 11. THE SANITARY MANHOLES SHOULD BE TESTED BY MEANS OF A VACUUM TEST BY A THIRD PARTY TESTING COMPANYOR BY A 24-HR EXFILTRATION TESTING.
 WITNESSED BY THE ENGINEER.
- 12. FORCE MAIN PIPE SHALL BE FURNISHED BY THE WWTF CONTRACTOR AND INSTALLED BY THE SITE CONTRACTOR.

WASTEWATER TREATMENRY FACILITY (WWTF) NOTES:

- WWTF CONTRACTOR TO FURNISH AND INSTALL PRECAST TANKS, CAST-IN-PLACE TANKS, TURNKEY TREATMENT BUILDING, GENERATOR AND ASSOCIATED CONTROLS FOR THE WWTF. AND FURNISH THE FORCE MAIN PIPE.
- 2. SITE CONTRACTOR SHALL INSTALL FORCE MAIN PIPE APPROXIMATELY 10' FROM WWTF TO 10' FROM THE DISTRIBUTION BOX AT LEACHING FIELD.
- 3. <u>SITE CONTRACTOR</u> BACKFILL OF WWTF AND TANKS WITH ON-SITE MATERIAL STOCKPILED ADJACENT TO THE FACILITY BY THE SITE CONTRACTOR.

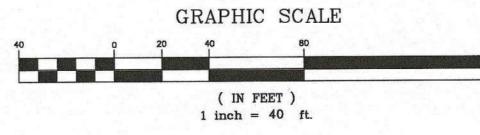

| | BENCHMARK SUMMARY | |
|-----------|--|--------|
| TBM # | DESCRIPTION | ELEV. |
| Λ | X-CUT ON HYDRANT FLANGE BOLT | 116.23 |
| 2 | WESTERLY TOP CORNER OF JERSEY BARRIER | 127.81 |
| 3 | RAILROAD SPIKE IN UTILITY POLE (NO #) | 131.93 |
| A | RAILROAD SPIKE IN UTILITY POLE #276/110 | 135.95 |

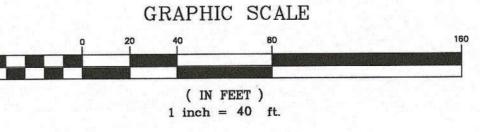

| DIG | SAF | Ε |
|---|--------------------------|---|
| 1 | | 1 |
| | | |
| Ams | | |
| 712000000000000000000000000000000000000 | E YOU 811 (-DIG-S | |
| | -344-7 | |

©ALTA RIVER'S EDGE,

BOSTON POST ROAD

(PUBLIC - VARIABLE WIDTH)

LIMIT OF WORK TO BE PROVIDED BY WWTP CONTRACTOR

RIM=135.2 I=127.89(WWTF)

I=127.77(MH1)

46LF, 8"PVC,

S=0.63%

I=123.50

S=1.0%

l=129.59

100.0'

TREATMENT FACILITY LEACHING FIELDS -

(BY OTHERS)

34LF, 6"PVC,

- SANITARY SEWER

35LF, 8"PVC, S=1.0%

I=127.82(MH3&MH4)

I=123.16(BLGA)

BE PROVIDED BY

WWTP CONTRACTOR

The state of the s

- INV.=128.39 12LF, 8"PVC,

S=4.2%

SMH#1 RIM=133.9

I=127.48(SMH2)

I=127.43(TANK)

TANK#1 (12'x5'-4")
(2000 GALLON DOUBLE WALL

TIGHT TANK; SEE DETAIL)

Short Short Short fit is facility that the first for the first

(HIGH WATER AND LEAK

ALARMS BY OTHERS)

RIM=134.9± I=123.02

5LF, 8"PVC, S=0.63%

- WASTEWATER TREATMENT FACILITY

(BY OTHERS)

SITE CONTRACTOR TO STUB PIPE
FOR WWTF
CONTRACTOR

RIM=136.0±

l=129.18 58LF, 8"PVC S=1.0%

GARAGE SEWER -

RIM=141.0±

S=1.0%

WMIT OF WORK TO

BE PROVIDED BY

WWTP CONTRACTOR

WASTEWATER

NOTES)

FORCE MAIN (SEE

I=129.24(BLG1)

I=129.14(MH2)

95LF, 8" PVC,

I=128.64(SMH6)

I=128.39(BLGB)

J=128.19(BLGC)

1=128.14(MH2) | 50LF, 8" PVC, S=0.63%

ZONE AE FLOODPLAIN LINE

I=129.50

S=0.61%


222LF, 8"PVC





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Consultant:

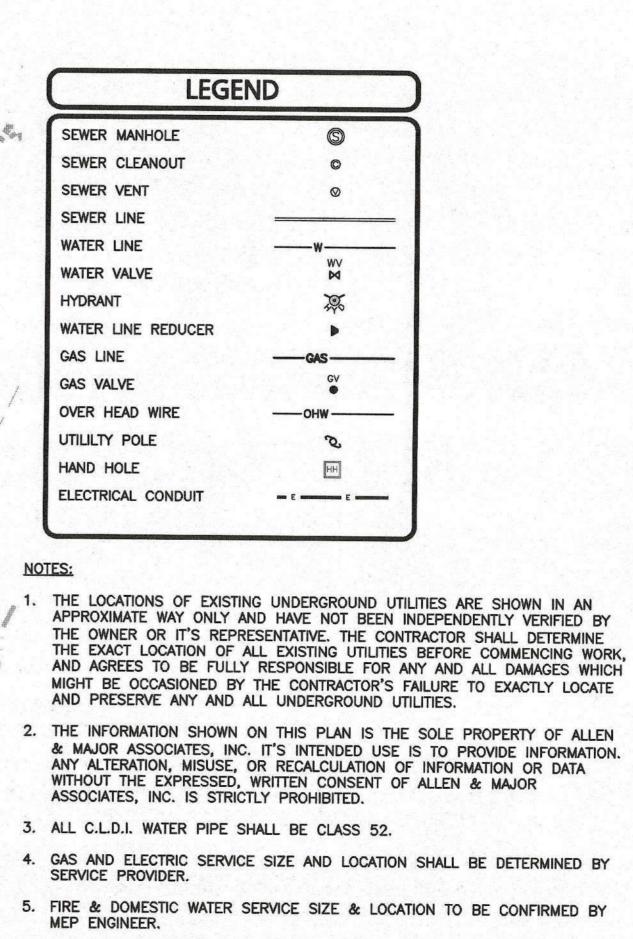

FIRE & DOMESTIC WATER SERVICE SIZE & LOCATION TO BE CONFIRMED BY

THE PROPOSED IRRIGATION SYSTEM FOR THE DEVELOPMENT SHALL BE

SUBMITTED TO WATER DEPARTMENT FOR APPROVAL PRIOR TO CONSTRUCTION.

HYDRANTS ARE TO BE INSTALLED PRIOR TO ANY COMBUSTIBLE MATERIALS BEING ON SITE.

8. PRIOR TO SUBMITTING FOR A BUILDING PERMIT, APPLICANT TO CONFIRM FINAL LOCATIONS OF FIRE HYDRANTS & FIRE DEPARTMENT CONNECTIONS WITH THE WAYLAND FIRE DEPARTMENT.


9. LOW VOLTAGE CONDUIT LOCATIONS TO BE CONFIRMED ON "LOW VOLTAGE SITE PLAN" BY OTHERS

10. THE CONTRACTOR SHALL CONTACT "DIGSAFE" AND THE TOWN OF WAYLAND DEPARTMENT OF PUBLIC WORKS AT LEAST 72 HOURS PRIOR TO ANY

EXCAVATION WORK TO REQUEST THE LOCATION OF THE EXISTING UTILITIES.

1-888-344-7233 WAYLAND DPW: 508-358-3672 508-358-3699 WAYLAND WATER DEPT .:


| | BENCHMARK SUMMARY | 1 |
|-----------|--|--------|
| TBM # | DESCRIPTION | ELEV. |
| Λ | X-CUT ON HYDRANT FLANGE BOLT | 116.23 |
| A | WESTERLY TOP CORNER OF JERSEY BARRIER | 127.81 |
| 3 | RAILROAD SPIKE IN UTILITY POLE (NO #) | 131.93 |
| A | RAILROAD SPIKE IN UTILITY POLE #276/110 | 135.95 |

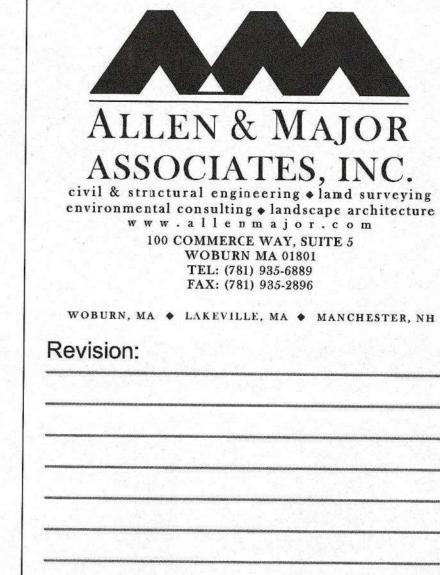

SJL/ND Drawn: Checked: CMQ

Scale: 1" = 40' Key Plan:

Engineer of Record:

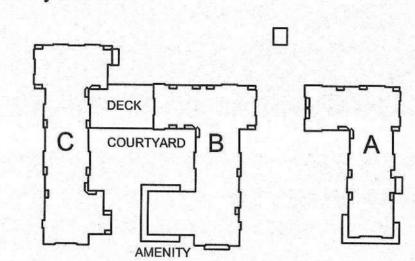

Project Name:

ALTA AT RIVER'S **EDGE**

490, 492, 494 BOSTON **POST RD** WAYLAND, MA 01778

Sheet Name:

UTILITIES PLAN

Project Number:

1670-09A

Issue Date:

SEPTEMBER 23, 2020 Sheet Number:

DIG SAFE BEFORE YOU DIG CALL 811 OR 1-888-DIG-SAFE 1-888-344-7233

30" WETLA OFFSET

METERS

SERVICE

- 8 GAS METERS

/- 8 GAS METERS

WATER SERVICE -

_ 6 GAS

METERS

6 GAS METERS 6 GAS

- 6 GAS

METERS

3 GAS SERVICES -

AT GRILL & FIRE TABLE LOCATIONS

(SEE LANDSCAPE

TO SHOWER

__ 6 GAS

8 GAS METERS

METERS

EMERGENCY GENERATOR -

BUILDINGS

EMERGENCY GENERATOR -

GENERATOR -

" VERIZON CONDUIT

TELECOM.

FIRE HYDRANT W/ 6"GATE VALVE

PULLBOX, TYP.

4" COMCAST CONDUIT 4" DAS CONDUIT

ELECTRICAL -

SERVICES

AND TEL/DATA

8" CLDI WATER MAIN -

(4.0' MINIMUM COVER)

- BUILDING "C" ISOLATION

VALVE, TYP.

- EXISTING FIRE

HYDRANT

FOR RESIDENTIAL

FOR WASTEWATER

(BY OTHERS)

TELECOM.

PULLBOX, TYP.

PROPOSED TRANSFORMER (1)

AND TRANSCLOSURE (1). FINAL

METERS

METERS

METERS

6 GAS -

8 GAS -/

METERS

8 GAS -METERS

EEEEE

METERS

6 GAS -

6 GAS —

6 GAS —

LOCATIONS TO BE CONFIMRED

REQUIREMENTS

TREATMENT FACILITY

2" DOM. WATER SERVICE

SITE CONTRACTOR

METERS

(2) 17"x30" ·

PULLBOX, TYP.

12 GAS

METERS

METERS

- 12 GAS

10 GAS

METERS

INSTALL PROPOSED -

SWITCH BOX

OVERHEAD ELECTRIC/

COORDINATE W/ UTILITY

EXISTING UTILITY POLE, TO REMAIN. ELECTRICAL SERVICE TO BE DRAWN

VIA OVERHEAD WIRES. (CONTRACTOR TO

COORDINATE WITH UTILITY

TELECOM. WIRES

(CONTRACTOR TO

PROVIDER)

PROVIDER)

INSTALL PROTECTUS III STAINLESS STEEL-

FIRE SERVICE WATER METER INSIDE WATER METER PIT VAULT PER MANUFACTURER

SPECIFICATIONS (TO BE FURNISHED BY THE CONTRACTOR). CONTRACTOR TO COORDINATE

INSTALLATION W/ THE TOWN OF WAYLAND DPW & WATER DEPARTMENT (SEE DETAIL)

CONDUIT FOR -

MONUMENT SIGN

TELECOM.

INCOMING SERVICE

SERVICE

AND TEL/DATA 4" VERIZON CONDUIT

SERVICES 4" COMCAST CONDUIT

ELECTRICAL

GAS SERVICE AT

GRILL LOCATIONS

(SEE LANDSCAPE

- BUILDING "B" ISOLATION

. Her has not been the many state to the last the last

BUILDING "A" ISOLATION .

VALVE, TYP.

PROPOSED UTILITY -

POLE EQUIPPED

(CONTRACTOR TO

COORDINATE W/

UTILITY PROVIDER)

W/ RISERS.

VALVE, TYP.

GAS SERVICE -

MAIN, TYP.

(CONTRACTOR TO

COORDINATE W/

UTILITY PROVIDER)

BOSTON POST ROAD (PUBLIC - VARIABLE WIDTH)

PLANS)

TO STUB PIPE

FOR WWTF

CONTRACTOR

PROPOSED TRANSFORMER.
FINAL LOCATION TO BE
CONFIRMED BY MEP AND

CABLE SWITCHING STATION

HIFIRE HYDRANT W/

PROJECT SITE

ISOLATION VALVE

EXISTING FIRE -

APPROXIMATELY 2750

LF OF EXISTING 3" CS #60 MAIN TO BE

#60 MAIN IN BOSTON POST ROAD TO THE LOCATION OF THE

PROJECT SITE

REPLACED W/ 6" PL

HYDRANT

CONNECT TO

OF WAYLAND

STANDARDS

EXISTING 8" WATER

LINE PER TOWN

6"GATE VALVE

UTILITY COMPANY

REQUIREMENTS

914 1 H H H H H H H H H H B B B 13

GRAPHIC SCALE (IN FEET)
1 inch = 40 ft.


LANDSCAPE LAYOUT NOTES

- 1. THE SITE PLAN IS BASED ON EXISTING CONDITIONS INFORMATION PROVIDED BY OTHERS. COPLEY WOLFF DESIGN GROUP IS NOT RESPONSIBLE FOR THE ACCURACY OR COMPLETENESS OF THIS INFORMATION.
- 2. THE CONTRACTOR SHALL VERIFY ALL CONDITIONS IN THE FIELD AND REPORT ANY AND ALL DISCREPANCIES TO THE OWNER'S REPRESENTATIVE. ANY ALTERATIONS TO THESE DRAWINGS MADE IN THE FIELD SHALL BE PROMPTLY REPORTED BY THE CONTRACTOR TO THE OWNER'S REPRESENTATIVE AND RECORDED ON RECORD
- 2. CONSULT ALL DRAWINGS AND SPECIFICATIONS FOR COORDINATION REQUIREMENTS BETWEEN ALL TRADES
- PRIOR TO COMMENCING NEW CONSTRUCTION. 3. THE CONTRACTOR SHALL NOTIFY OWNER'S REPRESENTATIVE IMMEDIATELY OF ANY AND ALL CONFLICTS
- BETWEEN PROPOSED SITE WORK AND WORK OF ALL OTHER TRADES. 4. THE CONTRACTOR SHALL BE RESPONSIBLE FOR DAMAGE INSIDE AND OUTSIDE THE LIMIT OF WORK LINE DUE TO
- CONTRACT OPERATIONS. CONTRACTOR SHALL RESTORE DAMAGED AREAS BEYOND CONTRACT LIMITS TO THEIR ORIGINAL CONDITION AT NO ADDITIONAL COST TO THE OWNER. THE CONTRACTOR SHALL CONTACT THE PROPER AUTHORITIES IN WRITING TO CONFIRM THE LOCATIONS OF ALL
- EXISTING UTILITIES BEFORE COMMENCING WORK. ANY DAMAGE DUE TO THE FAILURE OF THE CONTRACTOR TO CONTACT AUTHORITIES SHALL BE BORNE BY THE CONTRACTOR. THE CONTRACTOR SHALL REPAIR ANY DAMAGE INCURRED DURING CONSTRUCTION TO EXISTING UTILITIES SCHEDULED TO REMAIN AT NO COST TO THE OWNER.
- 6. EXISTING STRUCTURES, IMPROVEMENTS, APPURTANCES AND VEGETATION TO REMAIN SHALL BE PROTECTED FROM DAMAGE. ANY DAMAGE TO EXISTING SITE IMPROVEMENTS TO REMAIN SHALL BE REPAIRED AT NO COST TO
- 7. THE CONTRACTOR SHALL COMPLY WITH ALL REQUIREMENTS OF PERMITS AND LICENSES ISSUED BY COGNIZANT FEDERAL, STATE, AND LOCAL AGENCIES.
- 8. THE CONTRACTOR SHALL COORDINATE ALL SITE UTILITY IMPROVEMENTS WITH PROPER AUTHORITIES. 9. ALL LINES AND DIMENSIONS ARE PARALLEL OR PERPENDICULAR TO THE LINES FROM WHICH THEY ARE
- MEASURED UNLESS OTHERWISE INDICATED. 10. THE CONTRACTOR SHALL BE RESPONSIBLE FOR ESTABLISHING ALL LINES, GRADES, AND OTHER SURVEY CONTROL TO COMPLETE THE WORK. THE CONTRACTOR SHALL BE RESPONSIBLE FOR THE MAINTENANCE AND PROTECTION OF THE SURVEY CONTROL REFERENCE POINTS AND LOCATION STAKES. THE CONTRACTOR SHALL EMPLOY A MASSACHUSETTS-LICENSED REGISTERED LAND SURVEYOR OR REGISTERED CIVIL ENGINEER,
- FAMILIAR WITH BUILDING CONSTRUCTION, WHO SHALL ESTABLISH LINES AND LEVELS. THE CONTRACTOR SHALL BE RESPONSIBLE FOR THE CORRECT LOCATION OF THE PROPOSED SITE FEATURES. 11. DIMENSIONS ARE APPROXIMATE BASED ON TAKE OFF FROM SURVEY. ACTUAL DIMENSIONS MAY VARY. NOTIFY
- 12. THE CONTRACTOR TO STAKE OUT LAYOUT FOR APPROVAL PRIOR TO EXCAVATION. 13. THE CONTRACTOR SHALL PREPARE SAMPLE PANELS FOR EACH PAVING TYPE FOR APPROVAL OF WORKMANSHIP, FINISHES, COLORS, AND JOINTING PRIOR TO FINAL INSTALLATION. 14. SEE LANDSCAPE ARCHITECTURAL PLANS FOR LAYOUT OF MATERIALS AND SITE IMPROVEMENTS AND SEE CIVIL
- DRAWINGS FOR GRADING, DRAINAGE, UTILITIES, AND PARKING AND CURB LAYOUT.

THE OWNER'S REPRESENTATIVE IN THE EVENT OF DIMENSIONAL DISCREPANCIES.

15. LANDSCAPE LAYOUT DRAWINGS ARE NOT TO BE USED FOR LAYOUT OF THE BUILDING ON THE SITE.

LAYOUT LEGEND

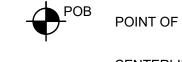


CENTERLINE FOR LAYOUT

5'-0" RADIUS


CENTER LINE OF OBJECT

VERIFY DIMENSION IN FIELD

ALIGN EDGES OR FACES

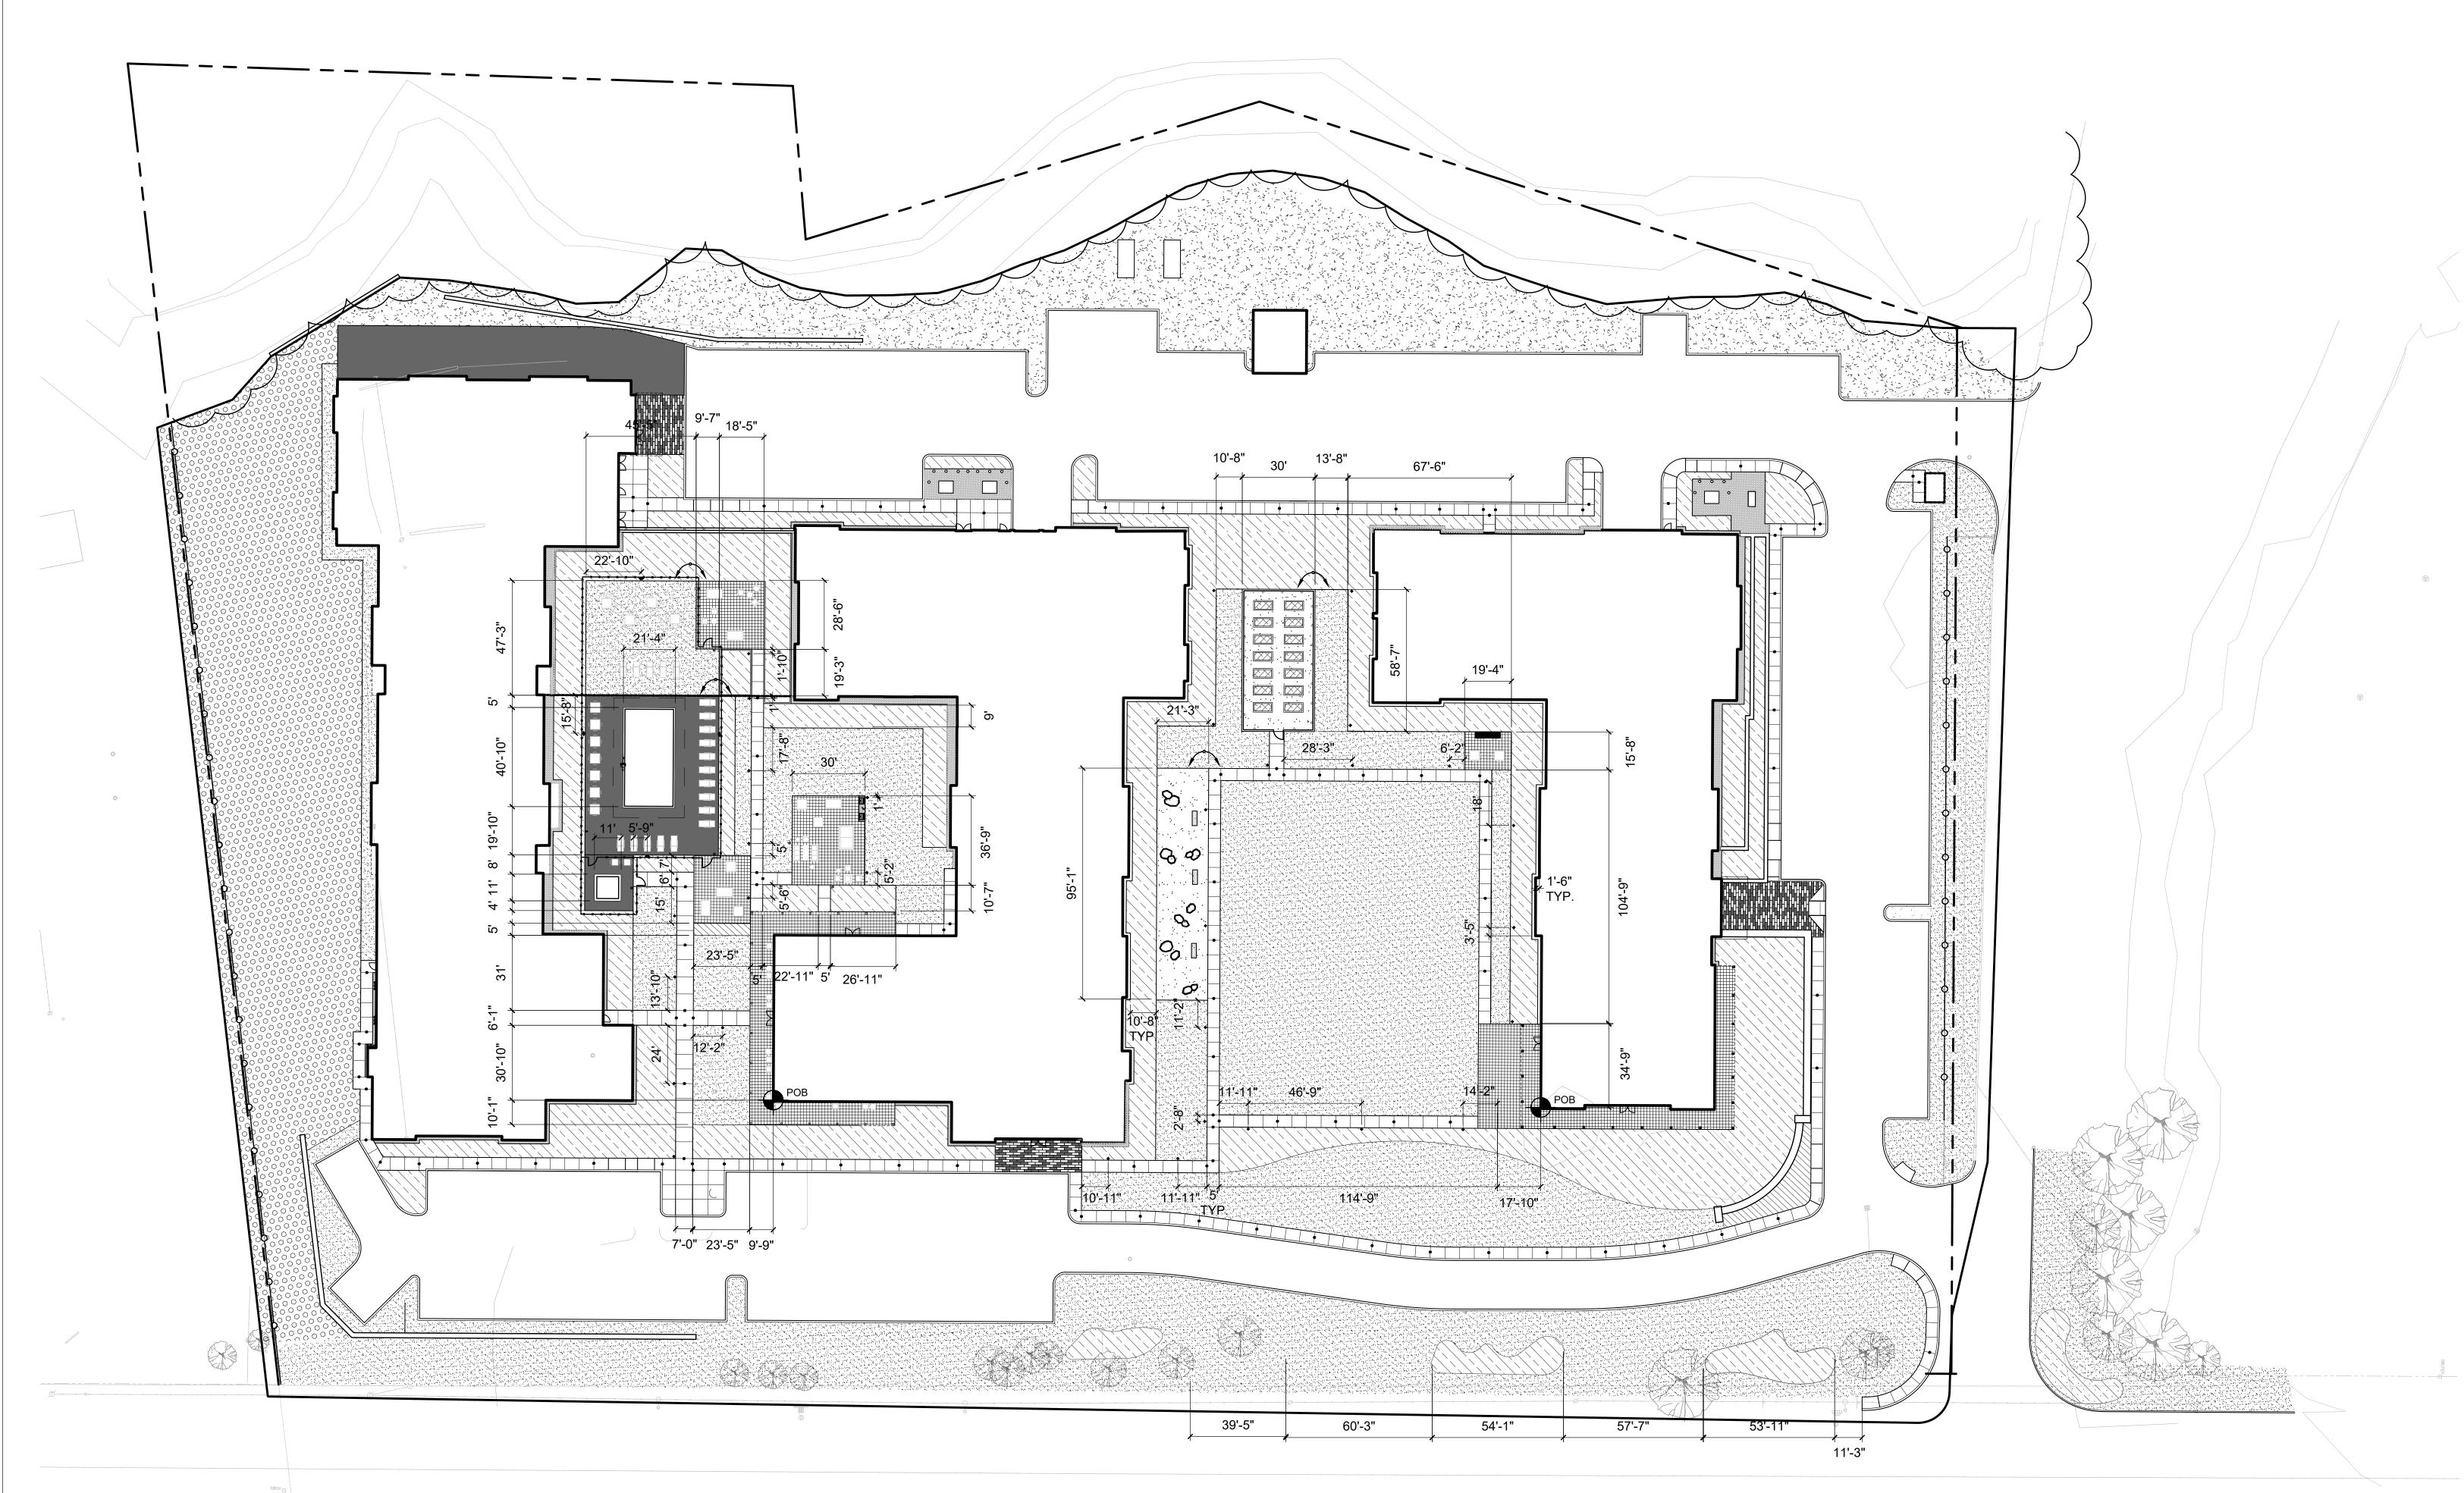

ROUTE 20 (BOSTON POST ROAD)

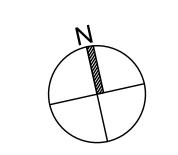

50 Commandant's Way at Admiral's Hill Ohelsea MA F 617.889.4402 617.884.4329 architecturalteam.com

| Consu | Itant: |
|-------|--------|
|-------|--------|

| С | W |
|---|---|
| D | G |

Copley Wolff Design Group Landscape Architects & Planners

Revision:

Architect of Record:




Drawn: SAS

Checked: AA

Scale: 1" = 30'-0"

Key Plan:

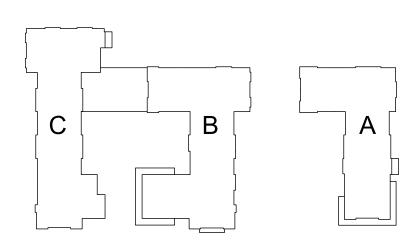

Project Name:

ALTA AT RIVER'S **EDGE**

490, 492, 494 BOSTON POST RD WAYLAND, MA 01778

Sheet Name:

Layout Plan

Project Number:


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Issue Date:

SEPTEMBER 23, 2020


Sheet Number:

L 1.02

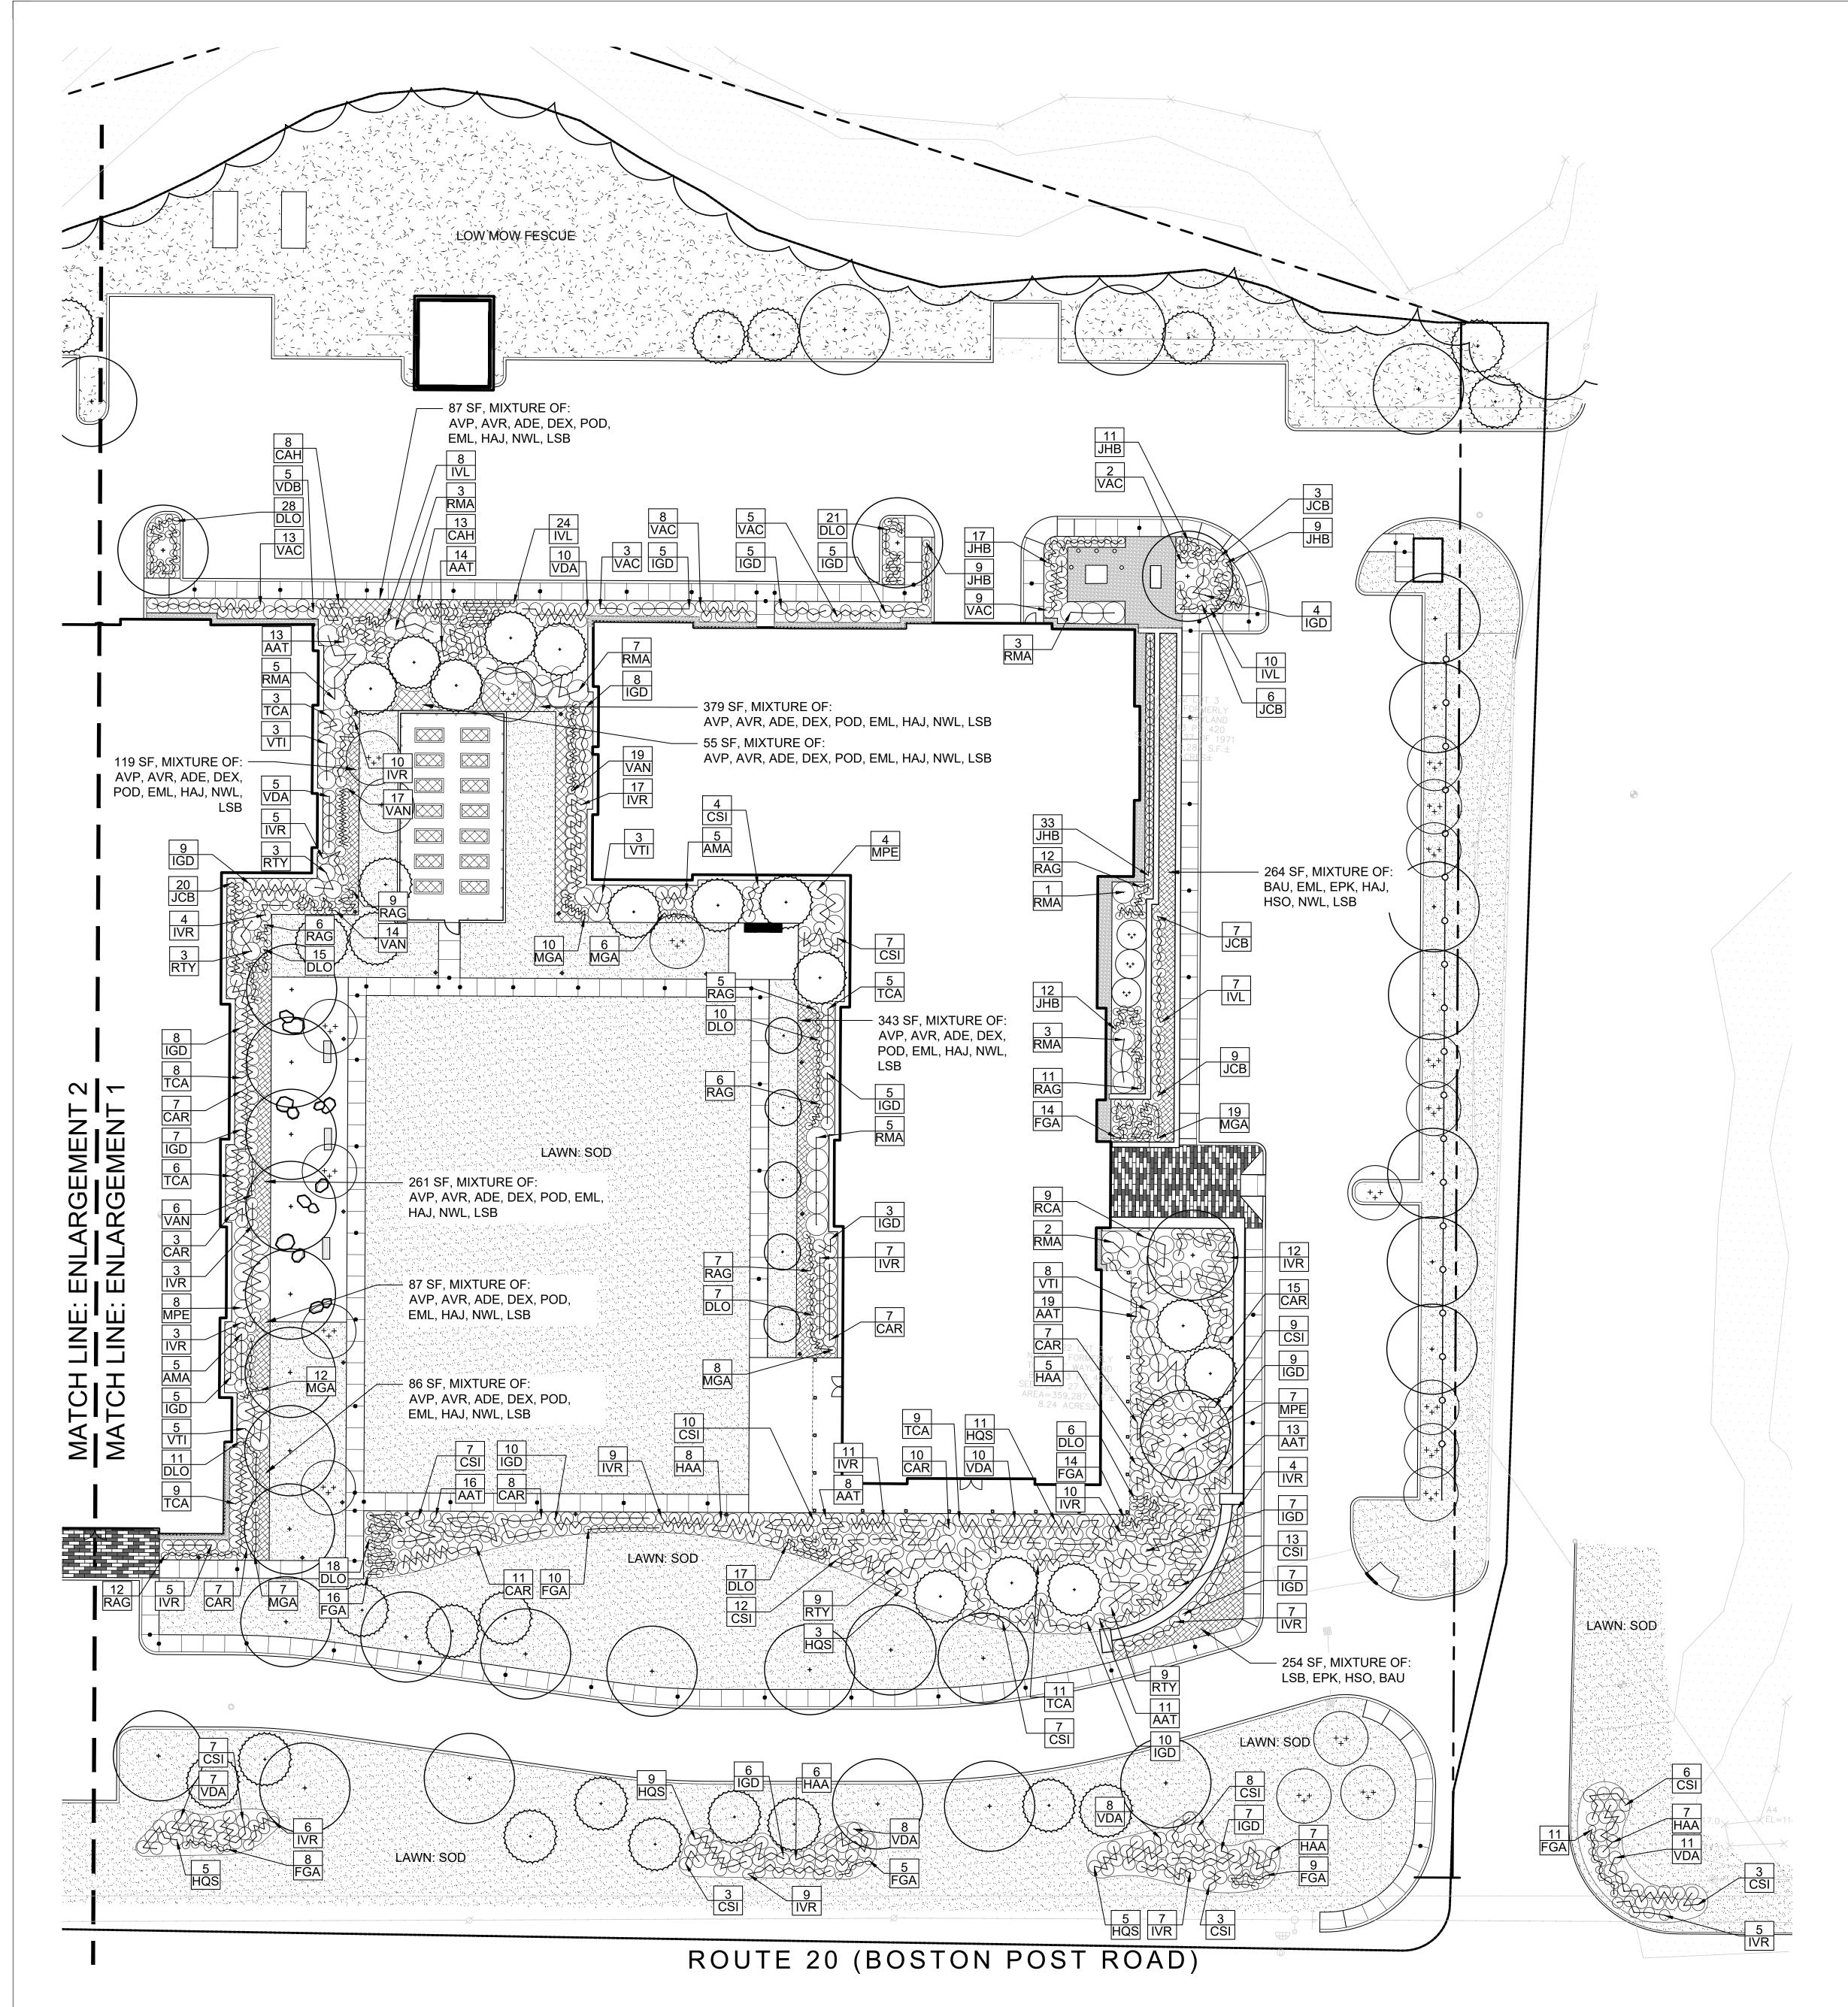

PLANT LIST: ENLARGEMENT 1

| Symbol | Qty | Botanical Name | Common Name | Size | Root Size | Comments |
|----------|---------|---|----------------------------------|-------------|-----------|----------|
| rubs and | d Grour | ndcover | | | | |
| AAT | 94 | Azalea atlanticum | Coastal Azalea | 36-42" ht. | #3 Cont. | |
| AMA | 10 | Aronia melanocarpa 'Autumn Magic' | Autumn Magic Black Chokeberry | 30-42" ht. | #3 Cont. | |
| CAH | 17 | Clethra alnifolia 'Hummingbird' | Hummingbird Sweet Pepperbush | 24-30" ht. | #3 Cont. | |
| CAR | 75 | Clethra alnifolia 'Ruby Spice' | Ruby Spice Sweet Pepperbush | 30-36" ht. | #3 Cont. | |
| CSI | 120 | Cornus sericea "Isanti" | Red Twig Dogwood | 36-42" ht. | #3 Cont. | |
| DLO | 189 | Diervilla lonicera | Northern Bush Honeysuckle | 18-24" ht. | #2 Cont. | |
| FGA | 87 | Fothergilla gardenii 'Appalachia' | Appalachia Dwarf Fothergilla | 24-36" ht. | #3 Cont. | |
| HAA | 33 | Hydrangea arborescens 'Annabelle' | Annabelle Smooth Hydrangea | 24-30" ht. | #3 Cont. | |
| HQS | 33 | Hydrangea quercifolia 'Snow Queen' | Snow Queen Oak Leaf Hydrangea | 30-42" ht. | #3 Cont. | |
| IGD | 121 | Ilex glabra 'Densa' | Dense Inkberry | 36-42" ht. | #3 Cont. | |
| IVL | 44 | Itea virginiana 'Little Henry' | Little Henry Virginia Sweetspire | 18-24" spd. | #2 Cont. | |
| IVR | 133 | Ilex verticillata 'Red Sprite' | Red Sprite Winterberry | 24-32" ht. | #3 Cont. | |
| JCB | 71 | Juniperus communis 'Berkshire' | Berkshire Common Juniper | 24-36" spd. | #3 Cont. | |
| ЈНВ | 79 | Juniperus horizontalis 'Bar Harbor' | Bar Harbor Creeping Juniper | 24-36" spd. | #3 Cont. | |
| MGA | 62 | Myrica gale | Sweetgale | 18-24" spd. | #2 Cont. | |
| MPE | 22 | Myrica pensylvanica | Northern Bayberry | 36-48" ht. | #5 Cont. | |
| RAG | 68 | Rhus aromatica 'Gro Low' | Grow Low Fragrant Sum ac | 18-24" spd. | #2 Cont. | |
| RCA | 9 | Rhododendron catawbinse 'Album' | Catawaba Rhododendron | 18-24" ht. | #3 Cont. | |
| RMA | 29 | Rhododendron maximum | Great Laurel | 48-52" ht. | #5 Cont. | |
| RTY | 24 | Rhus typhina | Staghorn Sumac | 42-52" ht. | #5 Cont. | |
| TCA | 51 | Taxus canadensis | Canada Yew | 30-42" ht. | #3 Cont. | |
| VAC | 40 | Viburnum acerifolium | Maple Leaf Viburnum | 30-42" ht. | #3 Cont. | |
| VAN | 85 | Vaccinum angustifolium | Low Bush Blueberry | 18-24" spd. | #2 Cont. | |
| VDA | 84 | Viburnum dentatum 'Autumn Jazz' | Autumn Jazz Arrowwood | 36-48" ht. | #3 Cont. | |
| VDB | 5 | Viburnum dentatum 'Blue Muffin' | Blue Muffin Arrowwood | 30-42" ht. | #3 Cont. | |
| VTI | 19 | Vib urnum trilob um | American Cranberrybush | 42-42" ht. | #5 Cont. | |
| rennials | / Orna | mental Grasses / Vines | • | | | |
| ADE | 208 | Astilbe chinensis 'Deutschland' | Deutschland Astibe | #1 Cont. | | |
| AVP | 208 | Astilbe 'Visions in Pink' | Visions in Pink Astilbe | #1 Cont. | | |
| AVR | 208 | Astilbe 'Visions in Red' | Visions in Red Astilbe | #1 Cont. | | |
| BAU | 117 | Baptisia australis | Blue False Indigo | #1 Cont. | | |
| DEX | 208 | Dicentra eximia | Fringed Bleeding Heart | #1 Cont. | | |
| EML | 252 | Eupatorium dubium 'Little Joe' | Little Joe Pye Weed | #1 Cont. | | |
| EPK | 117 | Echinacea purpurea 'Kim's Knee High' | Kims Knee High Pruple Coneflower | #1 Cont. | | |
| HAJ | 252 | Hylotelephium 'Herbstfreude' Autumn Joy | Autumn Joy Stonecrop | #1 Cont. | | |
| HSO | 117 | Hemerocallis 'Stella D'Oro' | Stella D'Oro Daylily | #1 Cont. | | |
| LSB | 325 | Leucanthemum x superbum 'Becky' | Becky Shasta Daisy | #1 Cont. | | |
| NWL | 252 | Nepeta x faassenii 'Walkers Low' | Walkers Low Catmint | #1 Cont. | | |
| POD | 208 | Polygonatum odoratum | Solomon's Seal | #1 Cont. | | |

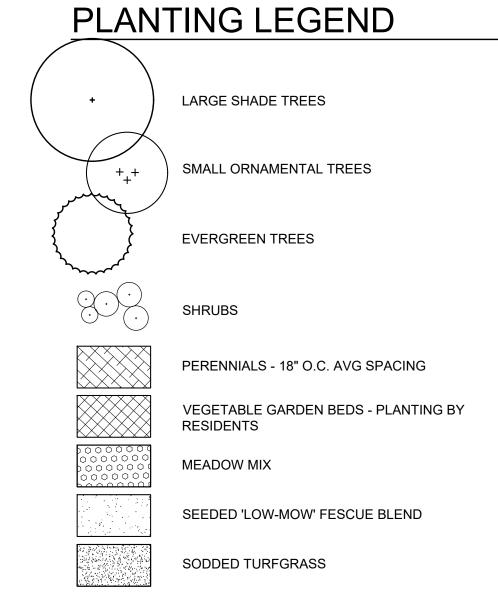

NOTES:

SCALE: 1"=20'

- See sheet L-2.00 for general planting notes.
- Perennial plant selection is schematic for pricing and species and quantity are subject to change.



50 Commandant's Way at Admiral's Hill Ohelsea MA 02150 F 617.889.4402 617.884.4329 architecturalteam.com

Consultant:



Copley Wolff Design Group Landscape Architects & Planners


Revision:

Architect of Record:



Drawn: SAS Checked: AA Scale: 1" = 20'-0"

Key Plan:

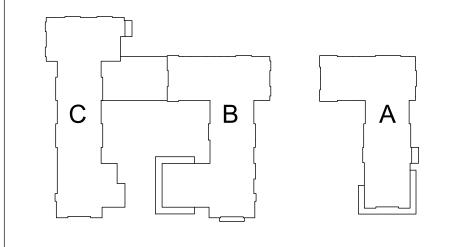

Project Name:

ALTA AT RIVER'S **EDGE**

490, 492, 494 BOSTON POST RD WAYLAND, MA 01778

Sheet Name:

Planting Plan: Enlargement 1

Project Number:


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Issue Date:

SEPTEMBER 23, 2020


Sheet Number:

L 2.01

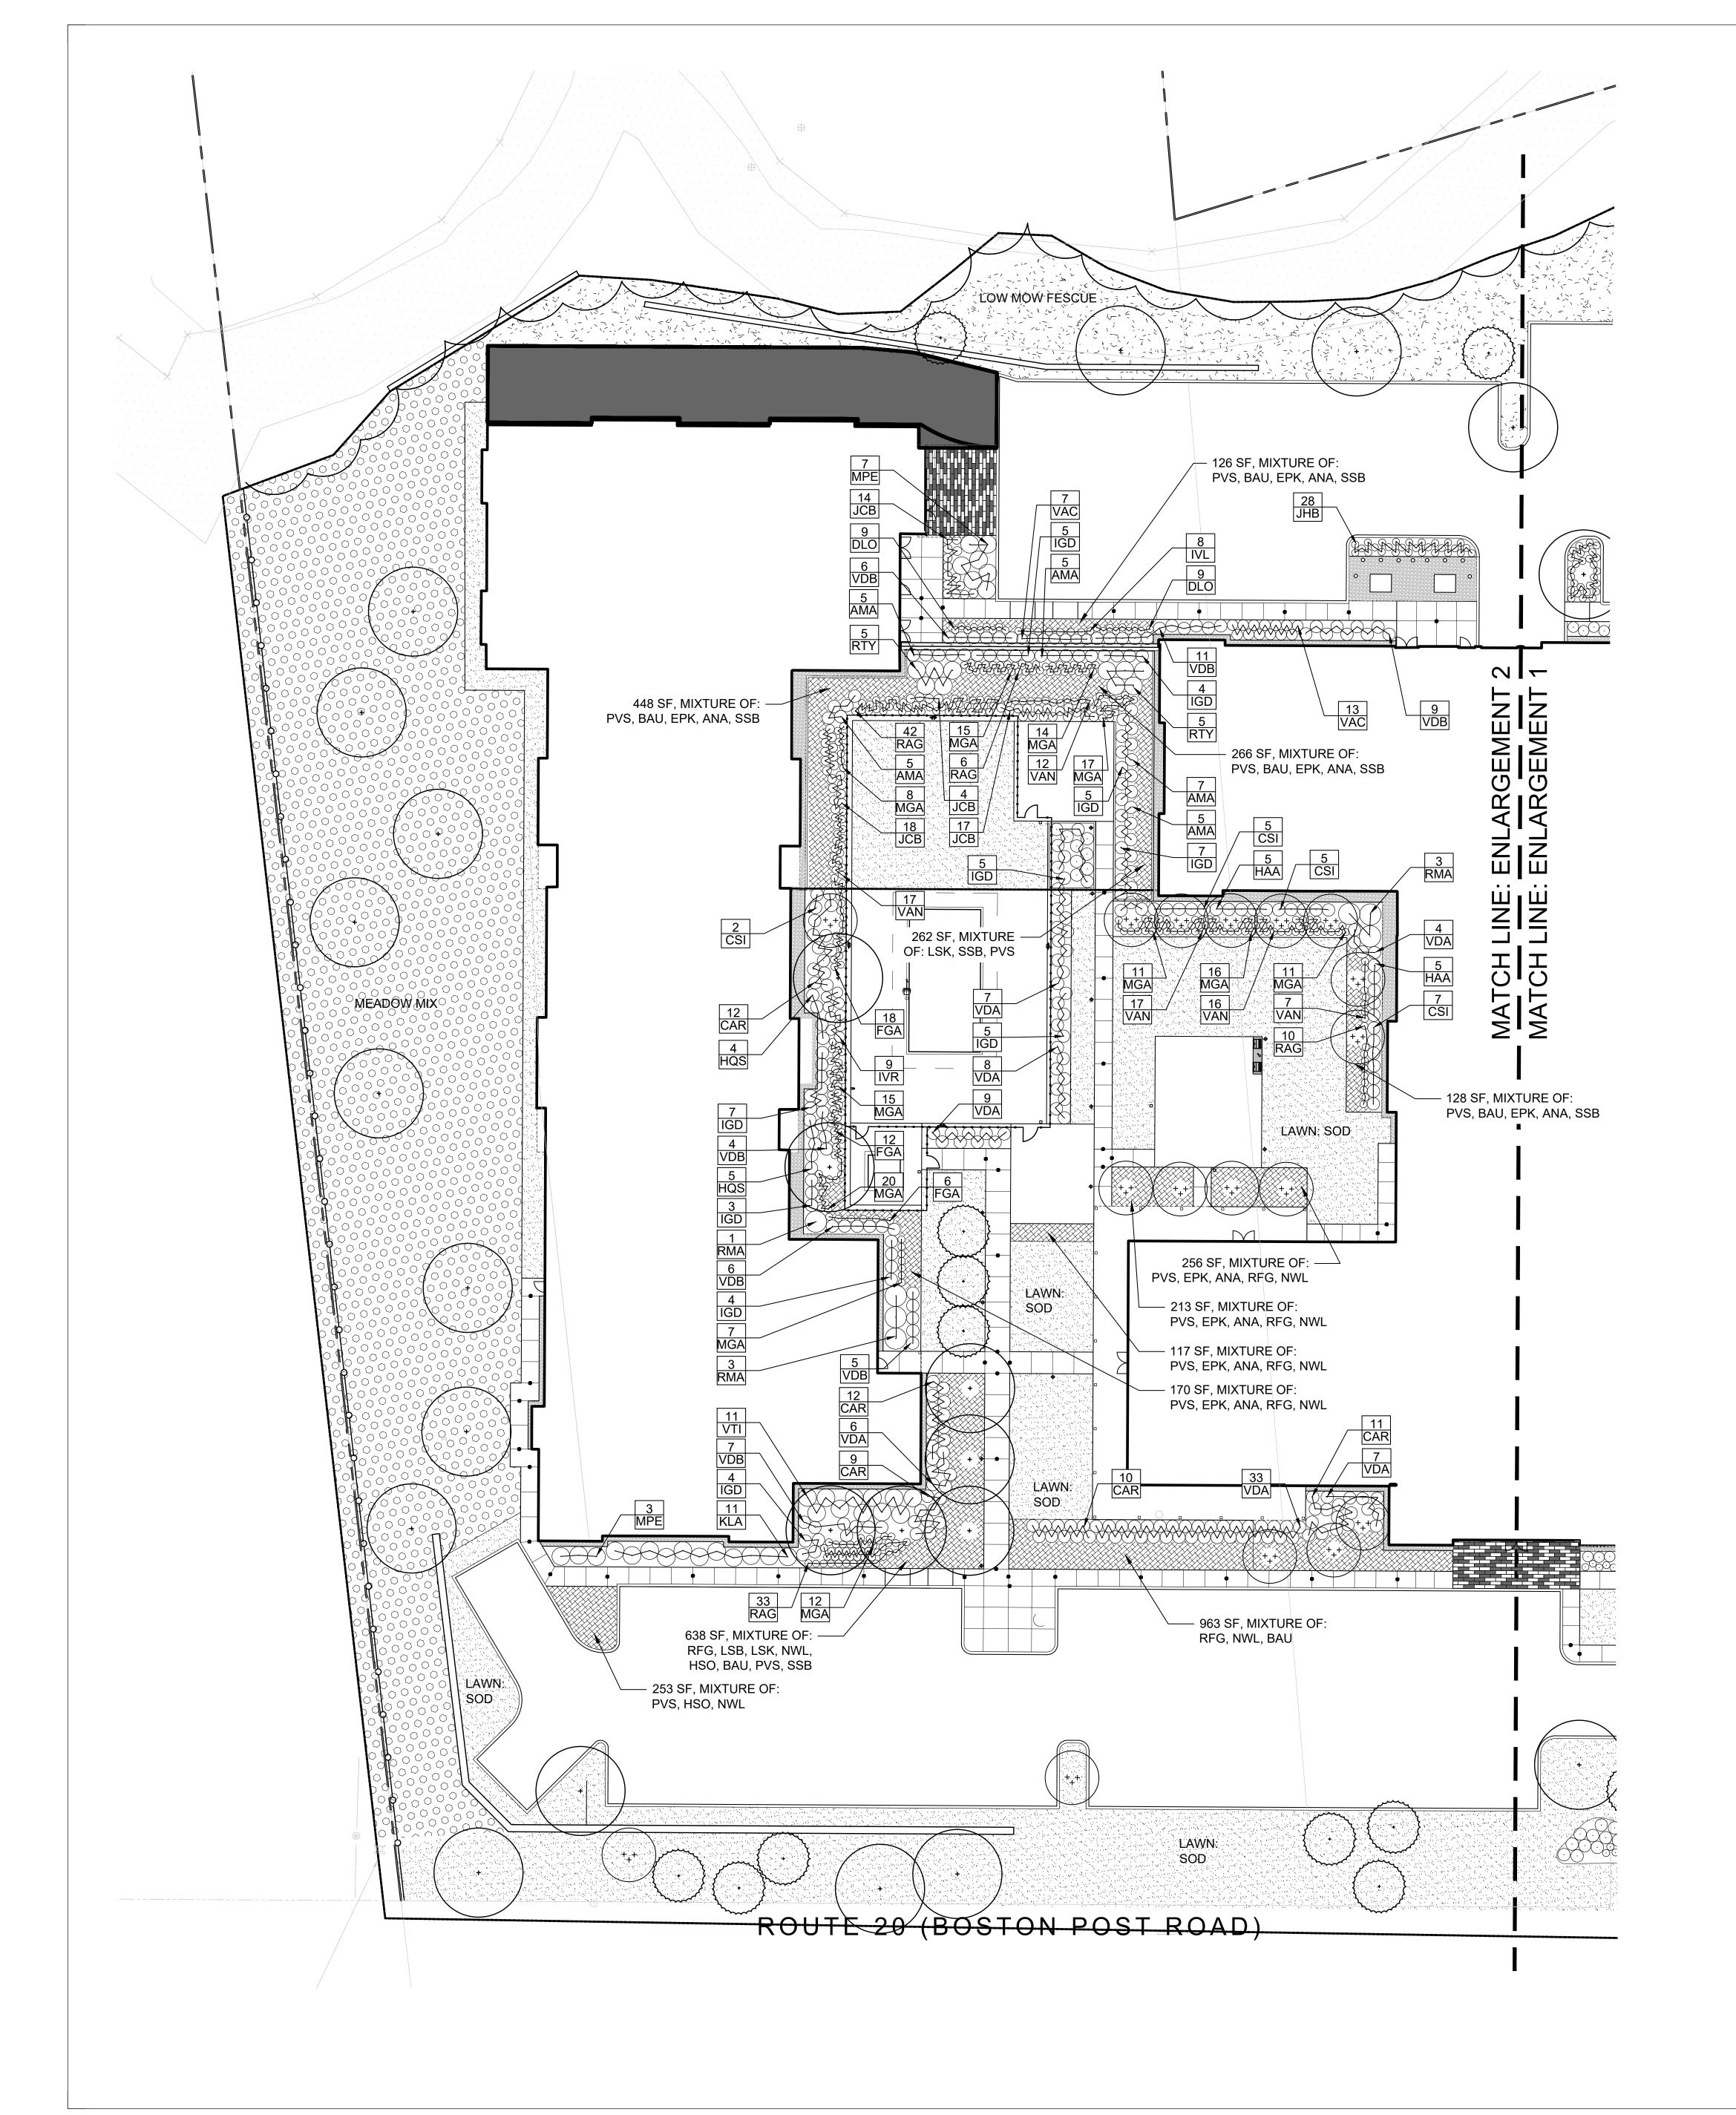

PLANT LIST: ENLARGEMENT 2

| Symbol | Qty | Botanical Name | Common Name | Size | Root Size | Comment |
|-----------|--------|--------------------------------------|----------------------------------|-------------|-----------|---------|
| nrubs and | d Grou | ndcover | | | | |
| AMA | 27 | Aronia melanocarpa 'Autumn Magic' | Autumn Magic Black Chokeberry | 30-42" ht. | #3 Cont. | |
| CAR | 54 | Clethra alnifolia 'Ruby Spice' | Ruby Spice Sweet Pepperbush | 30-36" ht. | #3 Cont. | |
| CSI | 19 | Cornus sericea 'Isanti' | Red Twig Dogwood | 36-42" ht. | #3 Cont. | |
| DLO | 18 | Diervilla lonicera | Northern Bush Honeysuckle | 18-24" ht. | #2 Cont. | |
| FGA | 36 | Fothergilla gardenii 'Appalachia' | Appalachia Dwarf Fothergilla | 24-36" ht. | #3 Cont. | |
| HAA | 13 | Hydrangea arborescens 'Annabelle' | Annabelle Smooth Hydrangea | 24-30" ht. | #3 Cont. | |
| HQS | 9 | Hydrangea quercifolia 'Snow Queen' | Snow Queen Oak Leaf Hydrangea | 30-42" ht. | #3 Cont. | |
| IGD | 59 | Ilex glabra 'Densa' | Dense Inkberry | 36-42" ht. | #3 Cont. | |
| IVL | 8 | Itea virginiana 'Little Henry' | Little Henry Virginia Sweetspire | 18-24" spd. | #2 Cont. | |
| IVR | 9 | Ilex verticillata 'Red Sprite' | Red Sprite Winterberry | 24-32" ht. | #3 Cont. | |
| JCB | 53 | Juniperus communis 'Berkshire' | Berkshire Common Juniper | 24-36" spd. | #3 Cont. | |
| JHB | 28 | Juniperus horizontalis 'Bar Harbor' | Bar Harbor Creeping Juniper | 24-36" spd. | #3 Cont. | |
| KLA | 11 | Kalmia latifolia | Mountain Laurel | 36-48" ht. | #5 Cont. | |
| MGA | 147 | Myrica gale | Sweetg <i>a</i> le | 18-24" spd. | #2 Cont. | |
| MPE | 10 | Myrica pensylvanica | Northern Bayberry | 36-48" ht. | #5 Cont. | |
| RAG | 92 | Rhus aromatica 'Gro Low' | Grow Low Fragrant Sum ac | 18-24" spd. | #2 Cont. | |
| RMA | 7 | Rhododendron maximum | Great Laurel | 48-52" ht. | #5 Cont. | |
| RTY | 10 | Rhus typhina | Staghorn Sumac | 42-52" ht. | #5 Cont. | |
| VAC | 20 | Viburnum acerifolium | Maple Leaf Viburnum | 30-42" ht. | #3 Cont. | |
| VAN | 69 | Vaccinum angustifolium | Low Bush Blueberry | 18-24" spd. | #2 Cont. | |
| VDA | 74 | Viburnum dentatum 'Autumn Jazz' | Autumn Jazz Arrowwood | 36-48" ht. | #3 Cont. | |
| VDB | 48 | Viburnum dentatum 'Blue Muffin' | Blue Muffin Arrowwood | 30-42" ht. | #3 Cont. | |
| VTI | 11 | Viburnum trilobum | American Cranberrybush | 42-42" ht. | #5 Cont. | |
| erennials | / Orna | mental Grasses / Vines | | .4 | ···· | |
| ANA | 399 | Aster novae-angliae | New England Aster | #1 Cont. | | |
| BAU | 687 | Baptisia australis | Blue False Indigo | #1 Cont. | | |
| EPK | 399 | Echinacea purpurea 'Kim's Knee High' | Kims Knee High Pruple Coneflower | #1 Cont. | | |
| HSO | 189 | Hemerocallis 'Stella D'Oro' | Stella D'Oro Daylily | #1 Cont. | | |
| LSB | 92 | Leucanthemum x superbum 'Becky' | Becky Shasta Daisy | #1 Cont. | | |
| LSK | 251 | Liatris spicata 'Kobold' | Dense Blazing Star | #1 Cont. | | |
| N₩L | 735 | Nepeta x faassenii 'Walkers Low' | Walkers Low Catmint | #1 Cont. | | |
| PVS | 747 | Panicum vergatum 'Shenandoah' | Shenandoah Switch Grass | #1 Cont. | | |
| RFG | 209 | rudbeckia fulgida 'Goldsturm' | Goldsturm Black-Eyed-Susan | #1 Cont. | | |
| SSB | 904 | Schizachyńum scoparium 'The Blues' | The Blues Little Bluestem | #1 Cont. | | |

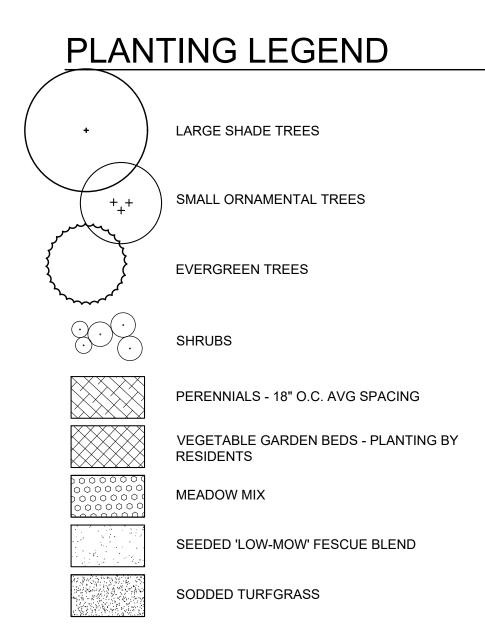

NOTES:

See sheet L-2.00 for general planting notes.

SCALE: 1"=20'

Perennial plant selection is schematic for pricing and species and quantity are subject to change.




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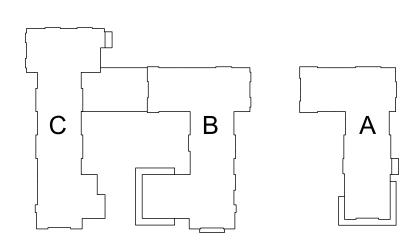
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Scale: 1" = 20'-0" Key Plan:



Project Name:

ALTA AT RIVER'S **EDGE**

490, 492, 494 BOSTON POST RD WAYLAND, MA 01778 Sheet Name:

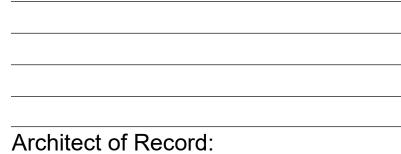Planting Plan: Enlargement 2

Project Number:


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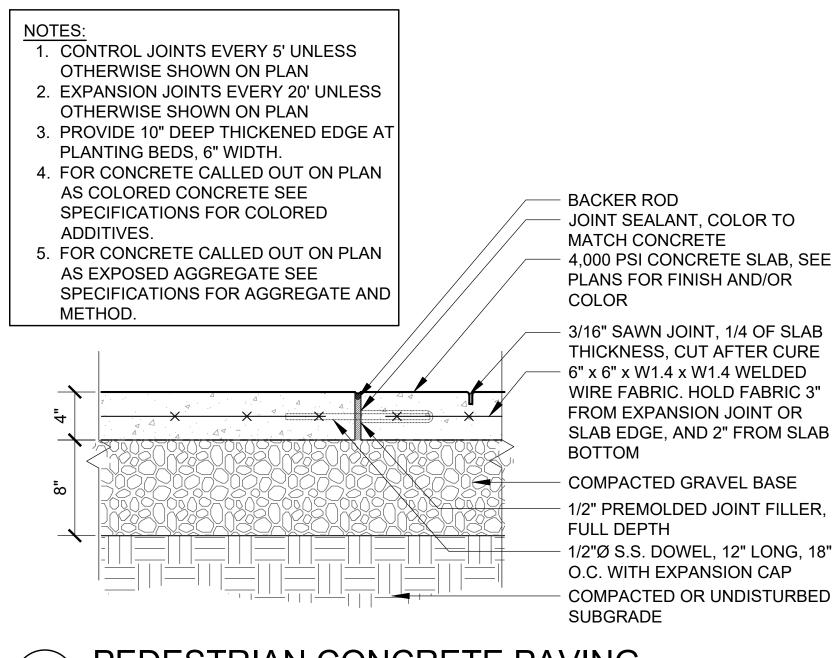
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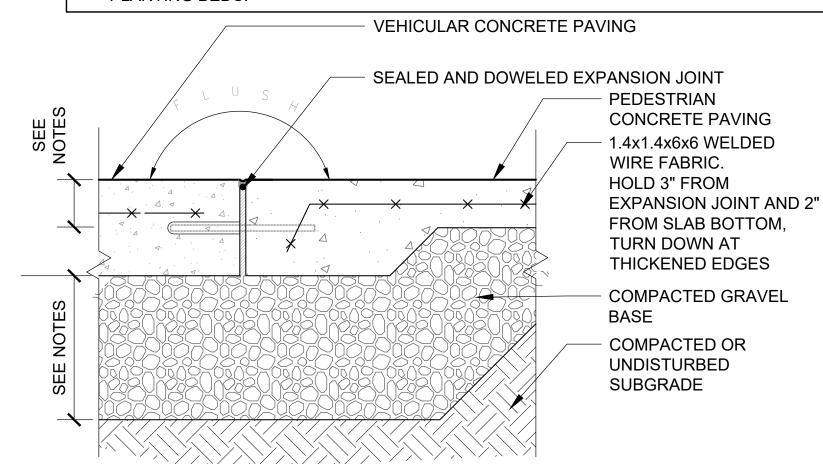


1 PEDESTRIAN CONCRETE PAVING SCALE: 1-1/2" = 1'-0"


NOTES:

1. PEDESTRIAN CONCRETE PAVING IS TO BE 4" THICK WITH AN 8" THICK GRAVEL BASE.


2. PROVIDE 12" DEEP x 8" WIDE THICKENED EDGE AT JOINT WITH BIT. PAVEMENT OR PLANTING BEDS.

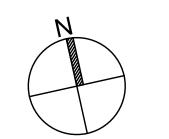

2 JOINT AT CONCRETE PAVING SCALE: 1-1/2" = 1'-0"

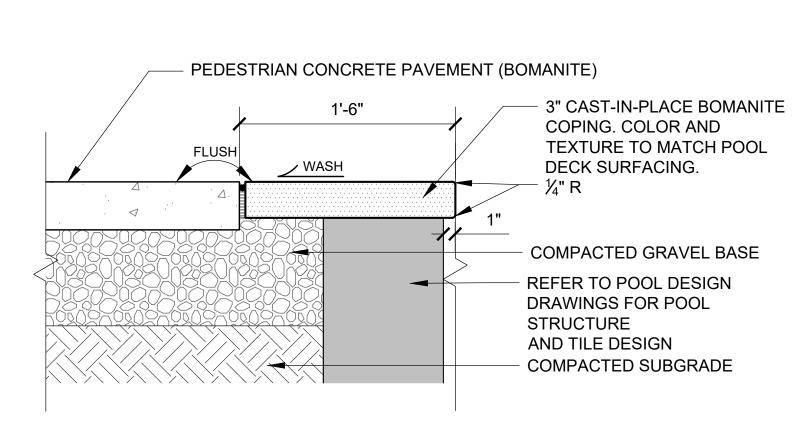


3 TEXTURED CONCRETE AT POOL COPING SCALE: 1-1/2" = 1'-0"

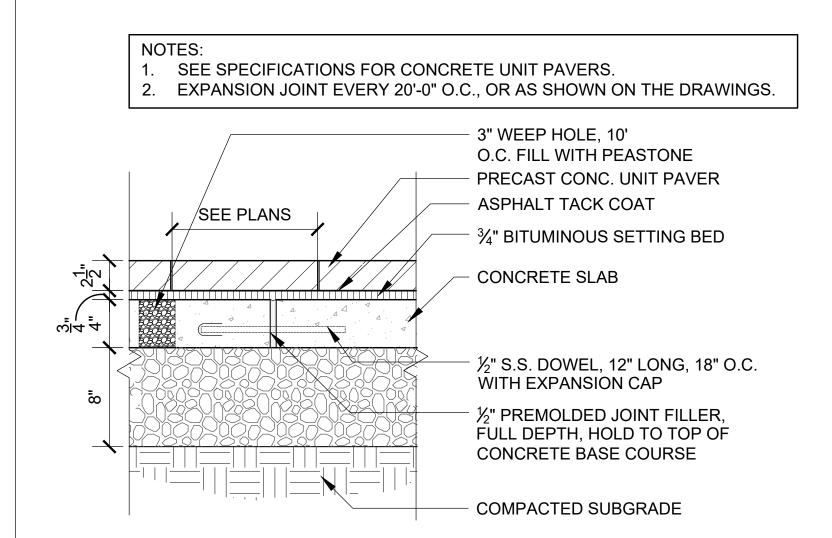


4 CONCRETE UNIT PAVERS

SCALE: 1-1/2" = 1'-0"

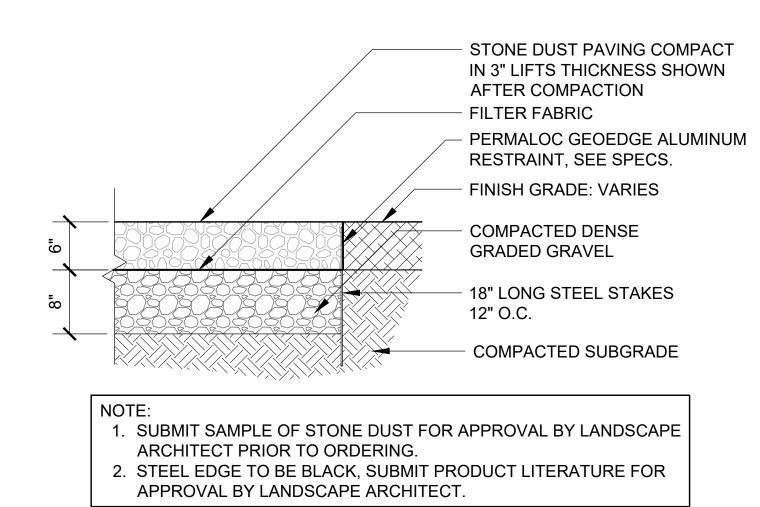


5 STONEDUST PAVING SCALE: 1" = 1'-0"

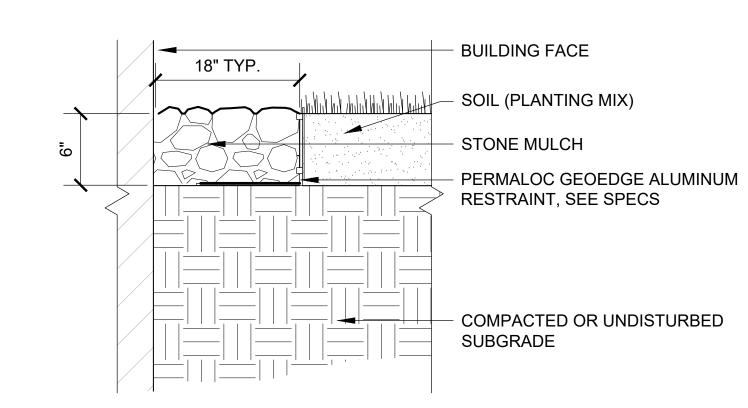


6 STONE MAINTENANCE STRIP

SCALE: 1-1/2" = 1'-0"

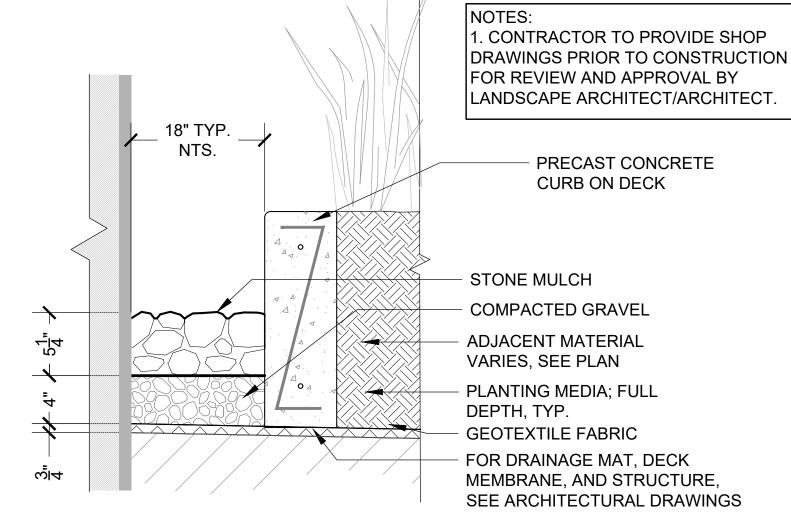



7 STONE MAINTENANCE STRIP OVER STRUCTURE SCALE: 1-1/2" = 1'-0"

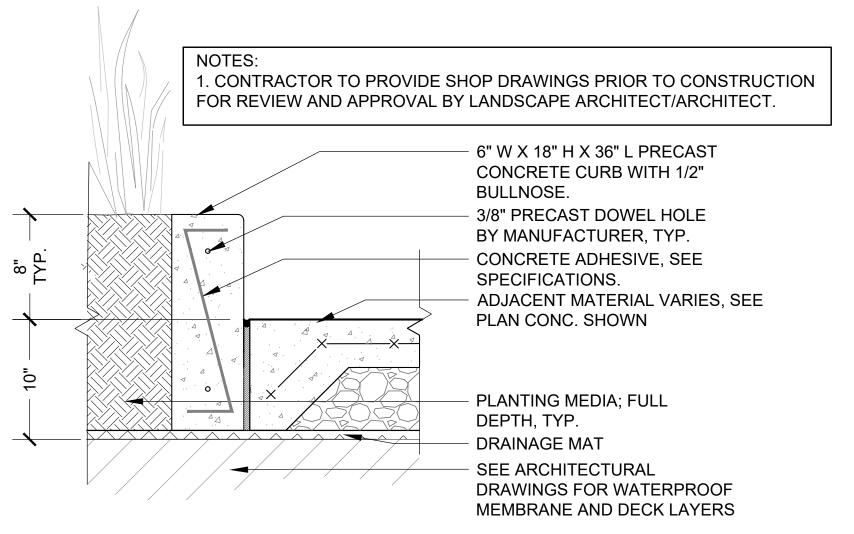


8 PRECAST CONCRETE CURB OVER STRUCTURE


SCALE: 1-1/2" = 1'-0"

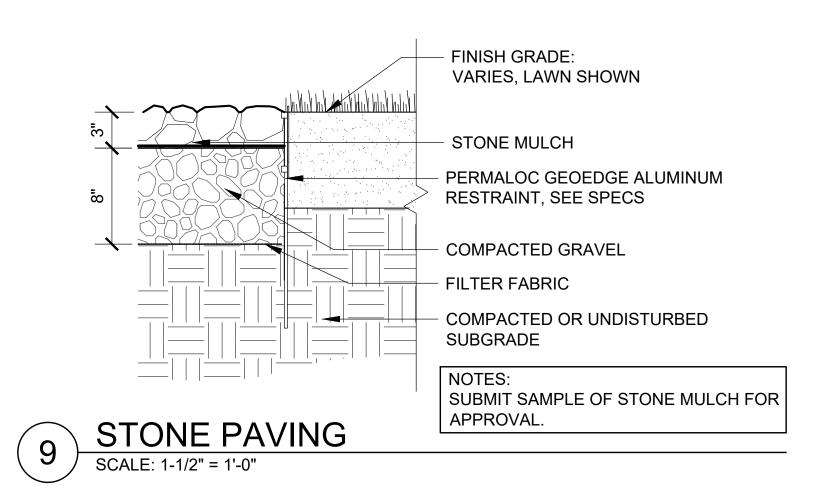

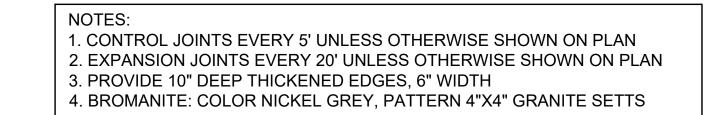


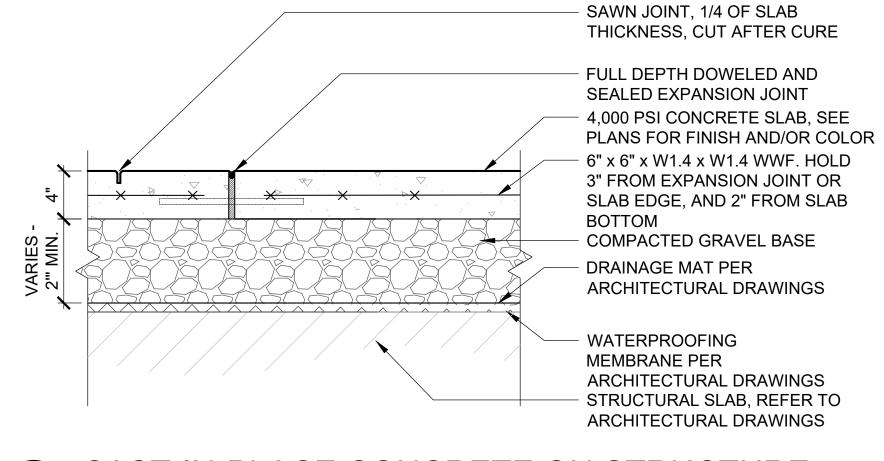

10 CAST-IN-PLACE CONCRETE ON STRUCTURE SCALE: 1-1/2" = 1'-0"

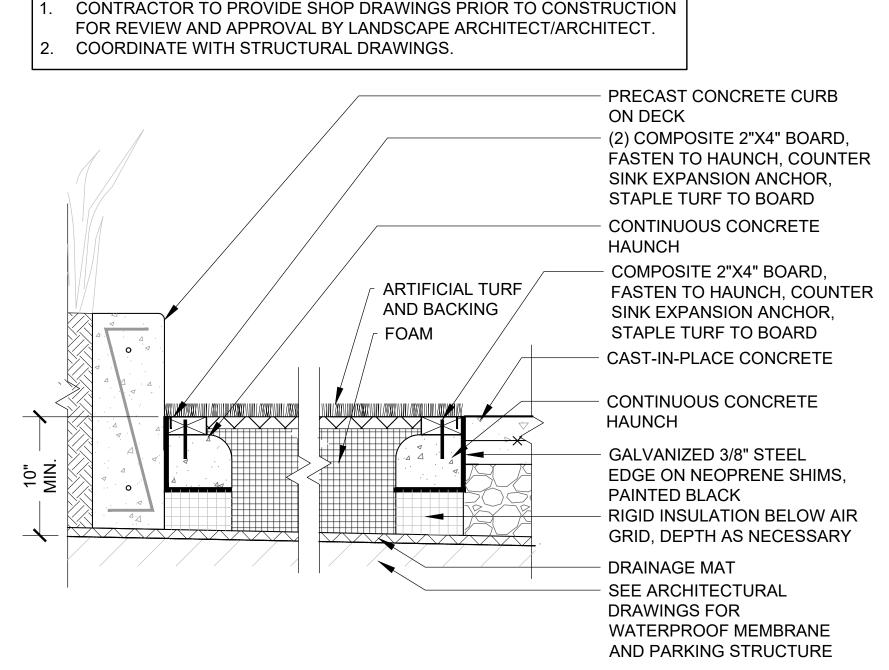

SYNTHETIC TURF OVER STRUCTURE SCALE: 1-1/2" = 1'-0"

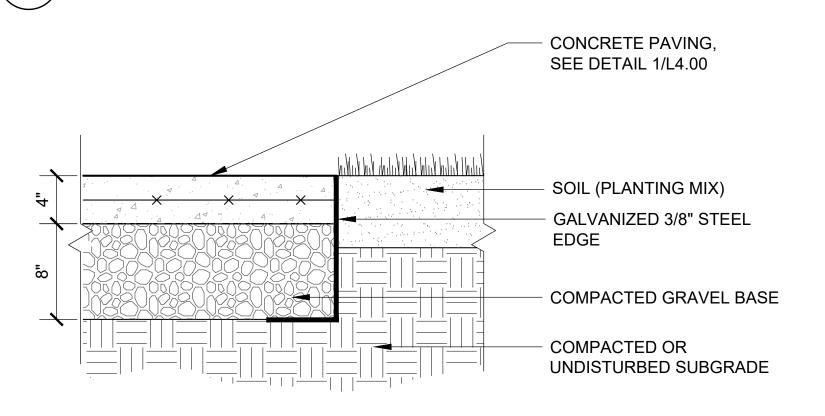


12) CONCRETE PAVING WITH PLANTING EDGE

SCALE: 1-1/2" = 1'-0"


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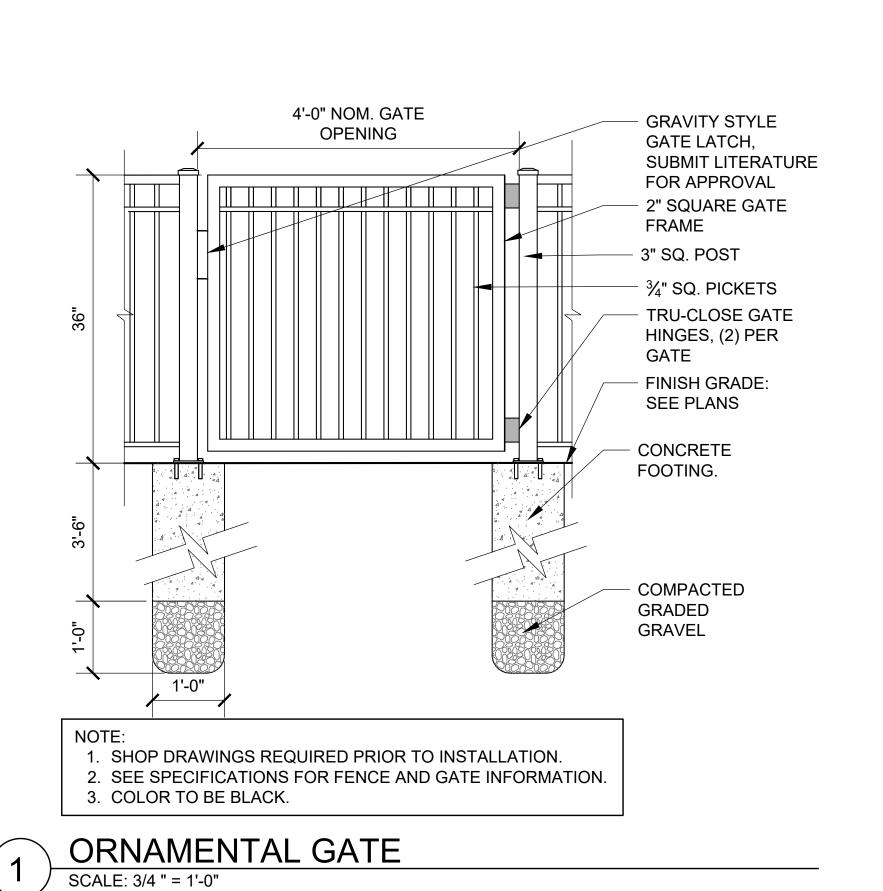
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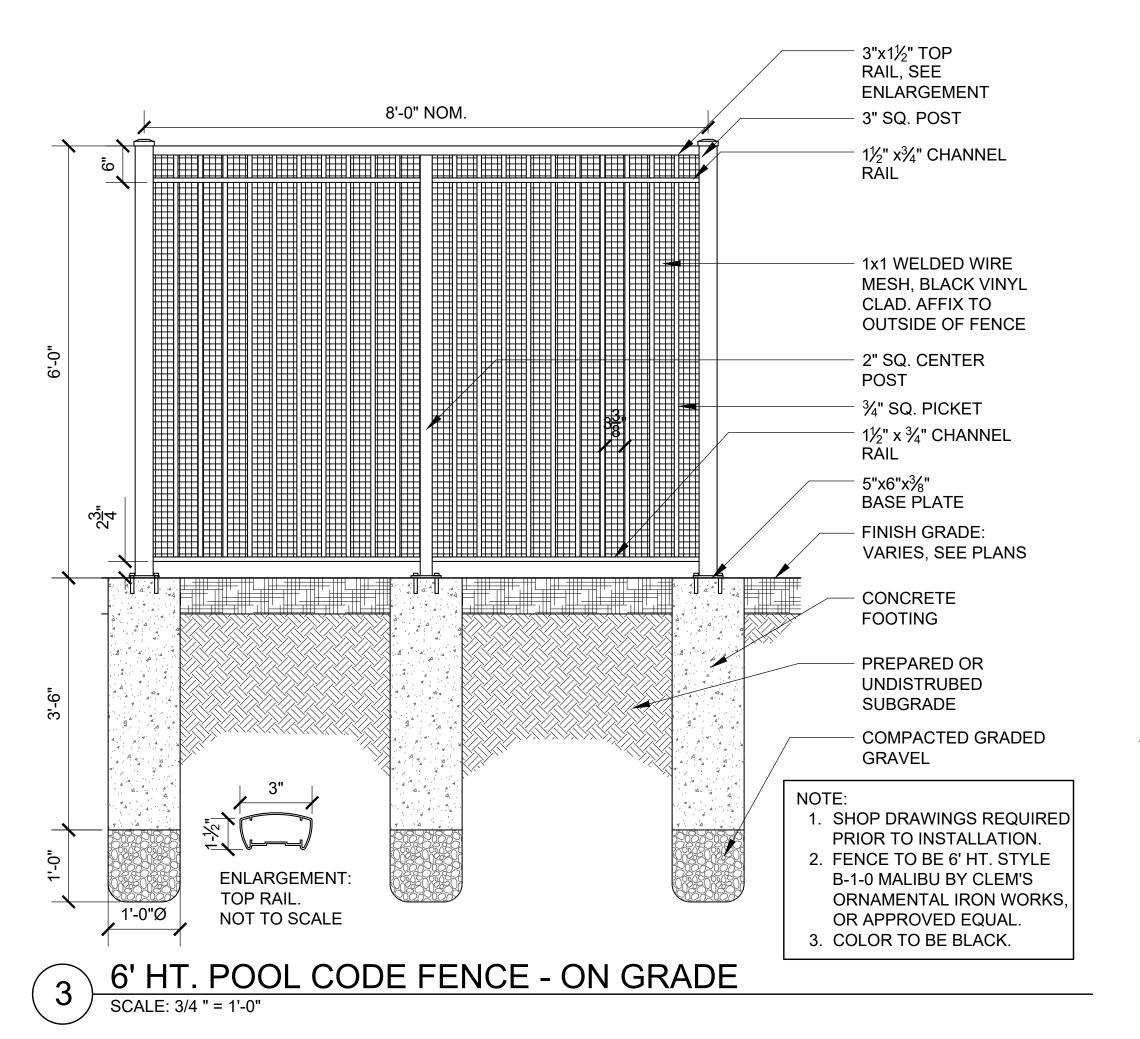
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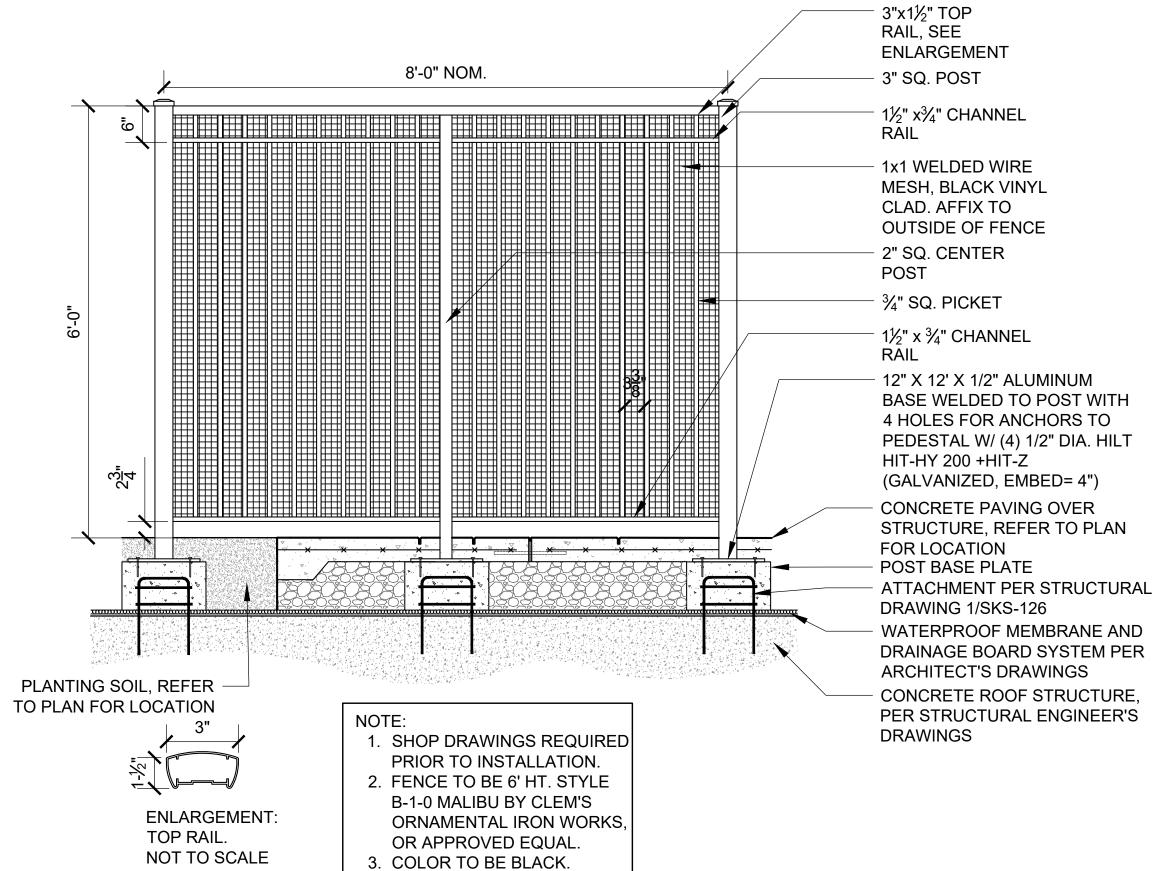
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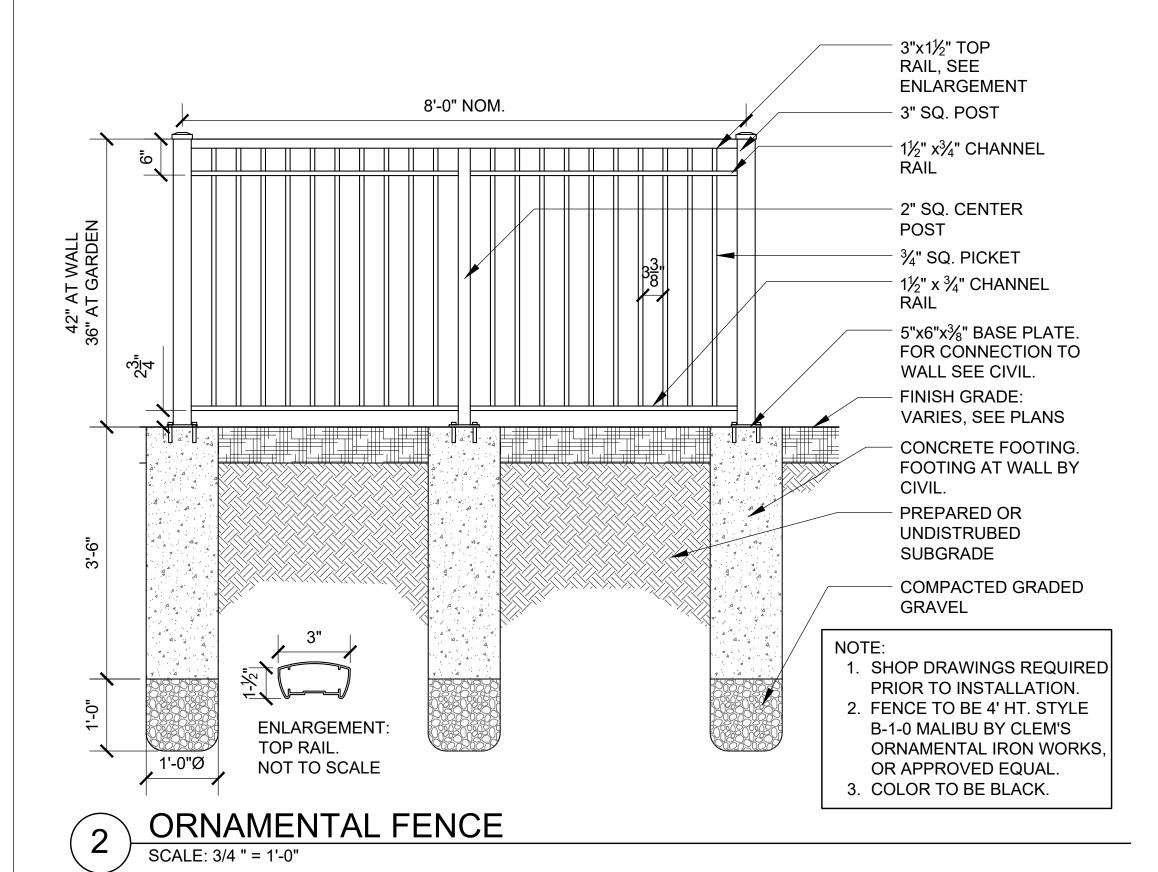





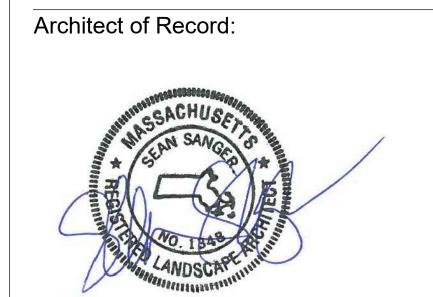

6' HT. POOL CODE FENCE - ON DECK

SCALE: 3/4 " = 1'-0"

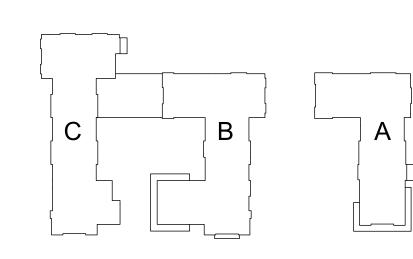

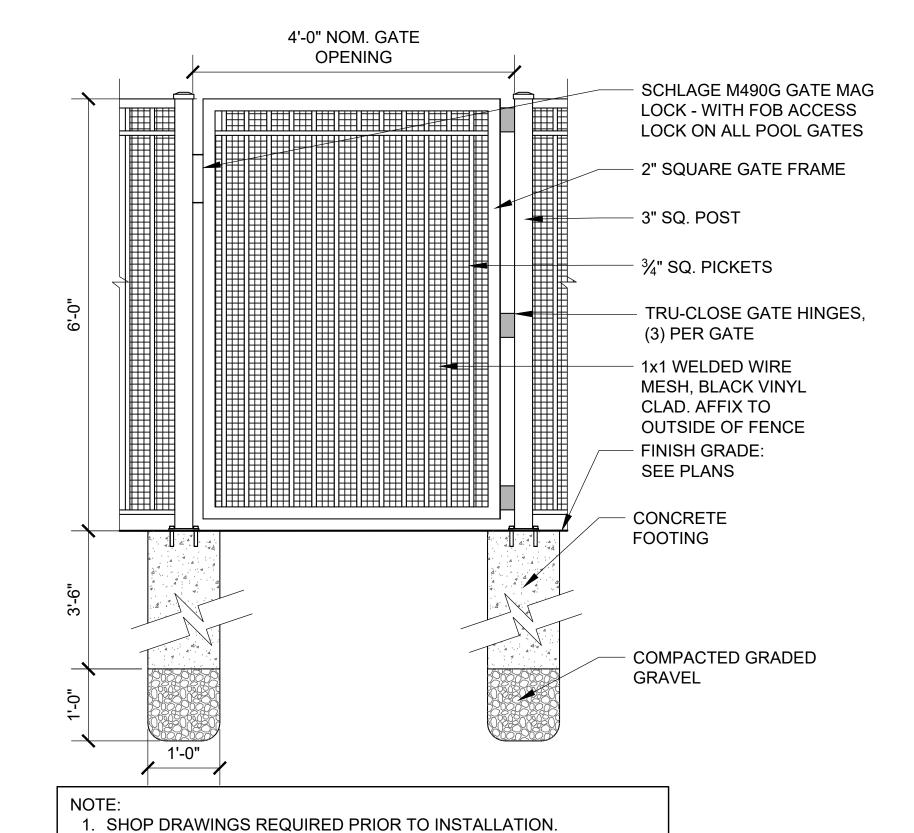

2. PROVIDE "PUSH TO EXIT" BUTTON POST BY SCHLAGE, OR EQUAL)

MOUNTED (INSIDE POOL) SEE PLAN FOR LOCATION.

POOL GATE - ON GRADE

4. COLOR TO BE BLACK.

SCALE: 3/4 " = 1'-0"

3. SEE SPECIFICATIONS FOR FENCE AND GATE INFORMATION.

4'-0" NOM. GATE OPENING SCHLAGE M490G GATE MAG LOCK - WITH FOB ACCESS LOCK ON ALL POOL GATES 2" SQUARE GATE FRAME 3" SQ. POST 3/4" SQ. PICKETS - 1x1 WELDED WIRE MESH, BLACK VINYL CLAD. AFFIX TO OUTSIDE OF FENCE TRU-CLOSE GATE HINGES, (3) PER GATE 12" X 12' X 1/2" ALUMINUM BASE WELDED TO POST WITH 4 HOLES FOR ANCHORS TO PEDESTAL W/ (4) 1/2" DIA. HILT HIT-HY 200 +HIT-Z (GALVANIZED, EMBED= 4") CONCRETE PAVING OVER STRUCTURE, REFER TO PLAN FOR LOCATION POST BASE PLATE ATTACHMENT PER STRUCTURAL DRAWING 1/SKS-126 WATERPROOF MEMBRANE AND DRAINAGE BOARD SYSTEM PER ARCHITECT'S DRAWINGS CONCRETE ROOF STRUCTURE, PER STRUCTURAL ENGINEER'S DRAWINGS

NOTE:

- SHOP DRAWINGS REQUIRED PRIOR TO INSTALLATION.
 PROVIDE "PUSH TO EXIT" BUTTON POST BY SCHLAGE, OR EQUAL)
 MOUNTED (INSIDE POOL) SEE PLAN FOR LOCATION.
- 3. SEE SPECIFICATIONS FOR FENCE AND GATE INFORMATION.
 4. COLOR TO BE BLACK.

4. COLOR TO BE BLACK

6 POOL GATE - ON DECK
SCALE: 3/4 " = 1'-0"

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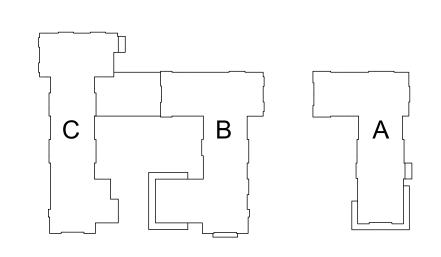
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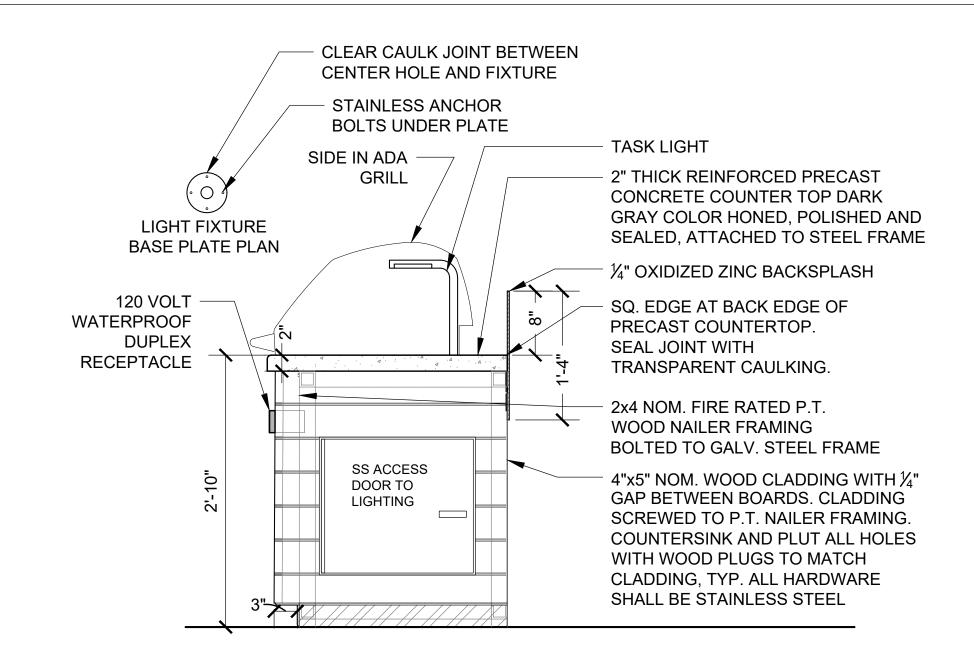
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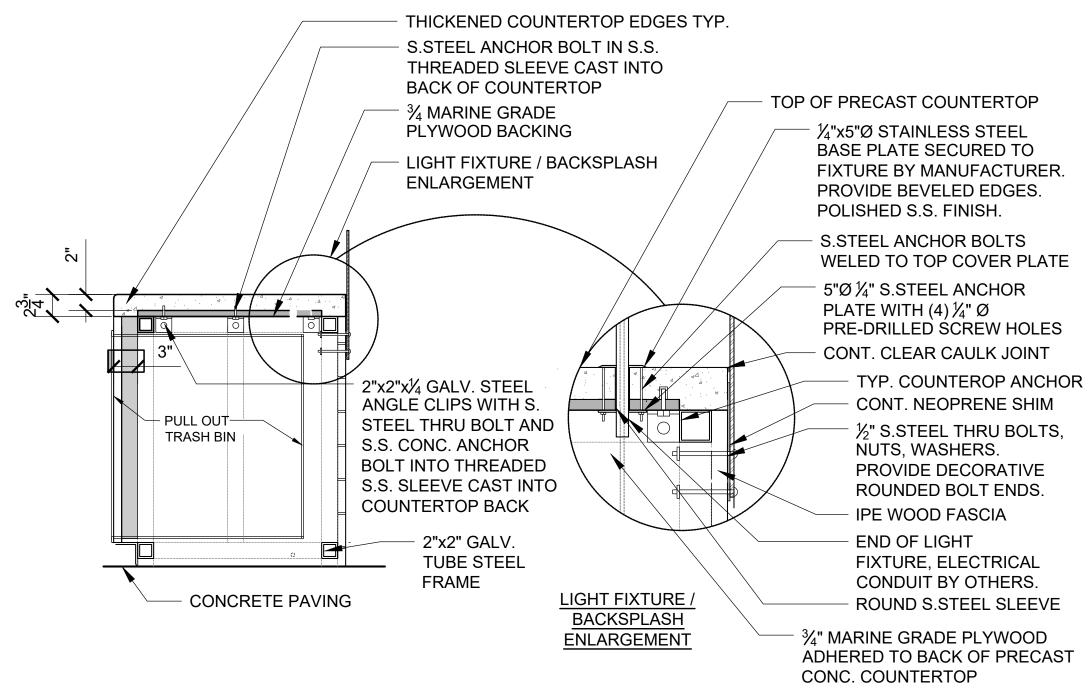
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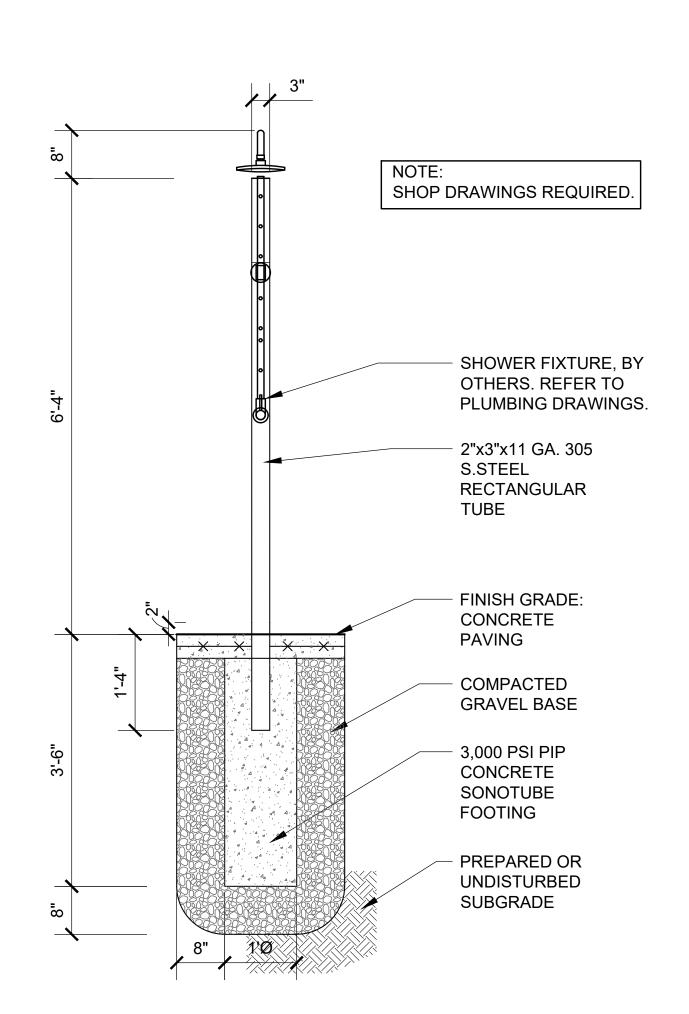
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GRILLING STATION - SIDE ELEVATION





2 GRILLING STATION: SECTION AT TRASH SCALE: 1" = 1'-0"



3 SHOWER

SCALE: 3/4" = 1'-0"

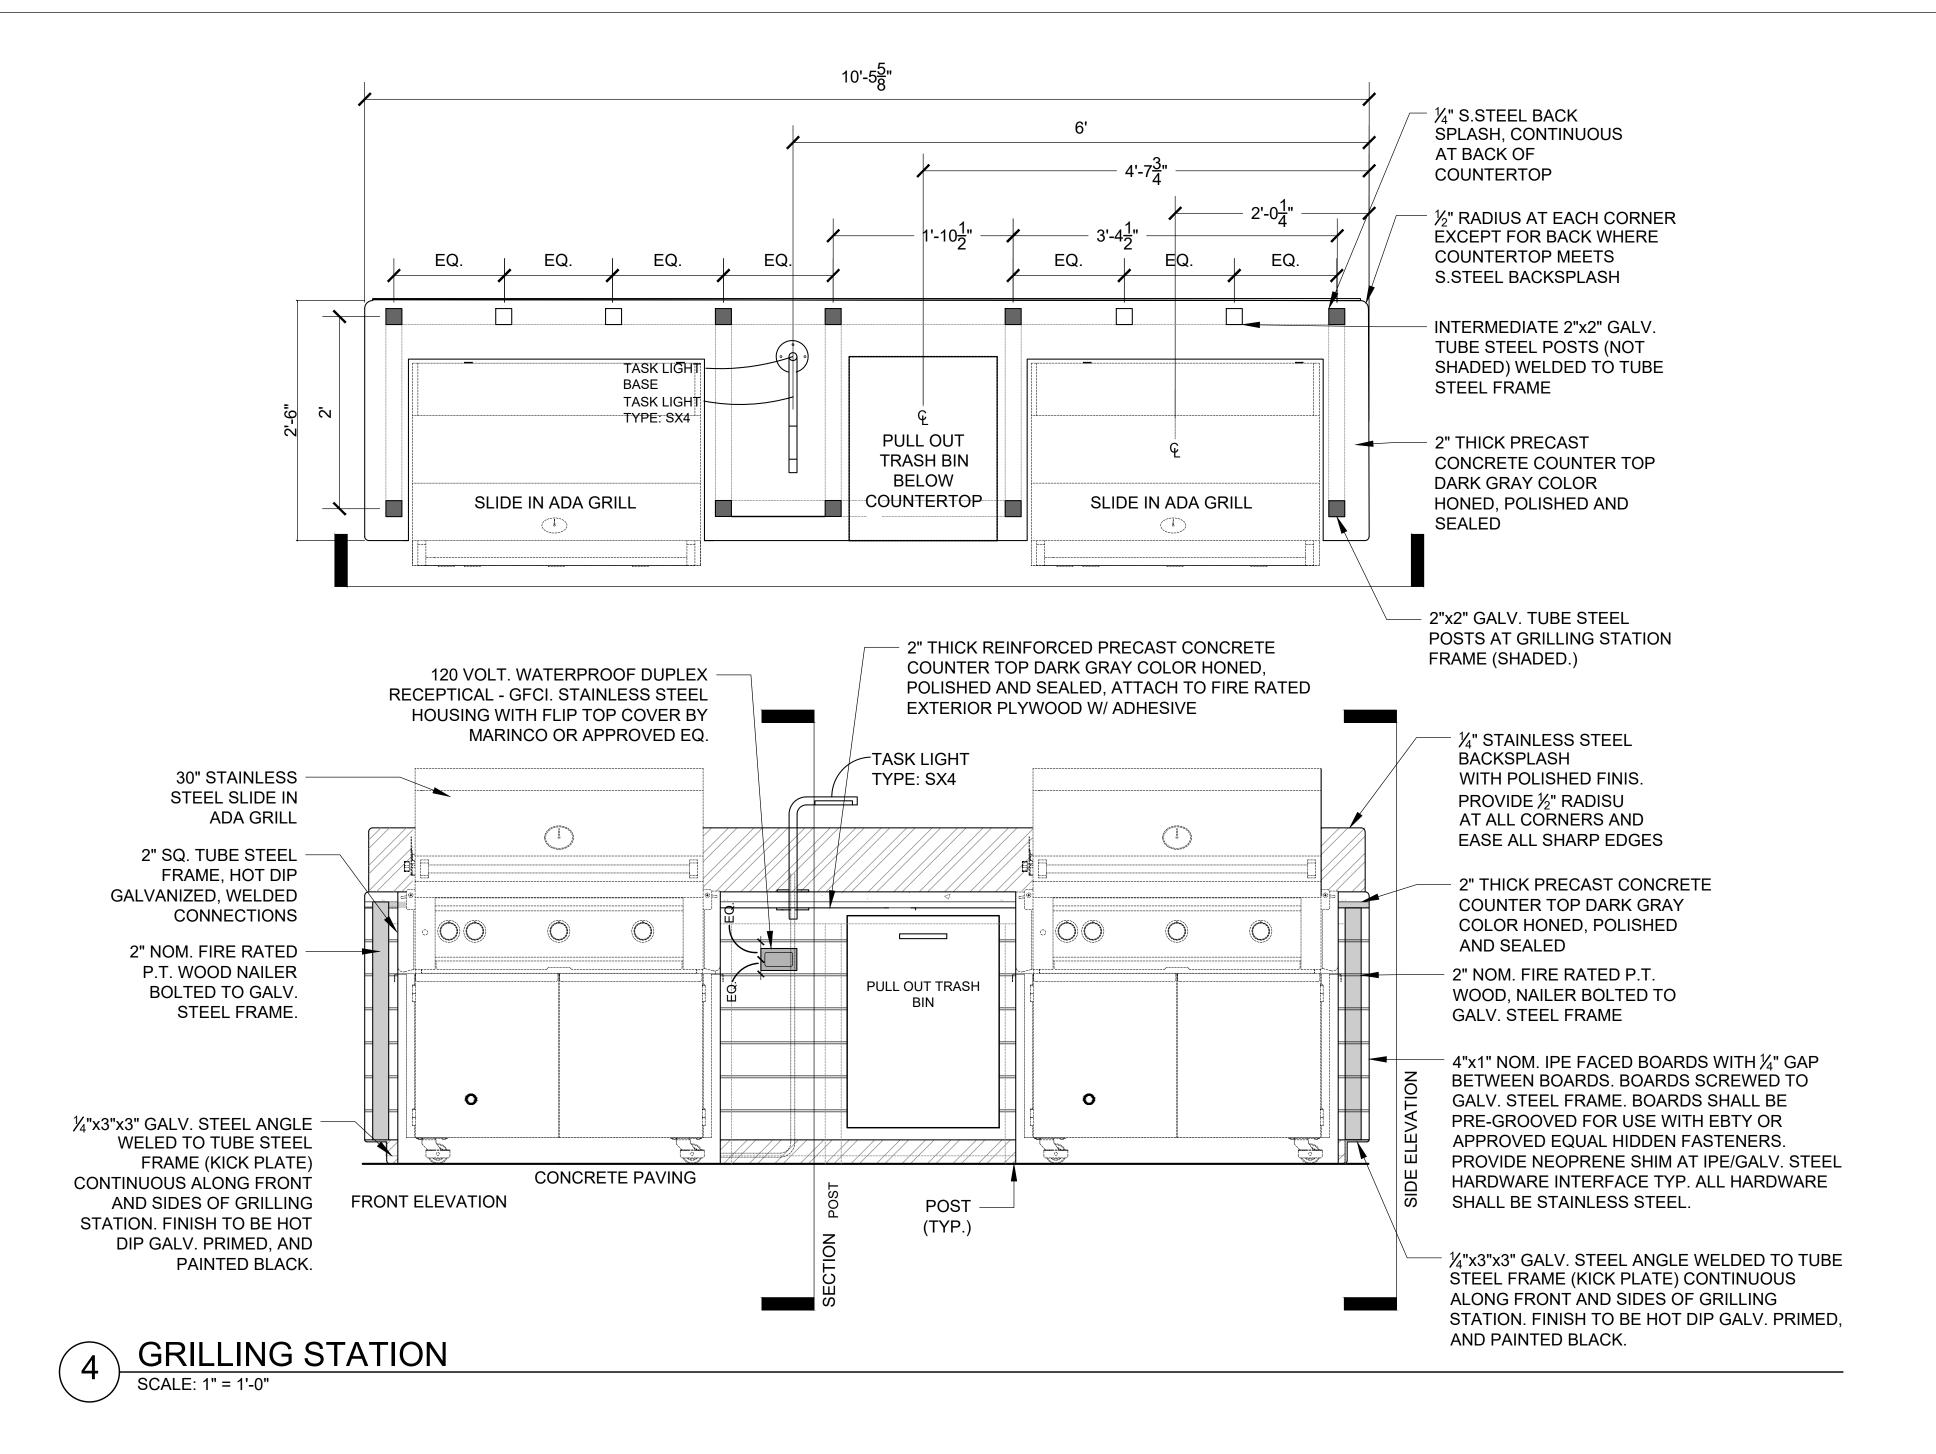

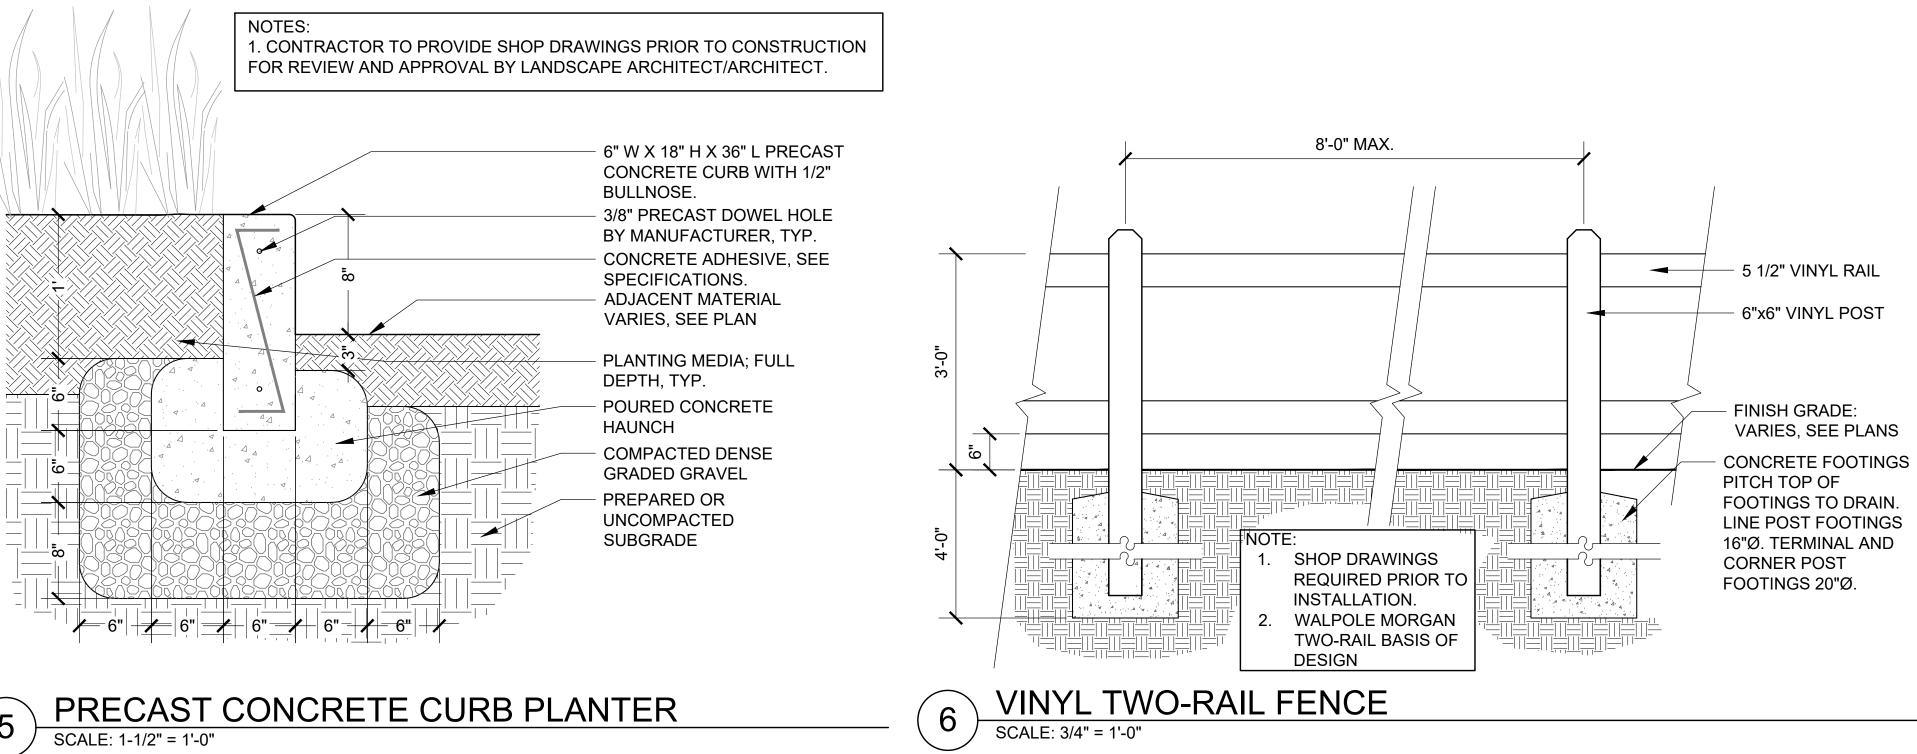

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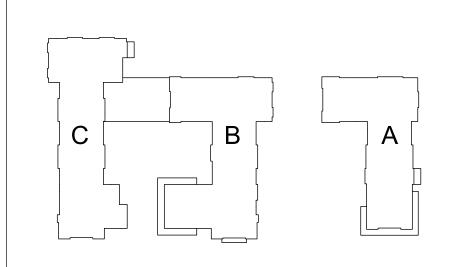
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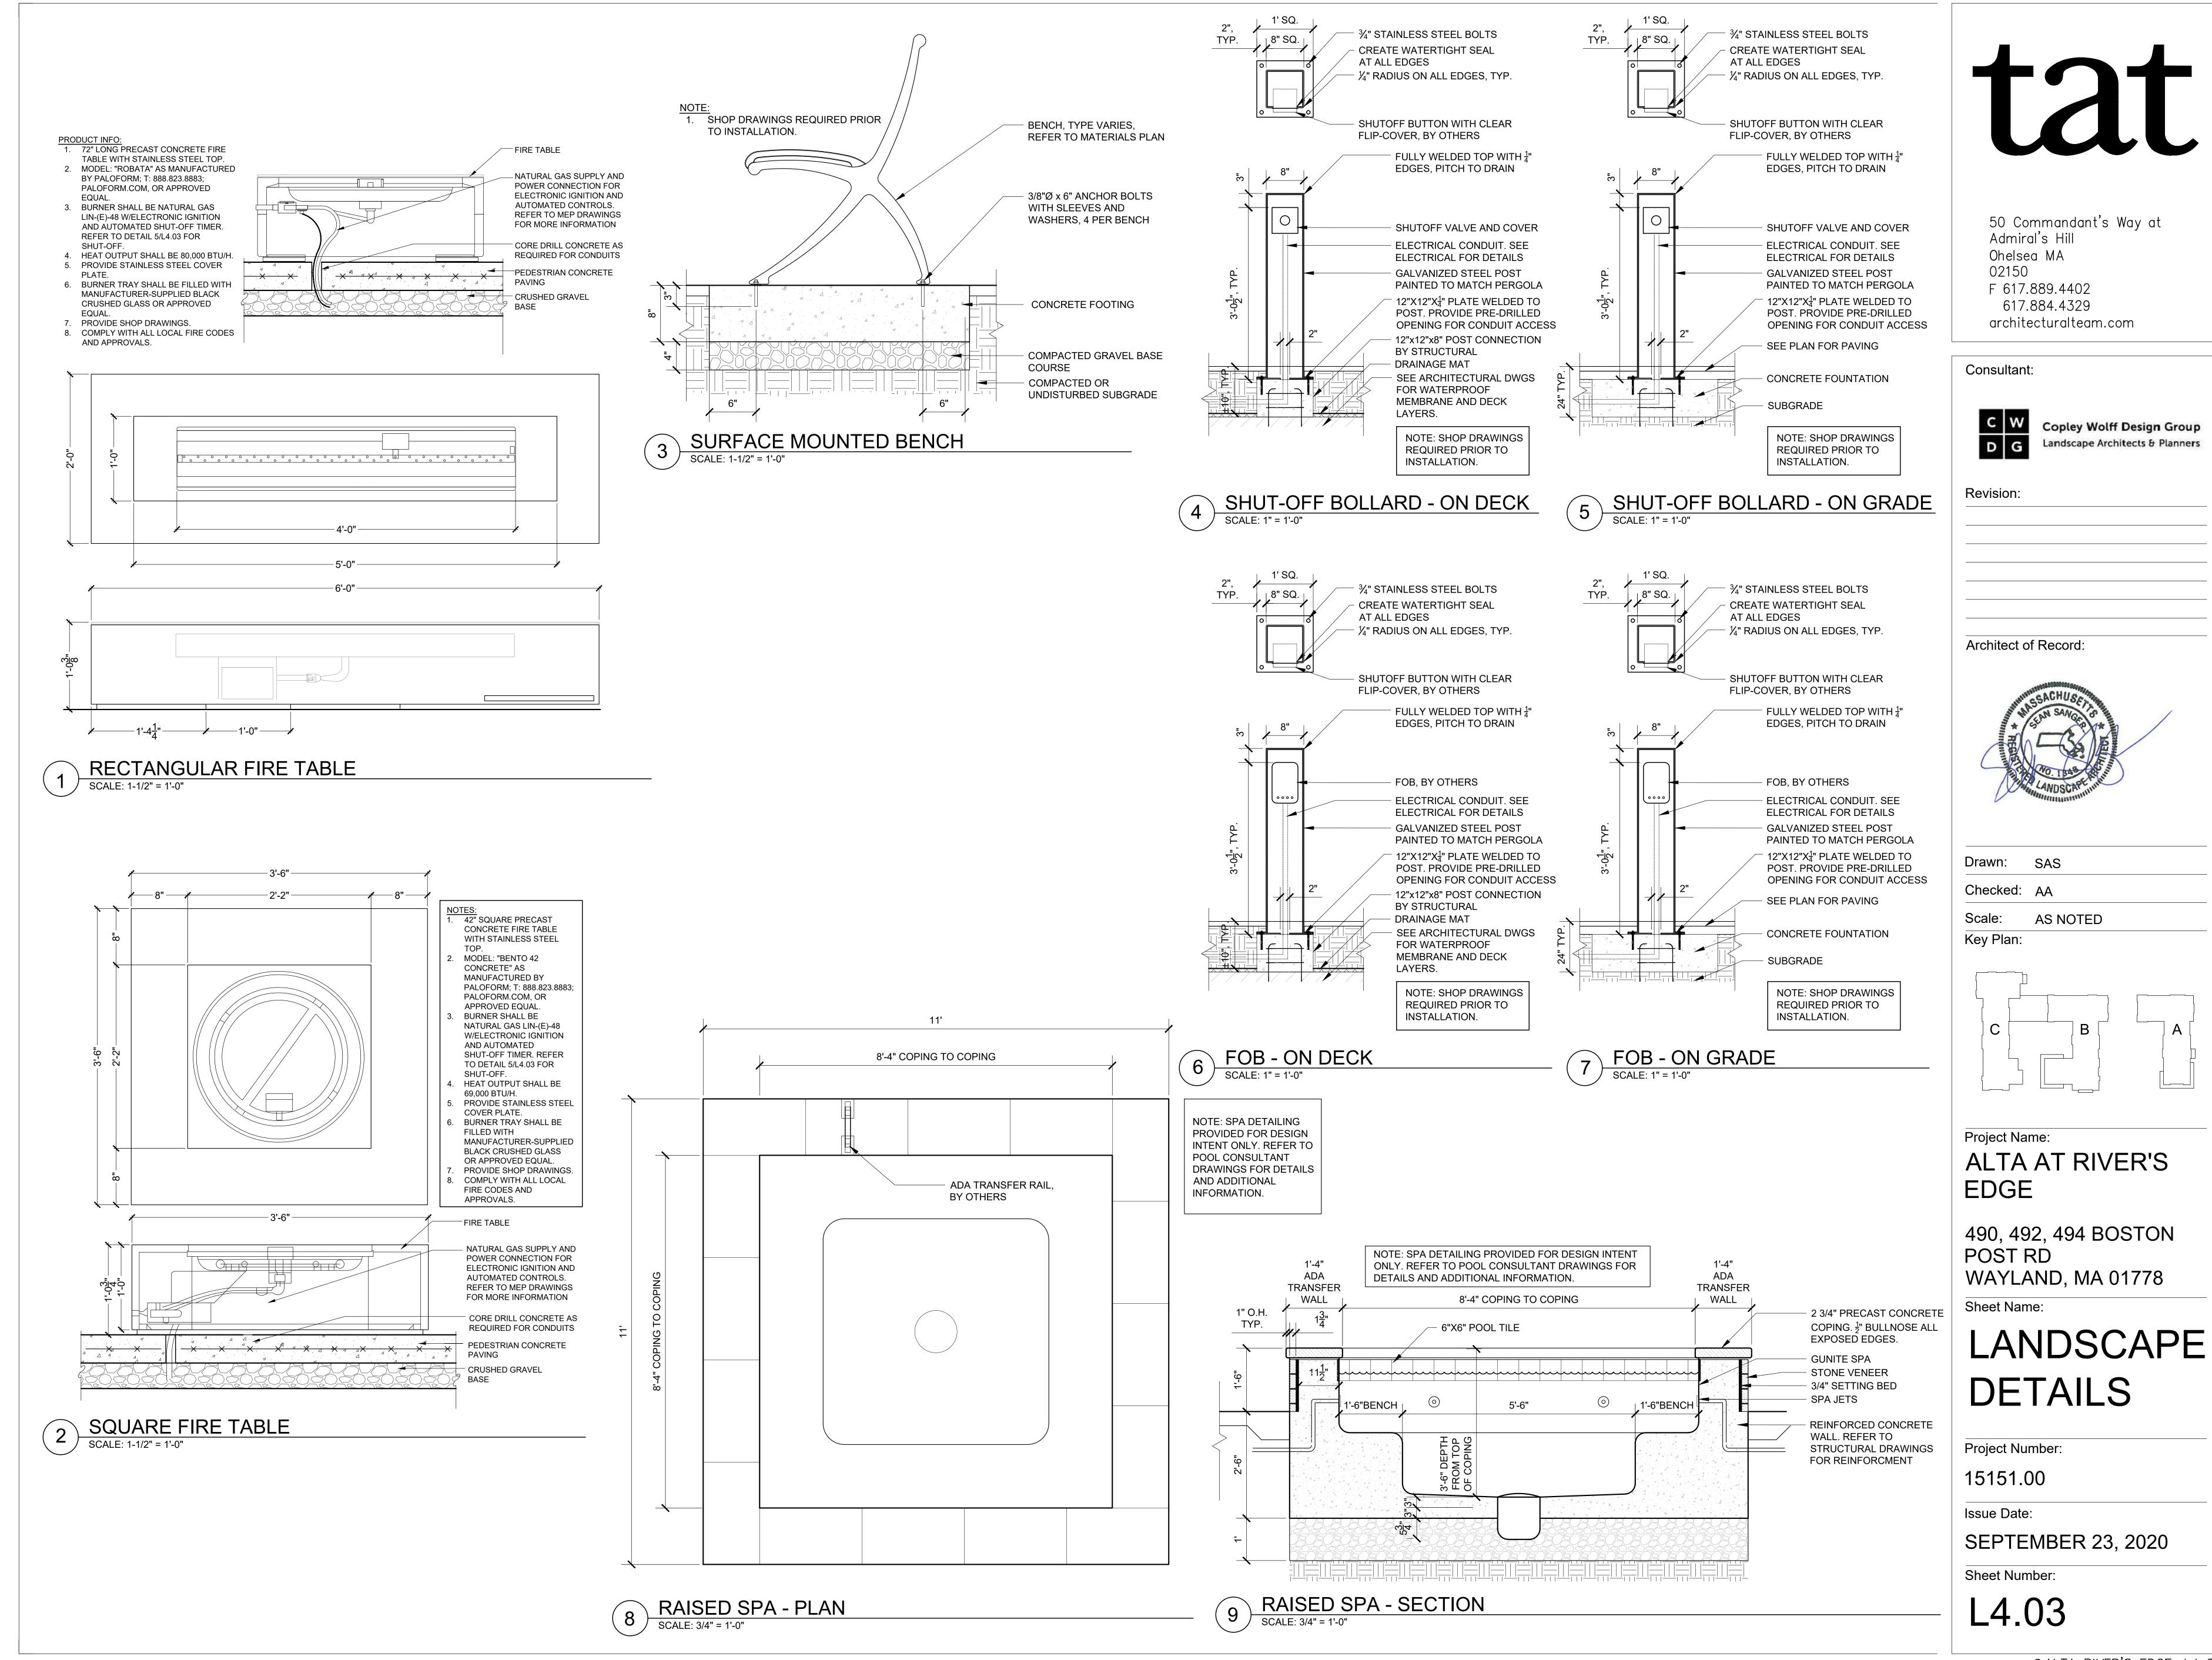
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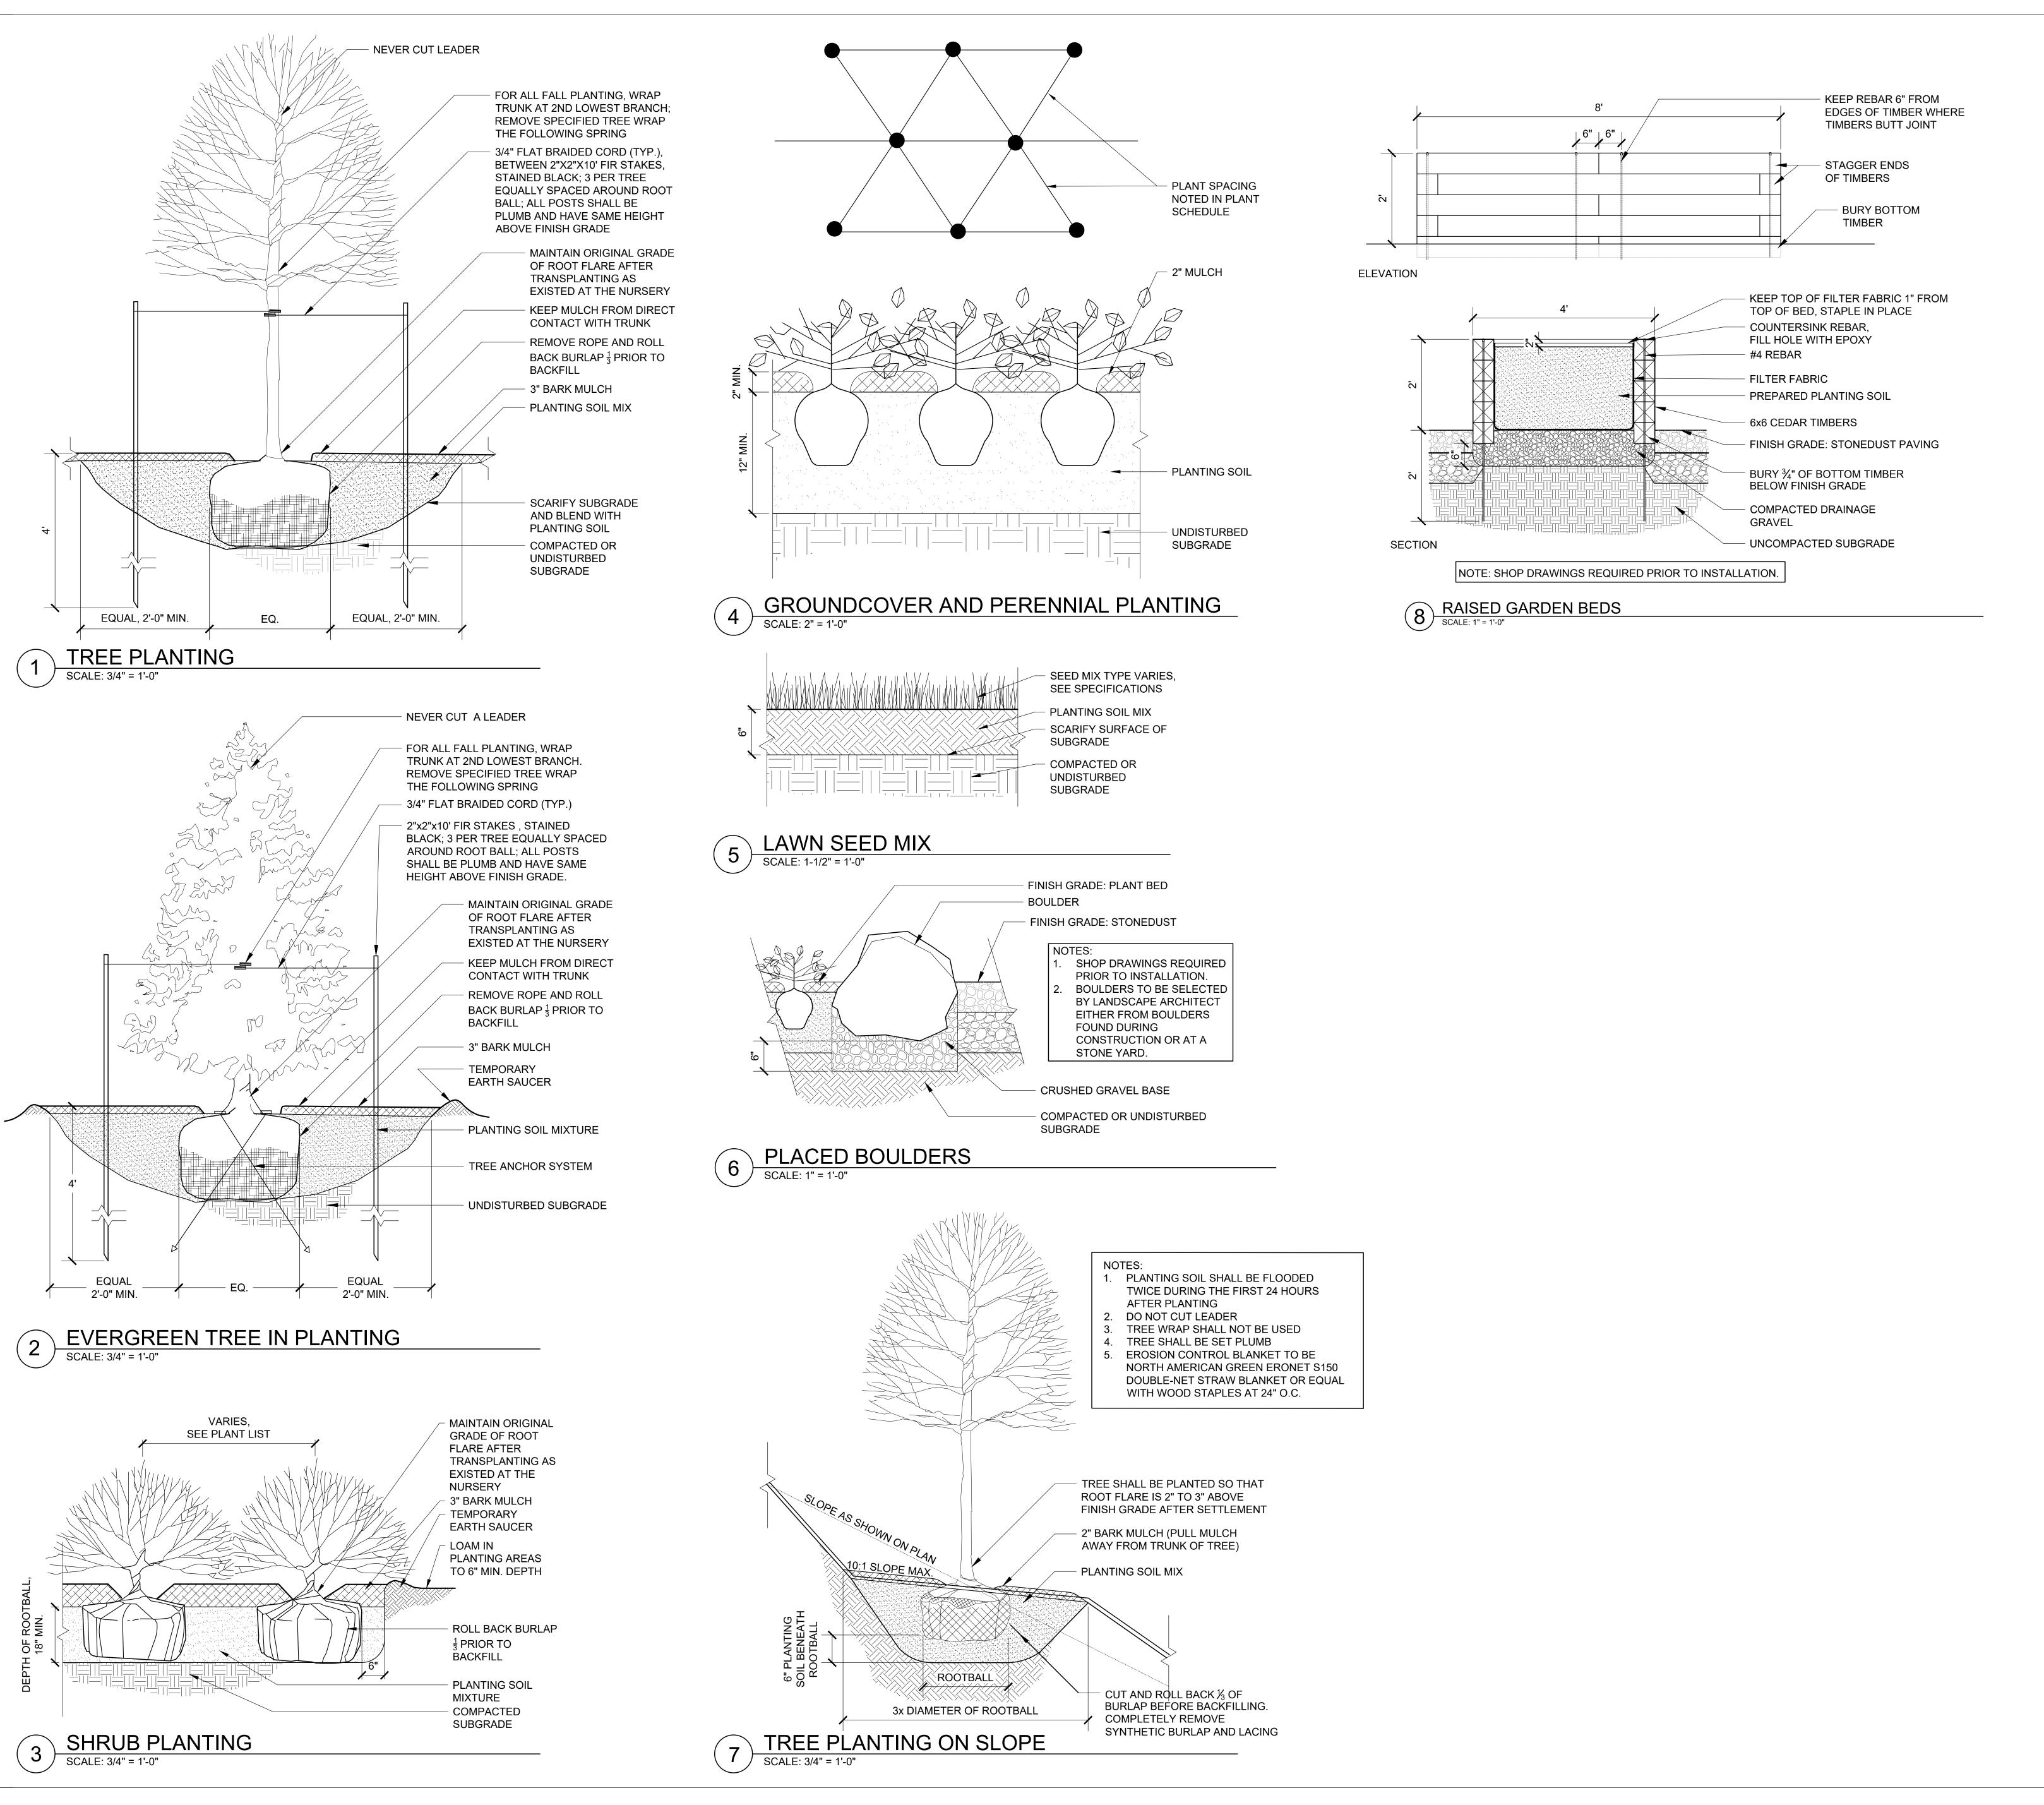
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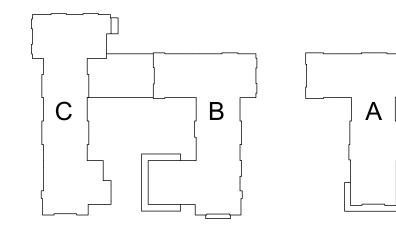
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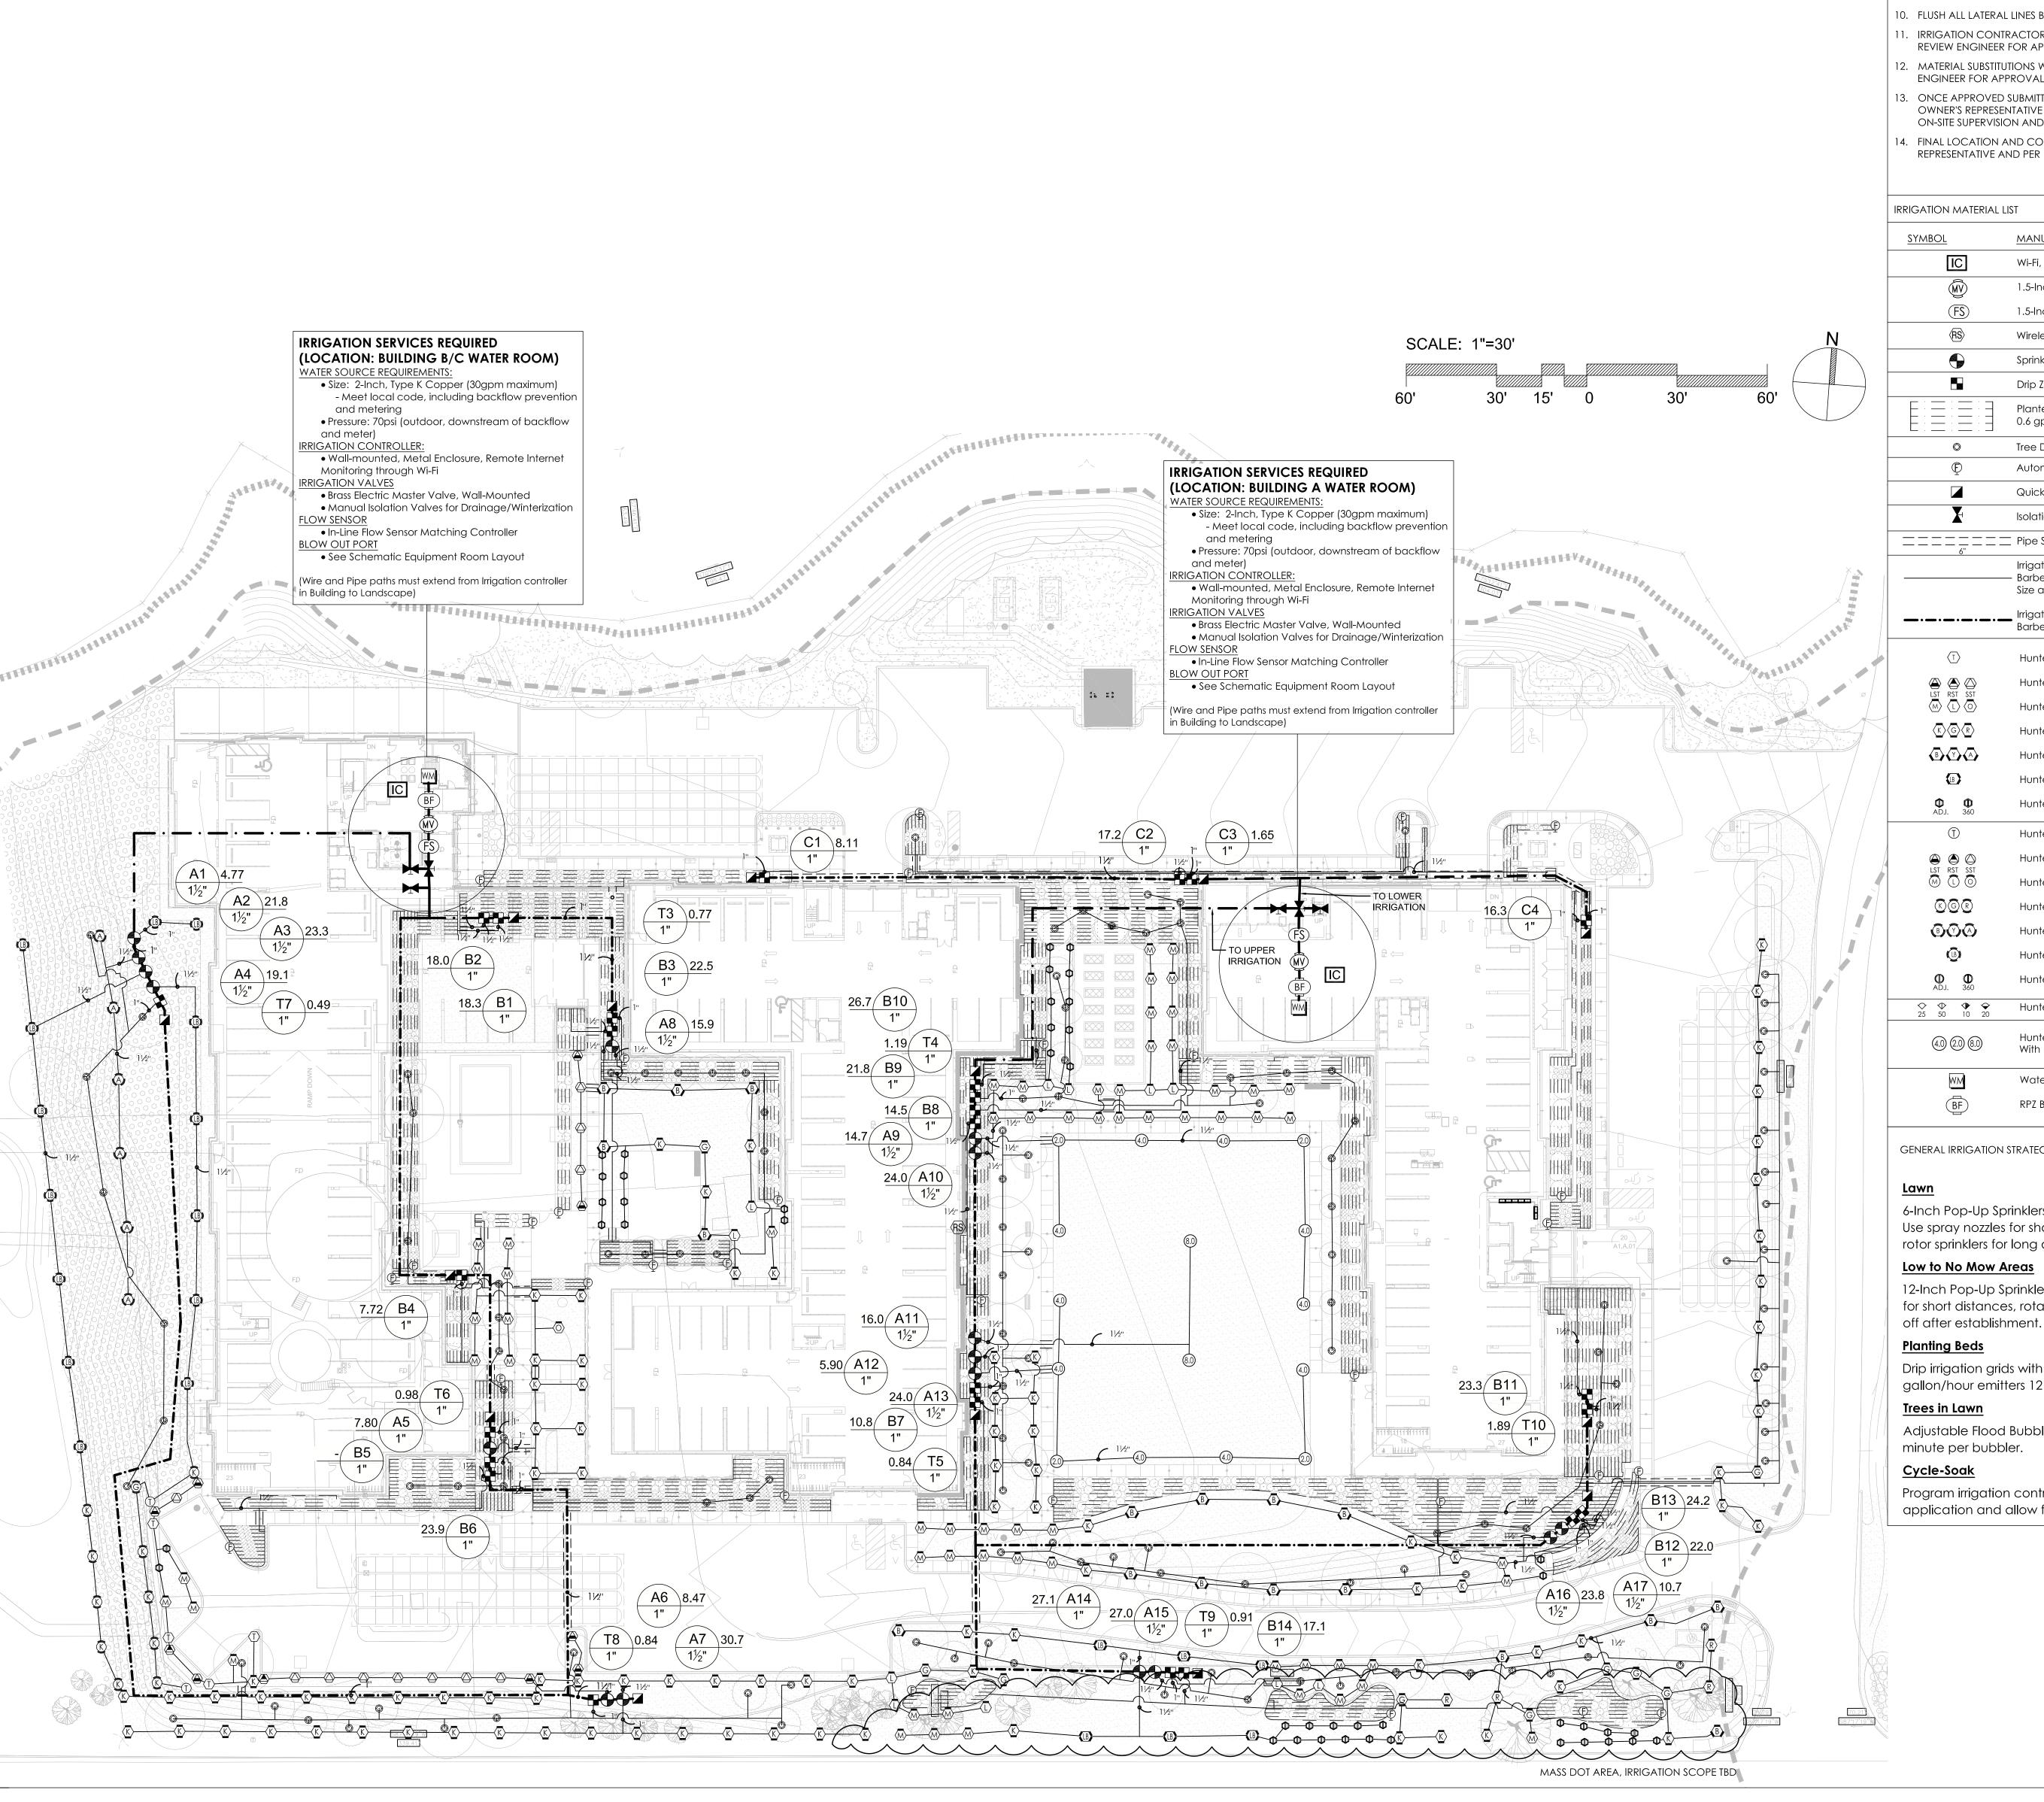
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IRRIGATION NOTES

PROTECTION.

- I. SEE IRRIGATION DETAILS AND SPECIFICATIONS SECTION 328400 FOR ADDITIONAL REQUIRED INFORMATION.
- . COORDINATE FINAL LOCATION OF SPRINKLERS, NOZZLES, DRIP IRRIGATION AND VALVE BOXES WITH FINAL APPROVED LANDSCAPE.
- 3. ALL PIPE AND VALVE LOCATIONS ARE DIAGRAMMATIC FOR CLARITY: IRRIGATION CONTRACTOR SHALL
- 4. SPECIFIED VALVE BOXES IN NATURAL TURF AREAS SHALL BE APPROVED BY LANDSCAPE ARCHITECT AND/OR OWNER'S REPRESENTATIVE.
- 5. ALL CONTROL WIRE SHALL BE 14/2 AWG TWO-WIRE WITH DECODERS.
- IRRIGATION SYSTEM IS DESIGNED FOR NEW DOMESTIC WATER SUPPLY FROM BUILDING TO PROVIDE 30 GPM MAXIMUM. DOMESTIC WATER SUPPLY TO PROVIDE 70-PSI DYNAMIC PRESSURE MAXIMUM AT OUTDOOR IRRIGATION POINT OF CONNECTION. IRRIGATION CONTRACTOR SHALL TEST DYNAMIC PRESSURE BEFORE STARTING WORK AND REPORT ANY DEVIATION TO THE OWNER'S REPRESENTATIVE BEFORE CONTINUING.
- INSTALL NEW IRRIGATION CONTROLLER IN NEW PLASTIC LOCKING ENCLOSURE GENERALLY WHERE SHOWN ON DRAWING INDOORS AS DIRECTED BY OWNER'S REPRESENTATIVE. HARD WIRE TO 120 VOLT, DEDICATED 20-AMP CIRCUIT POWER SUPPLY USING LICENSED ELECTRICIAN. ROUTE ALL TWO-WIRE TO CONTROLLER IN CONDUIT THROUGH BUILDING.
- 8. ALL ABOVE GROUND WIRING SHALL BE INSTALLED IN RIGID, METALLIC CONDUIT FOR VANDALISM
- . COORDINATE LOCATION OF ALL EXISTING AND FUTURE UTILITIES ON SITE, CONTACT PROPER AUTHORITIES AND UTILITY COMPANIES BEFORE THE START OF WORK.
- 10. FLUSH ALL LATERAL LINES BEFORE INSTALLING SPRINKLERS (NO INTERNALS).
- 1. IRRIGATION CONTRACTOR MUST SUBMIT IRRIGATION PRODUCTS AS PER THE WRITTEN SPECIFICATIONS TO REVIEW ENGINEER FOR APPROVAL PRIOR TO ORDERING MATERIAL AND BEGINNING WORK.
- 12. MATERIAL SUBSTITUTIONS WHICH VARY FROM THE SPECIFIED PRODUCTS MUST BE SUBMITTED TO REVIEW ENGINEER FOR APPROVAL AS PART OF THE SUBMITTAL PROCESS.
- 13. ONCE APPROVED SUBMITTALS HAVE BEEN RETURNED TO THE IRRIGATION CONTRACTOR, WORK MAY BEGIN. OWNER'S REPRESENTATIVE MUST BE NOTIFIED 7 DAYS IN ADVANCE OF THE START OF WORK TO COORDINATE ON-SITE SUPERVISION AND ADMINISTRATION.
- 14. FINAL LOCATION AND CONFIGURATION OF IRRIGATION SYSTEM SHALL BE APPROVED BY OWNER'S REPRESENTATIVE AND PER LOCAL AUTHORITIES.

| SYMBOL | MANUFACTURER/MODEL | DETAIL # (LI-2.00) |
|---|--|--------------------|
| IC | Wi-Fi, Two-Wire Irrigation Controller | 1 |
| ŴV | 1.5-Inch Brass Master Valve | 2 |
| FS | 1.5-Inch Flow Sensor | |
| (RS) | Wireless Rain Sensor | 3 |
| • | Sprinkler Zone Valve with Filter Sentry/Scrubber | 4, 6 |
| | Drip Zone Valve Kit with Filter and Pressure Regulator | 5, 6 |
| | Planted Area to Receive Dripline 0.6 gph Emitters 12" O.C. at 18" Row Spacing | 7 |
| 0 | Tree Drip Ring | 18 |
| Φ | Automatic Flush Valve | 8 |
| | Quick Coupler Valve | 9 |
| X | Isolation Gate Valve | 10 |
| | Pipe Sleeve: PVC SDR 35 Solvent Weld (with Size) | 11 |
| - | Irrigation Lateral Line: Class 100 Polyethylene with Barbed Fittings and Stainless Steel Clamps Size as Noted, Unlabled Pipe = 1-Inch | 12 |
| | Irrigation Mainline: 1.5-Inch Class 100 Polyethylene with Barbed Fittings and Double Stainless Steel Clamps | |
| T | Hunter MP Corner PROS-06-PRS40-CV | |
| LST RST SST | Hunter MP Strip PROS-06-PRS40-CV | |
| \bigcirc \bigcirc | Hunter MP1000 PROS-06-PRS40-CV | |
| $\langle K \rangle \langle G \rangle \langle R \rangle$ | Hunter MP2000 PROS-06-PRS40-CV | 13 |
| BYA | Hunter MP3000 PROS-06-PRS40-CV | |
| (LB) | Hunter MP3500 PROS-06-PRS40-CV | |
| D D ADJ. 360 | Hunter MP800SR PROS-06-PRS40-CV | |
| (1) | Hunter MP Corner PROS-12-PRS40-CV | |
| | Hunter MP Strip PROS-12-PRS40-CV | |
| LST RST SST | Hunter MP1000 PROS-12-PRS40-CV | |
| KGR | Hunter MP2000 PROS-12-PRS40-CV | |
| | Hunter MP3000 PROS-12-PRS40-CV | 14 |
| (B) | Hunter MP3500 PROS-12-PRS40-CV | |

GENERAL IRRIGATION STRATEGY

6-Inch Pop-Up Sprinklers and Gear-Driven Rotor Sprinklers with Head-to-Head Coverage Use spray nozzles for short distances, rotary nozzles for medium distances, gear-driven

Hunter AFB (Trees in Lawn)

Hunter I-20-06-SS-PRB (Great Lawn) With Nozzle Flow Rates

Water Meter (Provided by Plumbing)

RPZ Backflow Preventer (Provided by Plumbing)

rotor sprinklers for long distances.

Low to No Mow Areas 12-Inch Pop-Up Sprinklers to allow for throwing water over taller grass. Use spray nozzles for short distances, rotary nozzles for medium to long distances. If desired by Owner, turn

<u>Planting Beds</u>

Drip irrigation grids with flow rates matched to planting soil specification. Typically 0.6 gallon/hour emitters 12 inches on center within drip tubing and 18" drip tubing rows.

Adjustable Flood Bubblers on Pop-Up Sprinkler Bodies ranging from 0.25 - 1.00 gallons per

Cycle-Soak

Program irrigation controller to apply daily water use in soak cycles as as to split up application and allow for proper horizontal and vertical movement of water through soils.



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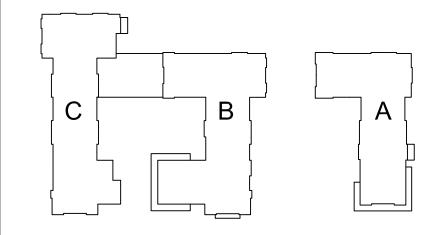
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Sheet Name:

Irrigation Plan

Project Number:


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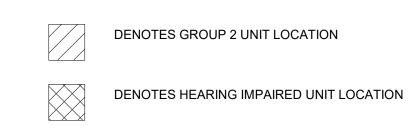
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OVERALL PLAN - LEVEL


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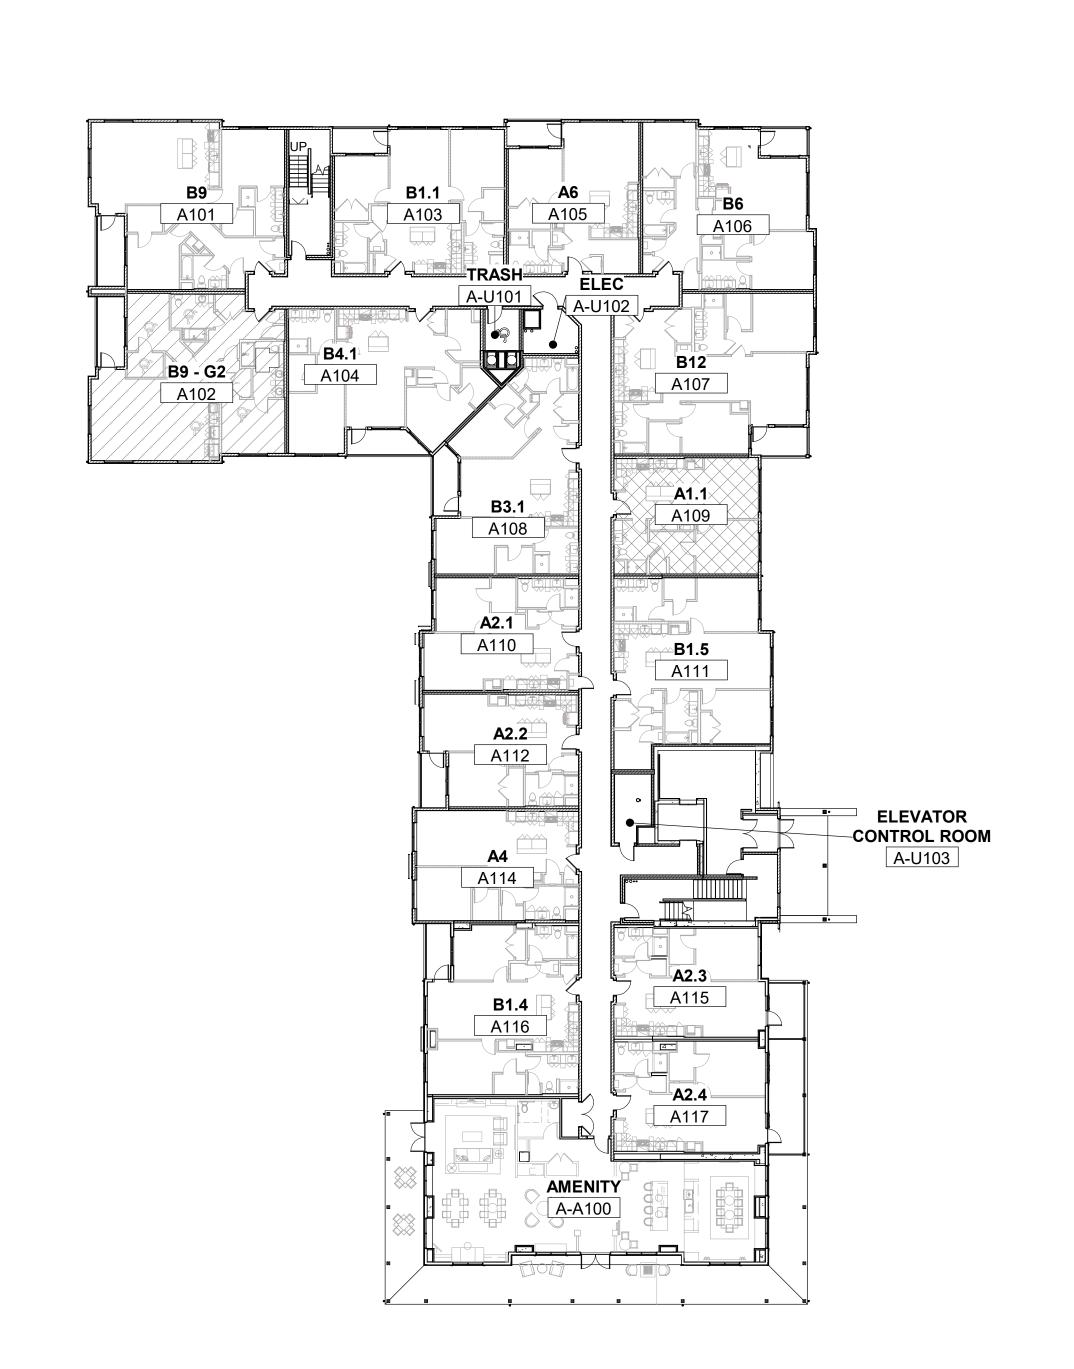
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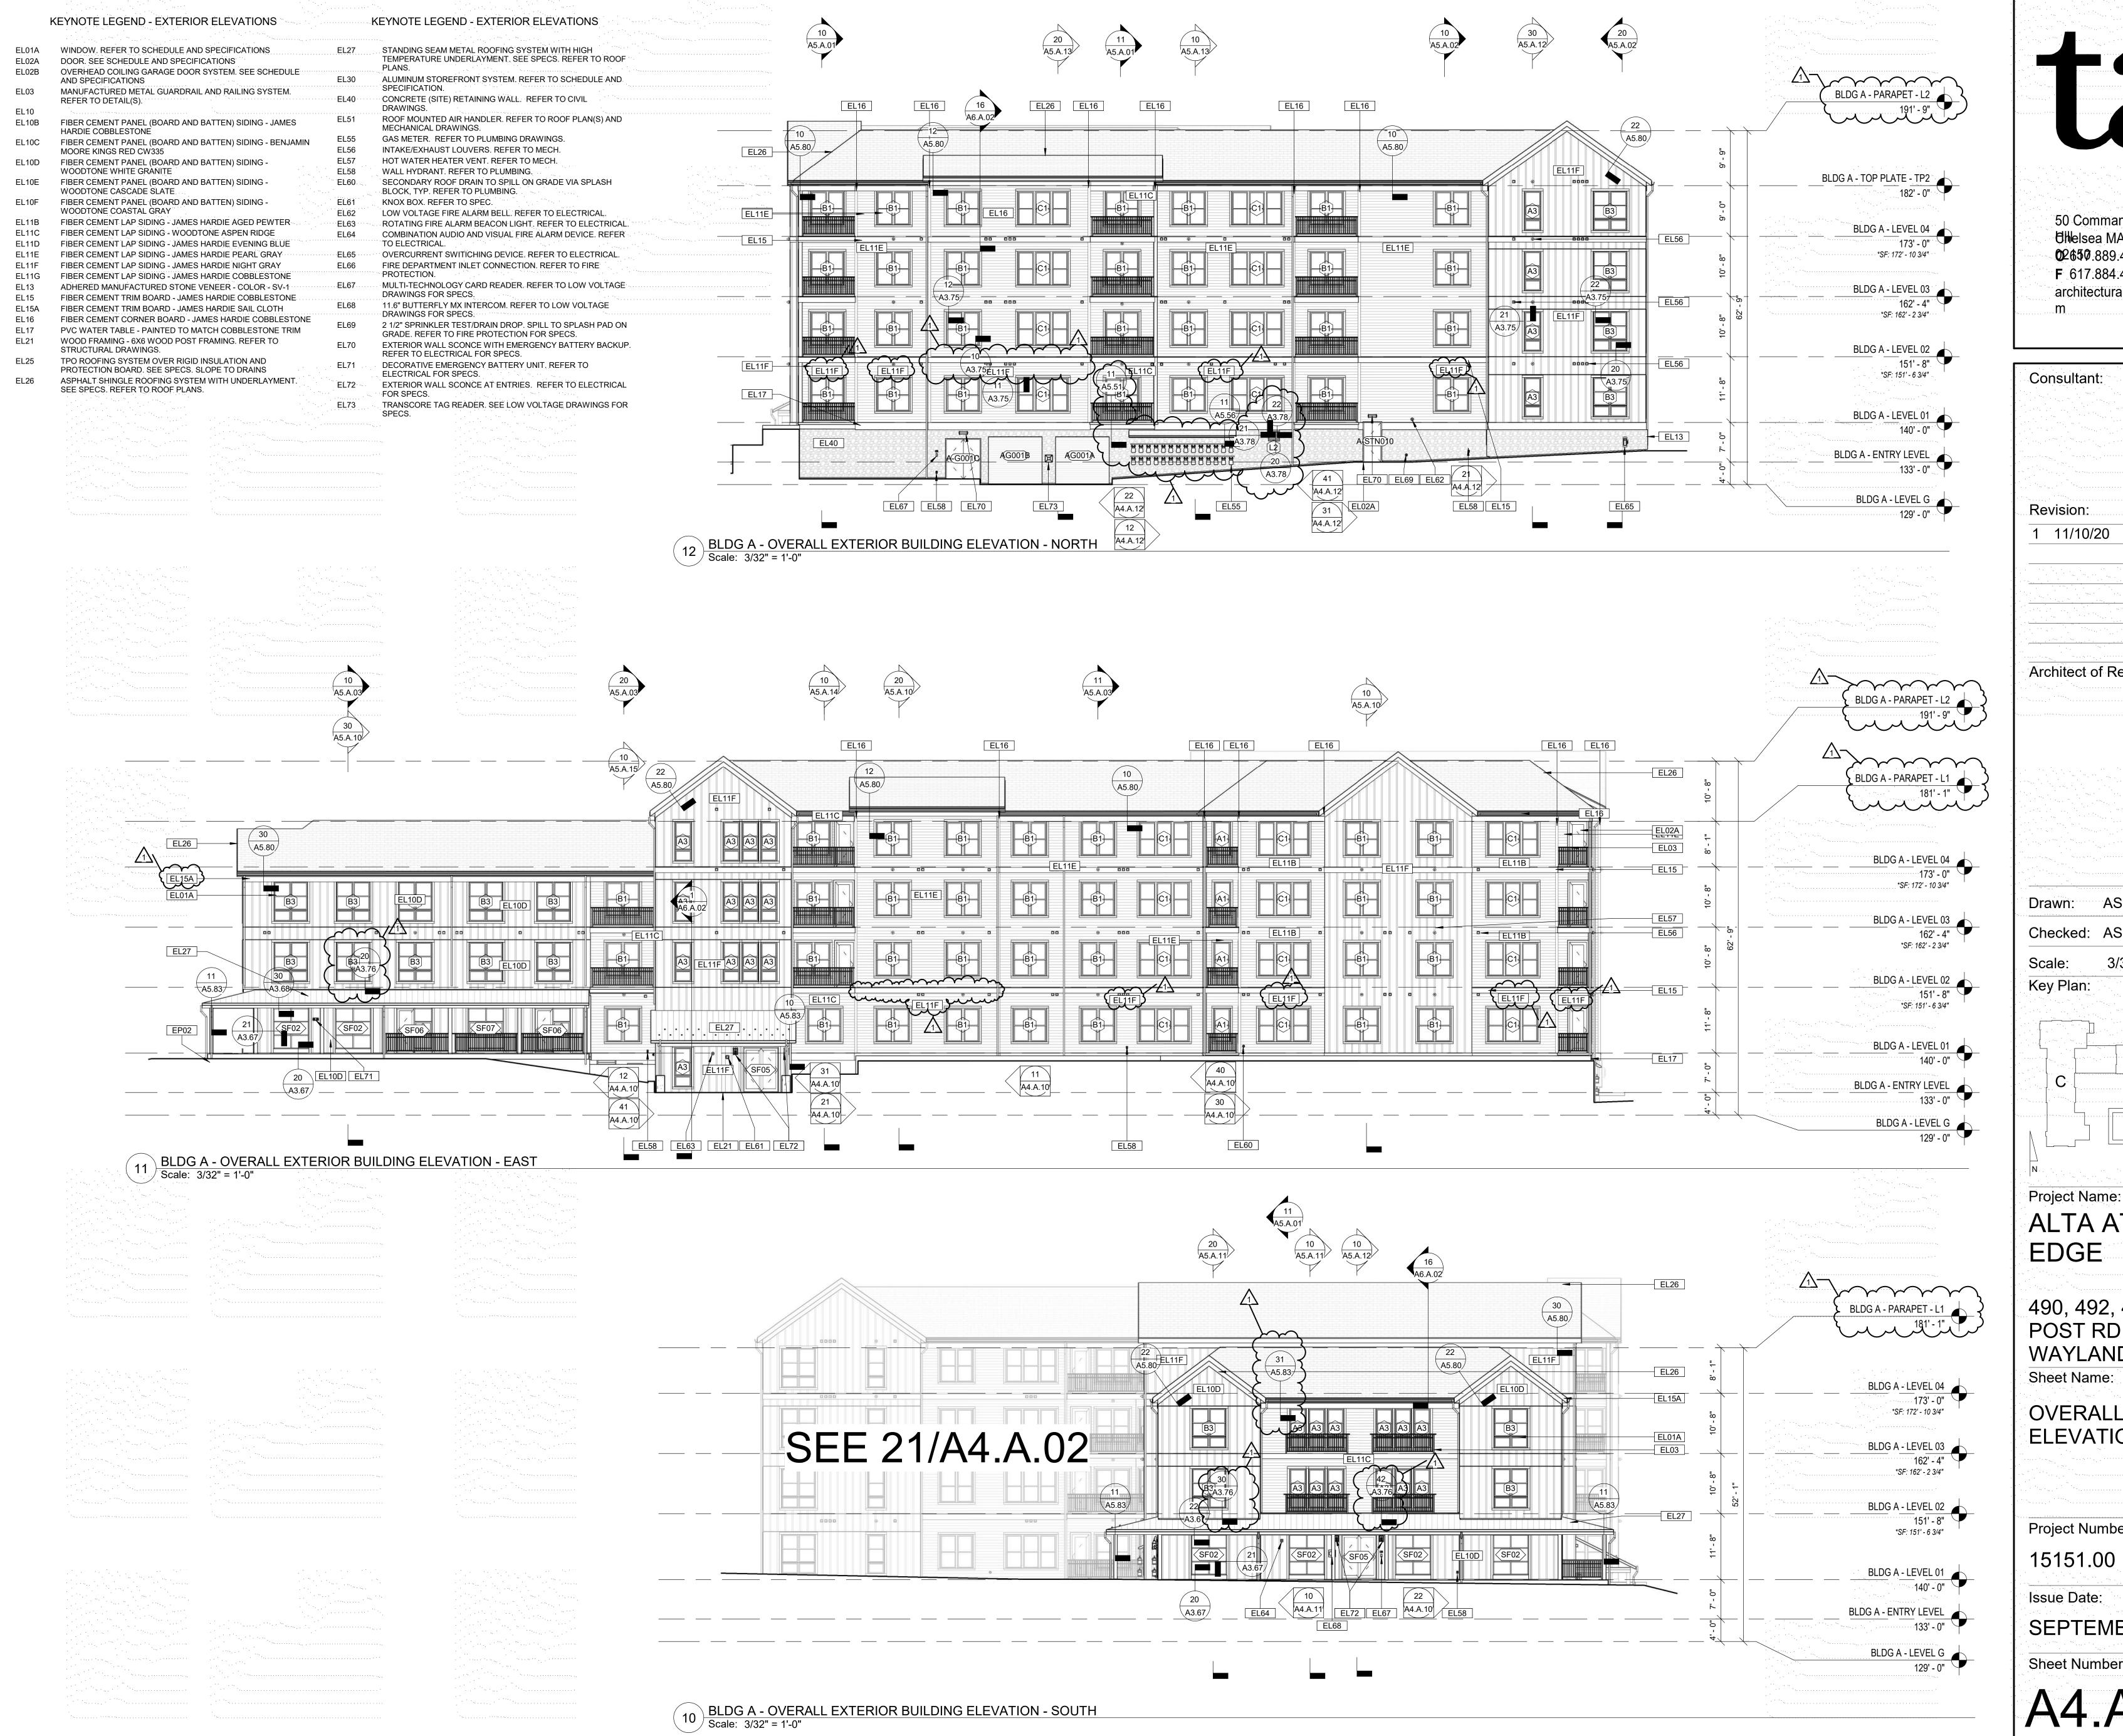
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BUILDING A 490 BOSTON POST ROAD

OVERALL PLANS - LEVEL 01
Scale: 1" = 20'-0"



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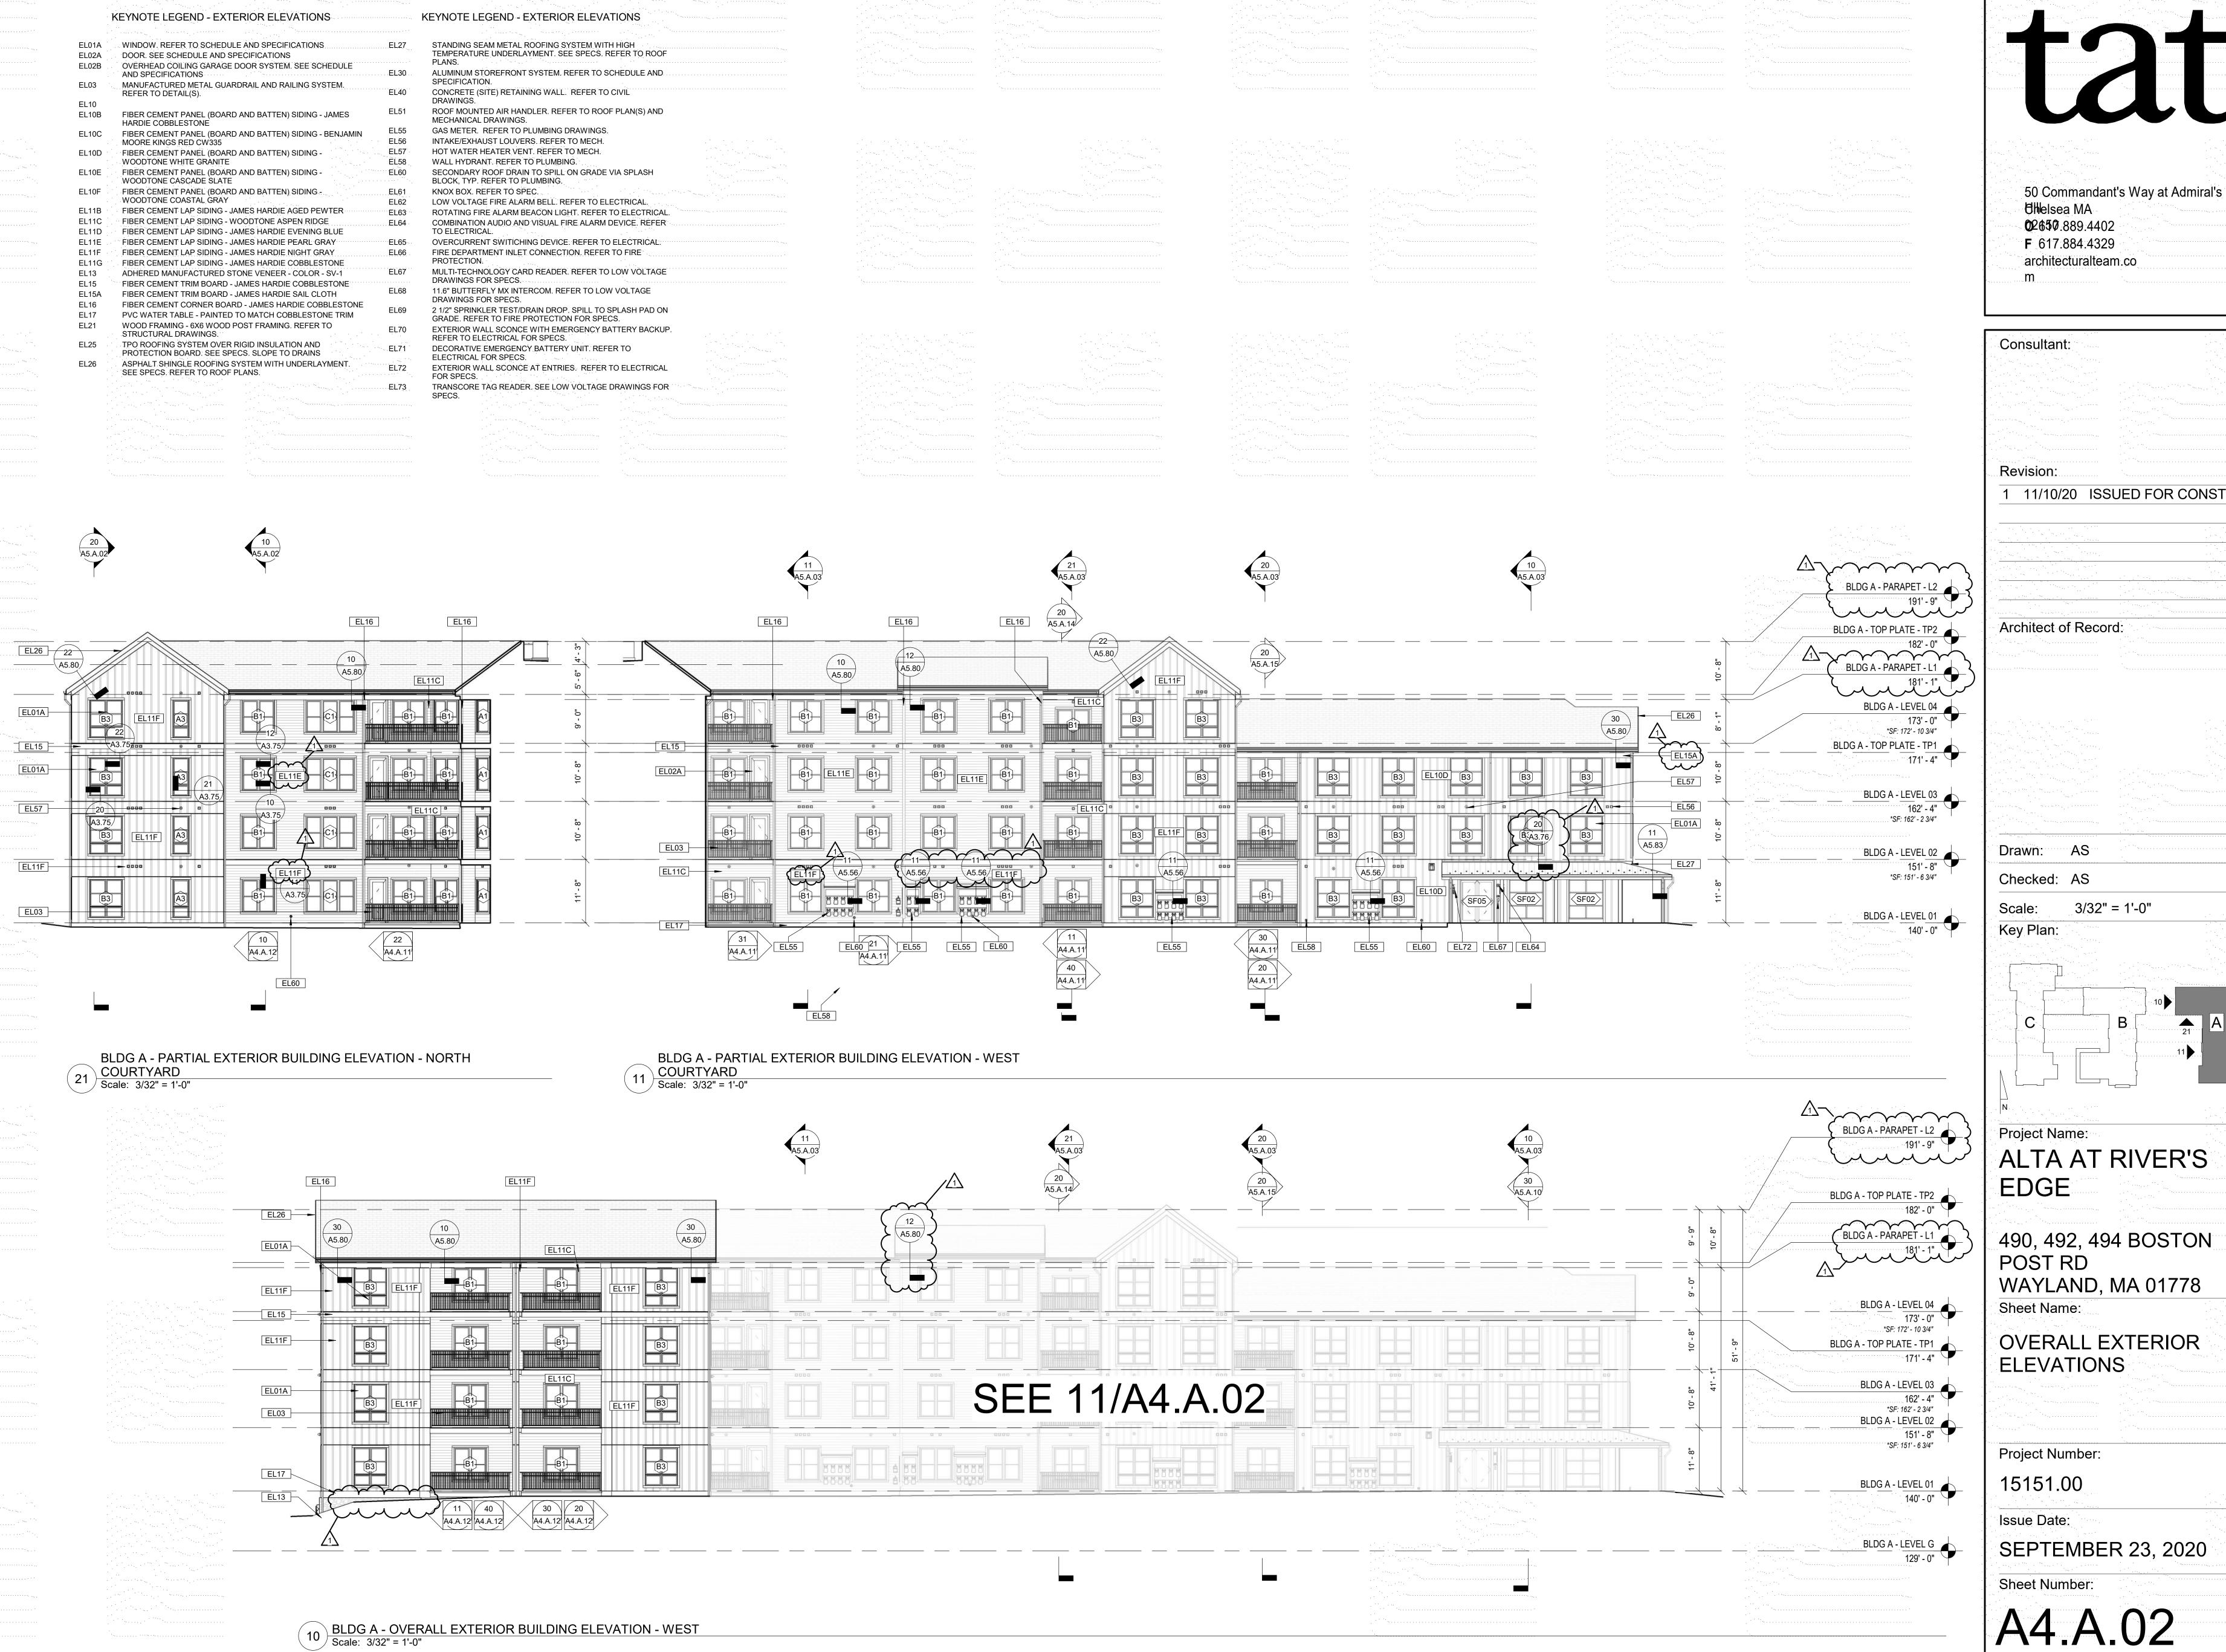
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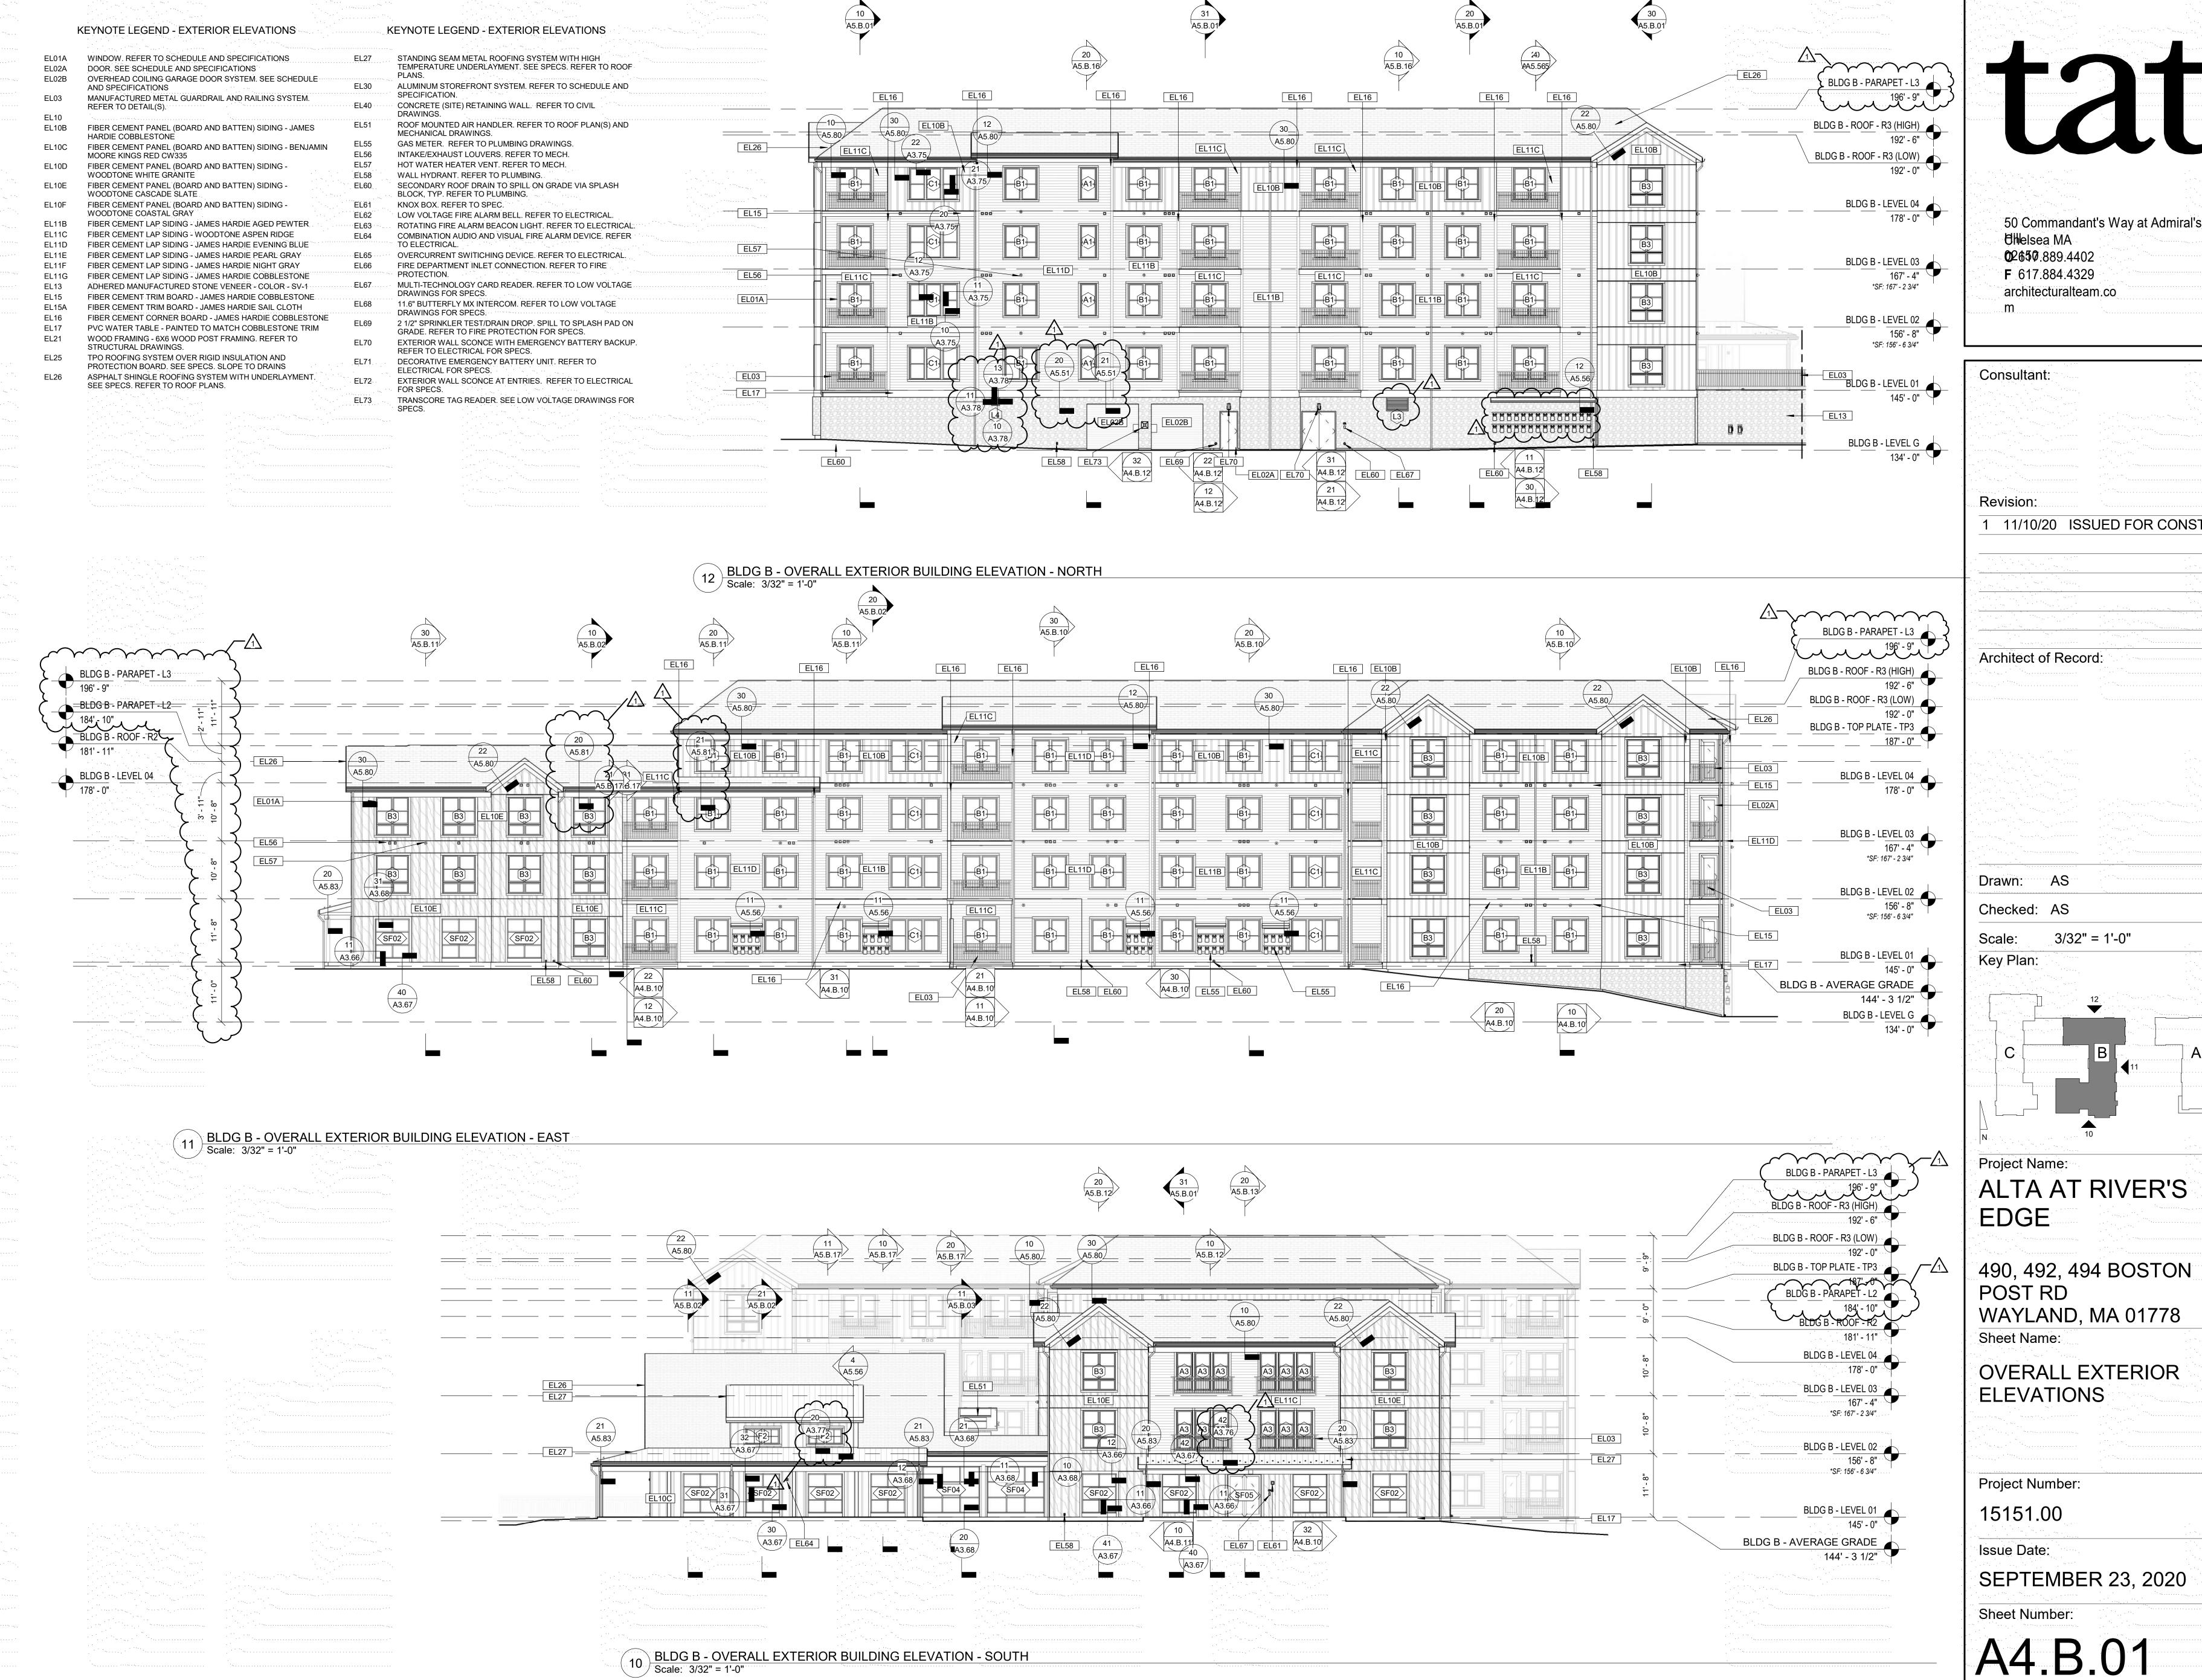
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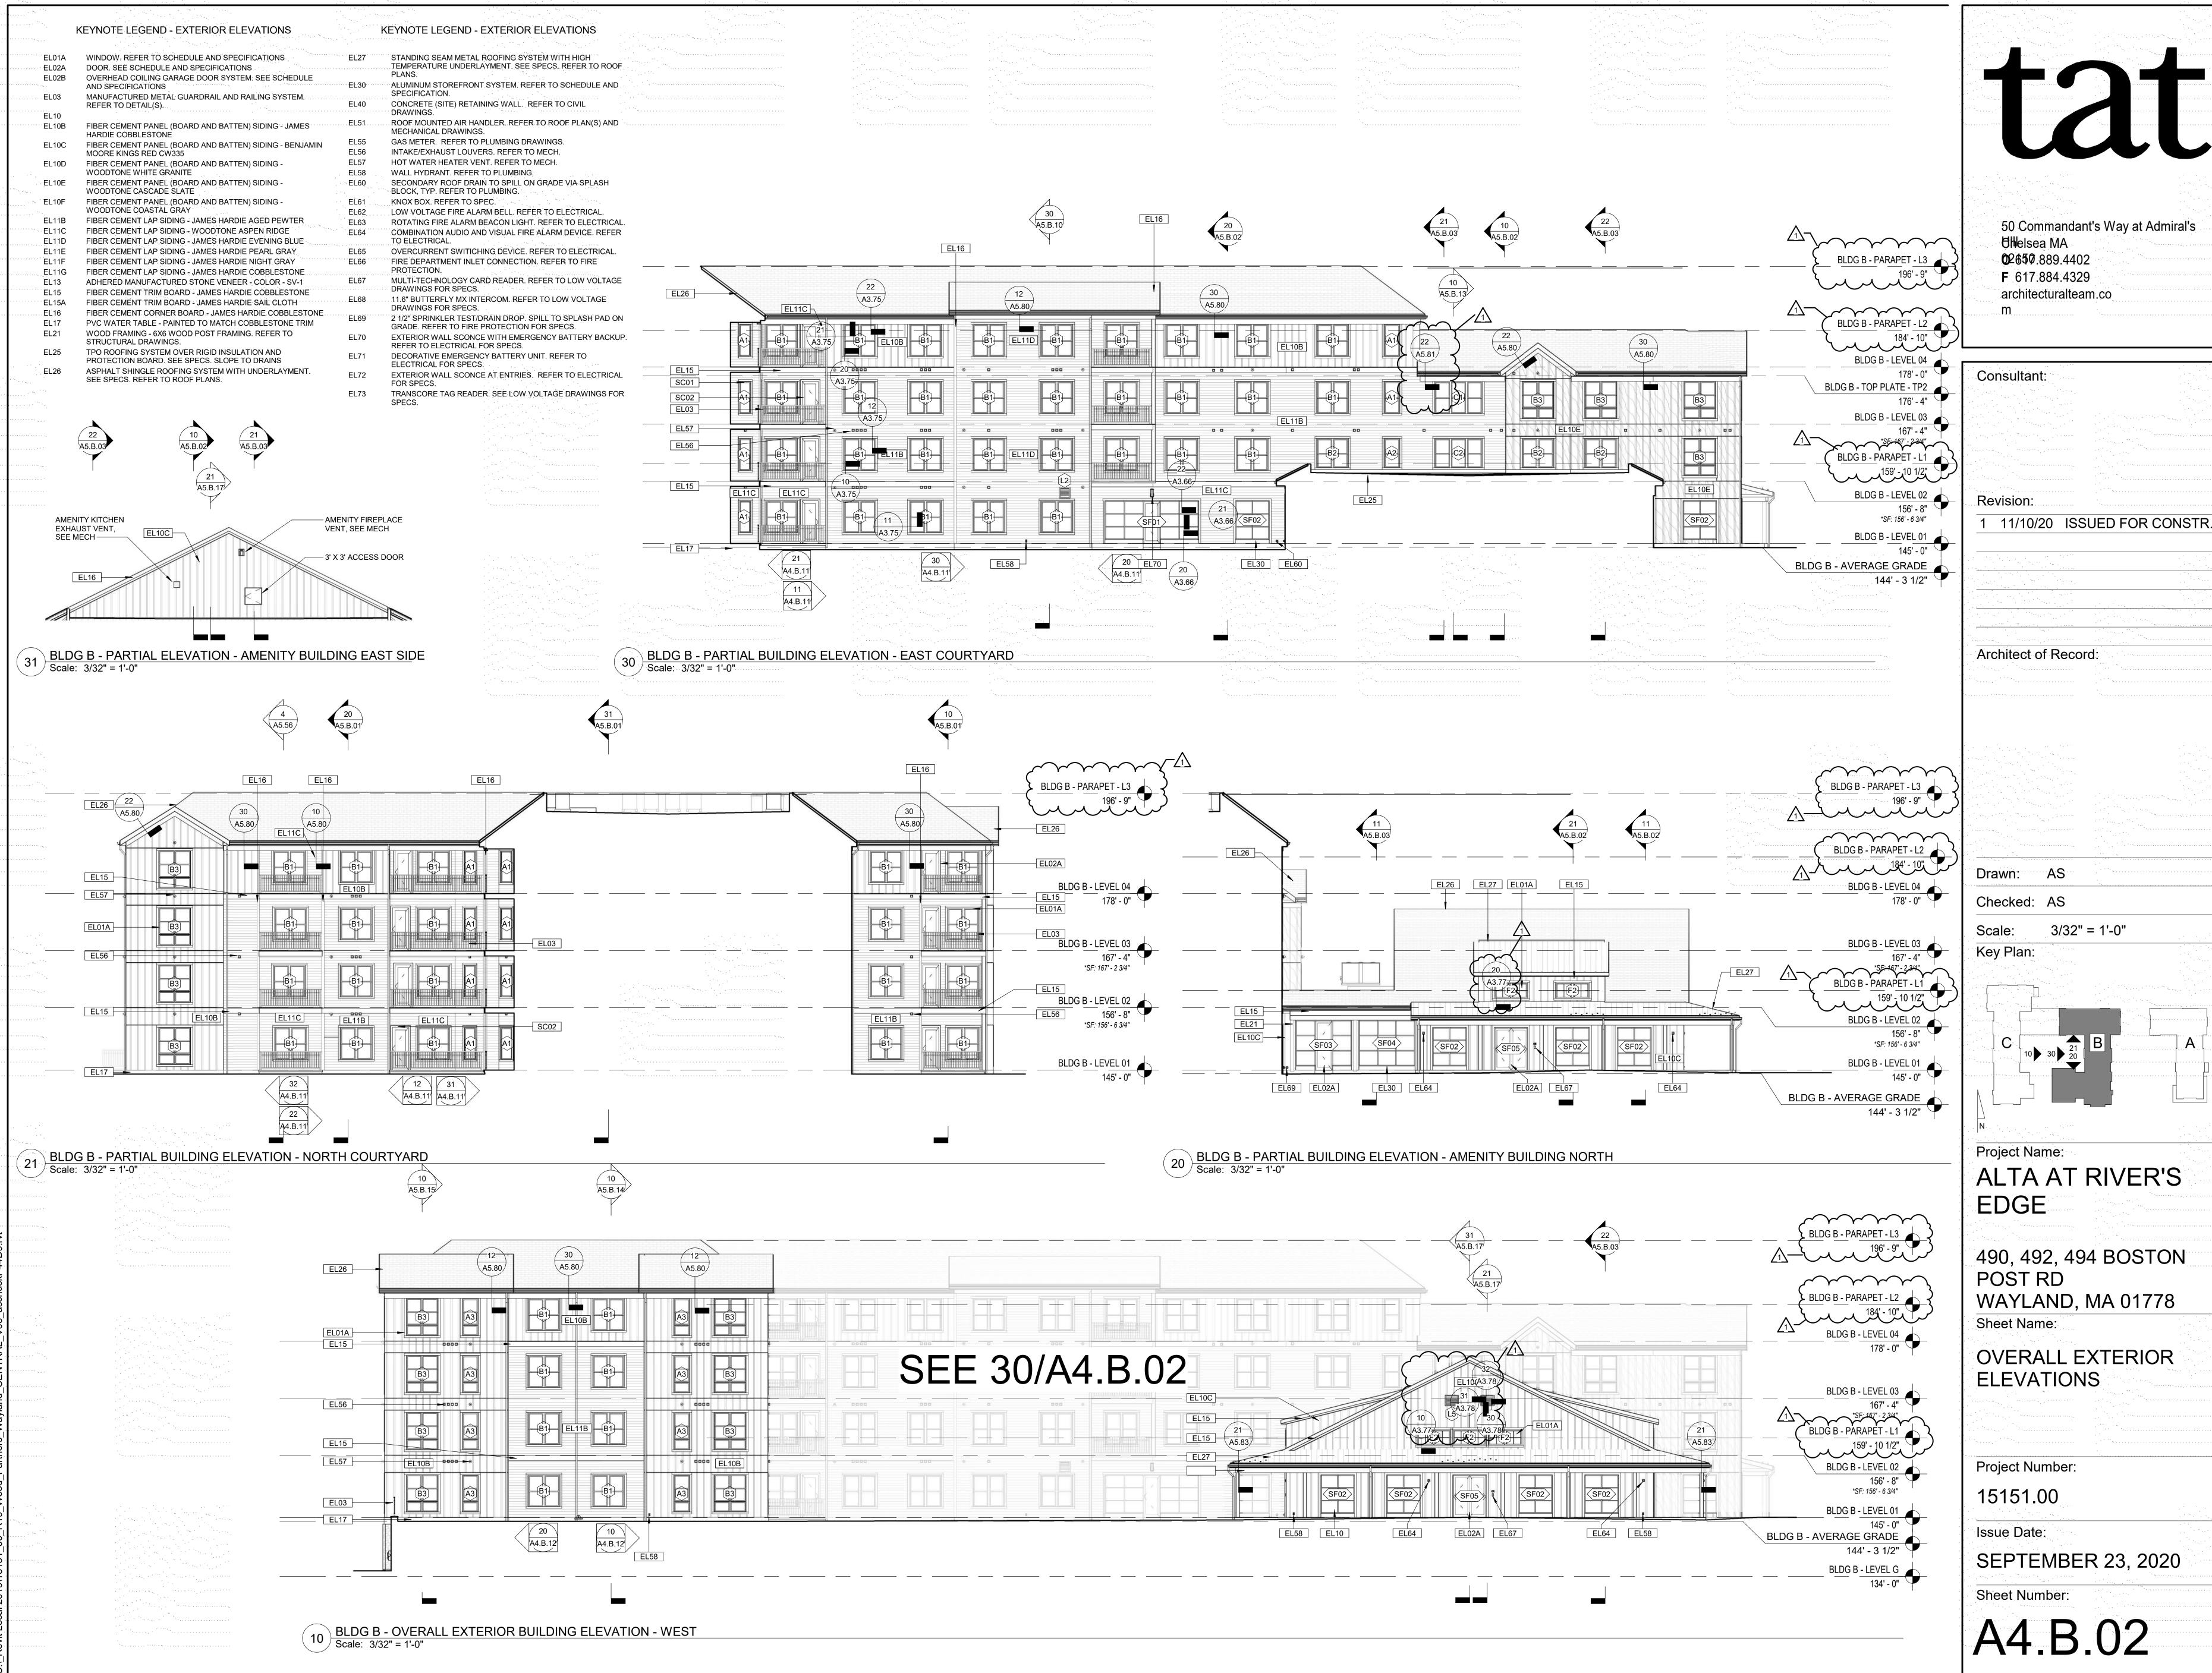
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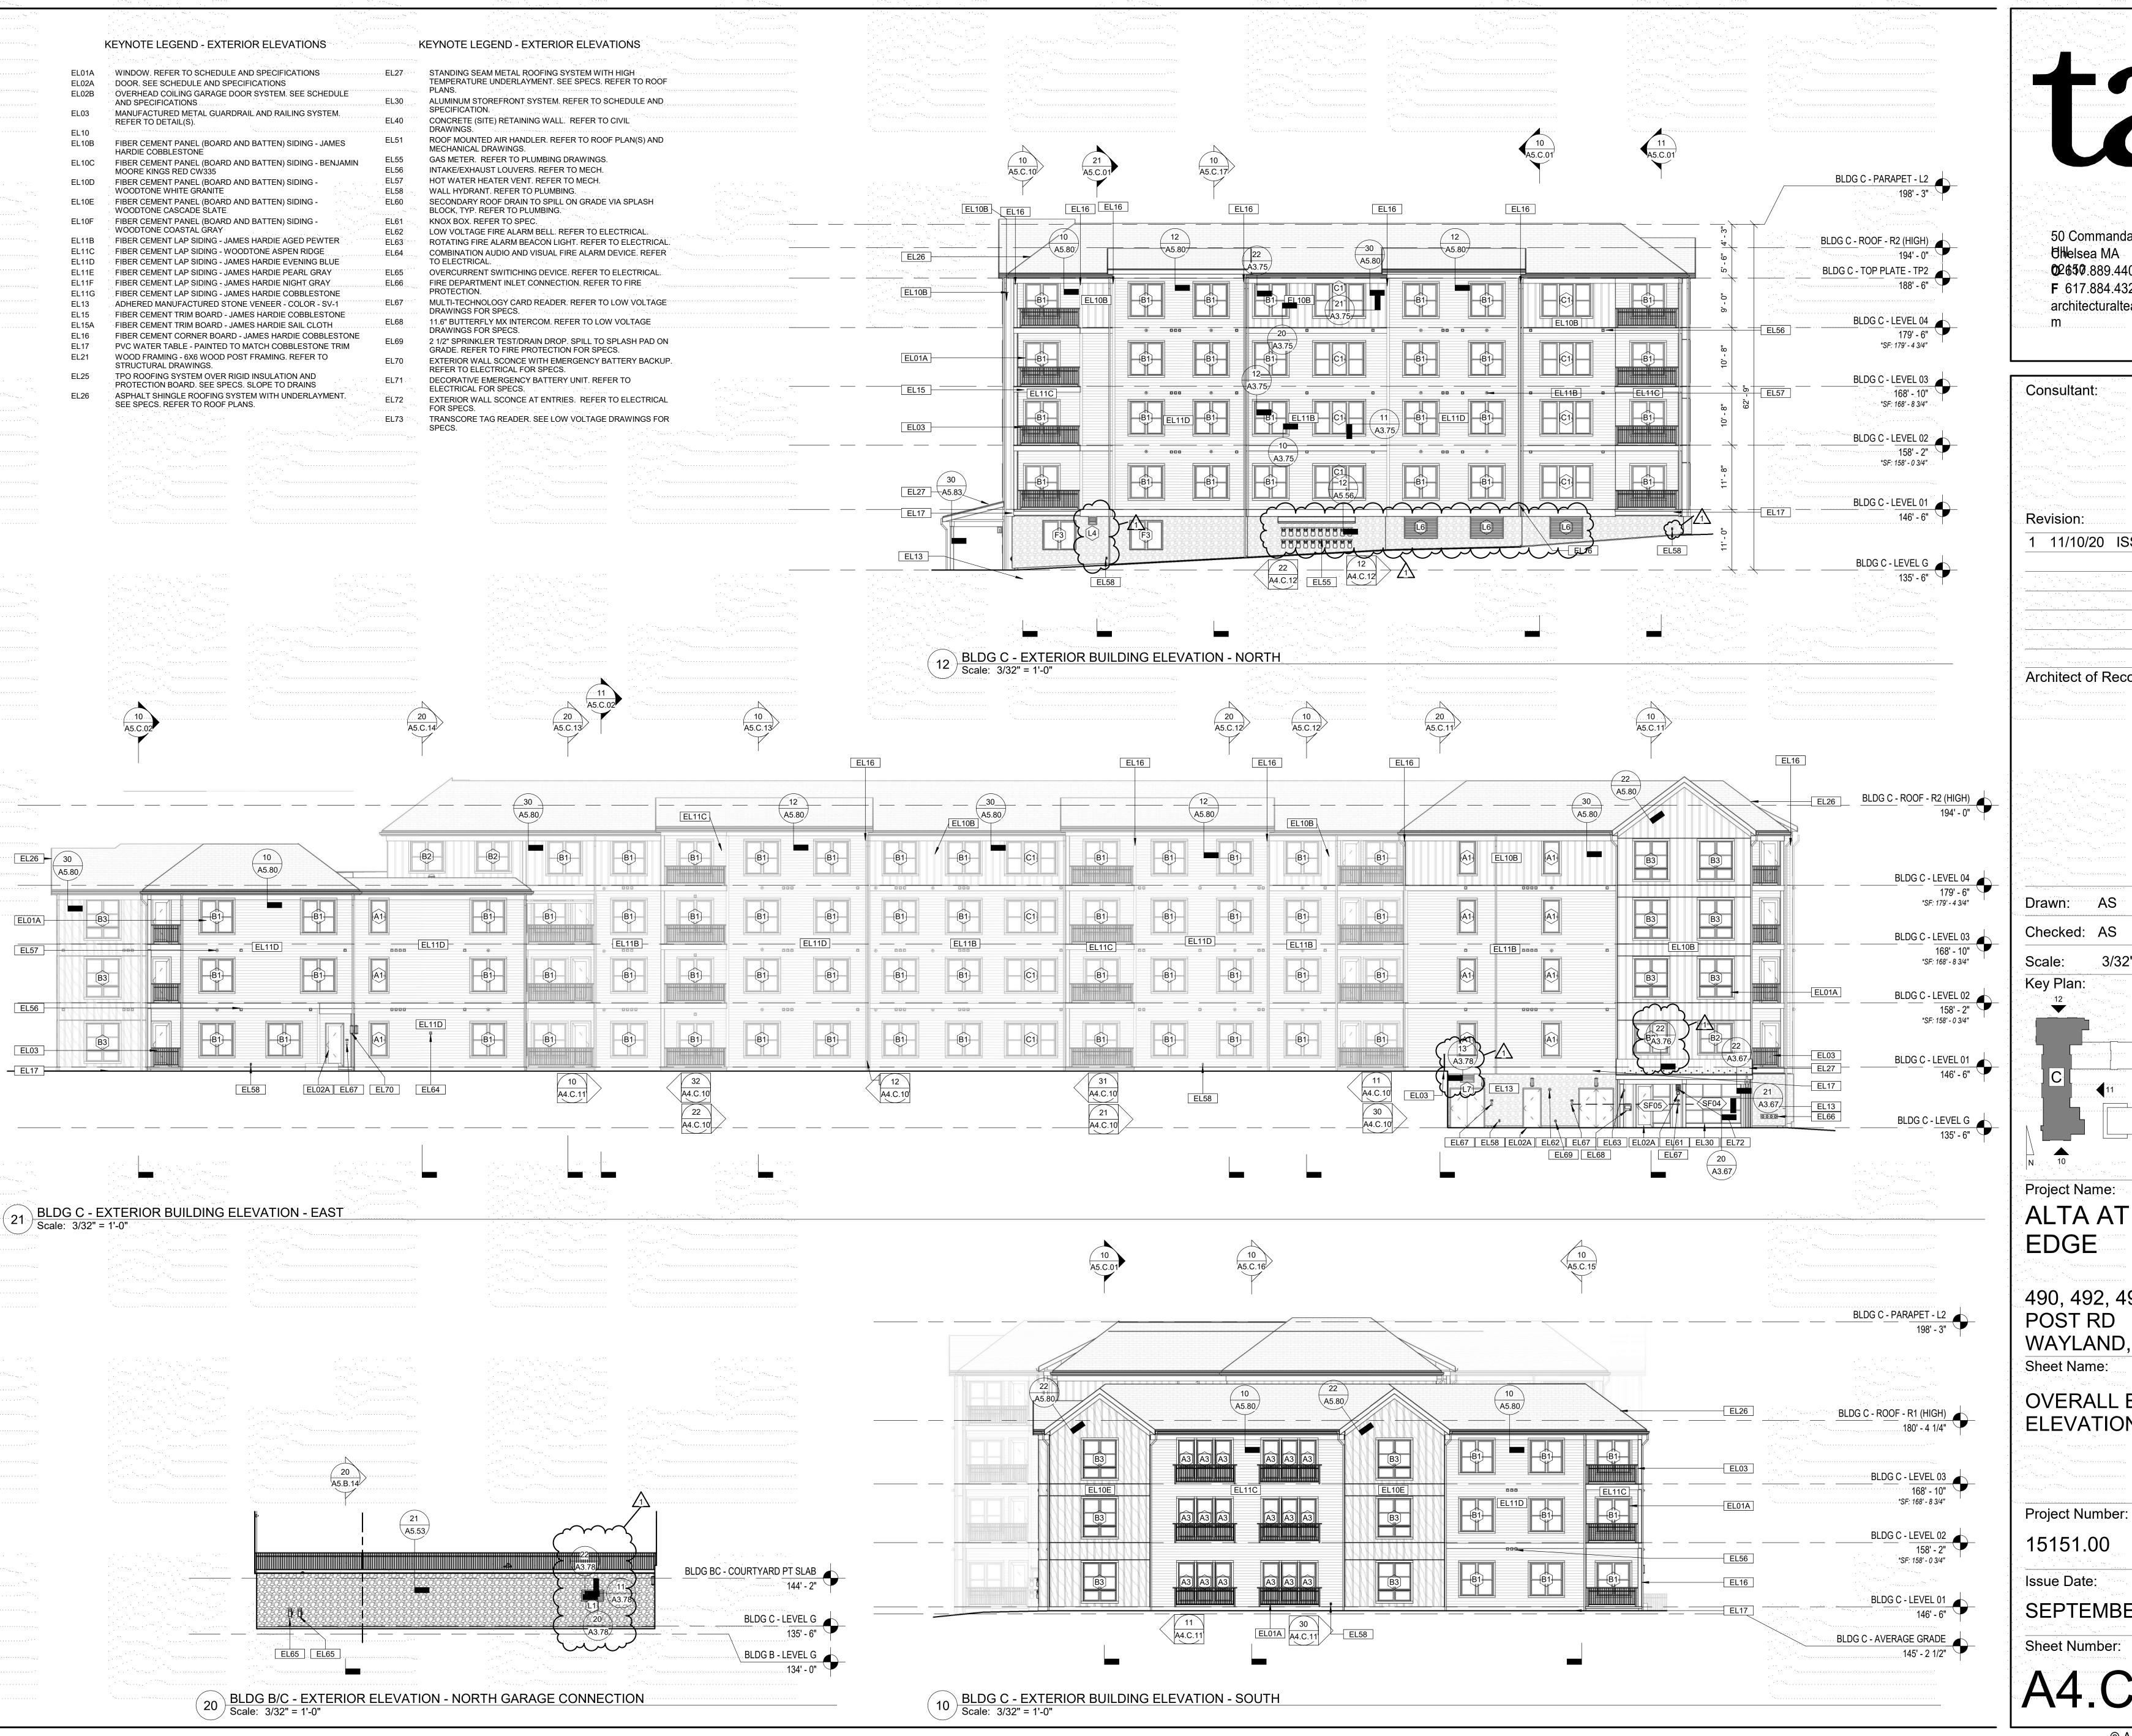
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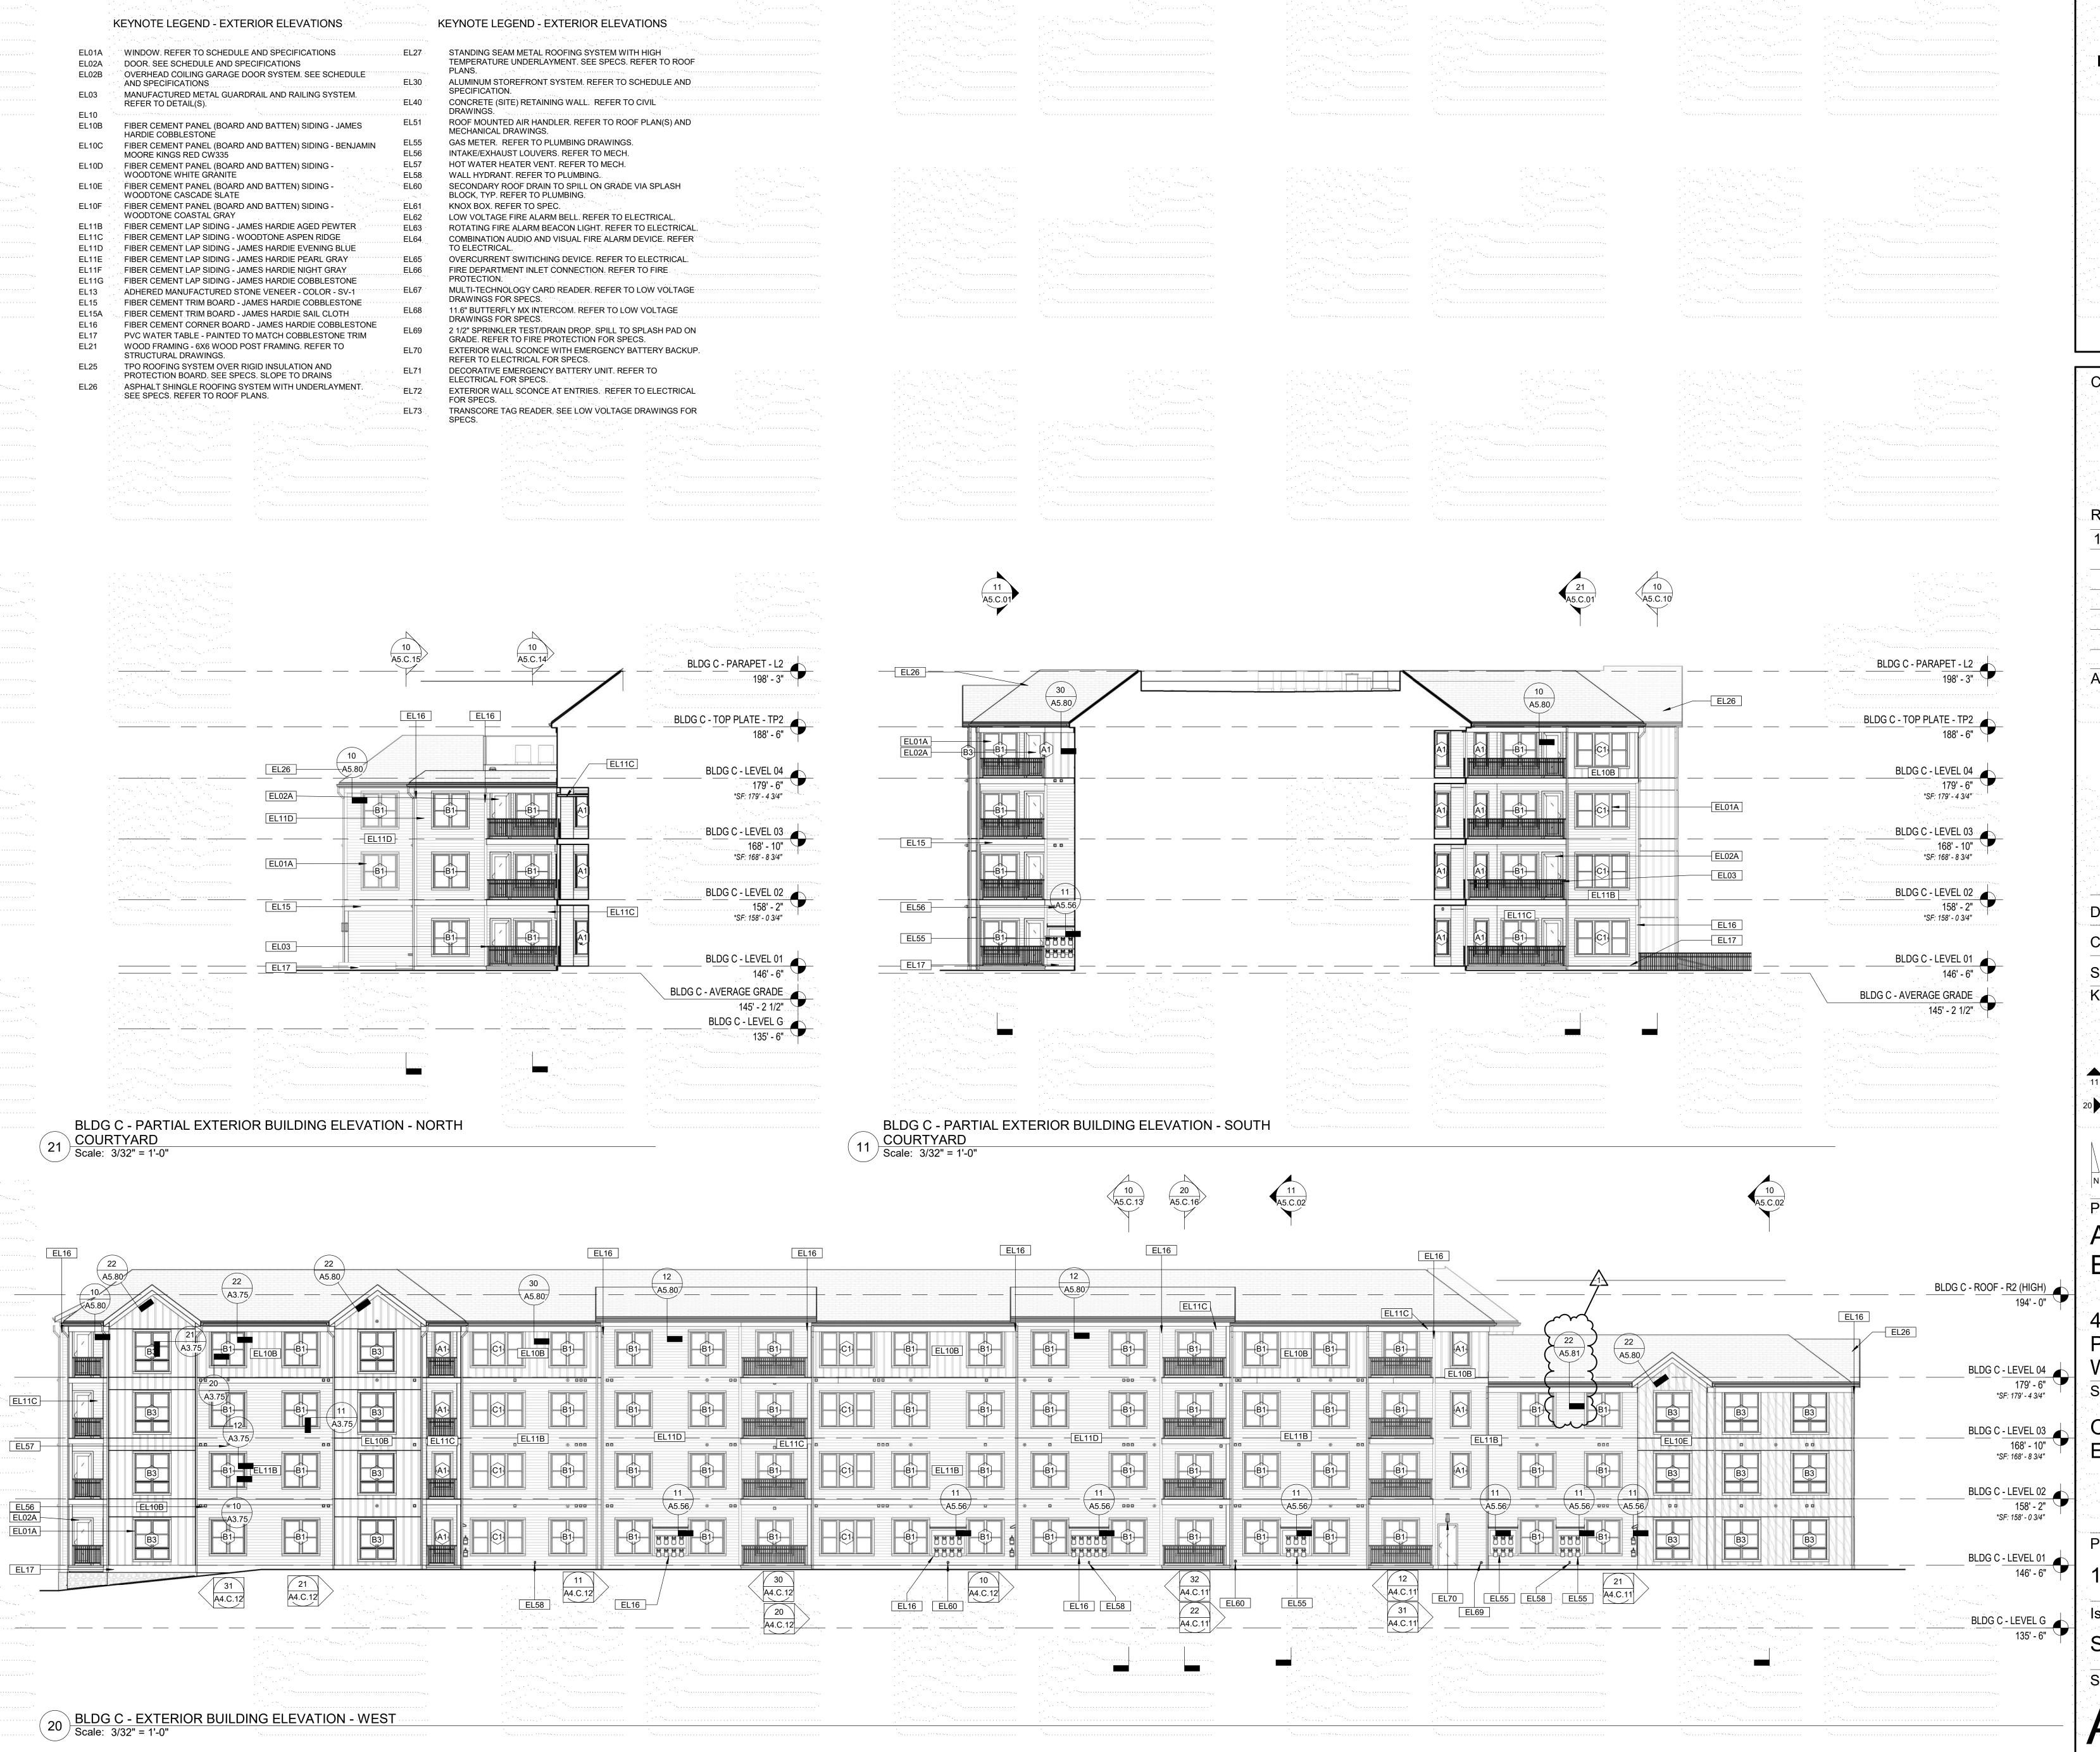
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OVERALL EXTERIOR ELEVATIONS
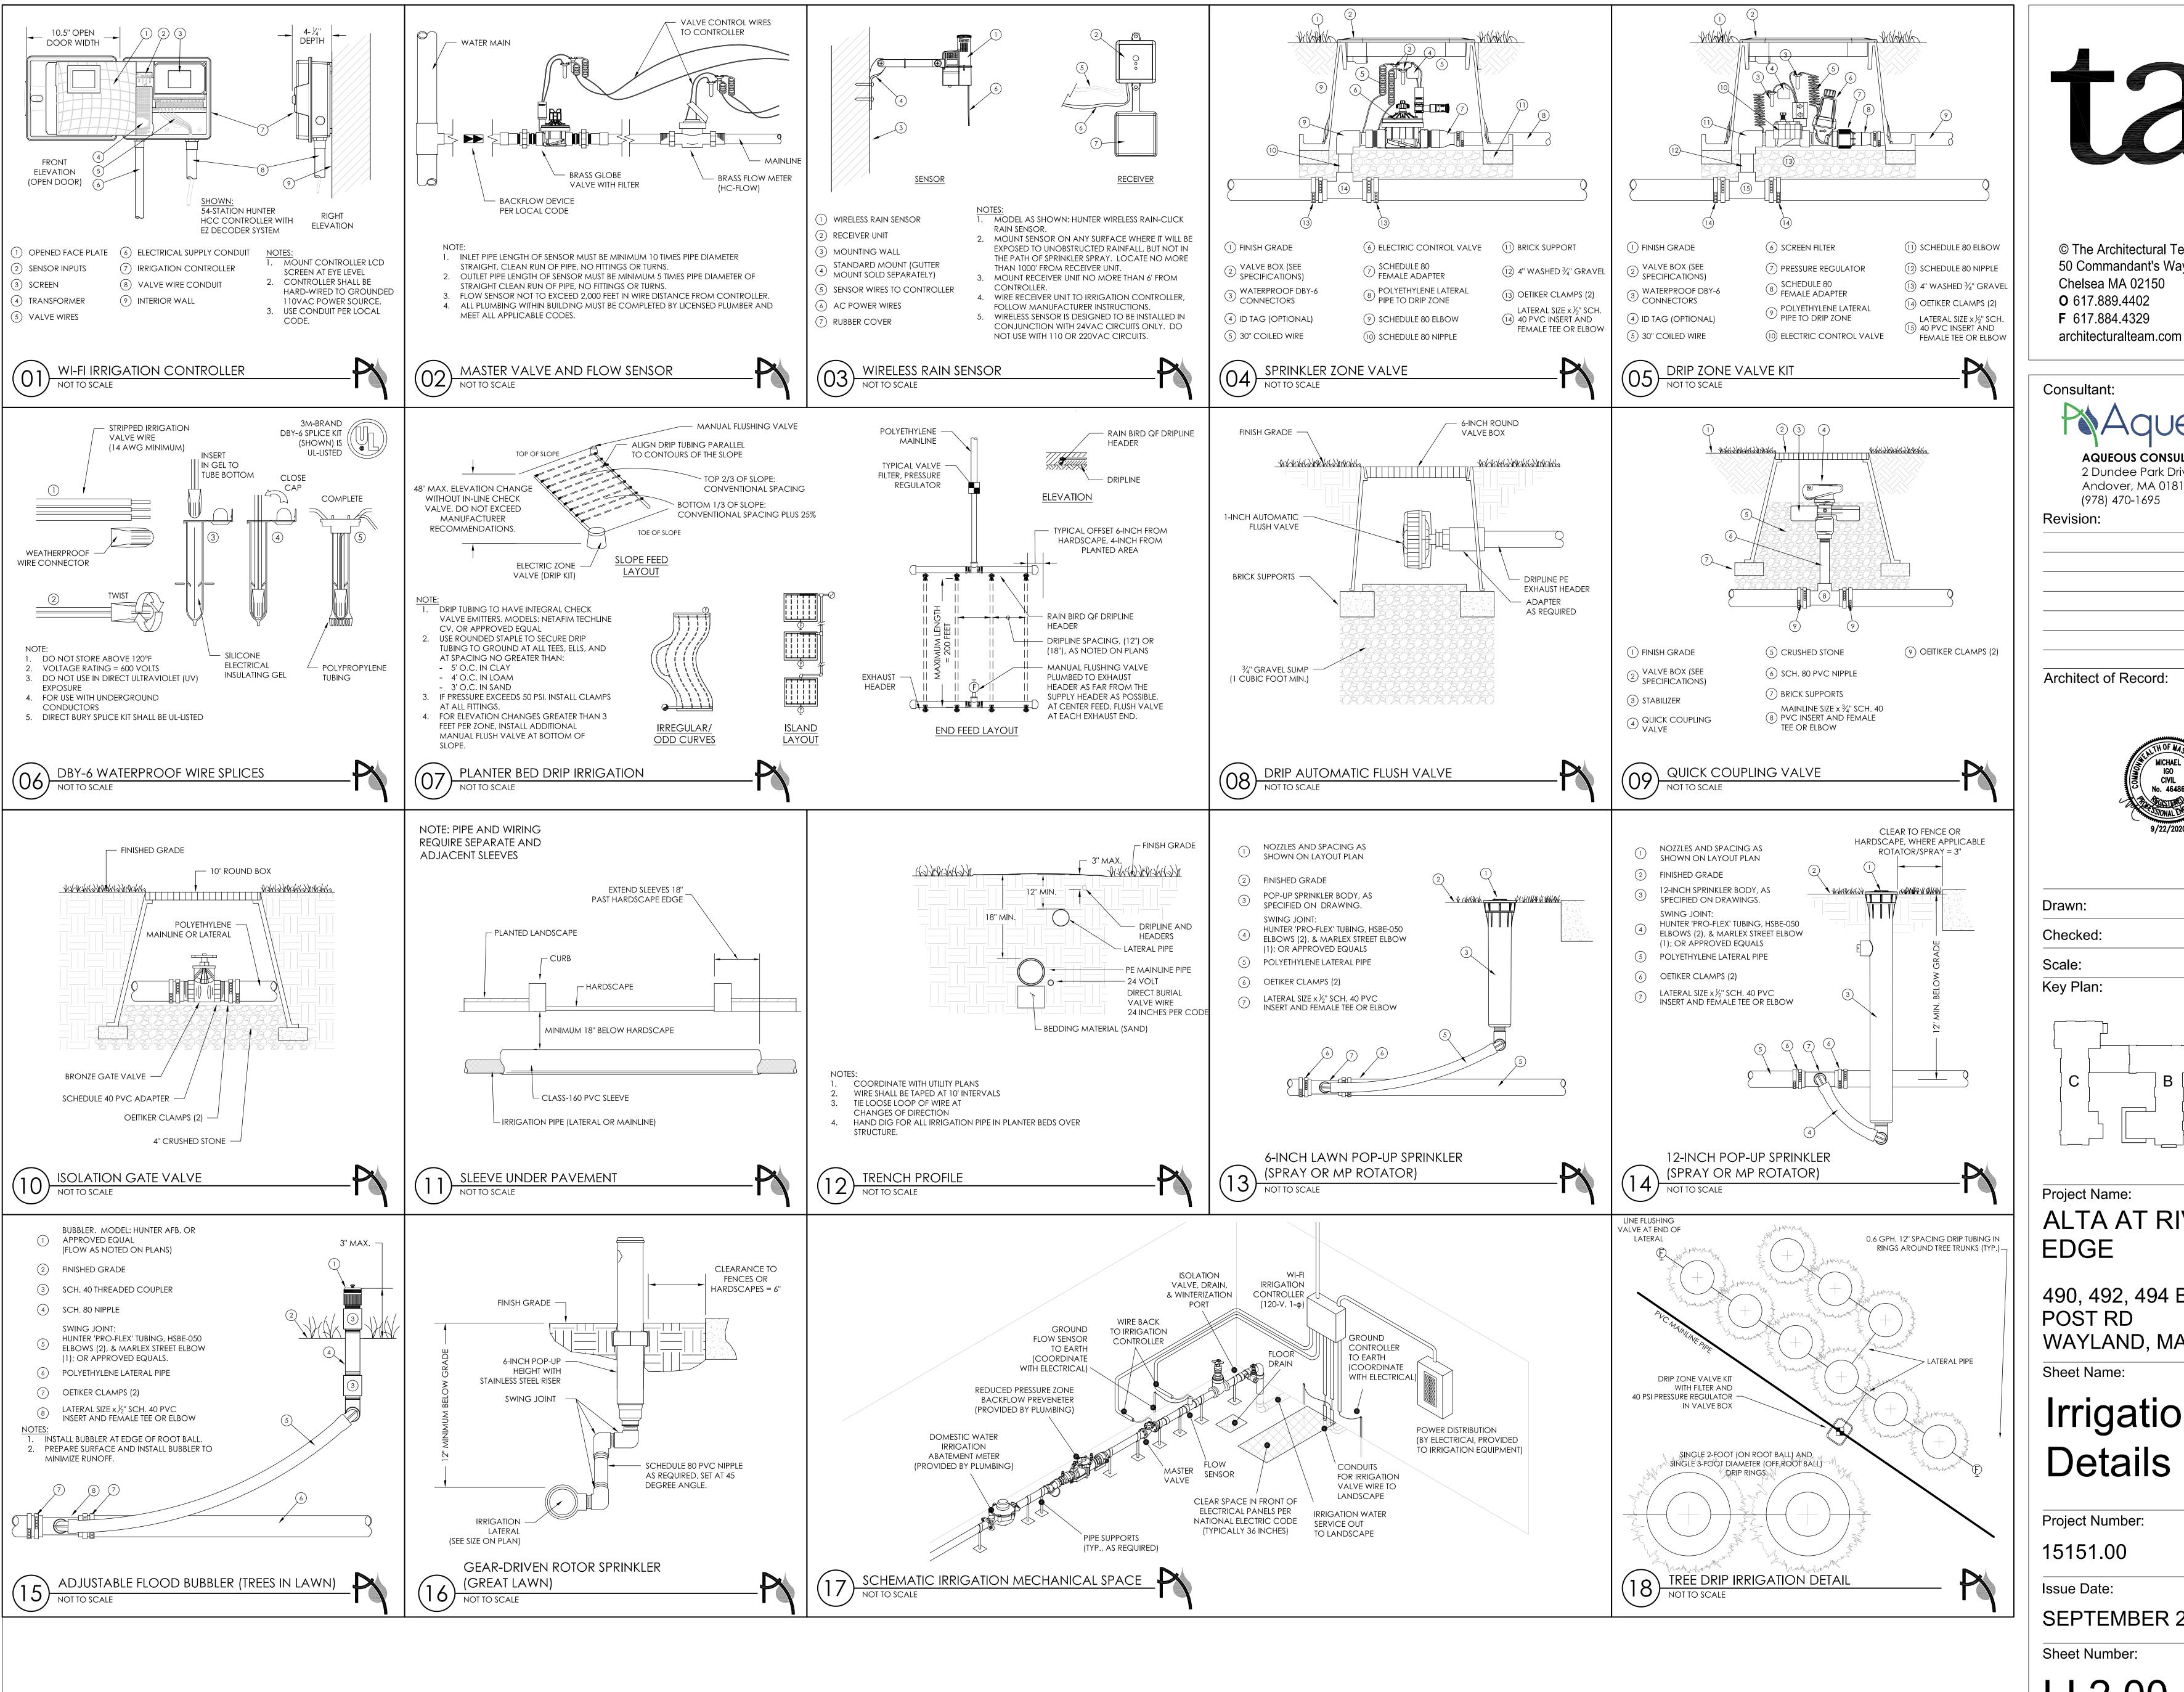
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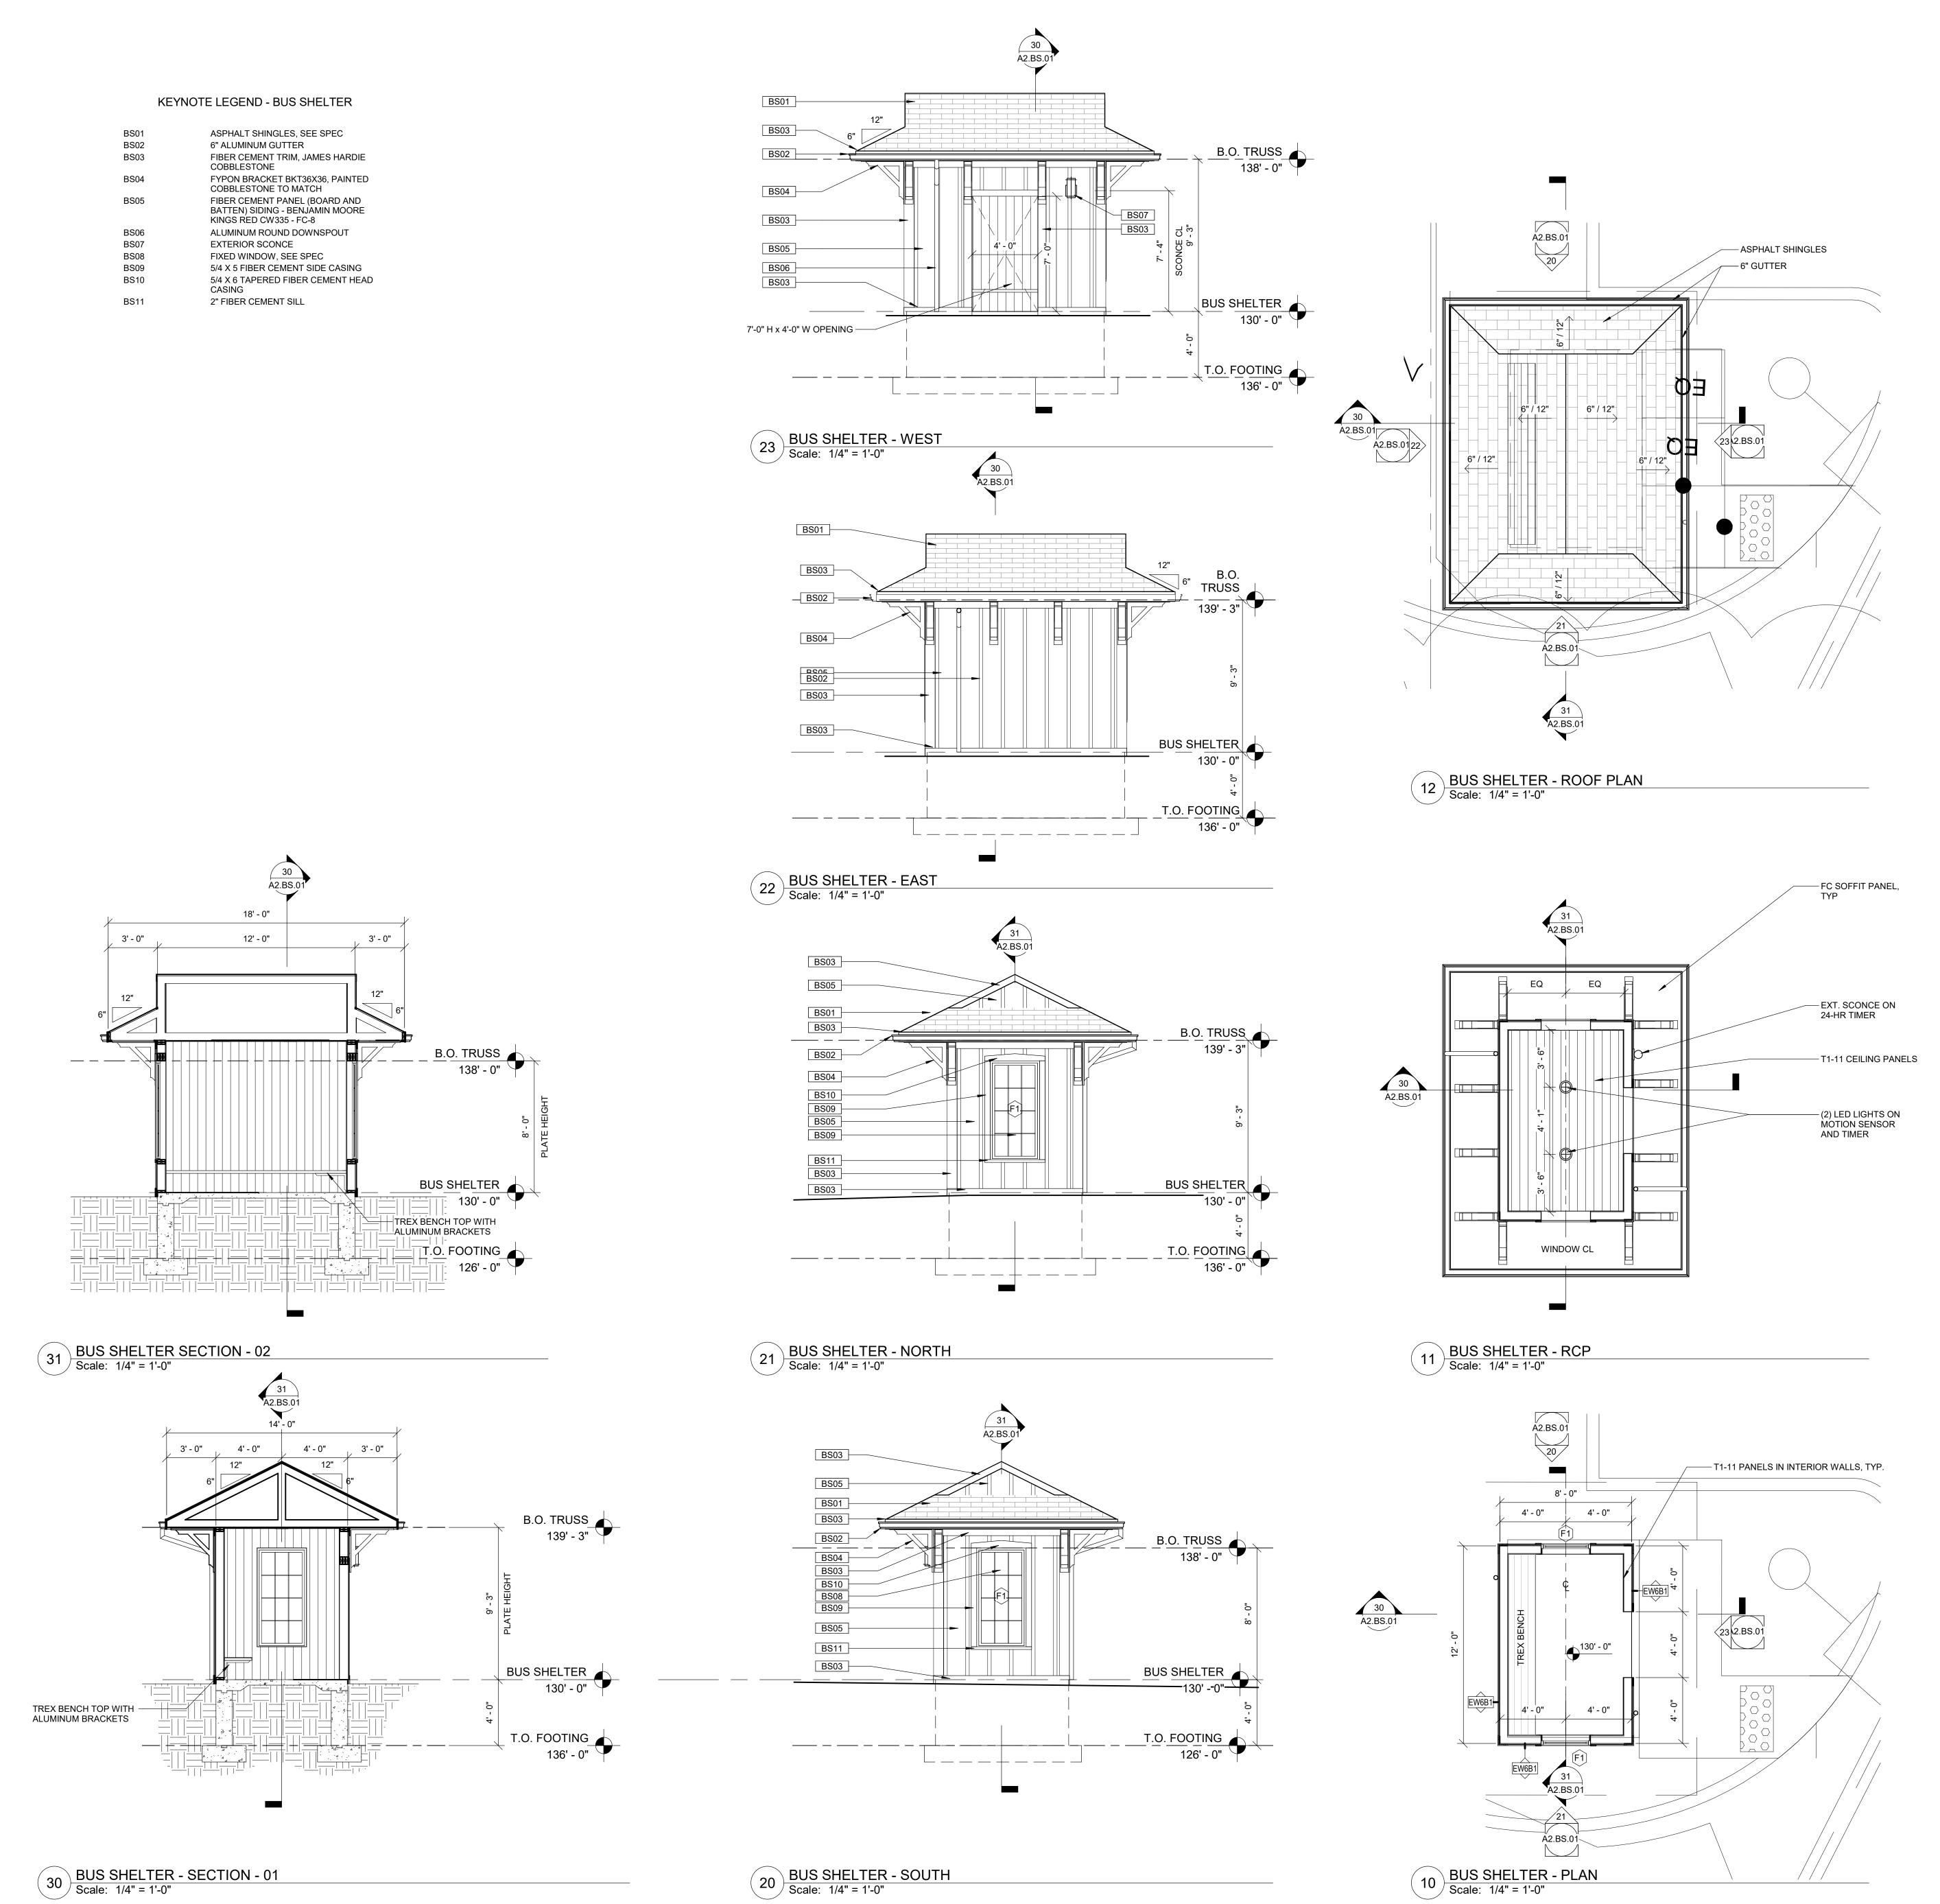
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Project Number:
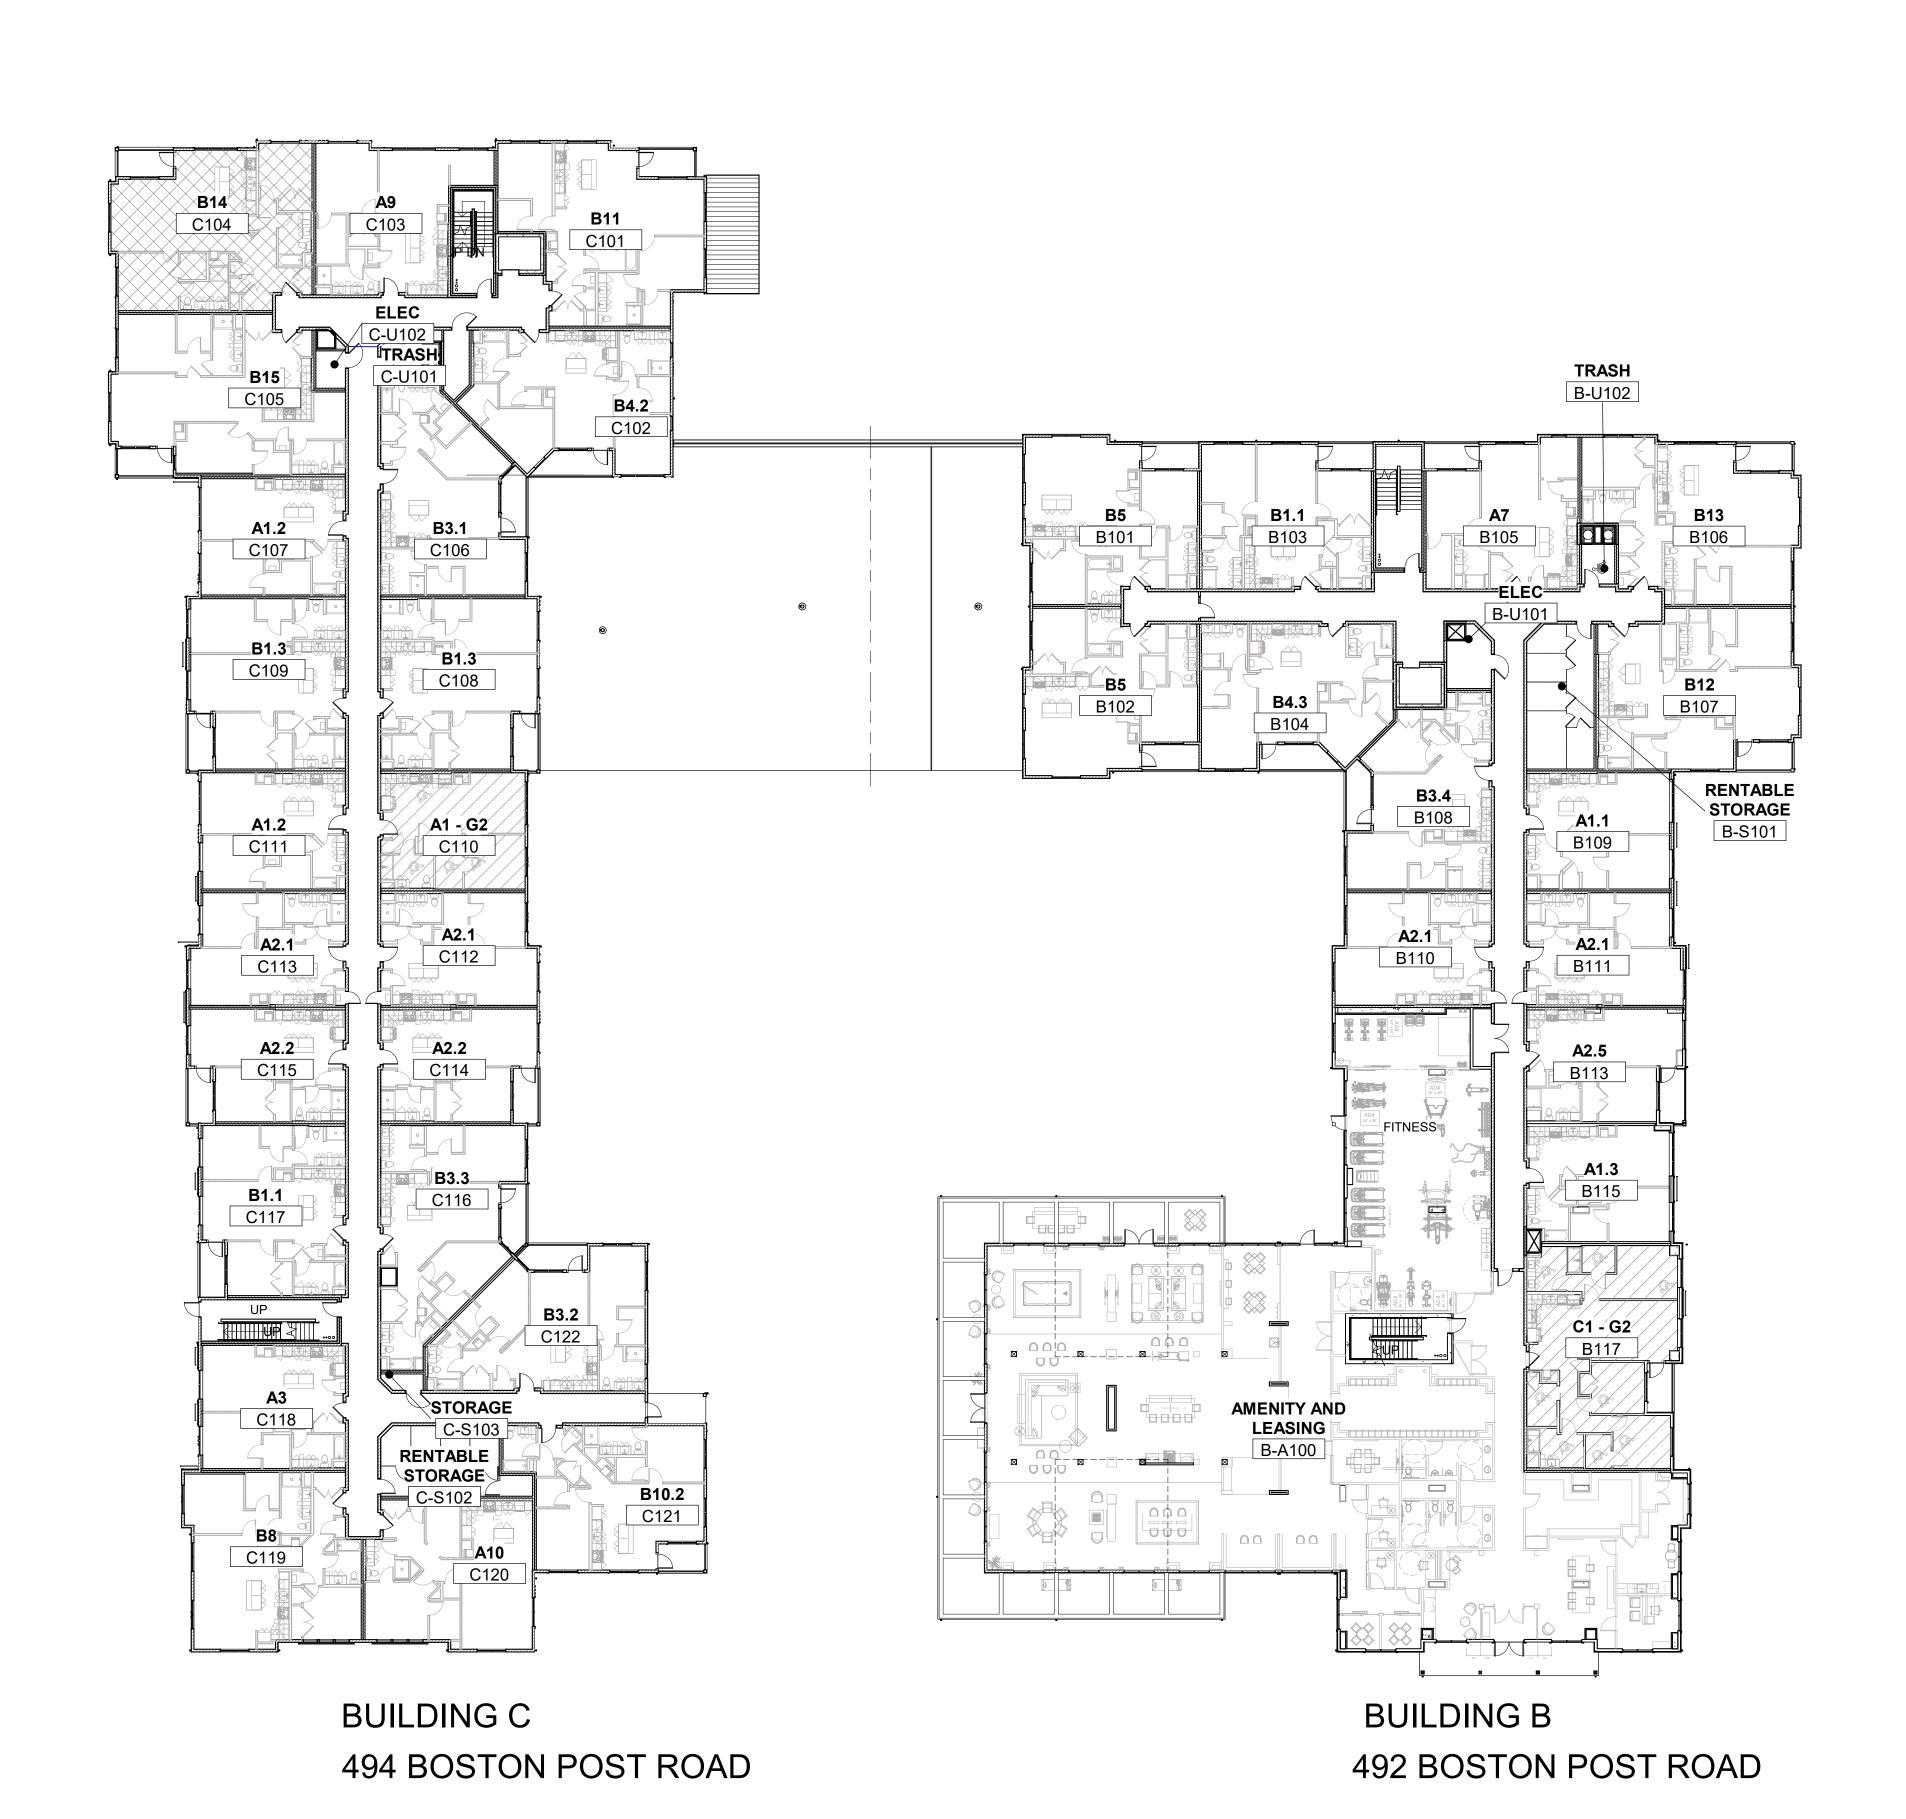
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Issue Date: **SEPTEMBER 23, 2020**

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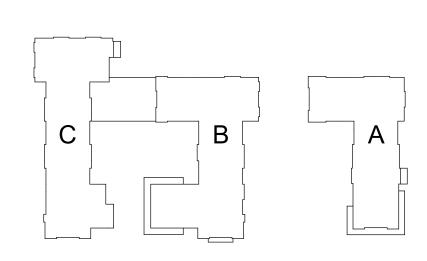


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