

NEIGHBORHOOD CONTEXTUAL WITH AERIAL PHOTOGRAPH MAP 1" = 500

• <u>Plan Scale: 1 inch = 10 feet or 1 inch = 20 feet;</u> A waiver is being requested such that the plans are drafted at a scale of 1 inch = 30 feet rather than the required 1 inch = 20 feet. This is BEING REQUESTED SO THAT THE ENTIRE PROJECT SITE CAN FIT ONTO A SINGLE

PERMIT SITE DEVELOPMENT PLANS FOR

COUNCIL ON AGING COMMUNITY CENTER

LOCATED AT

8 ANDREW AVENUE

(ASSESSORS MAP 23: LOTS 052L, 052U, 052K & 052S) LOCATED IN

WAYLAND, MASSACHUSETTS 01778

DATE: DECEMBER 7, 2022 REVISED: JANUARY 5, 2023 REVISED: JANUARY 16, 2023 REVISED: FEBRUARY 2, 2023 REVISED: FEBRUARY 10, 2023 REVISED: MARCH 1, 2023 REVISED: MARCH 17, 2023 REVISED: MAY 15, 2023

> OWNER/APPLICANT: TOWN OF WAYLAND 41 COCHITUATE ROAD WAYLAND, MASSACHUSETTS 01778

> > CIVIL ENGINEER:



BEVERLY, MASSACHUSETTS 01915 TELEPHONE: (978) 299-0447 WWW.MERIDIANASSOC.COM

COVER SHEET



DRAWING INDEX

CV O.O

ENDORSED BY WAYLAND PLANNING BOARD

IN ACCORDANCE WITH CERTIFICATE OF VOTE FOR

AMENDING THE WAYLAND TOWN CENTER MIXED-USE PROJECT MASTER SPECIAL PERMIT, SPECIAL PERMITS
AND SITE PLAN DECISION

LG 1.0 GENERAL NOTES & LEGEND RECORD CONDITIONS & DEMOLITION PLAN C 1.0 LAYOUT & MATERIALS PLAN C 2.0 LAYOUT & AREA CALCULATIONS PLAN C 2.1 C 3.0 GRADING & DRAINAGE PLAN C 4.0 UTILITY PLAN C 5.0 EROSION & SEDIMENTATION CONTROL PLAN SITE CONSTRUCTION DETAILS C 6.0 C 7.0 SITE CONSTRUCTION DETAILS C 8.0 SITE CONSTRUCTION DETAILS SITE CONSTRUCTION DETAILS C 9.0 L 1.0 LANDSCAPE PLAN L 2.0 LANDSCAPE DETAILS

REFERENCE DRAWINGS

SITE LIGHTING PLAN SZ1 OVERALL GROUND AND MEZZENINE FLOOR PLAN A 200 A 400 EXTERIOR ELEVATIONS

LIST OF REQUESTED PLAN WAIVERS: WAYLAND WETLANDS AND WATER RESOURCES BYLAW, CHAPTER 194 APPLICATION:

SHEET FOR EASE OF READABILITY AND REVIEW.

FOR PERMITTING ONLY NOT FOR CONSTRUCTION

RECORD CONDITIONS PLAN:

- 1. THE TOPOGRAPHY, SITE DETAIL & SURFACE IMPROVEMENTS DEPICTED HEREON WERE OBTAINED FROM AN INSTRUMENT SURVEY CONDUCTED ON THE GROUND BY TOWN OF WAYLAND SURVEYOR.
- 2. THE SUBJECT PROPERTY IS LOCATED IN THE LIMITED COMMERCIAL DISTRICT ZONE, THE AQUIFER PROTECTION OVERLAY DISTRICT AND THE MIXED-USE OVERLAY DISTRICT.
- 3. THE MIXED-USE OVERLAY DISTRICT (MUOD) COMPRISING THE LAND AS SHOWN ON PLATE 23 OF THE ATLAS OF THE TOWN OF WAYLAND, MASSACHUSETTS, 2002, NUMBERED AS PARCELS 23-052, 23-052B, 23-052C, AND 23-052F, AND AS SHOWN ON THE PLAN ENTITLED "TOWN OF WAYLAND MIXED-USE OVERLAY DISTRICT," SURVEY DEPARTMENT, 41 COCHITUATE ROAD, WAYLAND, MA 01778, DATED SEPTEMBER 6, 2005, A COPY OF WHICH IS ON FILE IN THE OFFICE OF THE TOWN CLERK
- 4. THE SUBJECT PROPERTY IS DEPICTED AS LOTS 052L, 052U, 052K AND 052S ON TOWN OF WAYLAND ASSESSOR'S MAP 23 FOR A TOTAL AREA OF APPROXIMATELY 181,520 SF (4.17 AC.)
- 5. THE LOCATION OF ALL UNDERGROUND UTILITIES SHOWN ARE APPROXIMATE AND ARE BASED UPON A PARTIAL FIELD SURVEY AND COMPILATION OF PLANS OF RECORD.
 MERIDIAN ASSOCIATES, INC. DOES NOT WARRANTY NOR GUARANTEE THE LOCATION OF ALL UTILITIES DEPICTED OR NOT DEPICTED. THE CONTRACTOR, PRIOR TO COMMENCEMENT OF CONSTRUCTION, SHALL VERIFY THE LOCATION OF ALL UTILITIES AND CONTACT DIG SAFE AT 811.
- 6. THIS PLAN DOES NOT SHOW ANY UNRECORDED OR UNWRITTEN EASEMENTS WHICH MAY EXIST. A REASONABLE AND DILIGENT ATTEMPT HAS BEEN MADE TO OBSERVE ANY APPARENT, VISIBLE USES OF THE LAND; HOWEVER, THIS DOES NOT CONSTITUTE A GUARANTEE THAT NO SUCH EASEMENTS EXIST.
- 7. THE ELEVATIONS DEPICTED HEREON WERE BASED ON THE NORTH AMERICAN VERTICAL DATUM OF 1988 (NAVD 88), AS DERIVED FROM GPS OBSERVATIONS.
- 8. PROPERTY LINES DEPICTED HEREON ARE BASED ON COMPILED DEEDS, PLANS OF RECORD AND AN ON THE GROUND INSTRUMENT SURVEY TO LOCATE PHYSICAL EVIDENCE OF PROPERTY BOUNDARIES. THIS PLAN IS NOT TO BE USED FOR THE RECONSTRUCTION OF BOUNDARY LINES NOR FOR TITLE INSURANCE PURPOSES.

GENERAL NOTES:

- 1. THE CONTRACTOR SHALL MAKE ALL NECESSARY CONSTRUCTION NOTIFICATIONS AND APPLY FOR AND OBTAIN ALL NECESSARY CONSTRUCTION PERMITS. THE CONTRACTOR SHALL ALSO PAY ALL FEES AND POST ALL BONDS ASSOCIATED WITH THE SAME, AND COORDINATE WITH THE OWNER AND ENGINEER AS REQUIRED.
- 2. CONTRACTOR SHALL BE SOLELY RESPONSIBLE FOR JOB SITE SAFETY AND ALL CONSTRUCTION MEANS AND METHODS.
- 3. LIMIT OF WORK SHALL BE SEDIMENT CONTROL BARRIERS, LIMIT OF GRADING AND SITE PROPERTY LINES AND/OR AS INDICATED ON DRAWINGS.
- 4. ANY ALTERATION TO THESE DRAWINGS MADE IN THE FIELD DURING CONSTRUCTION SHALL BE RECORDED BY THE CONTRACTOR ON RECORD DOCUMENTS.
- 5. ANY AREA OUTSIDE THE LIMIT OF WORK THAT IS DISTURBED SHALL BE RESTORED TO ITS ORIGINAL CONDITION AT NO COST TO OWNER.
- 6. EXISTING TREES AND SHRUBS OUTSIDE THE LIMITS OF WORK SHALL BE REMOVED ONLY UPON PRIOR APPROVAL OF THE OWNER.
- 7. FOR DRAWING LEGIBILITY, ALL EXISTING TOPOGRAPHIC FEATURES, EXISTING UTILITIES, PROPERTY BOUNDARIES, EASEMENTS, ETC. MAY NOT BE SHOWN ON ALL DRAWINGS. REFER TO ALL REFERENCED DRAWINGS AND OTHER DRAWINGS IN THIS SET FOR ADDITIONAL INFORMATION.
- 8. ALL EXCAVATORS OR CONTRACTORS MUST REFER TO 520 CMR 14.00 TO OBTAIN A TRENCH PERMIT PRIOR TO ANY CONSTRUCTION RELATED TRENCHES ON SITE.
- 9. THE CONTRACTOR SHALL BE RESPONSIBLE FOR COMPLIANCE WITH CONDITIONS THAT MAY BE PROMULGATED BY THE WAYLAND PLANNING BOARD, CONSERVATION COMMISSION AND MUNICIPAL AGENCIES.

LAYOUT NOTES:

- 1. ALL LINES AND DIMENSIONS ARE PARALLEL OR PERPENDICULAR TO THE LINES FROM WHICH THEY ARE MEASURED UNLESS OTHERWISE INDICATED.
- 2. COORDINATE THE LOCATION OF ALL SITE LIGHTING STANDARDS WITH IMPROVEMENTS SHOWN ON THESE DRAWINGS.
- 3. CONTRACTOR SHALL REPORT SIGNIFICANT CONFLICTS TO THE ARCHITECT FOR RESOLUTION.
- 4. DIMENSIONS FROM BUILDING ARE FROM FACE OF BUILDING. CONTRACTOR SHALL VERIFY ALL CONDITIONS IN THE FIELD AND REPORT ANY DISCREPANCIES TO THE ARCHITECT.
- 5. THE CONTRACTOR SHALL NOTIFY THE ARCHITECT AND ENGINEER OF ANY DISCREPANCIES BETWEEN SITE PLAN DIMENSIONS AND BUILDING PLANS BEFORE PROCEEDING WITH ANY PORTION OF SITE WORK WHICH MAY BE AFFECTED SO THAT PROPER ADJUSTMENTS TO THE SITE LAYOUT CAN BE MADE IF NECESSARY.
- 6. SEE ARCHITECTURAL DRAWINGS FOR EXACT BUILDING DIMENSIONS AND ALL DETAIL CONTIGUOUS TO THE BUILDING INCLUDING ENTRANCES, DOORWAY PADS, ETC.

GRADING AND UTILITY NOTES:

- 1. ALL SITE WORK SHALL MEET OR EXCEED THE SITE WORK SPECIFICATIONS PREPARED FOR THIS PROJECT. THE CONTRACTOR SHALL BE RESPONSIBLE FOR VERIFYING THAT
 THE PROPOSED IMPROVEMENTS SHOWN ON THE PLANS DO NOT CONFLICT WITH ANY KNOWN EXISTING OR OTHER PROPOSED IMPROVEMENTS. IF ANY CONFLICTS ARE
 DISCOVERED, THE CONTRACTOR SHALL NOTIFY THE OWNER AND THE ARCHITECT PRIOR TO INSTALLATION OF ANY PORTION OF THE SITE WORK WHICH WOULD BE AFFECTED.
- 2. AT ALL LOCATIONS WHERE EXISTING CURBING OR PAVEMENT ABUTS NEW CONSTRUCTION, THE EDGE OF THE EXISTING CURB OR PAVEMENT SHALL BE SAW CUT TO A CLEAN,
- SMOOTH EDGE. BLEND NEW PAVEMENT, CURBS AND EARTHWORK SMOOTHLY INTO EXISTING BY MATCHING LINES, GRADES AND JOINTS.

 3. THE CONTRACTOR SHALL VERIFY EXISTING GRADES IN THE FIELD AND REPORT ANY DISCREPANCIES IMMEDIATELY TO THE ENGINEER.
- 4. ALL UTILITY COVERS, GRATES, ETC. SHALL BE ADJUSTED TO BE FLUSH WITH THE PAVEMENT FINISH GRADE UNLESS OTHERWISE NOTED. RIM ELEVATIONS OF DRAINAGE STRUCTURES AND MANHOLES ARE APPROXIMATE.
- 5. PITCH EVENLY BETWEEN SPOT GRADES. ALL PAVED AREAS MUST PITCH TO DRAIN AT A MINIMUM OF 1/8" PER FOOT UNLESS SPECIFIED. ANY DISCREPANCIES NOT ALLOWING THIS MINIMUM PITCH SHALL BE REPORTED TO THE ENGINEER PRIOR TO CONTINUING WORK.
- 6. CONTRACTOR SHALL PROTECT ALL UNDERGROUND DRAINAGE, SEWER AND UTILITY FACILITIES FROM EXCESSIVE VEHICULAR LOADS DURING CONSTRUCTION. ANY DAMAGE TO THESE FACILITIES RESULTING FROM CONSTRUCTION LOADS WILL BE RESTORED TO ORIGINAL CONDITION AT NO COST TO OWNER.
- 7. EXCAVATION REQUIRED WITHIN THE PROXIMITY OF EXISTING UTILITY LINES SHALL BE DONE BY HAND. CONTRACTOR SHALL REPAIR ANY DAMAGE TO EXISTING UTILITY LINES
- OR STRUCTURES INCURRED DURING CONSTRUCTION OPERATIONS AT NO COST TO THE OWNER.

 8. THE CONTRACTOR SHALL SCHEDULE HIS WORK TO ALLOW THE FINISHED SUBGRADE ELEVATIONS TO DRAIN PROPERLY WITHOUT PUDDLING. SPECIFICALLY, ALLOW WATER TO ESCAPE WHERE PROPOSED CURB MAY RETAIN RUNOFF PRIOR TO APPLICATION OF THE FINISH SUBGRADE AND/OR SURFACE PAVING. PROVIDE TEMPORARY POSITIVE
- 9. COORDINATE UTILITY CONSTRUCTION WITH ALL TRADES AND CORRESPONDING DESIGN PLANS FOR CONNECTION TO EXISTING BUILDING AND SITE UTILITIES.
- 10. CONTRACTOR TO COORDINATE WITH FILTER MEDIA MANUFACTURER TO SIZE THE FILTER MEDIA CHAMBER SYSTEM. SHOULD AN ALTERNATE DEVICE BE REQUESTED, IT MUST BE APPROVED BY THE DESIGN ENGINEER.
- 11. A SEWER EJECTOR PUMP DETAIL HAS BEEN PROVIDED SHOULD IT BE REQUIRED. CONTRACTOR IS TO COORDINATE WITH THE MANUFACTURER FOR SIZING OF THE EJECTOR PUMP SYSTEM.
- 12. ALL MONITORING WELLS ARE TO BE BROUGHT FLUSH TO FINAL GRADES AND PROTECTED WITH A COVER THAT CAN BE USED TO ACCESS THE MONITORING WELL. THE TYPE OF COVER WILL DEPEND ON THE GROUND COVER ADJACENT TO THE MONITORING WELL.

PLANTING NOTES:

DRAINAGE AS REQUIRED.

- 1. RESTORE ALL DISTURBED AREAS AS SHOWN ON PLANS UNLESS OTHERWISE INDICATED.
- 2. DEGRADE STOCKPILE AREAS AFTER REMOVAL OF SURPLUS MATERIALS. SEED THE DISTURBED AREA UNLESS WITHIN EXISTING AGRICULTURAL ACCESS AREAS.
- 3. PLANTING SEED SHALL BE SOWN IN SEASONAL CONDITIONS AS APPROPRIATE FOR GOOD SEED SURVIVAL, OR AT SUCH TIMES AS APPROVED BY THE OWNER.
- 4. IF CERTAIN OF THE SEEDED AREAS DO NOT SHOW A PROMPT "CATCH", THESE SHALL BE RESEEDED AT THE SAME RATE AND IN THE SAME MANNER AS BEFORE IN INTERVALS OF TEN (10) DAYS, WHICH PROCESS SHALL CONTINUE UNTIL A GROWTH OF GRASS IS ESTABLISHED OVER THE ENTIRE AREA.
- 5. PROTECT NEWLY TOPSOILED, GRADED AND/OR SEEDED AREAS FROM TRAFFIC AND EROSION. KEEP AREAS FREE OF TRASH AND DEBRIS RESULTING FROM LANDSCAPE CONTRACTOR OPERATIONS.
- 6. REPAIR AND RE-ESTABLISH GRADES IN SETTLED, ERODED AND RUTTED AREAS TO THE SPECIFIED GRADE AND TOLERANCES.
- 7. ALL PLANT MATERIAL SHALL CONFORM TO THE MINIMUM GUIDELINES ESTABLISHED BY THE AMERICAN STANDARD FOR NURSERY STOCK PUBLISHED BY THE AMERICAN NURSERY AND LANDSCAPE ASSOCIATION.
- 8. ANY PROPOSED SUBSTITUTIONS OF PLANT MATERIAL SHALL BE MADE WITH MATERIAL EQUIVALENT TO THE DESIRED MATERIAL IN OVERALL FORM, HEIGHT. BRANCHING HABIT, FLOWER, LEAF, COLOR, FRUIT AND CULTURE. PROPOSED SUBSTITUTIONS WILL ONLY BE CONSIDERED IF SUBMITTED WITH ENUMERATED REASONS WHY SUBSTITUTIONS ARE PROPOSED.
- 9. ALL PLANTING BEDS TO BE FILLED WITH SOIL AND CROWNED ABOVE ADJACENT LAWN OR IMPROVED AREAS. ALL PLANTING BEDS TO BE MULCHED WITH AGED PINE BARK MULCH TO A DEPTH OF THREE (3) INCHES. EXCEPTION: WITHIN 100 YEAR FLOOD PLAIN, MAINTAIN EXISTING GRADES.
- 10. CAUTION SHALL BE USED NOT TO EXTEND MULCH LAYER ABOVE SOIL LEVEL AT TRUNK/STEMS OF INSTALLED PLANT MATERIAL
- 11. PROVIDE FIVE (5) FOOT DIAMETER MULCH CIRCLE AROUND ALL INDIVIDUAL TREE PLANTINGS AND CONTINUOUS MULCH BED AROUND SHRUB PLANTINGS.
- 12. VERIFY ALL EXISTING UTILITY LINES PRIOR TO PLANTING AND REPORT ANY CONFLICTS TO THE OWNER OR OWNER'S REPRESENTATIVE.
- 13. PLANT MATERIALS SHALL BEAR SAME RELATIONSHIP TO GRADE AS THEY BORE TO GRADE IN THE NURSERY.
- 14. TOPSOIL STRIPPED FROM THE SITE AND PROPERLY STOCKPILED PRIOR TO APPLICATION MAY, UPON APPROVAL OF THE LANDSCAPE ARCHITECT, BE USED FOR PREPARATION OF PLANTING BEDS. IT SHOULD BE FREE OF LARGE (ONE (1) INCH OR GREATER) COBBLES, ROOTS, OLD SOD, TRASH, WOOD OR OTHER CONTAMINANTS AND BE OF FRIABLE CONSISTENCY AND SUITABLE FOR PLANT GROWTH.
- 15. THE LANDSCAPE CONTRACTOR SHALL FURNISH TOPSOIL. TOPSOIL SHALL BE FERTILE, FRIABLE, NATURAL AND PRODUCTIVE TOPSOIL OF GOOD CLAY—LOAM TYPE. IT SHALL BE FREE OF WEED SEEDS. TOPSOIL SHALL BE WITHOUT ADMIXTURE OF SUBSOIL AND SHALL BE REASONABLY FREE OF STONES, LUMPS, ROOTS, STICKS AND OTHER FOREIGN MATTER. TOPSOIL SHALL NOT BE WORKED OR APPLIED IN A MUDDY OR WET CONDITION.
- 16. THE LANDSCAPE CONTRACTOR SHALL CLEAN UP AND REMOVE ANY DEBRIS FROM THE SITE CAUSED BY THE LANDSCAPE CONTRACTOR.
- 17. PLANT MATERIAL SHALL BE MAINTAINED BY THE LANDSCAPE CONTRACTOR WHILE THE PROJECT IS UNDERWAY.

FOR PERMITTING ONLY
NOT FOR CONSTRUCTION

EROSION AND SEDIMENTATION CONTROL NOTES:

- 1. CONSTRUCTION ACCESS TO THE SITE IS TO BE SOLELY FROM ROUTE 20. NO CONSTRUCTION ACCESS TO THE SITE IS TO BE PROVIDED FROM ANDREW AVENUE OR LILLIAN WAY.
- 2. REFER TO SHEET C5.0 FOR STORAGE AREAS OF MATERIALS, EQUIPMENT AND SOIL STOCKPILING. THESE LOCATIONS ARE APPROXIMATE AND MAY BE ADJUSTED AS NEEDED BY THE CONTRACTOR DURING THE CONSTRUCTION PROCESS.
- 3. UNDER NO CIRCUMSTANCES IS THE STORAGE OF MATERIALS, EQUIPMENT OR SOILS TO BE LOCATED ON OR IN THE VICINITY OF THE PROPOSED SUBSURFACE INFILTRATION SYSTEM.
- 4. SEDIMENT CONTROL BARRIER SHALL BE INSTALLED ALONG THE EDGE OF PROPOSED DEVELOPMENT AS INDICATED IN THE PLAN PRIOR TO THE COMMENCEMENT OF CONSTRUCTION OPERATIONS.
- 5. CONTRACTOR SHALL MAINTAIN ALL EROSION AND SEDIMENT CONTROL MEASURES DURING ENTIRE CONSTRUCTION PERIOD.
- 6. ANY SEDIMENT TRACKED ONTO PUBLIC RIGHT-OF-WAYS SHALL BE SWEPT AT THE END OF EACH WORKING DAY
- 7. ALL STOCKPILE AREAS SHALL BE LOCATED WITHIN LIMIT OF WORK LINE AND STABILIZED TO PREVENT EROSION.
- 8. ALL DEBRIS GENERATED DURING SITE PREPARATION ACTIVITIES SHALL BE LEGALLY DISPOSED OF.
- 9. PROVIDE CRIBBING AS NECESSARY TO PROTECT EXISTING UTILITY LINES DURING CONSTRUCTION.
- 10. SITE ELEMENTS TO REMAIN MUST BE PROTECTED FOR DURATION OF PROJECT.
- 11. ADDITIONAL EROSION AND SEDIMENT CONTROL MEASURES SHALL BE IMPLEMENTED AS CONDITIONS WARRANT OR AS DIRECTED BY THE OWNER OR OWNER'S REPRESENTATIVE
- 12. ALL POINTS OF CONSTRUCTION EGRESS OR INGRESS SHALL BE MAINTAINED TO PREVENT TRACKING OR FLOWING OF SEDIMENT ONTO PUBLIC ROADS.
- 13. SOIL EROSION AND SEDIMENTATION CONTROL MEASURES SHALL BE INSPECTED AND MAINTAINED ON A DAILY BASIS DURING CONSTRUCTION TO ENSURE THAT THE EROSION CONTROL BARRIERS ARE INTACT.
- 14. DUST SHALL BE CONTROLLER BY SPRINKLING OR OTHER APPROVED METHODS AS NECESSARY, OR AS DIRECTED BY THE OWNER OR OWNER'S REPRESENTATIVE.
- 15. CLEAN AND MAINTAIN SEDIMENT CONTROL BARRIER AS REQUIRED DURING CONSTRUCTION OPERATIONS TO ENSURE ITS CONTINUED FUNCTIONALITY.
- 16. COMMON FILL (SITE GRADING AREAS) SHALL CONSIST OF MINERAL SOIL SUBSTANTIALLY FREE FROM ORGANIC MATERIALS, LOAM, WOOD TRASH AND OTHER OBJECTIONABLE MATERIALS WHICH MAY BE COMPRESSIBLE OR WHICH CANNOT BE PROPERLY COMPACTED. SELECT COMMON FILL SHALL NOT CONTAIN STONES LARGER THAN 2—IN. IN LARGEST DIAMETER AND SHALL HAVE A MAXIMUM OF 75% PASSING THE NO. 40 SIEVE AND A MAXIMUM OF 20% PASSING THE NO. 200 SIEVE. SELECT COMMON FILL SHALL NOT CONTAIN GRANITE BLOCKS, BROKEN CONCRETE, MASONRY RUBBLE OR OTHER SIMILAR MATERIALS. IT SHALL HAVE PHYSICAL PROPERTIES SUCH THAT IT CAN BE READILY SPREAD AND COMPACTED DURING FILLING. SNOW, ICE AND FROZEN SOIL WILL NOT BE PERMITTED. SOIL EXCAVATED FROM THE STRUCTURE AREAS AND WHICH MEETS THE ABOVE REQUIREMENTS MAY BE USED.
- 17. ORDINARY FILL SHALL BE WELL GRADED, NATURAL INORGANIC SOIL, FREE OF ORGANIC OR OTHER WEAK OR COMPRESSIBLE MATERIALS, FROZEN MATERIALS, AND OF STONES LARGER THAN TWO THIRDS (2/3) THE LIFT THICKNESS. IT SHALL BE OF SUCH NATURE AND CHARACTER THAT IT CAN BE COMPACTED TO THE SPECIFIED DENSITIES IN A REASONABLE LENGTH OF TIME. IT SHALL BE FREE OF PLASTIC CLAY, OF ALL MATERIALS SUBJECT TO DECAY, DECOMPOSITION, OR DISSOLUTION, AND OF CINDERS OR OTHER MATERIALS THAT WILL CORRODE PIPING OR OTHER METAL. IT SHALL HAVE A MINIMUM DRY DENSITY OF NOT LESS THAN 120 POUNDS PER CUBIC FOOT. MATERIAL FROM EXCAVATION ON THE SITE MAY BE USED AS ORDINARY FILL IF IT MEETS THE ABOVE REQUIREMENTS. ORDINARY FILL SHALL HAVE A MAXIMUM OF 60% PASSING THE #40 SIEVE, AND A MAXIMUM OF 20% PASSING THE #200 SIEVE. IT SHOULD NOT CONTAIN BROKEN CONCRETE, MASONRY RUBBLE OR OTHER SIMILAR MATERIALS, AND SHALL HAVE PHYSICAL PROPERTIES SUCH THAT IT CAN BE READILY SPREAD AND COMPACTED DURING FILLING. SNOW, ICE AND FROZEN SOIL SHALL NOT BE PERMITTED.
- 18. SELECT COMMON FILL (ROADWAY AREAS) SHALL BE PLACED IN LAYERS HAVING A MAXIMUM THICKNESS OF 8 IN. MEASURED BEFORE COMPACTION. EACH LAYER OF FILL SHALL BE COMPACTED TO AT LEAST 95 PERCENT OF MAXIMUM DRY DENSITY DETERMINED BY THE ASTM D1557. COMPACTION OF STRUCTURAL FILL SHALL CONSIST OF FULLY LOADED TEN WHEEL TRUCKS, A TRACTOR DOZER WEIGHING AT LEAST 30,000 LBS AND OPERATED AT FULL SPEED, A HEAVY VIBRATORY ROLLER, OR OTHER METHOD ONLY AS APPROVED BY THE ENGINEER. COMPACTION OF SELECT COMMON FILL IN CONFINED AREAS ADJACENT TO STRUCTURES SHALL BE ACCOMPLISHED BY HAND OPERATED VIBRATORY EQUIPMENT OR MECHANICAL TAMPERS APPROVED BY THE ENGINEER. AS A MINIMUM, COMPACTION OF SELECT COMMON FILL SHALL CONSIST OF FOUR COVERAGES OF THE APPROVED EQUIPMENT.
- 19. EROSION AND SEDIMENT CONTROL, BOTH DURING AND AFTER CONSTRUCTION, SHALL BE PROVIDED AS REQUIRED TO RETAIN SEDIMENT ONSITE, AND TO CONTROL EROSION OF EMBANKMENTS, TEMPORARY AND FINAL EXPOSED SLOPES, AND TEMPORARY MATERIAL STOCKPILE(S). SILT FENCES, CHECK DAMS, DRAINAGE DITCHES OR SWALES, TEMPORARY SEEDING, AND PRE-MANUFACTURED TEXTILES, GEOTUBES, GEOGRID, CELLULAR GEOWEB, ETC., SHALL BE UTILIZED AS APPROPRIATE. EROSION AND SETTLEMENT CONTROL MEASURES SHALL BE IN ACCORDANCE WITH ALL PERMITS AND CODES AND THIS SPECIFICATION. DURING THE EXCAVATION OF THE WORK AT THE SITE, OPERATIONS SHALL BE CONTINUOUSLY MONITORED TO AVOID THE CREATION OF CONDITIONS THAT COULD LEAD TO EXCESSIVE EROSION OF SOIL WITH SURFACE RUNOFF FROM THE WORK AREAS. CONTROLS SHALL BE PROVIDED TO PROTECT THE WATER QUALITY AND SHALL BE IN ACCORDANCE WITH PROJECT DOCUMENTS AND ALL LOCAL, STATE AND FEDERAL LAWS AND REGULATIONS. EROSION CONTROL MEASURES SHALL BE EMPLOYED TO REDUCE EROSION OF SLOPES AND SILTATION OF OFF-SITE OUTFALLS AND TRIBUTARIES.
- 20. UPON SIGNS OF CONCENTRATED FLOW BY EVIDENCE OF GULLYING OR RILLING IN DISTURBED AREAS, HAYBALES AND/OR STONE CHECK DAMS SHALL BE PLACED IN THESE AREAS, SPACED EVERY 50' IN THE UPGRADIENT SLOPE.

DEMOLITION NOTES:

<u>EXISTING LEGEND</u>


NHESP PRIORITY HABITAT OF

RARE SPECIES

- 1. CONTRACTOR IS RESPONSIBLE FOR REMOVAL OF ALL EXISTING WATER, SEWER, GAS, ELECTRICAL, AND COMMUNICATIONS SERVICES, NOTED TO BE REMOVED, ONSITE WHICH SERVE THE EXISTING BUILDING. ALL UTILITIES THAT WILL BE ABANDONED SHALL BE REMOVED COMPLETELY. CONTRACTOR SHALL COORDINATE ALL UTILITY REMOVAL WITH RESPECTIVE UTILITY PROVIDERS PRIOR TO CONSTRUCTION.
- 2. ALL ITEMS TO BE REMOVED, WHETHER SPECIFIED HERON OR NOT, SHALL BE PART OF THE SCOPE OF WORK.
- 3. THE SITE CONTRACTOR IS RESPONSIBLE FOR MAINTAINING SITE SECURITY AND PUBLIC SAFETY THROUGHOUT THE DURATION OF THE SITE WORK. ALL WORK AND SAFETY MEASURES SHALL BE CONDUCTED IN ACCORDANCE WITH ALL LOCAL, STATE, AND FEDERAL REQUIREMENTS.
- 4. CONTRACTOR SHALL INSTALL TEMPORARY CONSTRUCTION SITE FENCING (6' TALL CHAIN LINK) AND EROSION CONTROL BARRIERS AROUND THE WORK AREA PRIOR TO BEGINNING ANY WORK. CONSTRUCTION FENCING AND ALL EROSION CONTROL MEASURES SHALL BE MAINTAINED THROUGHOUT THE DURATION OF THE SITE WORK.
- 5. CONTRACTOR SHALL INSTALL TEMPORARY GRAVEL CONSTRUCTION ENTRANCE/EXIT PADS AS NECESSARY TO ENSURE ALL VEHICULAR TRAFFIC LEAVING THE SITE MUST CROSS A PAD. CONTRACTOR SHALL WASH VEHICLES IF NECESSARY TO PREVENT THE TRACKING OF DEBRIS ONTO PUBLIC WAYS.
- 6. CONTRACTOR IS RESPONSIBLE FOR ENSURING THAT ALL PUBLIC WAYS REMAIN CLEAN AND FREE OF DEBRIS RESULTING FROM THE CONSTRUCTION SITE THROUGHOUT THE DURATION OF THE PROJECT.
- 7. CONTRACTOR SHALL TAKE ALL MEASURES NECESSARY TO MINIMIZE DUST ONSITE THROUGHOUT CONSTRUCTION.
- 8. CONTRACTOR SHALL BE SOLELY RESPONSIBLE FOR JOB SITE SAFETY AND ALL CONSTRUCTION MEANS AND METHODS.

PROPOSED LEGEND

CONIFEROUS TREE (TO BE REMOVED)

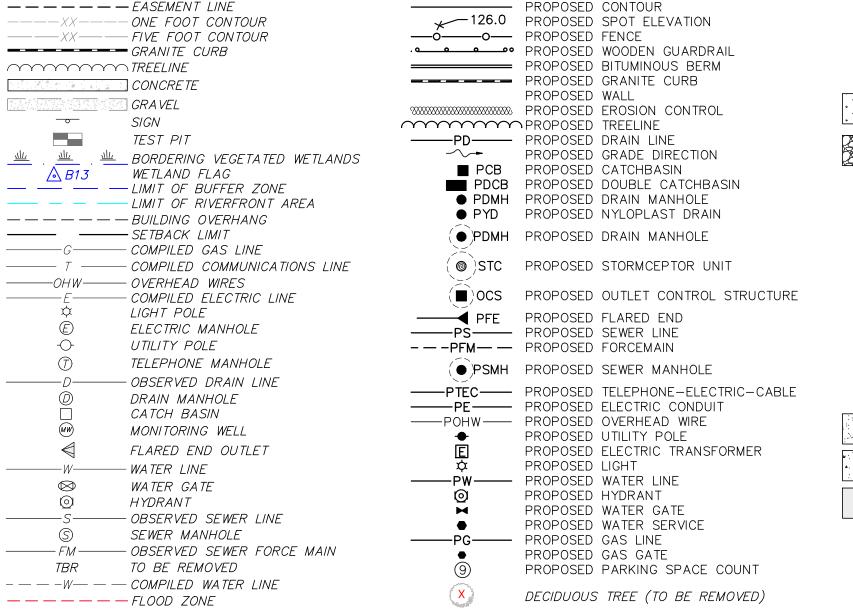



TW

SNOW STOCKPILE AREA

PROPOSED TREE

NEW ENGLAND

CONSERVATION/WILDLIFE MIX

PLANTING AREA

RIPRAP AREA PROPOSED MONUMENT TO BE PLACED INVERT ELEVATIONS a=/b=/i= BOTTOM OF CURB BOTTOM OF WALL (DBO) DESIGNED BY OTHERS PROPOSED GENERATOR GEN HR PROPOSED HANDICAP RAMP PROPOSED PIPE LENGTH PROPOSED BITUMINOUS BERM PROPOSED EDGE OF PAVEMENT PGC PROPOSED GRANITE CURB R= RIM ELEVATION PROPOSED PIPE SLOPE TOP OF CURB

PROPOSED SIGN
PROPOSED STONE DUST TRAIL
PROPOSED CONCRETE WALKWAY

PROPOSED STANDARD DUTY PAVEMENT

TOP OF WALL

PROPOSED WHEEL STOP
PROPOSED CHARGING STATION
PROPOSED LIMIT OF WORK

ENDORSED BY WAYLAND PLANNING BOARD

IN ACCORDANCE WITH CERTIFICATE OF VOTE FOR
AMENDING THE WAYLAND TOWN CENTER MIXED—USE
PROJECT MASTER SPECIAL PERMIT, SPECIAL PERMITS
AND SITE PLAN DECISION
_____, 2023

PEEN REVIEW / TOWN COMMENTS
03/17/23 PEER REVIEW / TOWN COMMENTS
03/01/23 PEER REVIEW / TOWN COMMENTS
02/10/23 SITE ACCESS & LAYOUT
02/10/23 SITE ACCESS & LAYOUT
01/16/23 SITE PLAN APPLICATION
01/05/23 CON. COMMISSION COMMENTS

COMMONAL SPANSON ON 49369

NMMUNITY CENTER

S. & LEGEND

IN

ACHUSETTS

INCIL ON AGING COMMU
GENERAL NOTES & LOCATED IN
MAYLAND, MASSACHI

SOCUMMINGS CENTER, SUITE 5950

SEVERLY, MASSACHUSETTS 01915


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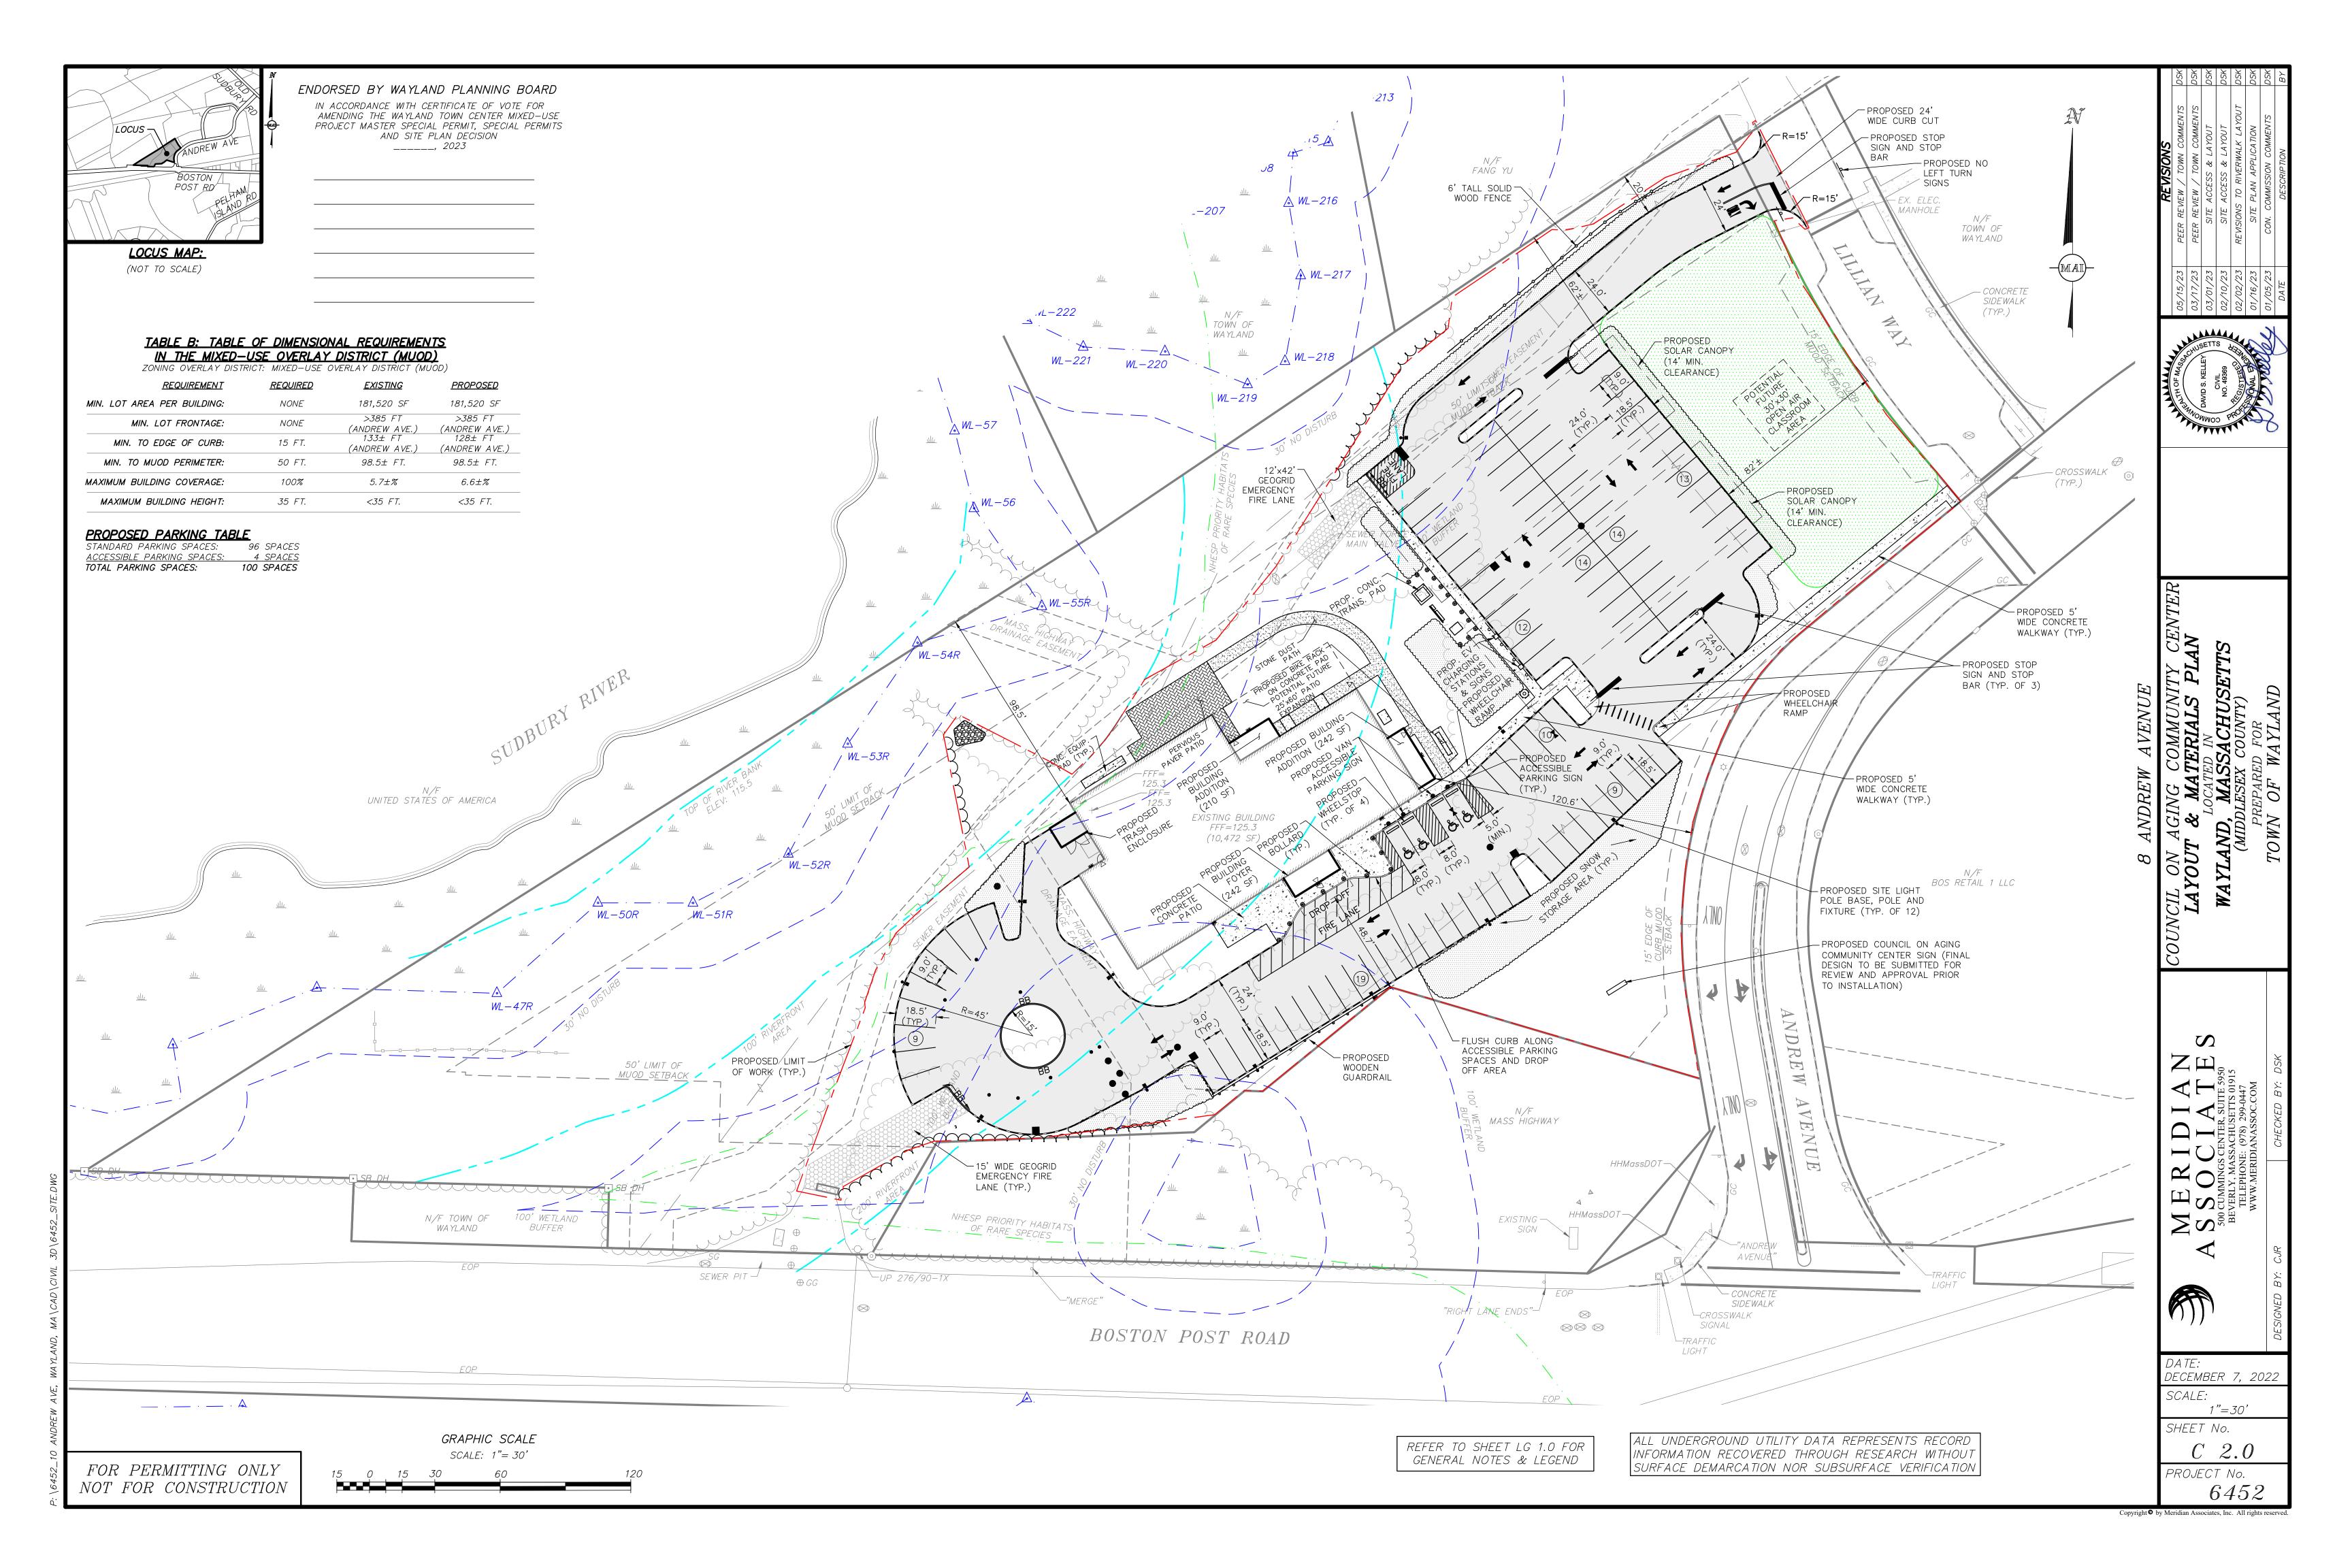
DATE: DECEMBER 7, 2022 SCALE: AS NOTED


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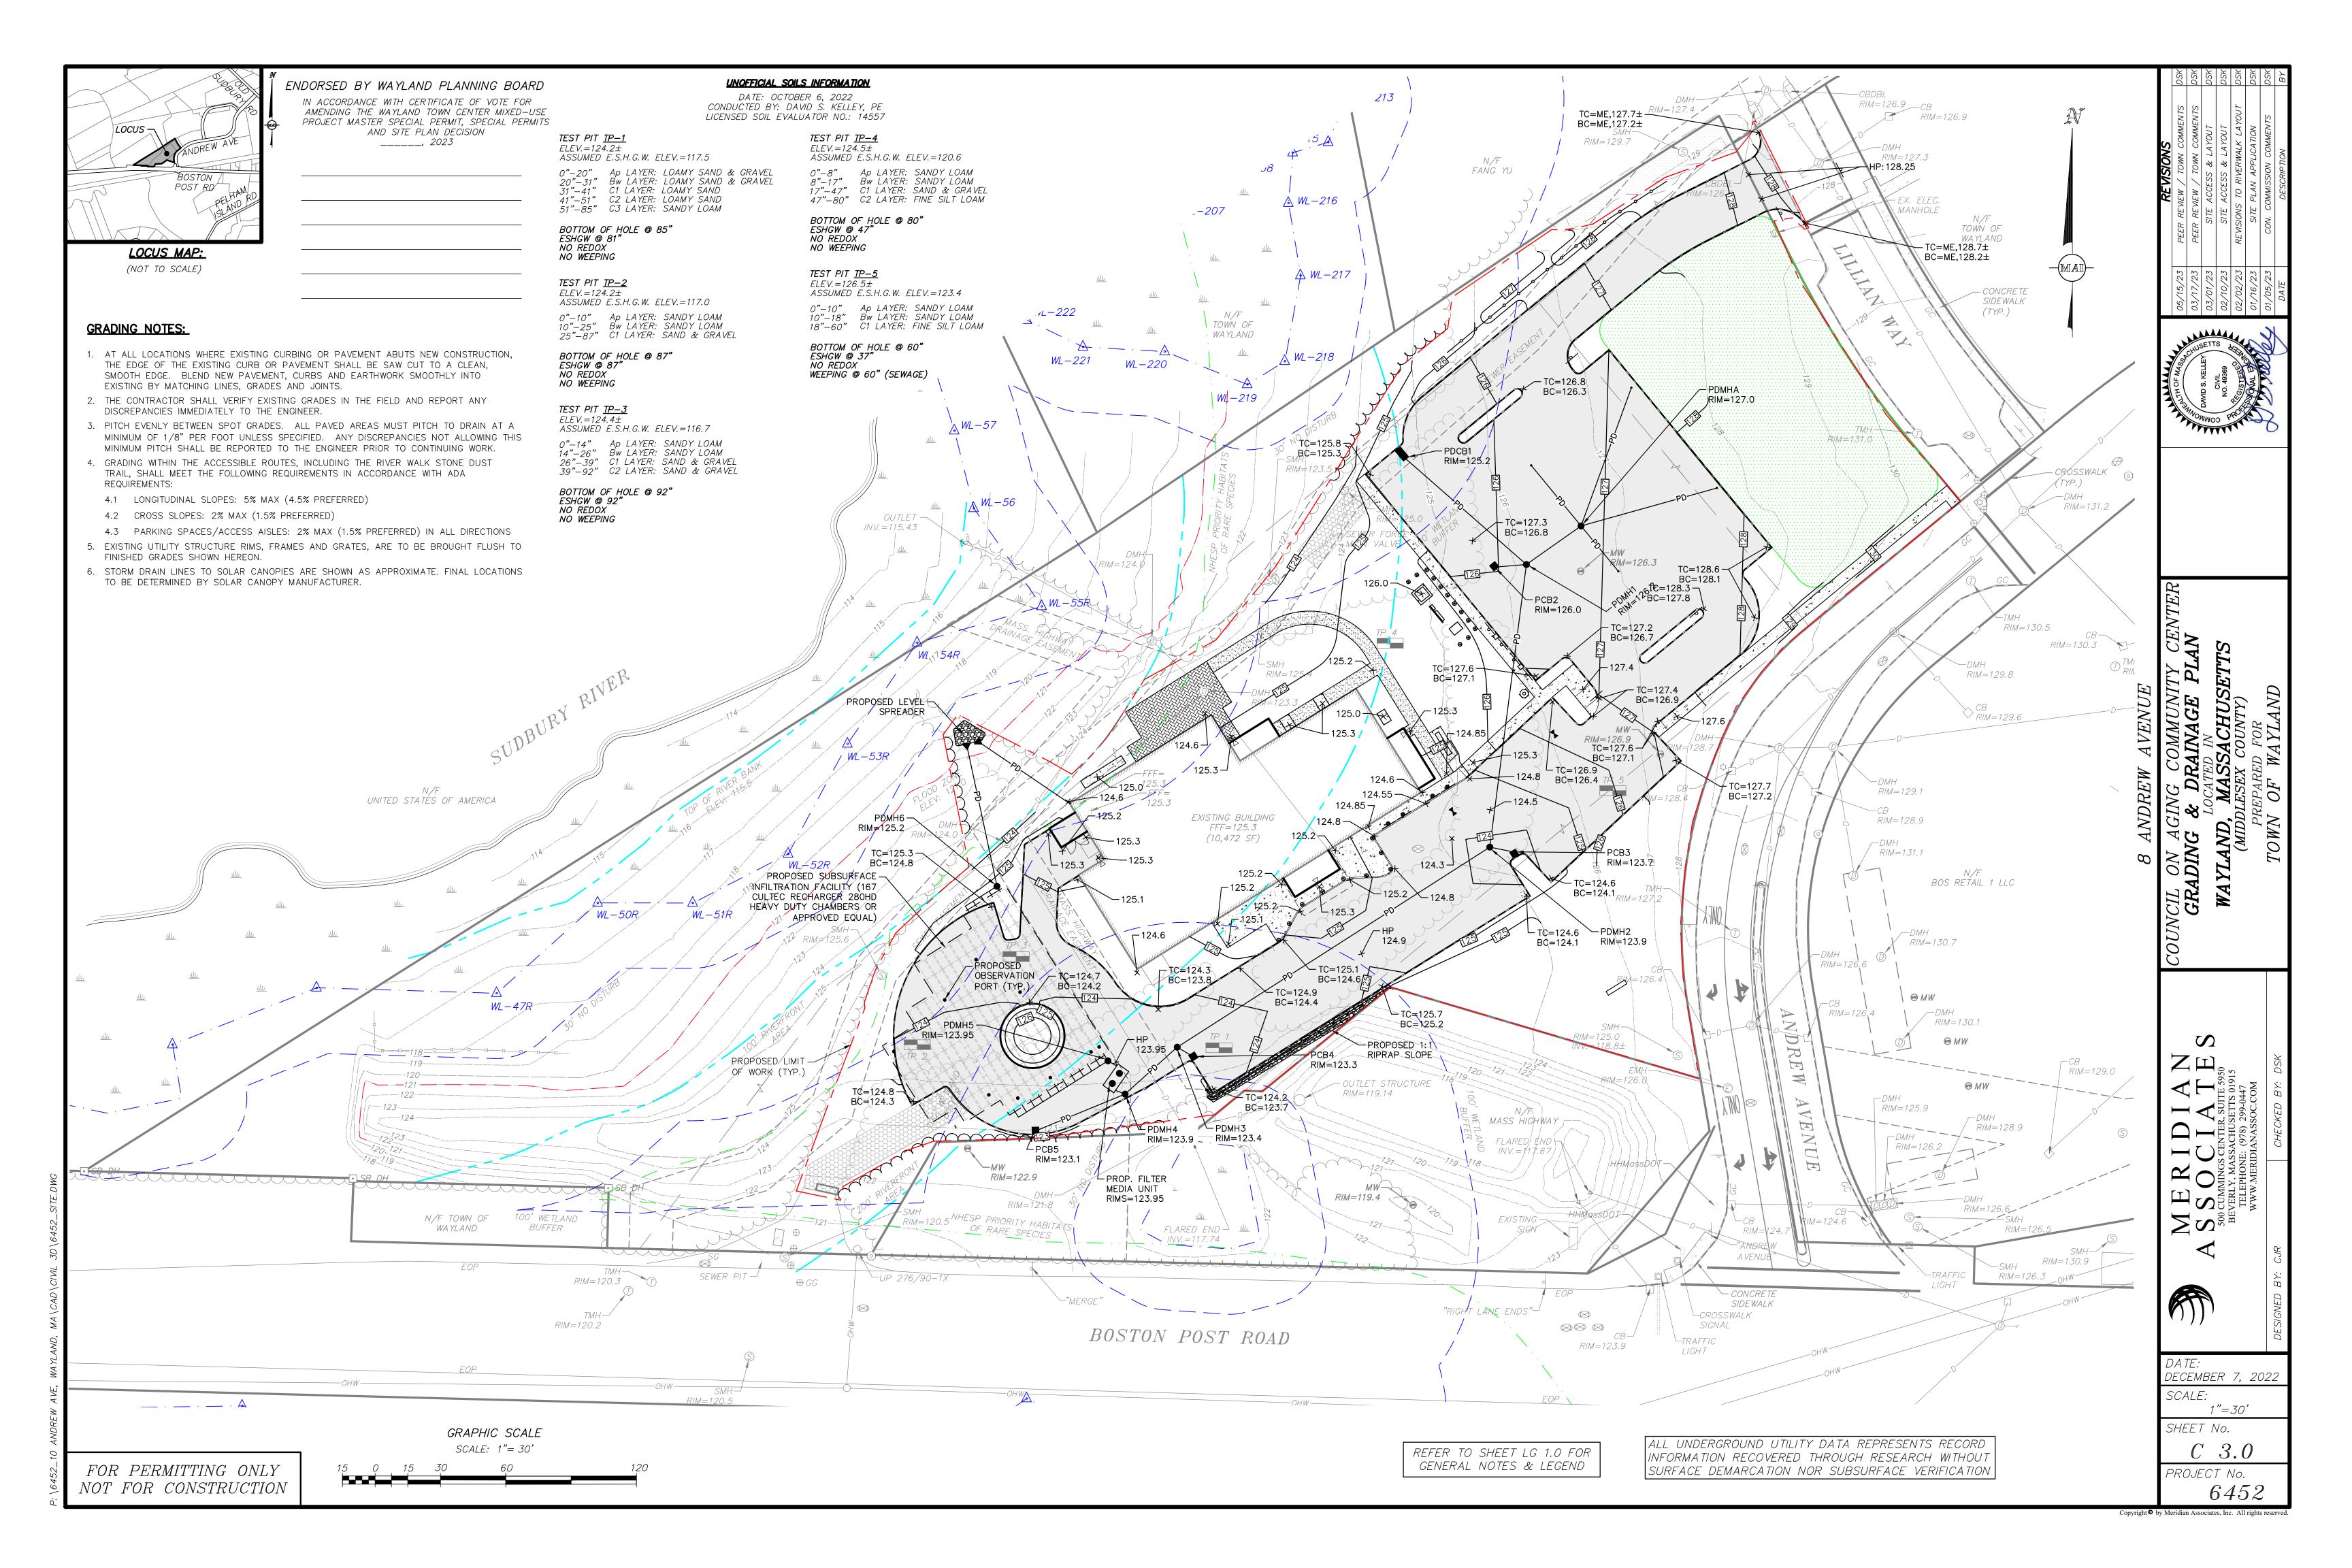
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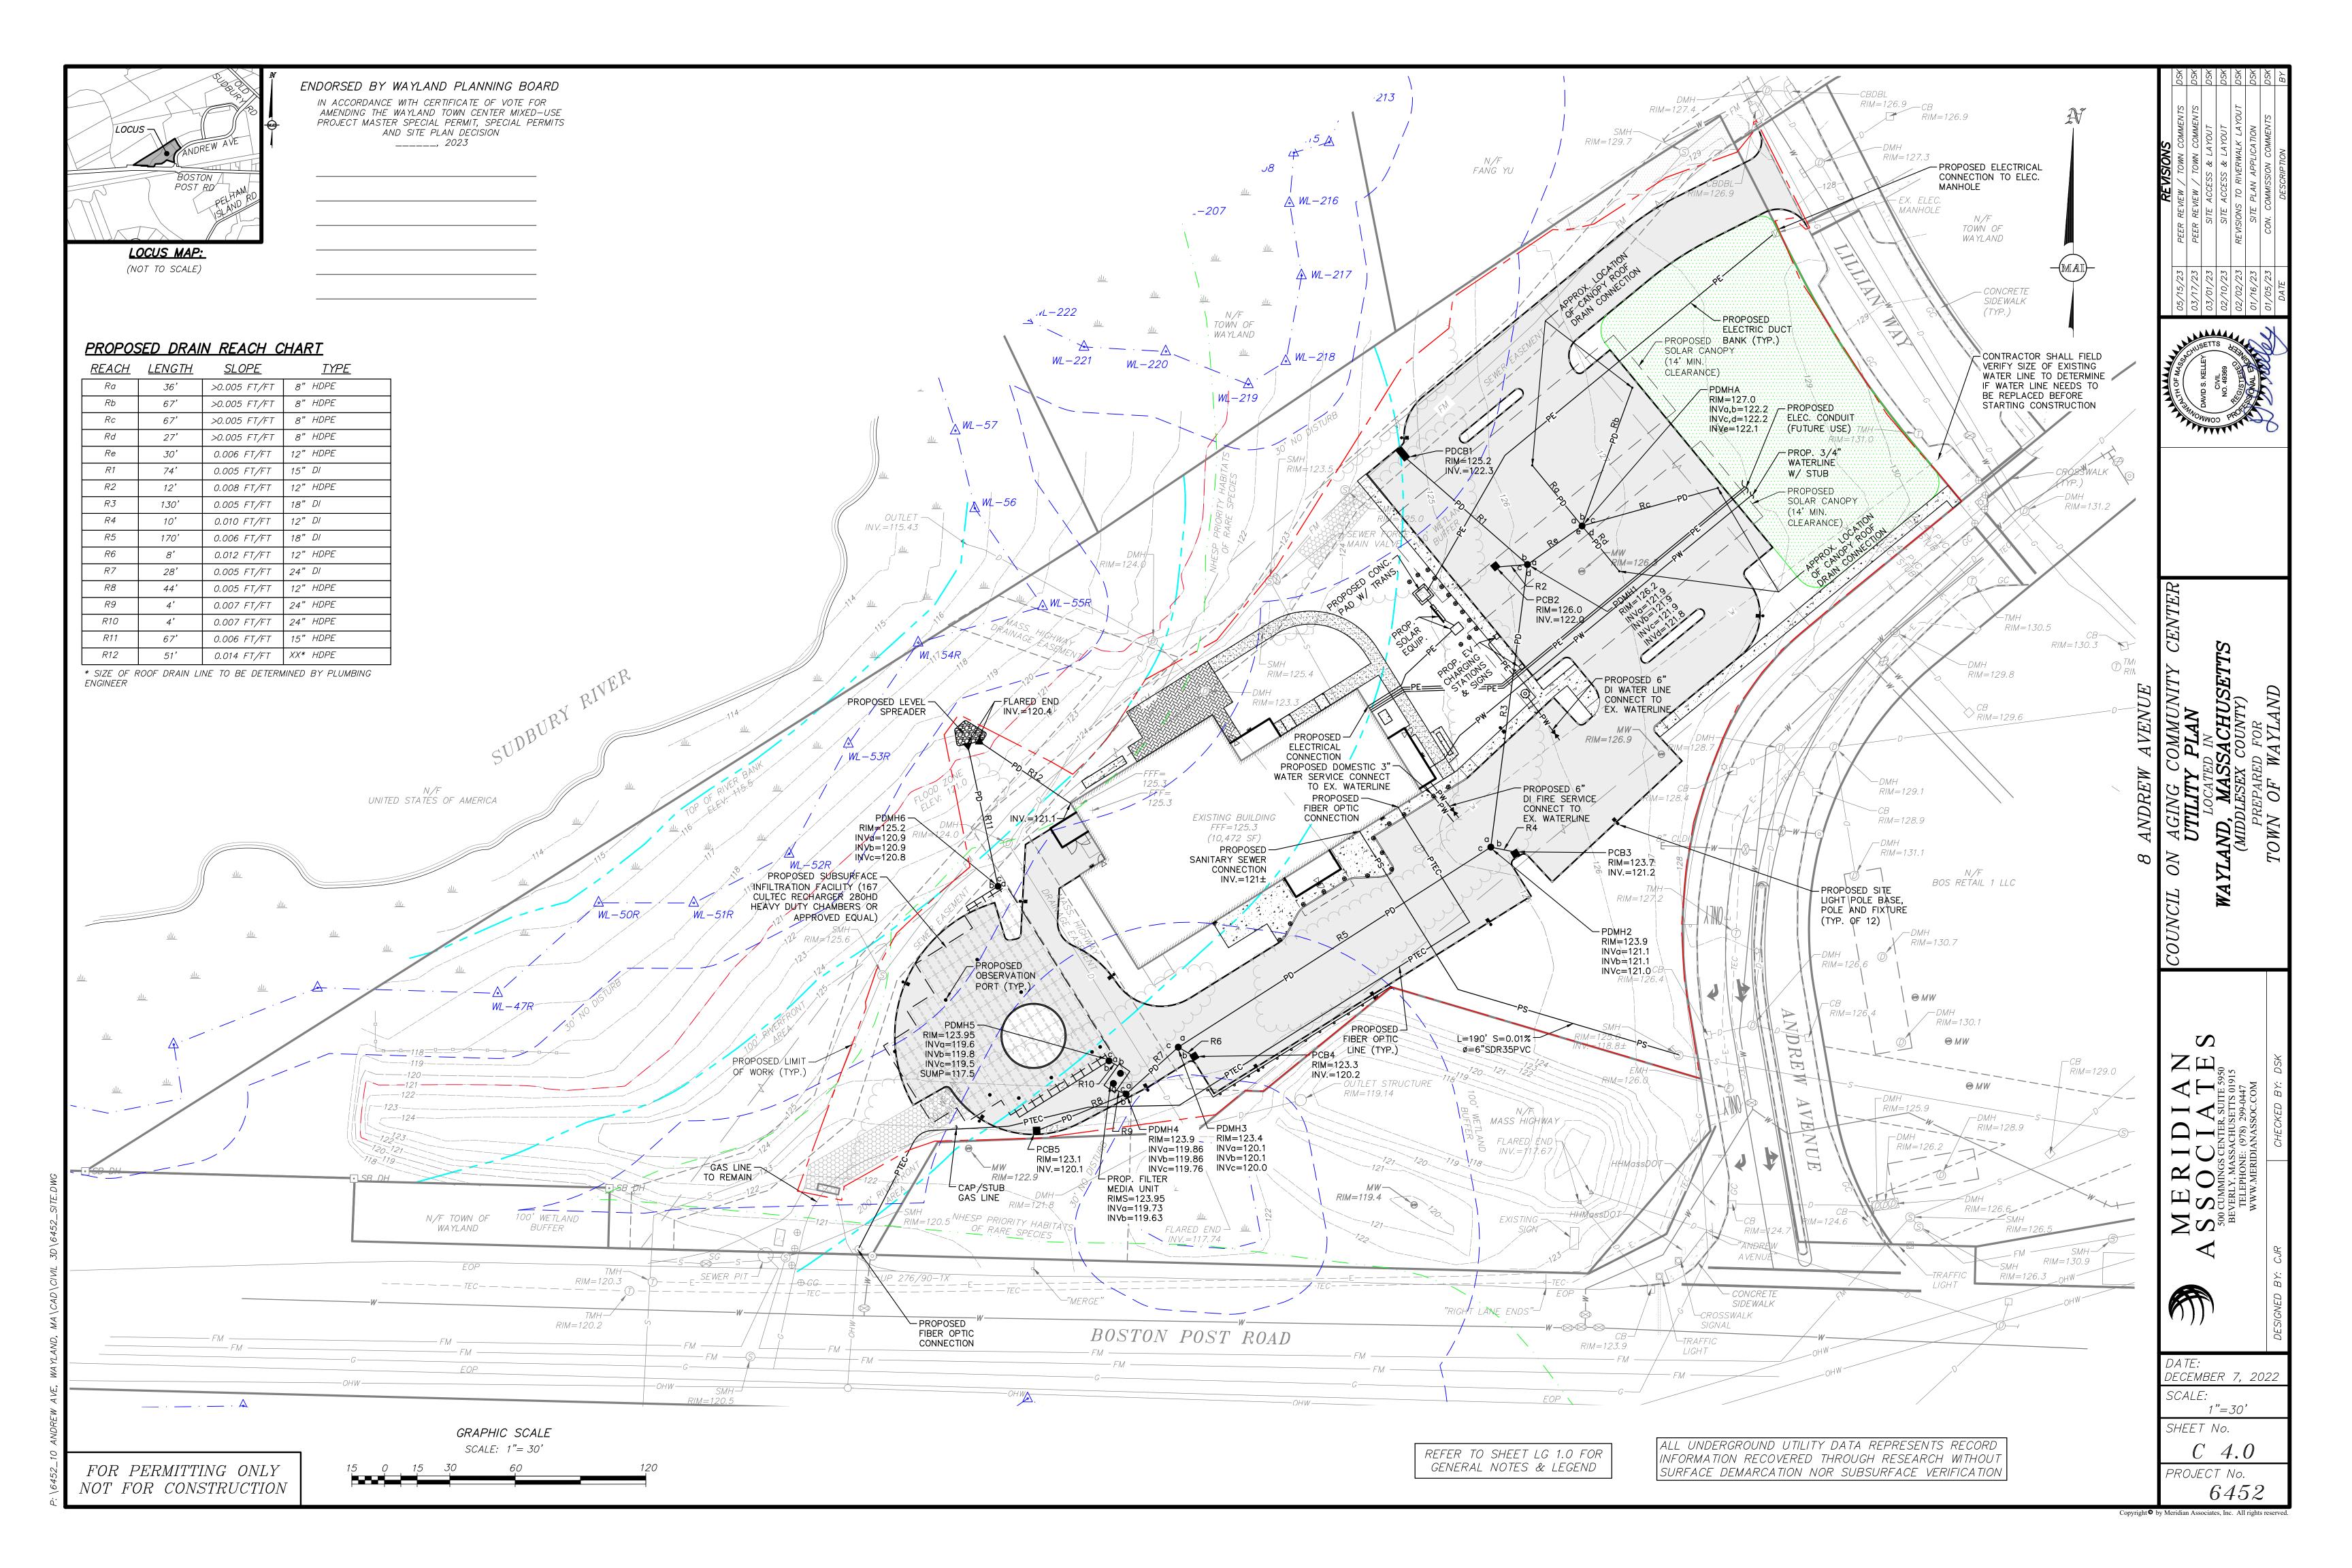
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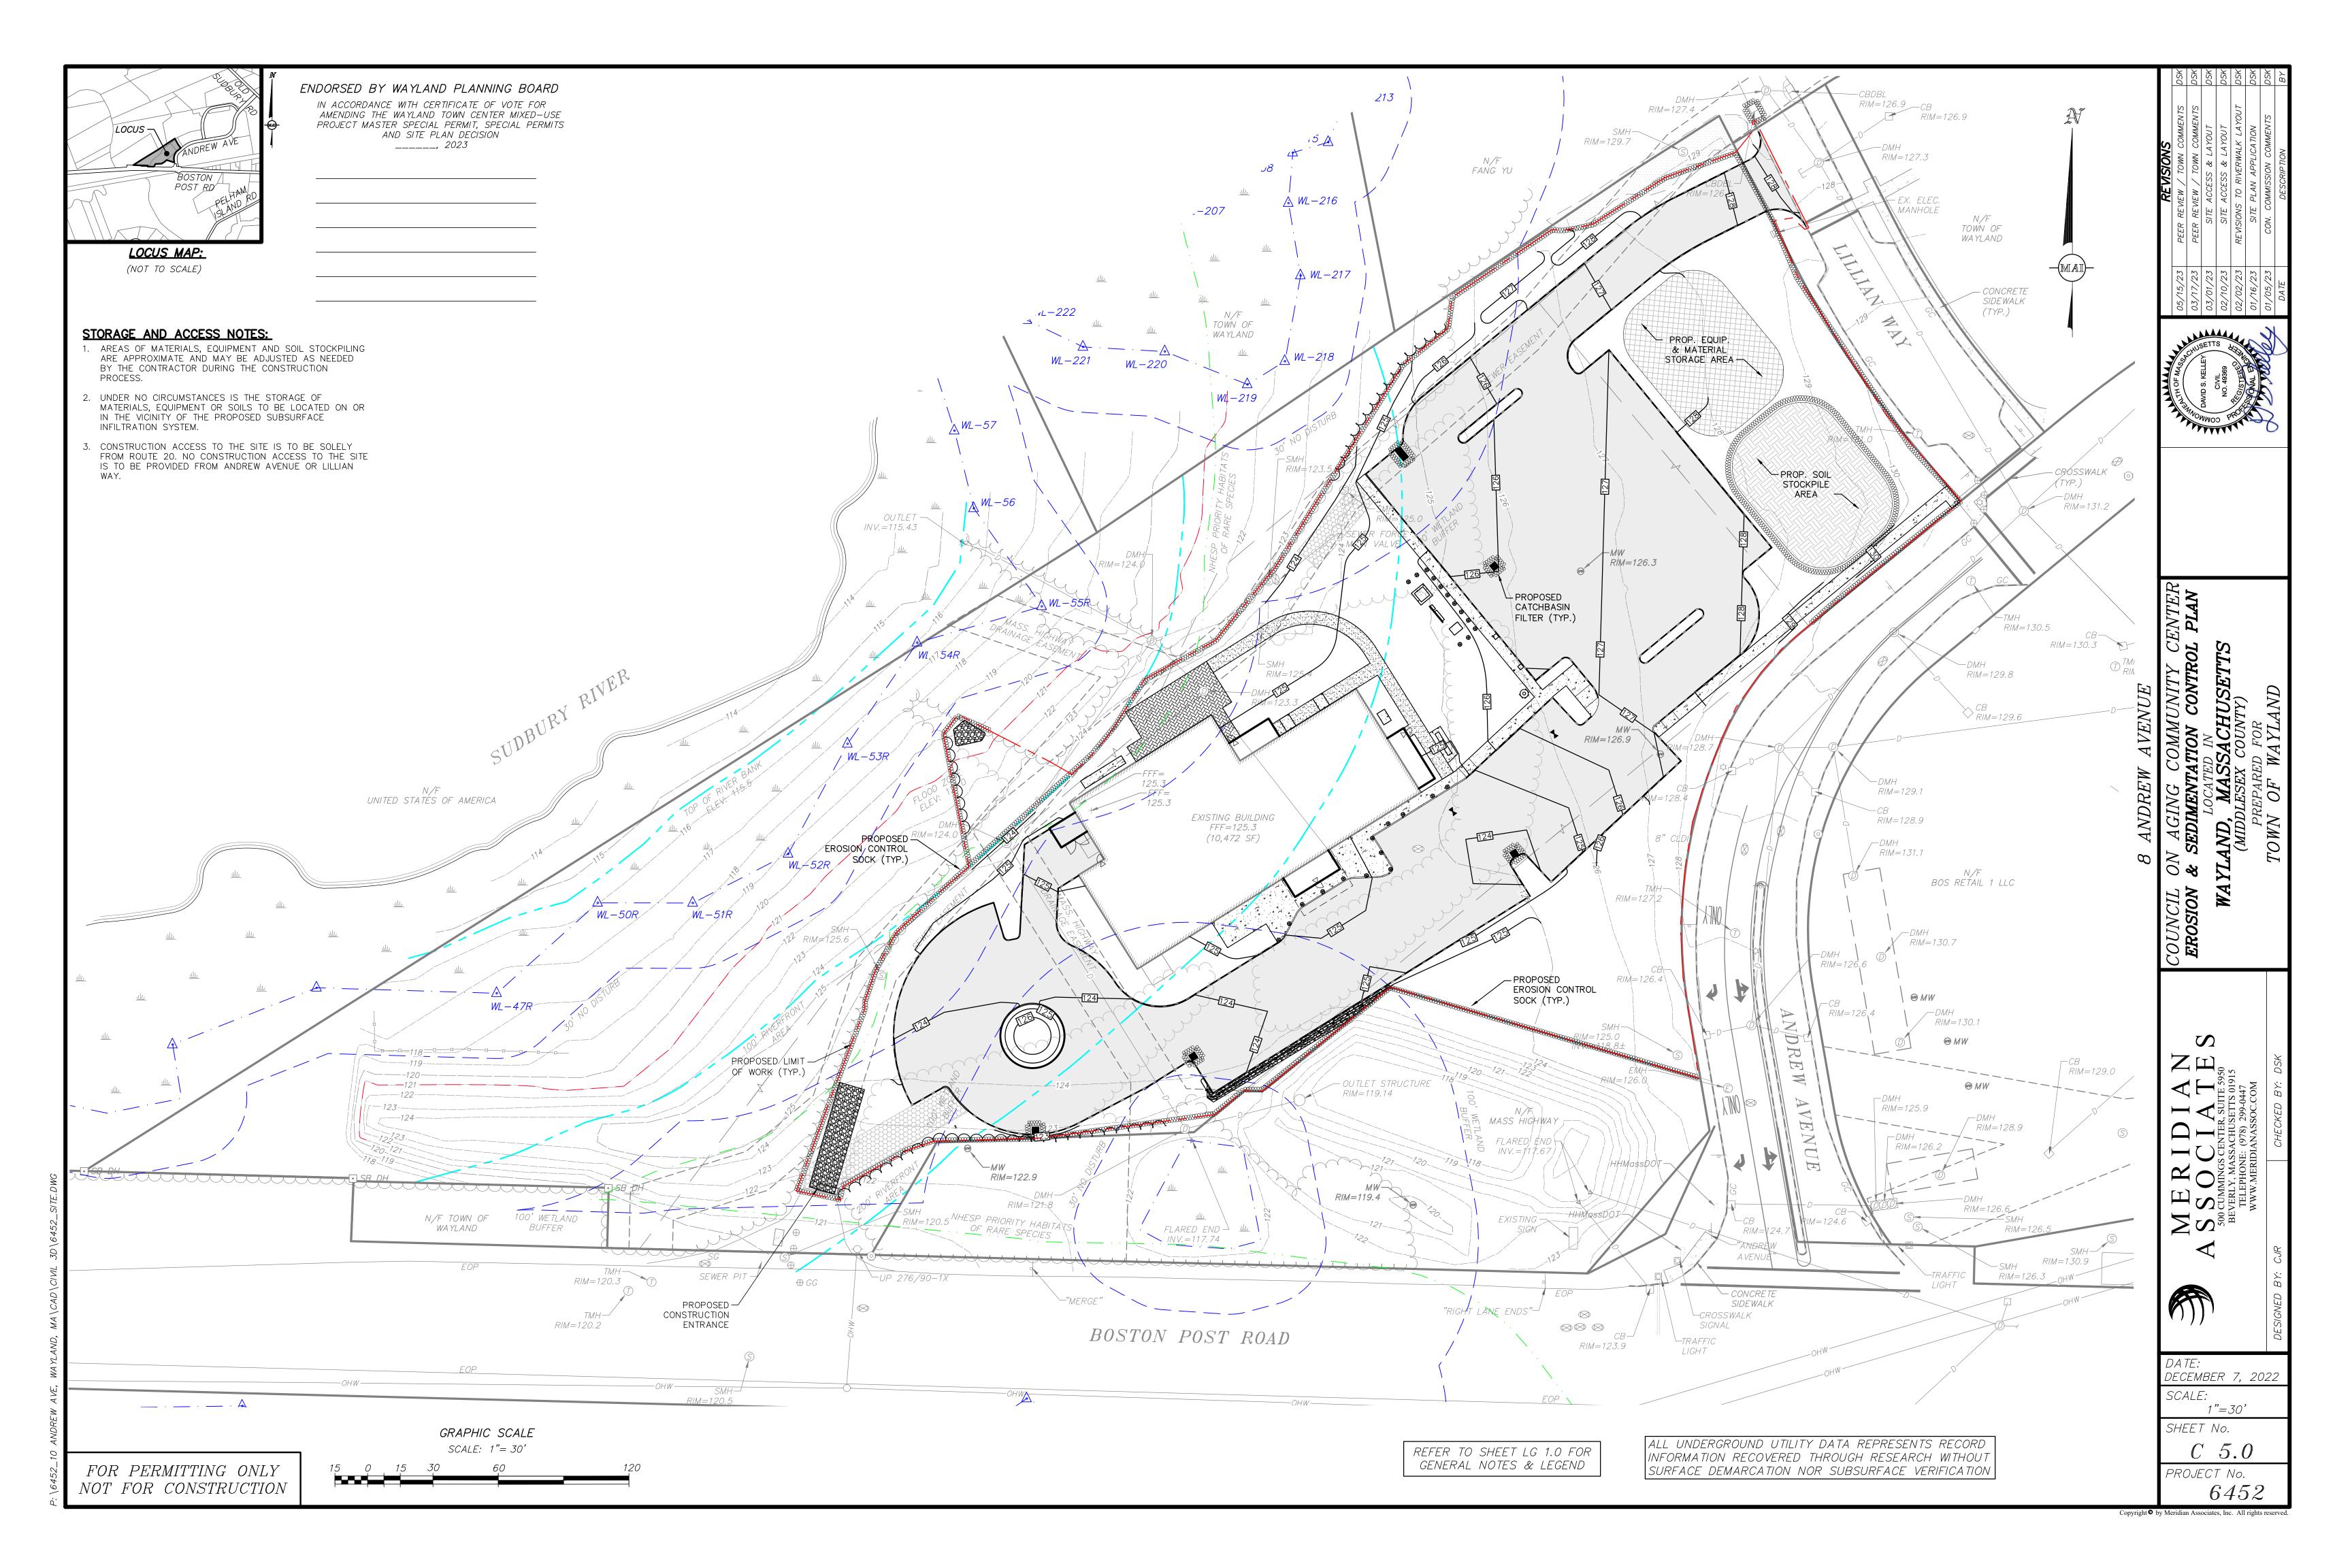










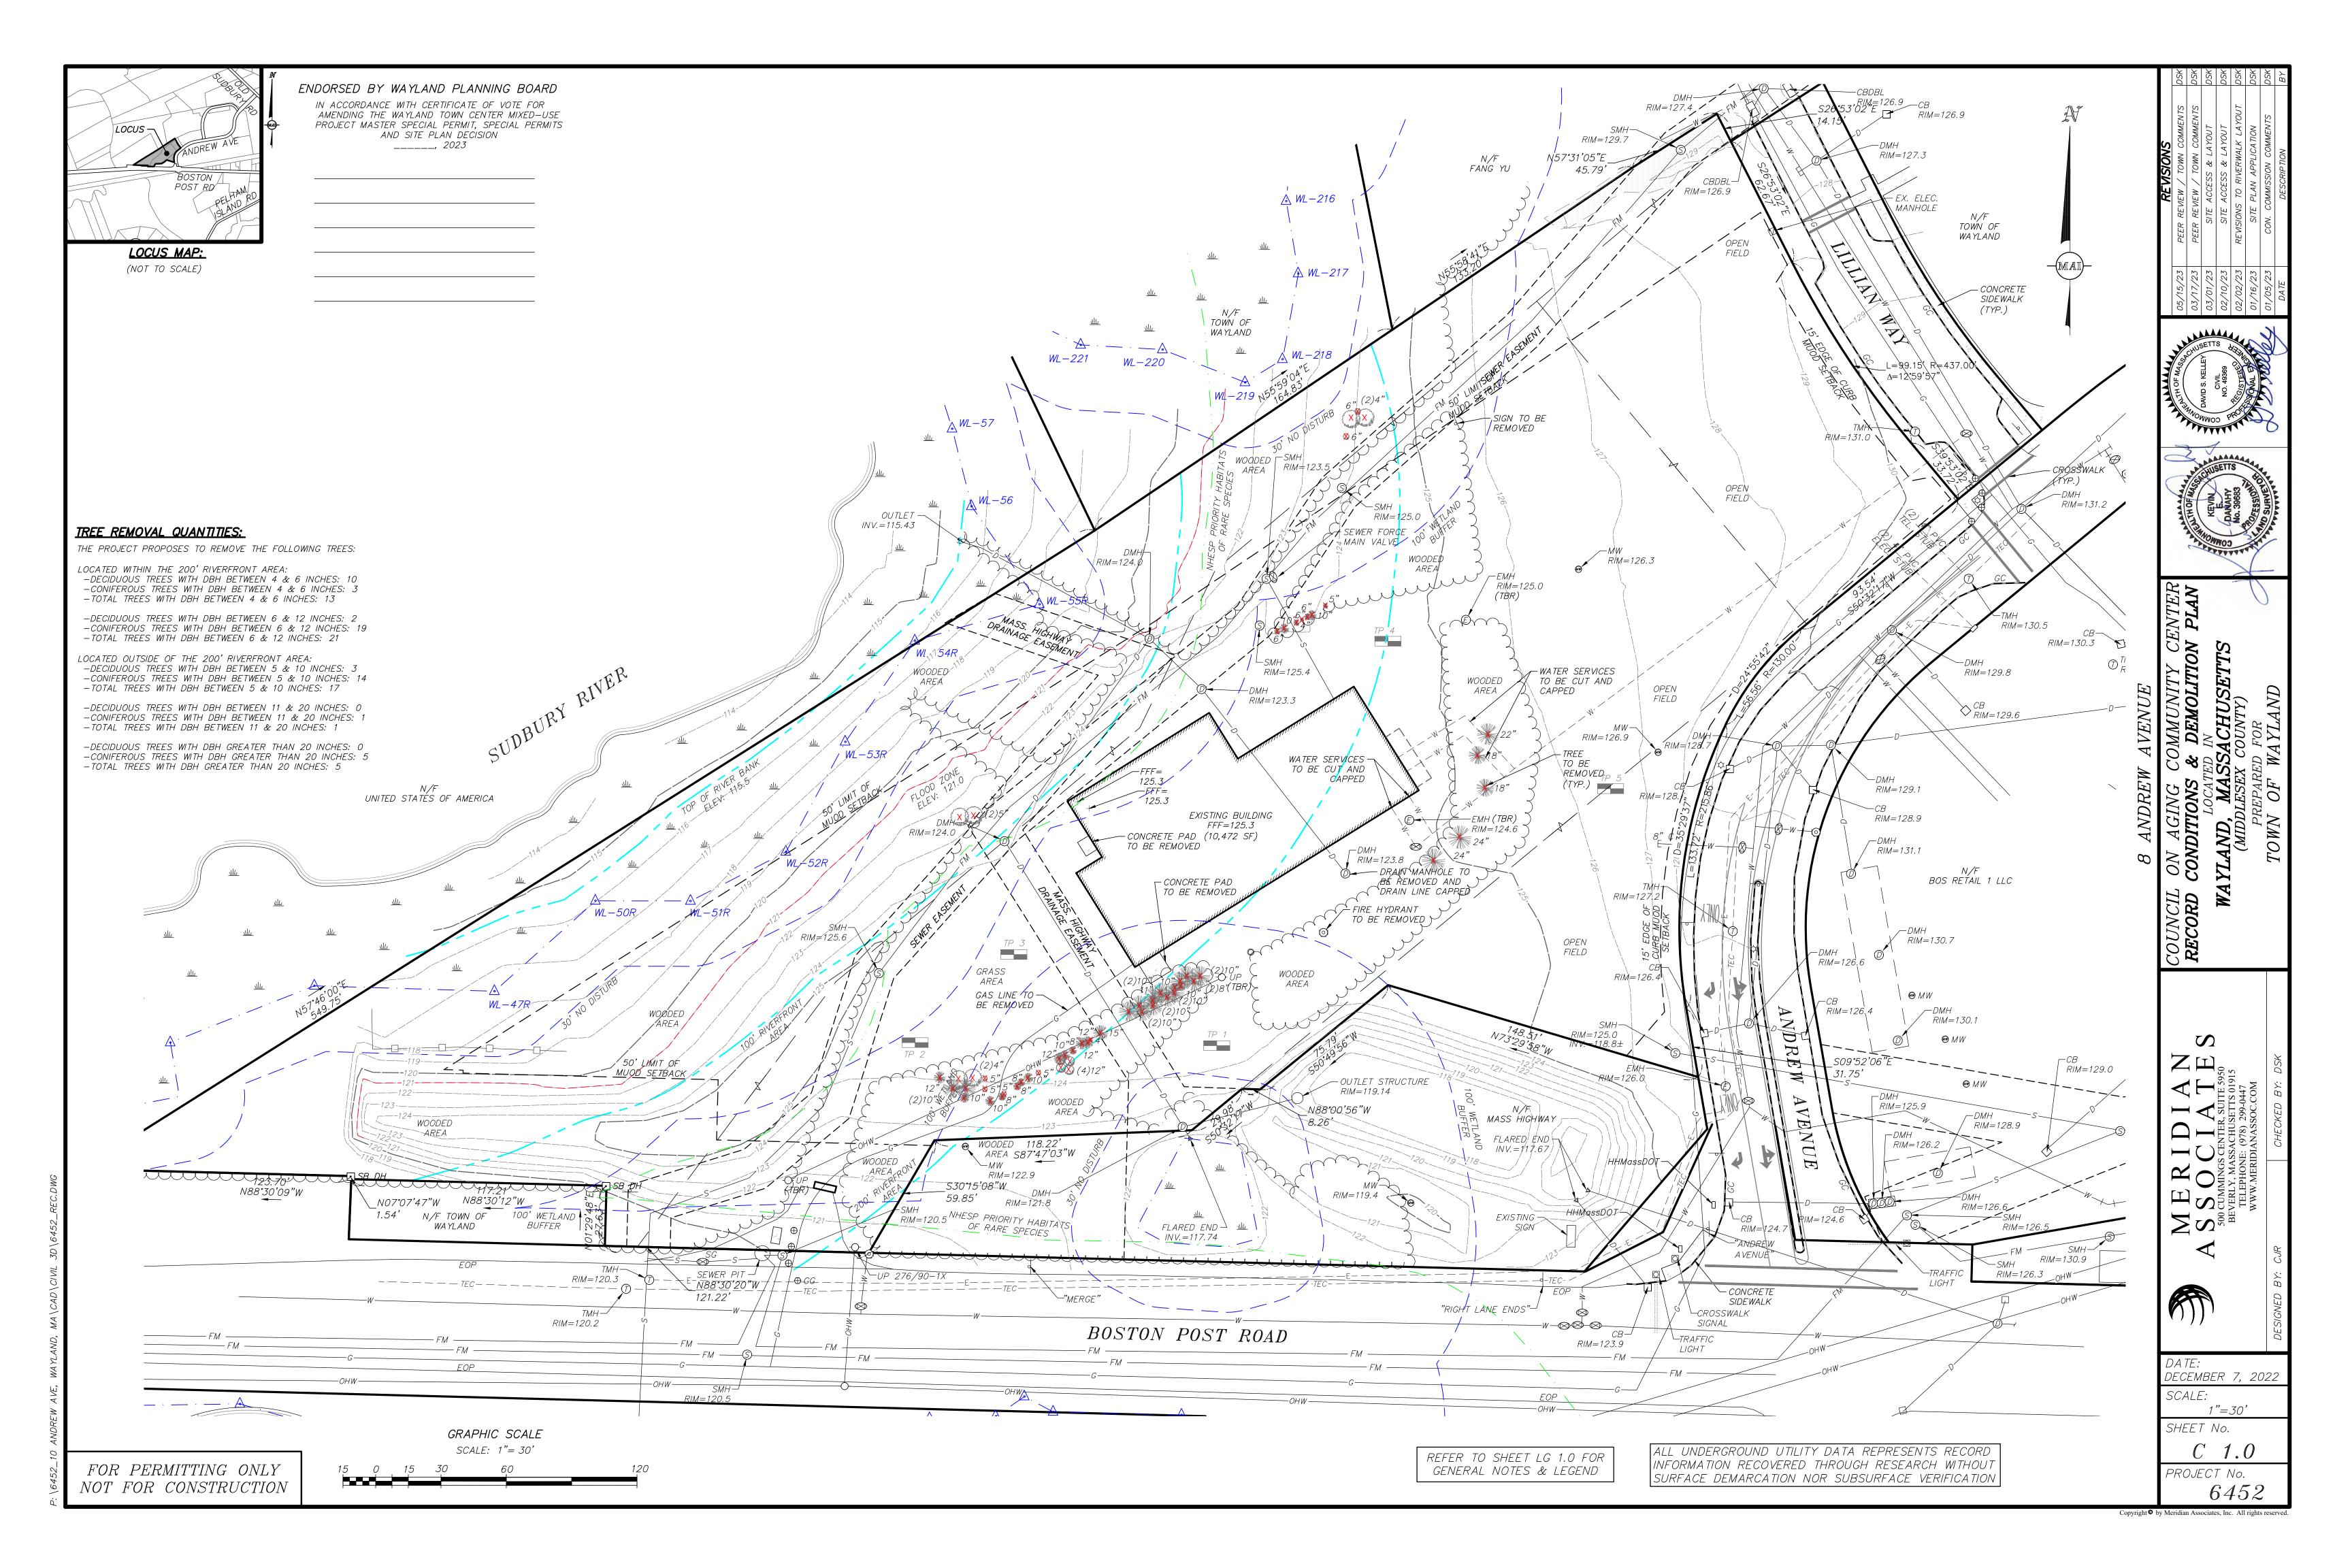

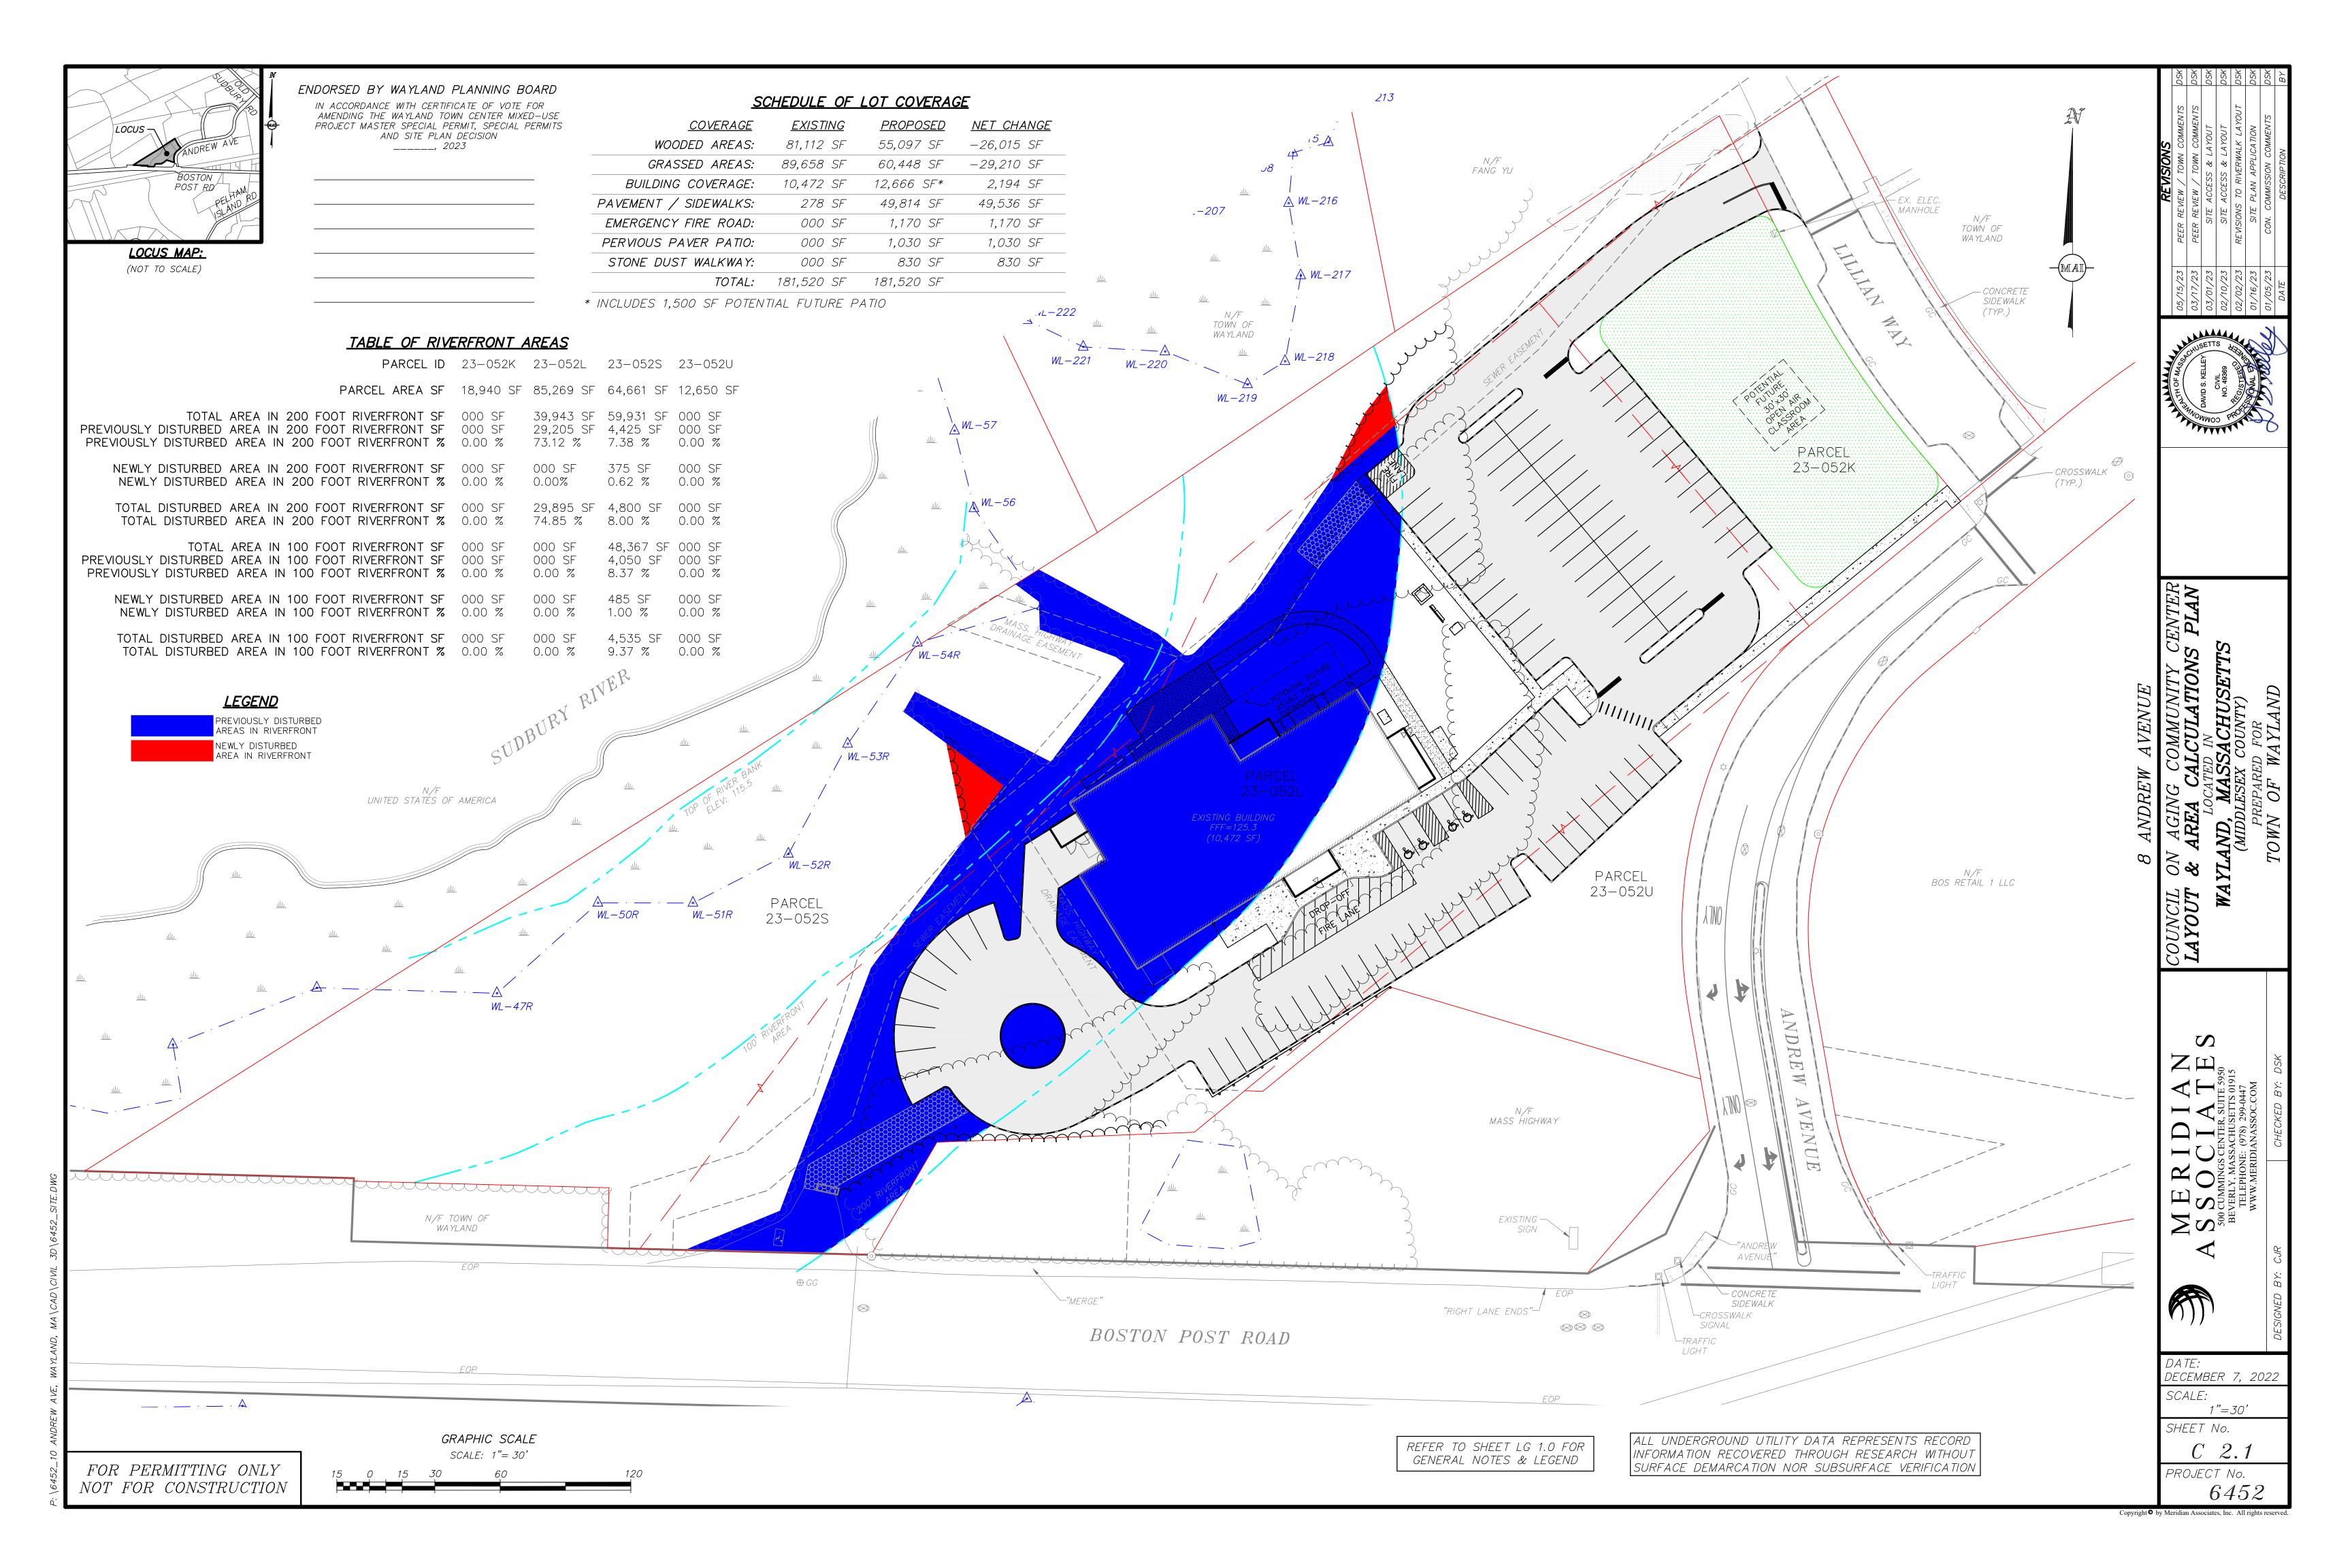

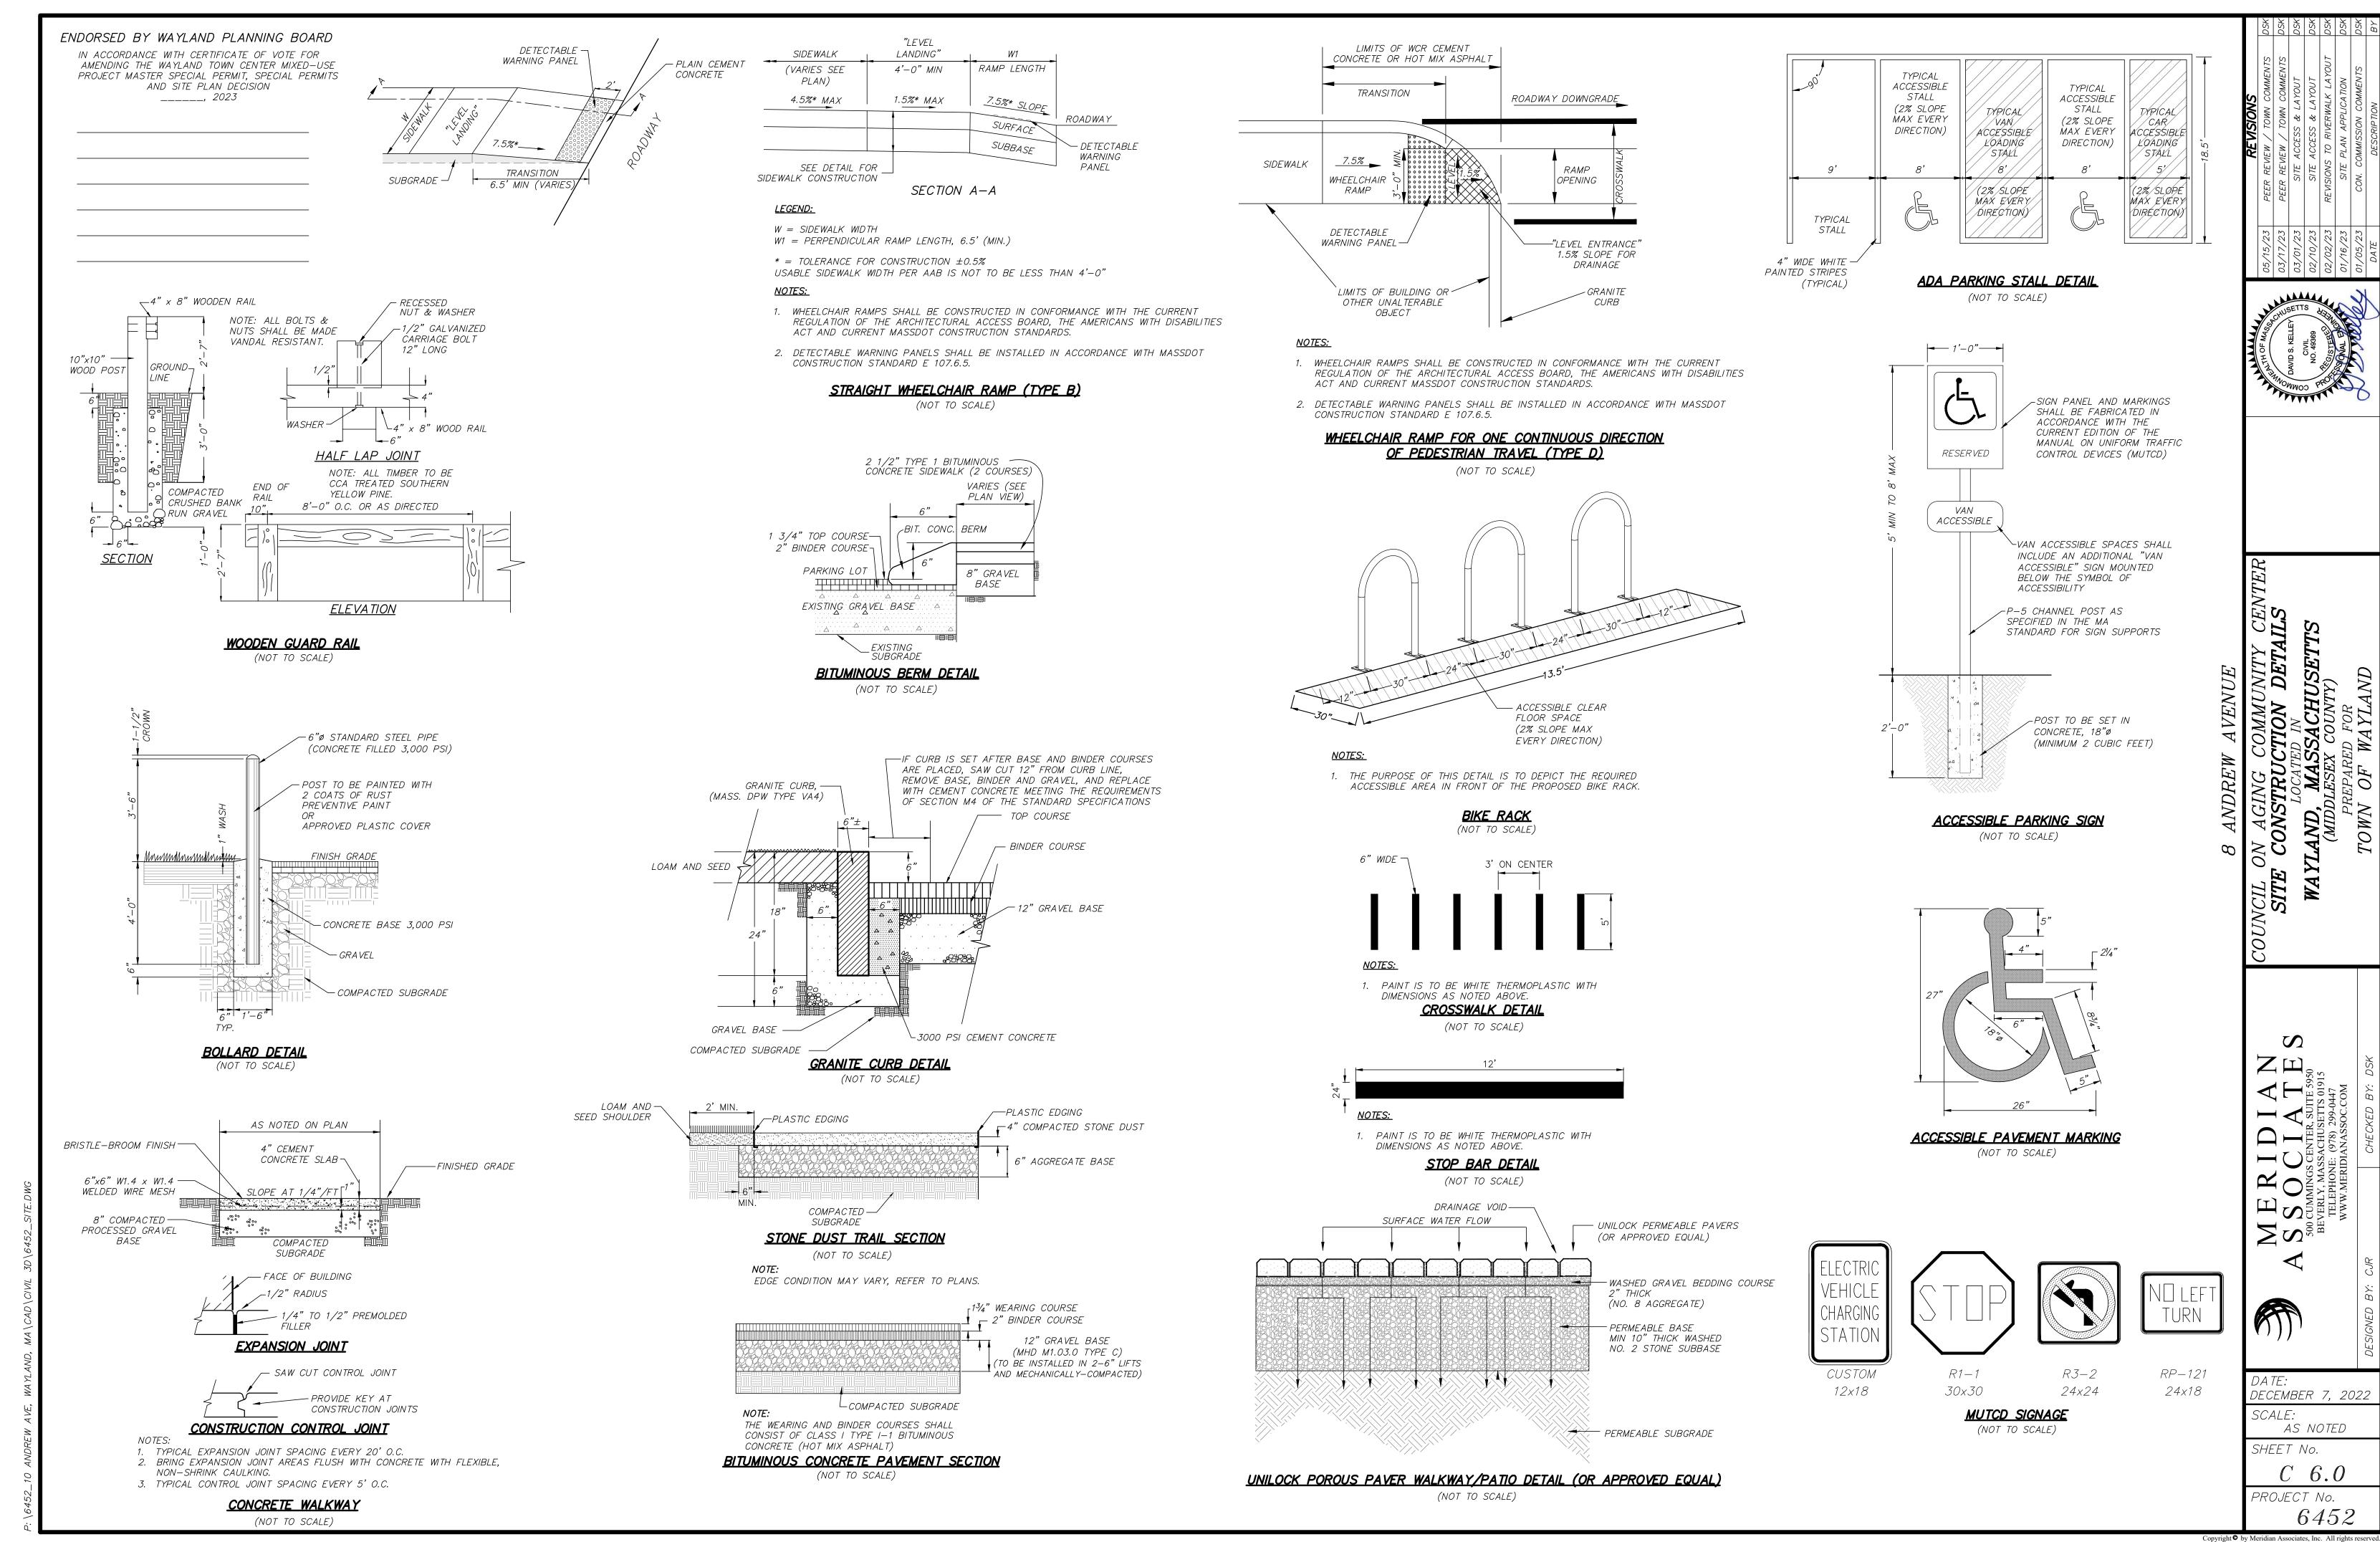



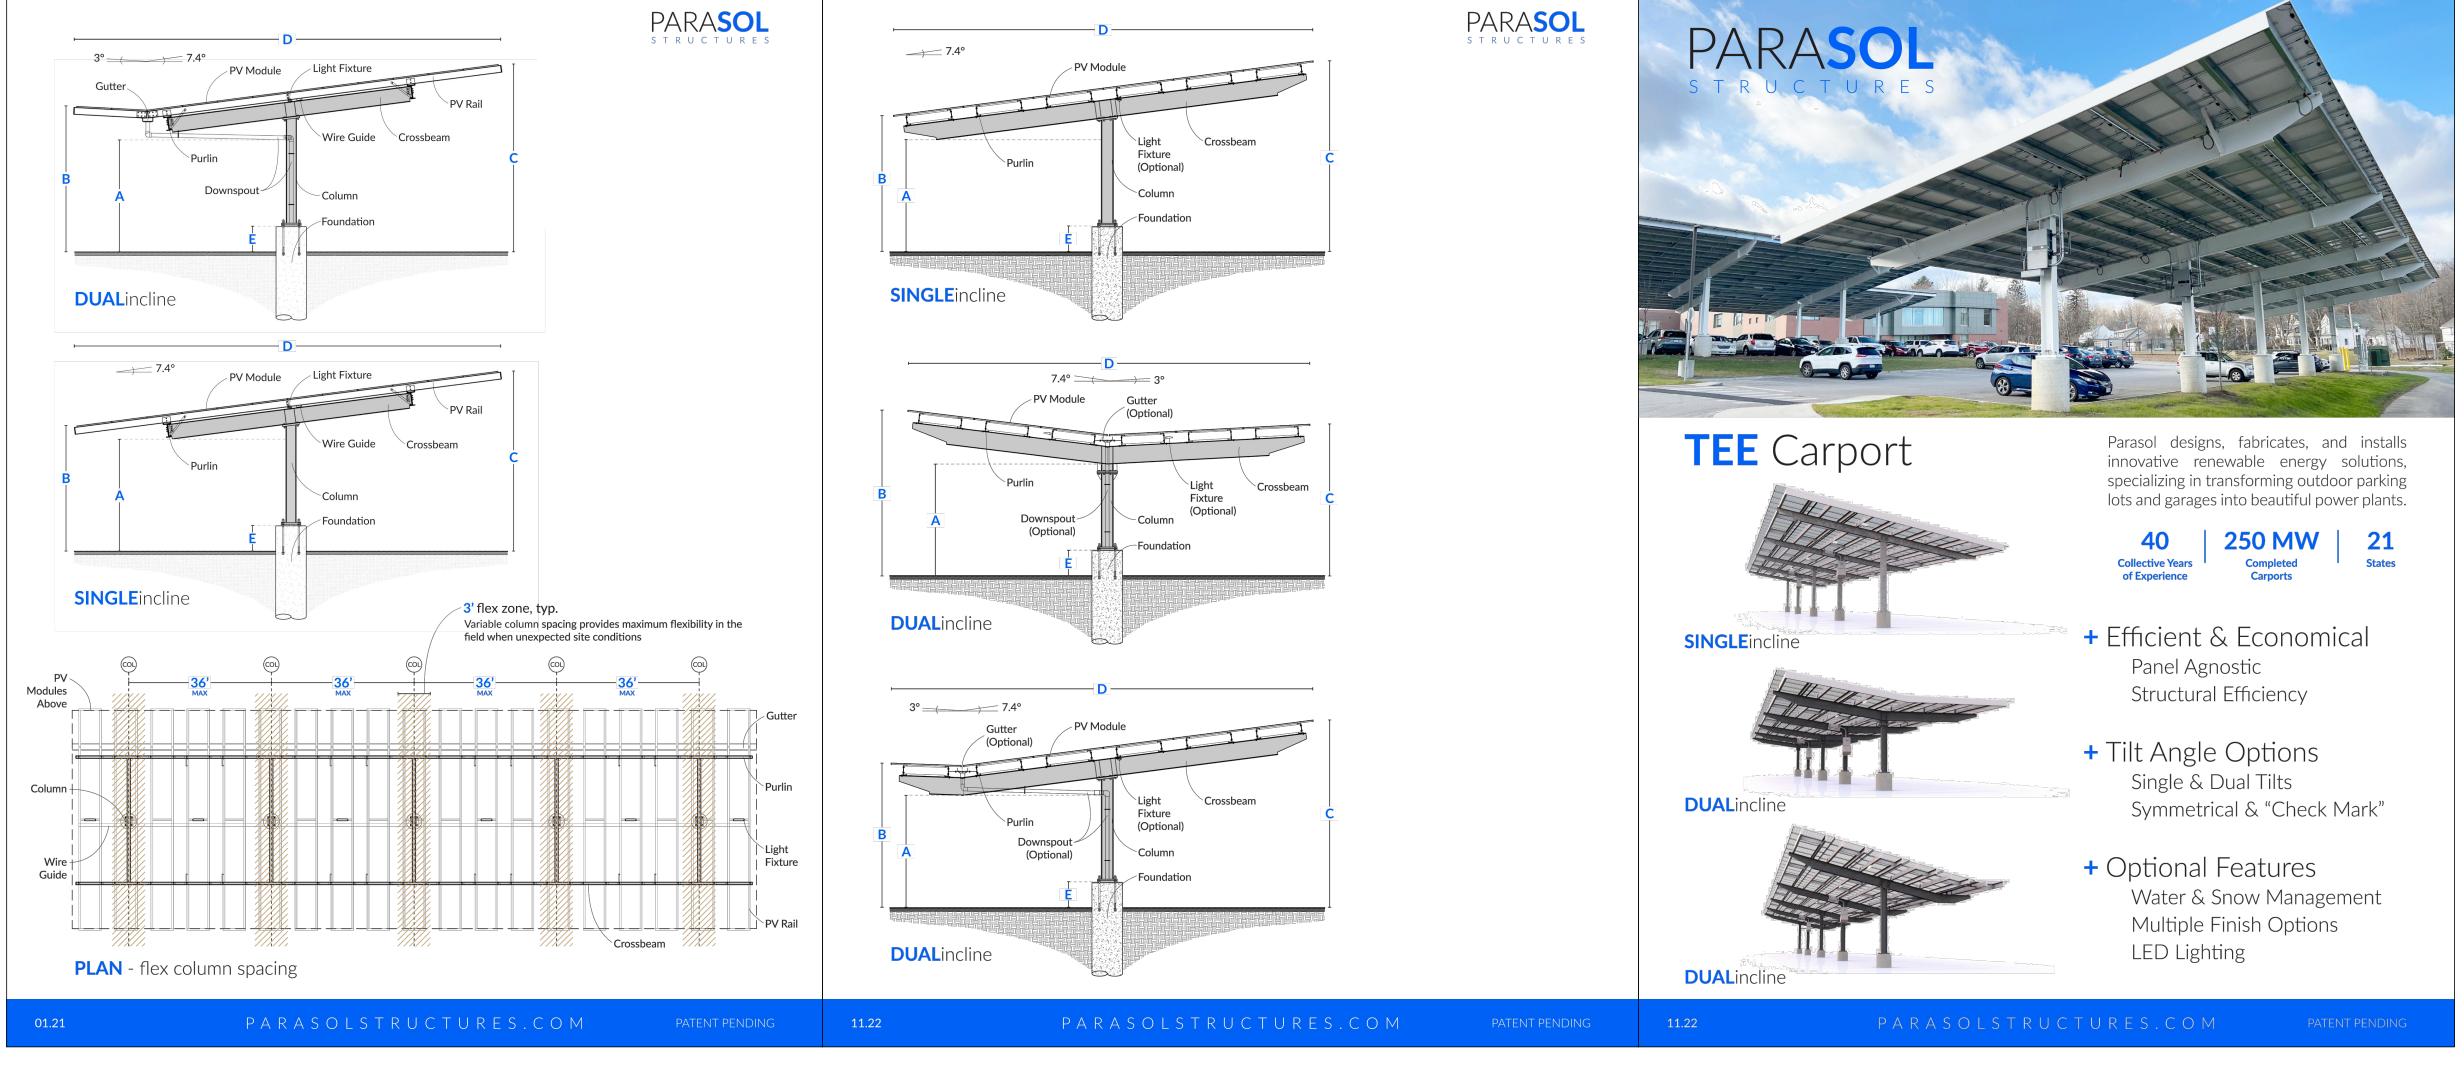

<u>NOTES:</u>

- 1. FINAL SOLAR CANOPY DESIGN IS TO BE SIMILAR TO ONE OF THE CANOPIES DEPITED
- 2. ACTUAL SOLAR CANOPIES AND CANOPY DETAILS ARE TO BE PROVIDED BY THE MANUFACTURER, YET TO BE DETERMINED.
- 3. SOLAR CANOPIES ARE TO PROVIDE A MINIMUM OF FOURTEEN (14) OF CLEARANCE BELOW THE LOWEST POINT OF THE CANOPY OR APPURTENANCES.
- 4. SOLAR CANOPIES ARE TO CONTAIN AN INTEGRATED GUTTER AND DOWN SPOUT SYSTEM THAT WILL CONNECT TO THE PROPOSED STORMWATER MANAGEMENT SYSTEM. FINAL CONNECTION LOCATIONS TO BE DETERMINED BY SOLAR CANOPY


SOLAR CANOPY DETAILS (NOT TO SCALE)

- 1. THICKNESS OF FERTILE INTERMEDIATE LAYER & DRAINAGE LAYER DEPENDENT UPON SPECIFIC SITE & LOADING CONDITIONS.
- 2. ½" CHIP CLEAR OR OTHER SUITABLE CLEAR STONE CAN BE USED FOR DRAINAGE LAYER.
- 3. TYPICAL SEED MIX: SEED MIX SHOULD BE MODIFIED TO SUIT LOCAL CONDITIONS.
- 45% CREEPING RED FESCUE,
- 20% TALL FESCUE,
- 15% PERENNIAL RYE GRASS, AND - 20% KENTUCKY BLUE GRASS, WITH
- LONG TERM FERTILIZER.
- 4. DRAINAGE SYSTEM OF THE PERMEABLE PAVEMENT SYSTEM SHOULD BE DESIGNED TO ACCOMMODATE EXPECTED INFILTRATION RATES, STORAGE CAPACITIES, OUTLET FLOW RATES, AND OTHER SITE SPECIFIC CONDITIONS.
- 5. SUBGRADE SHOULD BE SLOPED TO AID IN DRAINAGE.
- 6. SEE ECORASTER GREEN INSTALLATION MANUAL FOR FURTHER

(FIRE LANE)

NOT TO SCALE

- INFORMATION ON LAYERS.
- 7. ALL DIMENSIONS IN mm UNLESS STATED OTHERWISE.
- 8. THIS DRAWING IS FOR CONCEPTUAL DESIGN PURPOSES ONLY, NOT

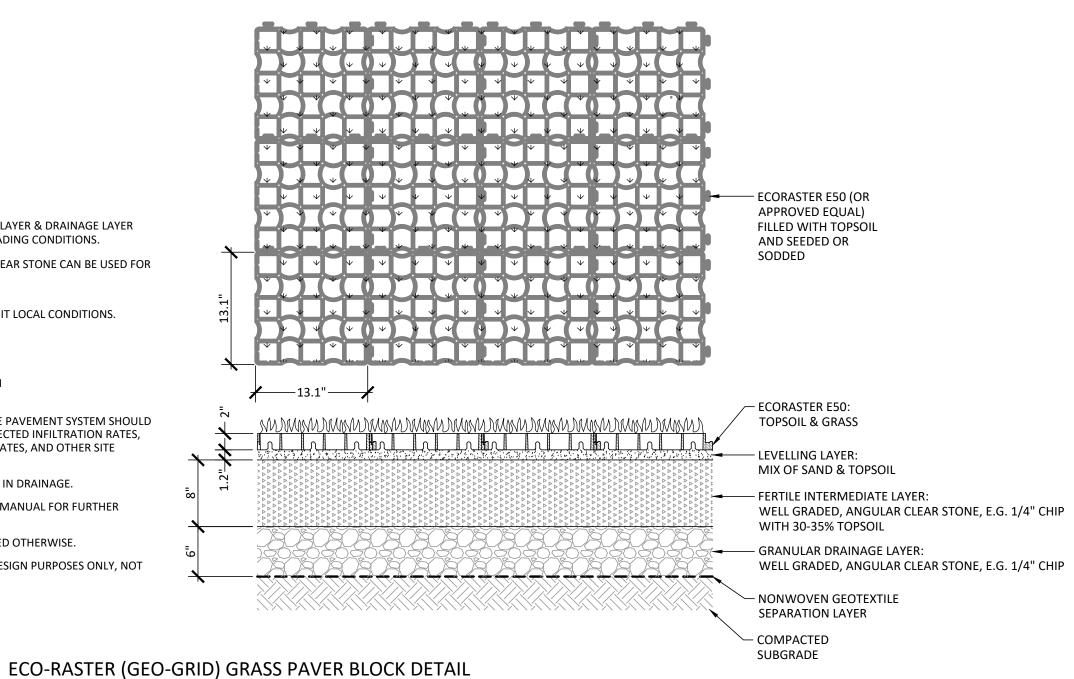

FOR PERMITTING ONLY NOT FOR CONSTRUCTION

PROJECT No.

DECEMBER 7, 2022

AS NOTED

6452

SCALE:

SHEET No.

SITE (

ZW,

IN ACCORDANCE WITH CERTIFICATE OF VOTE FOR AMENDING THE WAYLAND TOWN CENTER MIXED-USE PROJECT MASTER SPECIAL PERMIT, SPECIAL PERMITS AND SITE PLAN DECISION _____, 2023

> CONCRETE AGAINST UNDISTURBED MATERIAL **WATERMAIN <u>NOTE:</u>

<u>BEND-PLAN</u>

WATERMAIN— CONCRETE AGAINST -UNDISTURBED MATERIAL

<u>PLUG ELEVATION</u>

∕CONCRETE AGAINST UNDISTURBED MATERIAL

<u>TEE-PLAN</u>

TABLE OF BEARING AREAS (S.F.), AGAINST APPROVED UNDISTURBED NATURAL MATERIAL (MIN. OF 4 S.F.) DIAMETER MAIN (IN.) TEE 90 BEND | 45 BEND PLUG4 4 | 4 4 4 4 12 12

THRUST BLOCK DETAIL

(CALDWELL COUPLING)

(NOT TO SCALE)

SEE PLAN 1 HYDRANT 4' MIN. C MAIN VALVE GROUND LEVEL VALVE BOX RESILIENT SEATED 6" GATE VALVE CONCRETE THRUST BLOCKING PROVIDE 4 CUBIC FEET OF 1/2" TO 1" CRUSHED STONE TO MIN. OF 6" ABOVE DRAINHOLES. MECHANICAL JOINT FLAT STONE OR -CONCRETE BLOCK CONCRETE 6" D.I. WATER PIPE SEGMENT EXTENSION

1) CONCRETE FOR THRUST

AT 28 DAYS

BLOCKS SHALL HAVE A

MINIMUM COMPREHENSIVE

STRENGTH OF 2000 PSI

2) THRUST BLOCK BEARING

SOIL CONDITIONS

AREAS TO BE IN ACCORDANCE

WITH TABLE BELOW, UNLESS


DETERMINED OTHERWISE BY

THE ENGINEER BECAUSE OF

FIRE HYDRANT (NOT TO SCALE)


THRUST

BLOCKING

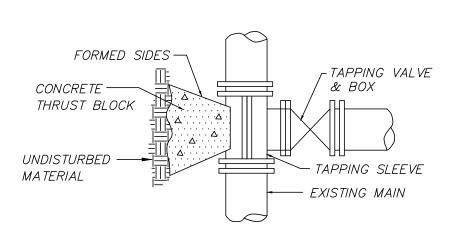

TAPPING VALVE AND SLEEVE:


(NOT TO SCALE)

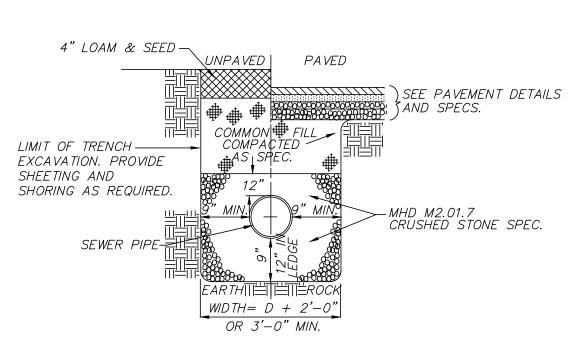


1. INSTALL BEDDING AND COMMON FILL IN 6 INCH LIFTS AND COMPACT TO 95% MAXIMUM DENSITY AT OPTIMUM MOISTURE CONTENT.

2. NON-METALLIC WARNING TAPE SHALL BE INSTALLED NO LESS THAN 24" ABOVE THE CROWN OF THE PIPE.

SEWER TRENCH DETAIL (NOT TO SCALE)

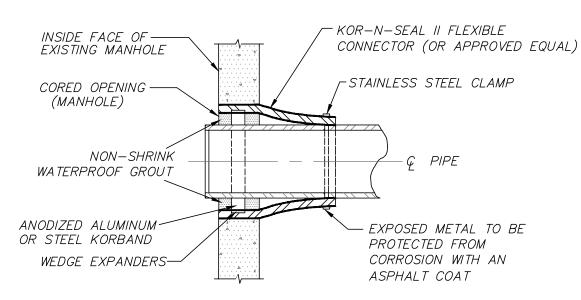

KOR-N-SEAL CONNECTION DETAIL (NOT TO SCALE)

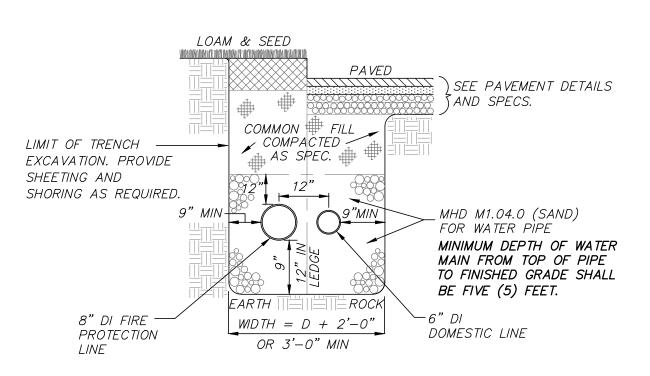



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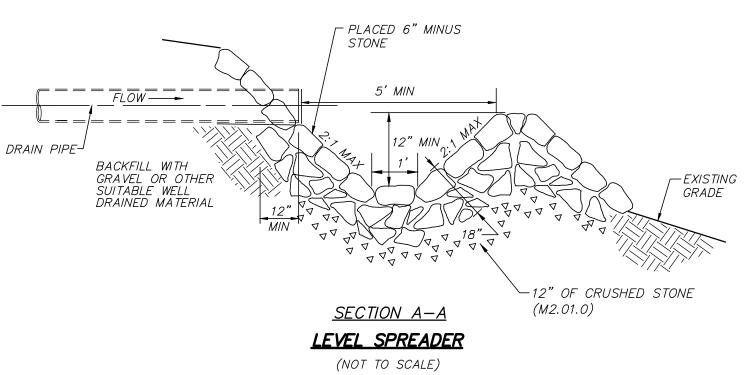
1. INSTALL BEDDING AND COMMON FILL IN 6 INCH LIFTS AND COMPACT TO 95% MAXIMUM DENSITY AT OPTIMUM MOISTURE CONTENT.


2. NON-METALLIC WARNING TAPE SHALL BE INSTALLED NO LESS THAN 24" ABOVE THE CROWN OF THE PIPE.

> WATER SERVICE TRENCH (NOT TO SCALE)



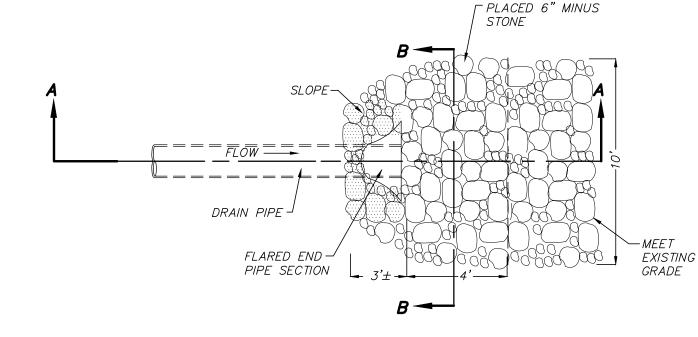

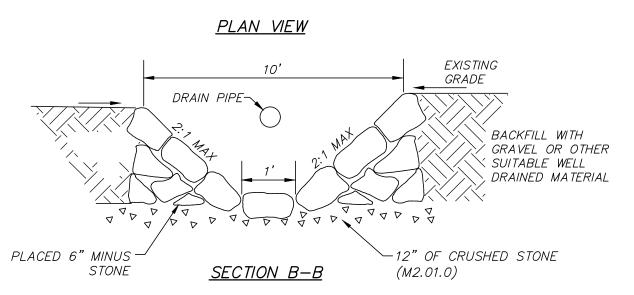

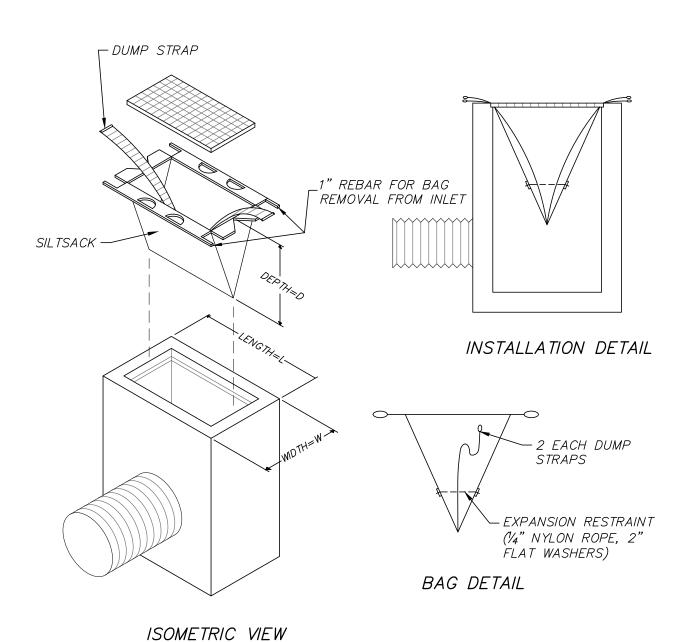

SILT SACKS SHALL BE INSPECTED WEEKLY AND SILT SHALL BE REMOVED WHEN ACCUMULATED TO ALLOW CATCH BASIN TO FUNCTION PROPERLY

> CATCH BASIN FILTER DETAIL (NOT TO SCALE)

FIL TERMITT COMPONENTS:

OUTSIDE CASING: 100% ORGANIC HESSIAN

FILLER INGREDIENT: FIBER ROOT MULCH

RUNOFF • BLEND OF COARSE & FINE COMPOST & SHREDDED WOOD • PARTICLE SIZES: 100% PASSING A 3" SCREEN; 90-100% PASSING A 1" SCREEN;

> 30-75% PASSING A 0.25" SCREEN WEIGHT: APPROXIMATELY 850 LBS/CUYD (AVE 30 LBS/LF)

70-100% PASSING A 0.75" SCREEN:

<u>NOTE:</u>

PROVIDE FILTERMITT EROSION CONTROL AS MANUFACTURED BY GROUNDSCAPES EXPRESS, INC P.O. BOX 737 WRENTHAM, MA. 02093 (508)-384-7140 OR EQUAL

FILTERMITT INSTALLATION:

SECTIONS CAN BE CONSTRUCTED ON SITE IN LENGTHS FROM 1' TO 100'.

SECTIONS CAN ALSO BE DELIVERED TO THE SITE IN LENGTHS FROM 1' TO 8'.

THE FLEXIBILITY OF FILTERMITT ALLOWS IT TO CONFORM TO ANY CONTOUR TERRAIN WHILE HOLDING A SLIGHTLY OVAL SHAPE AT 12" HIGH BY 12" WIDE.

WHERE SECTION ENDS MEET, THERE SHALL BE AN OVERLAP OF 6" OR GREATER.

<u>EROSION CONTROL SOCK — FILTERMITT DETAIL</u>

WORK

AREA

DISTURBED

AREA

(WORK AREA)

UNION TOP VIEW

WORK

AREA

AREA

FILTERMIT

UNION SECTION VIEW

NATIVE SOIL

RUNOFF

RUNOFF

> FLOW

FILTERMITT


PROTECTED


AREA

TOP VIEW

PROTECTED


(NOT TO SCALE)

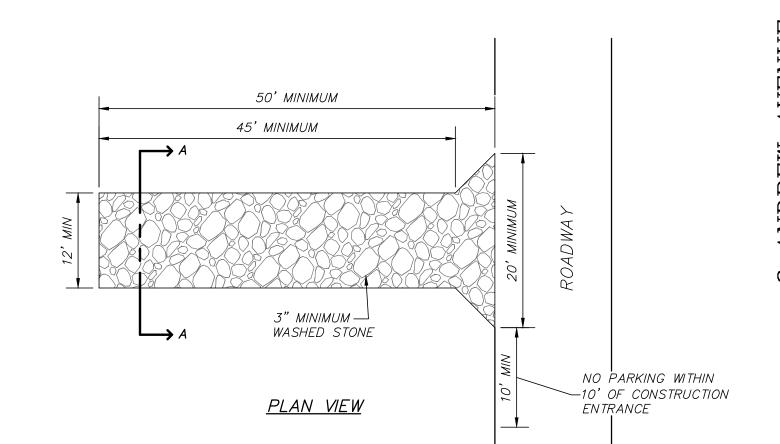

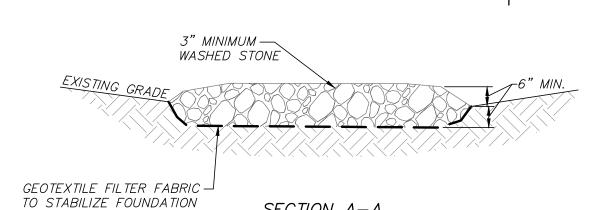

TEMPORARY STABILIZED CONSTRUCTION ENTRANCE (NOT TO SCALE)

SECTION A-A

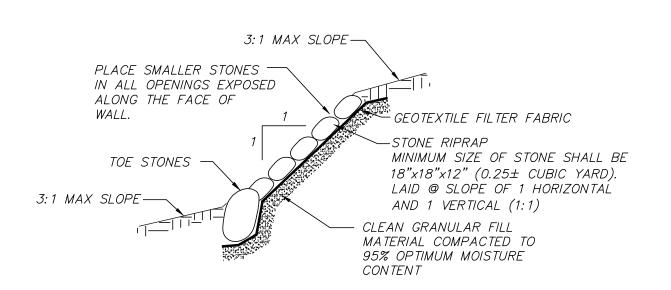

STONE RIPRAP SLOPE PROTECTION

(NOT TO SCALE)

CONS

SITE


ZH,

DECEMBER 7, 2022 SCALE:


AS NOTED SHEET No.

8.0PROJECT No. 6452

FOR PERMITTING ONLY NOT FOR CONSTRUCTION

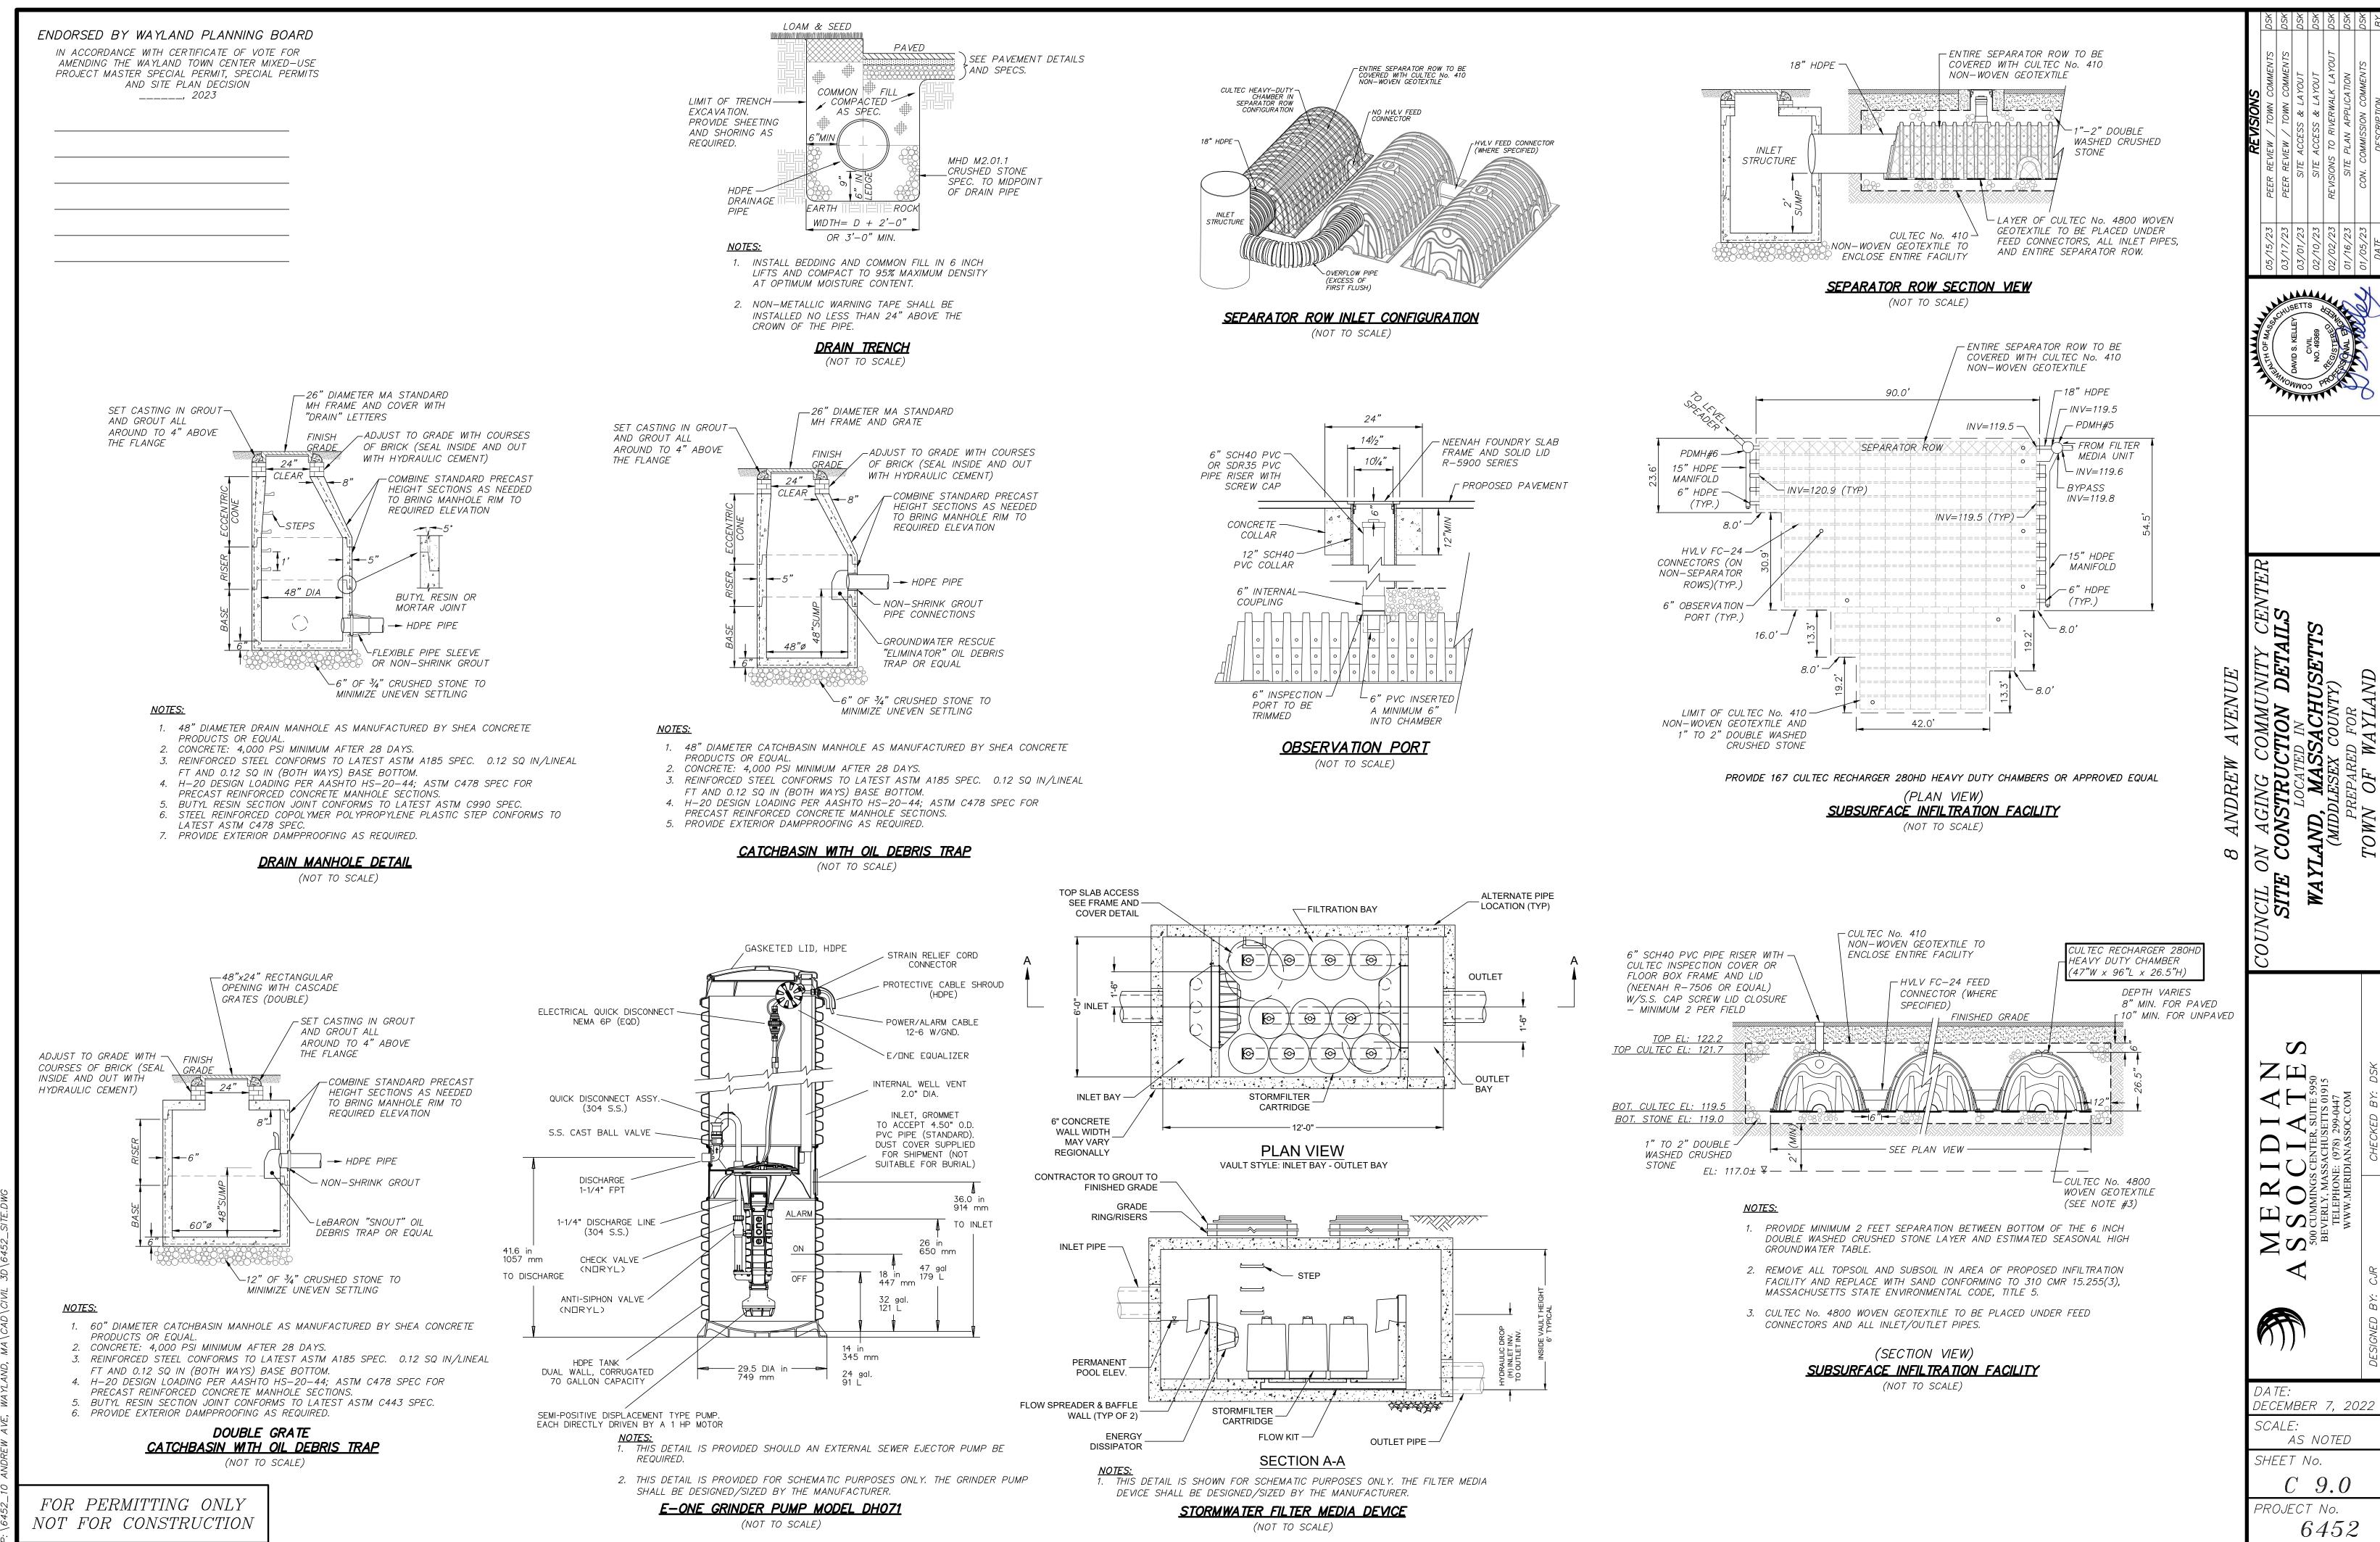

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2-1/2" (+/-)

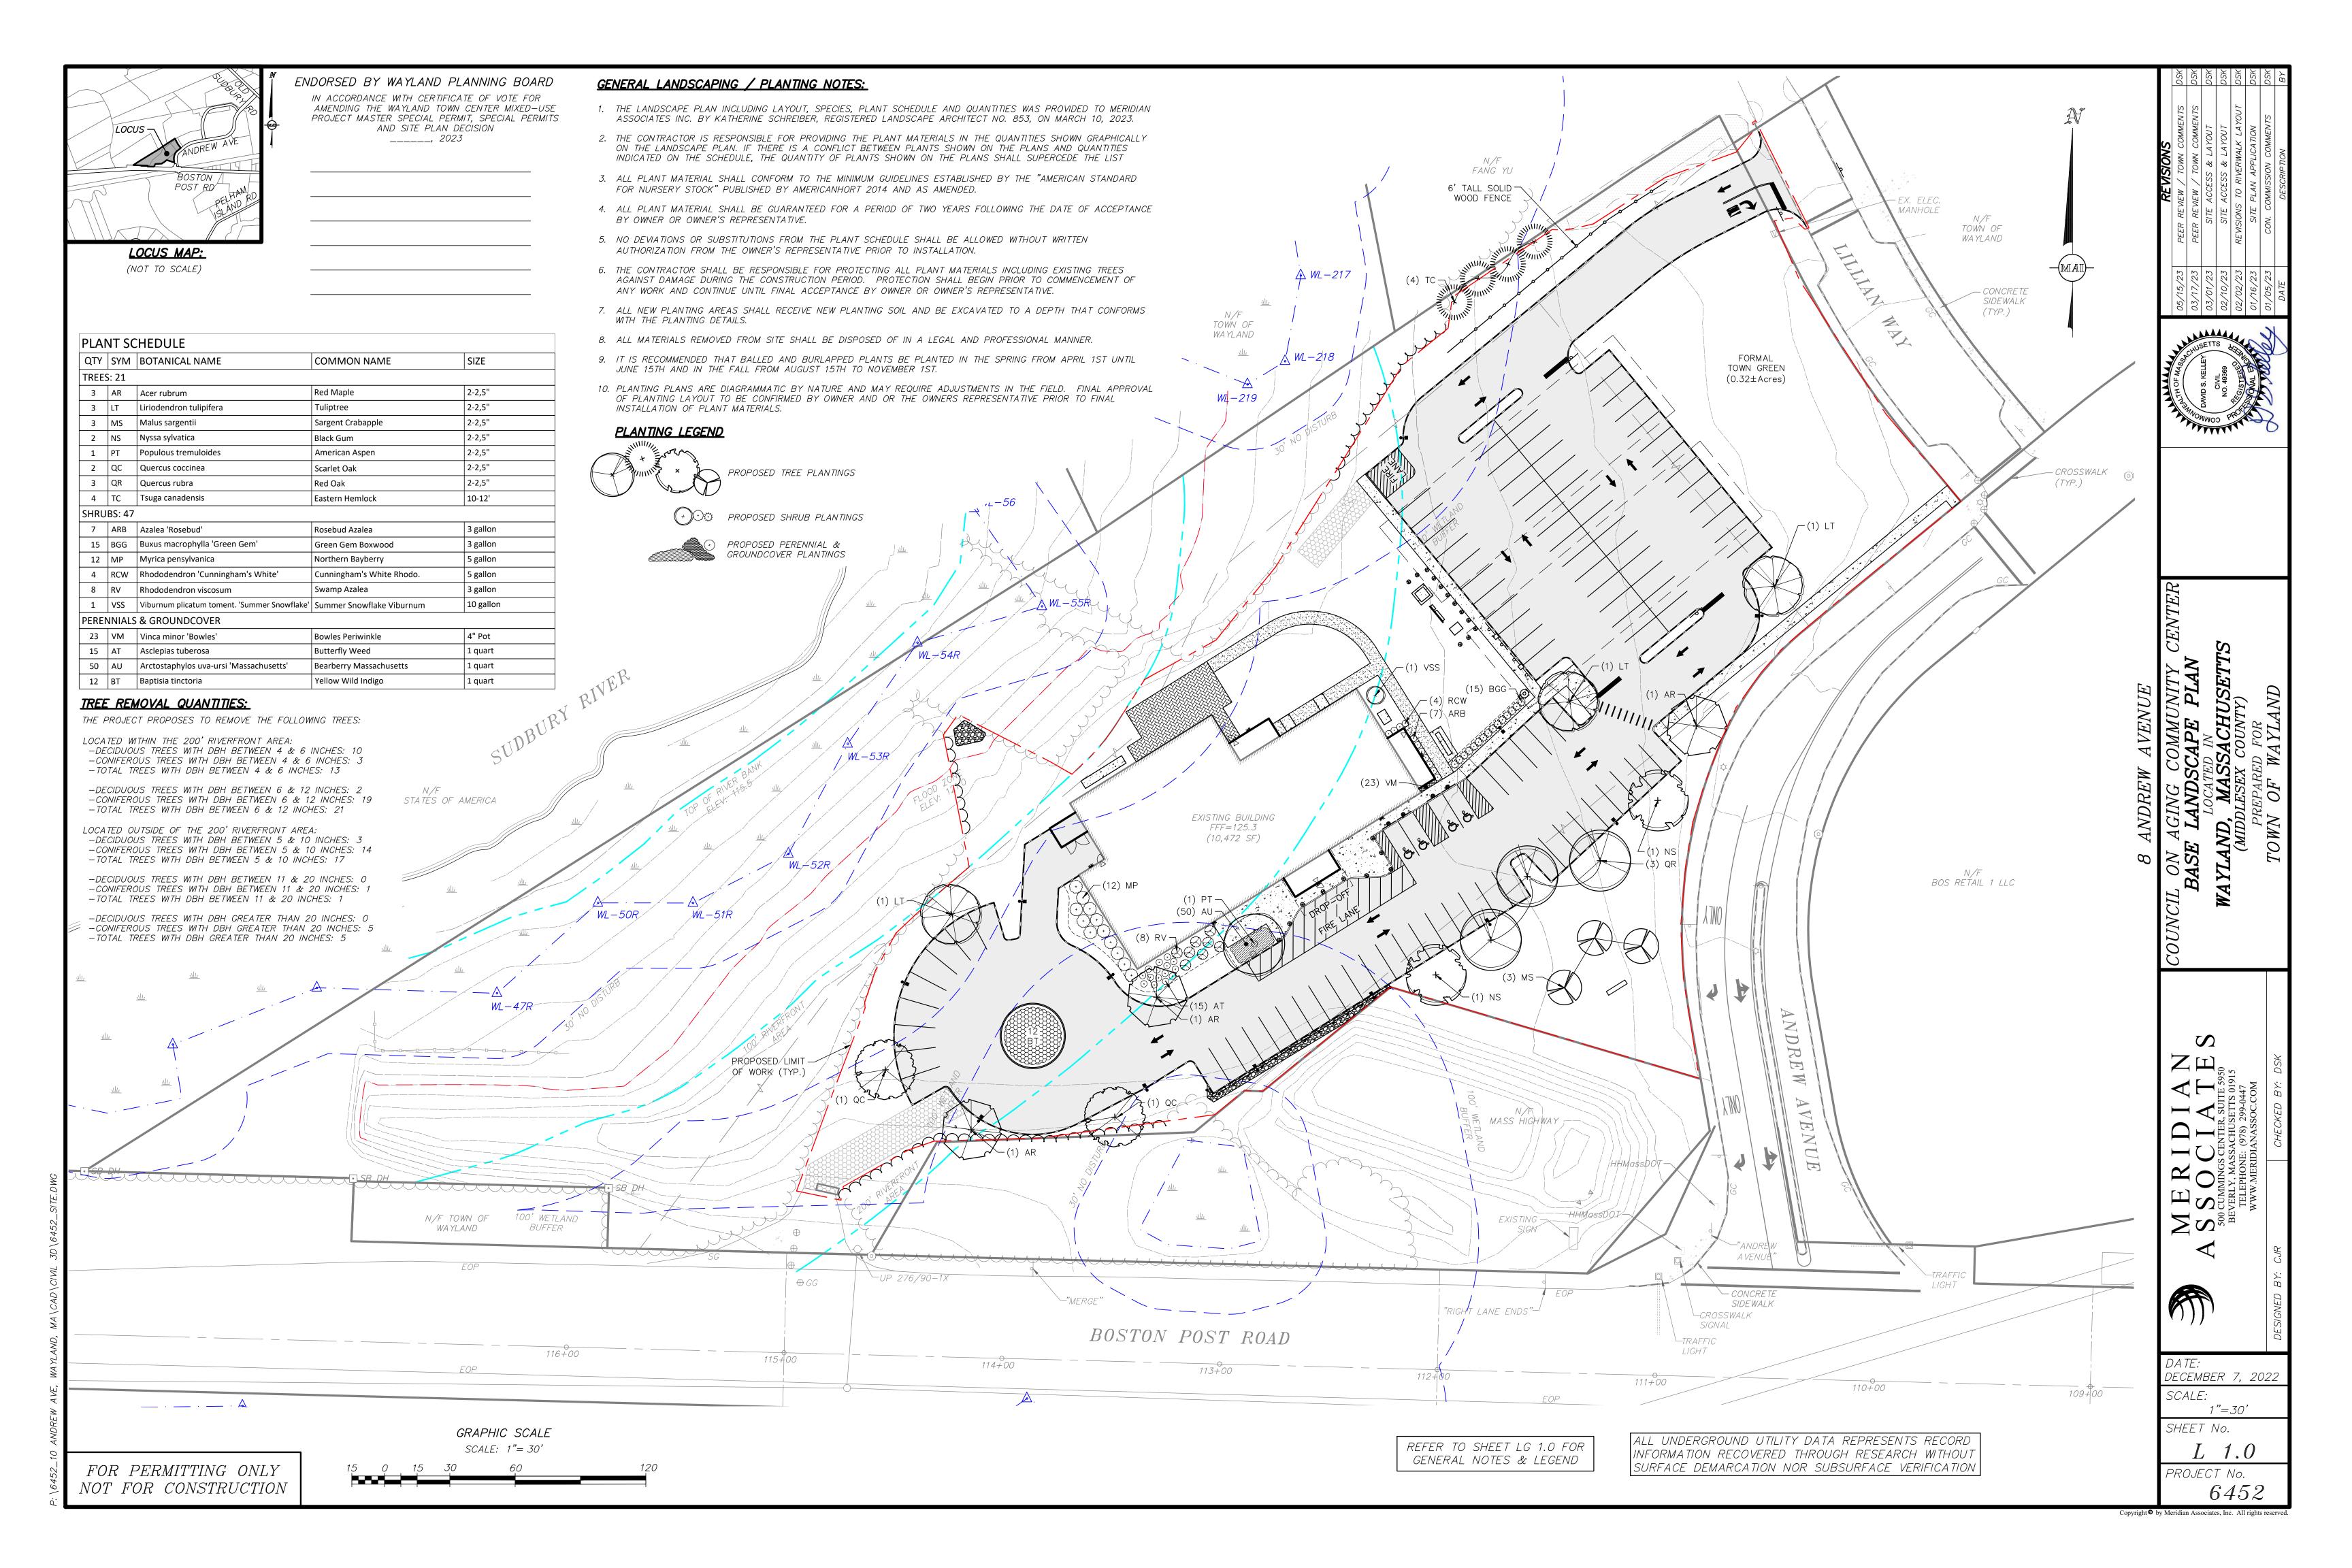FENCE POST

6 to 7 Cuts

\ for Point Top (Typ.)

PICKET

POST

- TOP OF PICKETS

∠*GROUND*

SINGLE NAIL

AND MIDDLE

SECTION-FACE SIDE

6' TALL WOODEN STOCKADE FENCE

(NOT TO SCALE)

– BOTTOM OF FENCE FABRIC

6' TALL WOODEN STOCKADE FENCE

FOOTING DETAIL

(NOT TO SCALE)

— FENCE POST

UNDISTURBED OR

3,000 PSI CONCRETE

FOOTING

IS FULLY CONCEALED.

COMPACTED SUBGRADE

1. INSTALL TOP OF CONCRETE FOOTING 2-1/2" BELOW FINISH GRADE.


2. REFER TO SPECIFICATION FOR SIZE OF

CORNER, TERMINAL AND GATE POSTS. 3. INCREASE FENCE HEIGHT AS NECESSARY FOR DUMPSTER ENCLOSURE TO ENSURE DUMPSTER


– FINISH GRADE - MATERIAL VARIES. SEE PLANS.

1" (Typ.) CLEARANCE (UNDER FENCE)

SECTION-FRAME SIDE

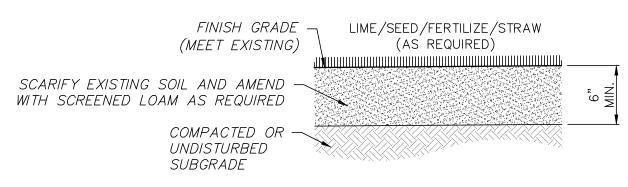


LOAM & SEEDING

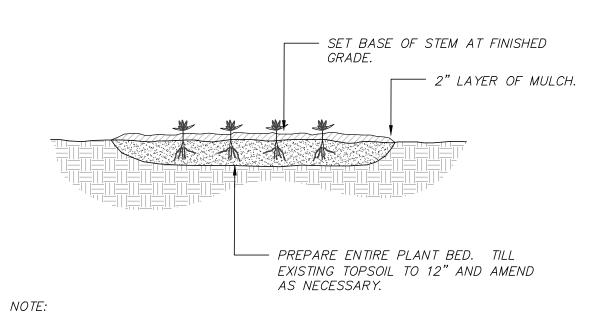

SPACE PLANTS EQUALLY TO PROVIDE CONSISTENT COVER OVER INDICATED PLANTING BED.

GROUNDCOVER PLANTING (NOT TO SCALE)

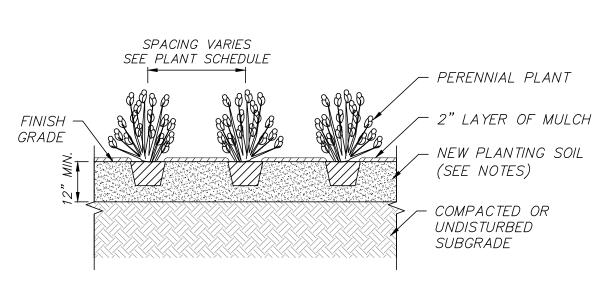

NOTES:

- 1. SEE LANDSCAPE NOTES FOR ADDITIONAL PLANTING REQUIREMENTS.
- 2. SPACE PLANTS EQUALLY TO PROVIDE CONSISTENT COVER OVER INDICATED PLANTING BED.
- 3. ALL ROOT BALLS TO BE SCARIFIED PRIOR TO BACKFILLING.

GROUNDCOVER / ANNUAL / PERENNIAL PLANTING

∕ 4" LAYER OF MULCH. KEEP MULCH 2" BACK FROM TRUNK. TRUNK FLARE TO REMAIN 1"-2" ABOVE FINISH GRADE.

CUT AND REMOVE AS MUCH BURLAP AS POSSIBLE, IF NON BIODEGRADABLE REMOVE ENTIRELY. WIRE BASKETS TO BE REMOVED ENTIRELY.


EXCAVATE PLANTING HOLE TO A WIDTH THREE TIMES THE DIAMETER OF THE ROOTBALL AND A DEPTH EQUAL TO THE HEIGHT.

COMPACT 6" MIN. LAYER OF NEW PLANTING SOIL BELOW ROOT BALL

NOTES:

- 1. BACKFILL PLANTING HOLE WITH NEW PLANTING SOIL.
- 2. BACKFILL HALF THE SOIL AND WATER TO SETTLE OUT AIR POCKETS, COMPLETE BACKFILLING AND REPEAT WATERING.
- 3. IF ROOTS ARE CIRCLING THE ROOTBALL EXTERIOR, CUT ROOTS VERTICALLY IN SEVERAL PLACES PRIOR TO PLANTING.


SHRUB PLANTING

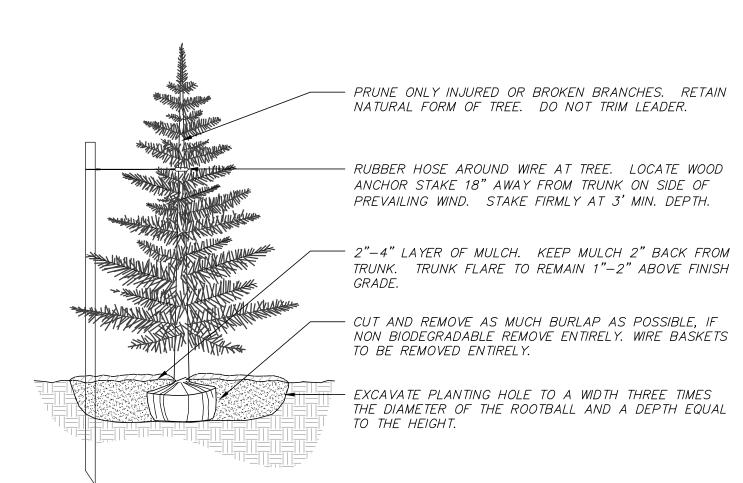

NOTES:

- 1. BACKFILL PLANTING HOLE WITH EXISTING SOIL AMENDED AS NECESSARY.
- 2. BACKFILL HALF THE SOIL AND WATER TO SETTLE OUT AIR POCKETS, COMPLETE BACKFILLING AND REPEAT
- 3. IF ROOTS ARE CIRCLING THE ROOTBALL EXTERIOR, CUT ROOTS VERTICALLY IN SEVERAL PLACES PRIOR TO
- 4. ONLY STAKE TREES SITUATED ON WINDY SITES OR EXPOSED TO SUBSTANTIAL PEDESTRIAN TRAFFIC.

EVERGREEN TREE PLANTING (NOT TO SCALE)

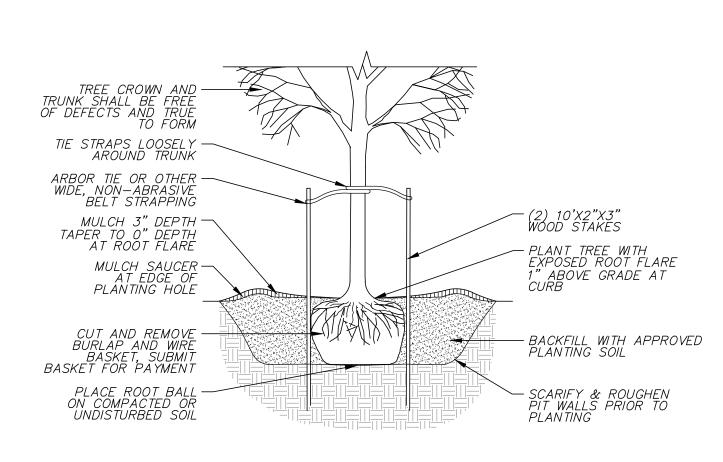


TREE PLANTING (NOT TO SCALE)

DECEMBER 7, 2022 SCALE: AS NOTED

SHEET No.

PROJECT No. 6452

FOR PERMITTING ONLY NOT FOR CONSTRUCTION

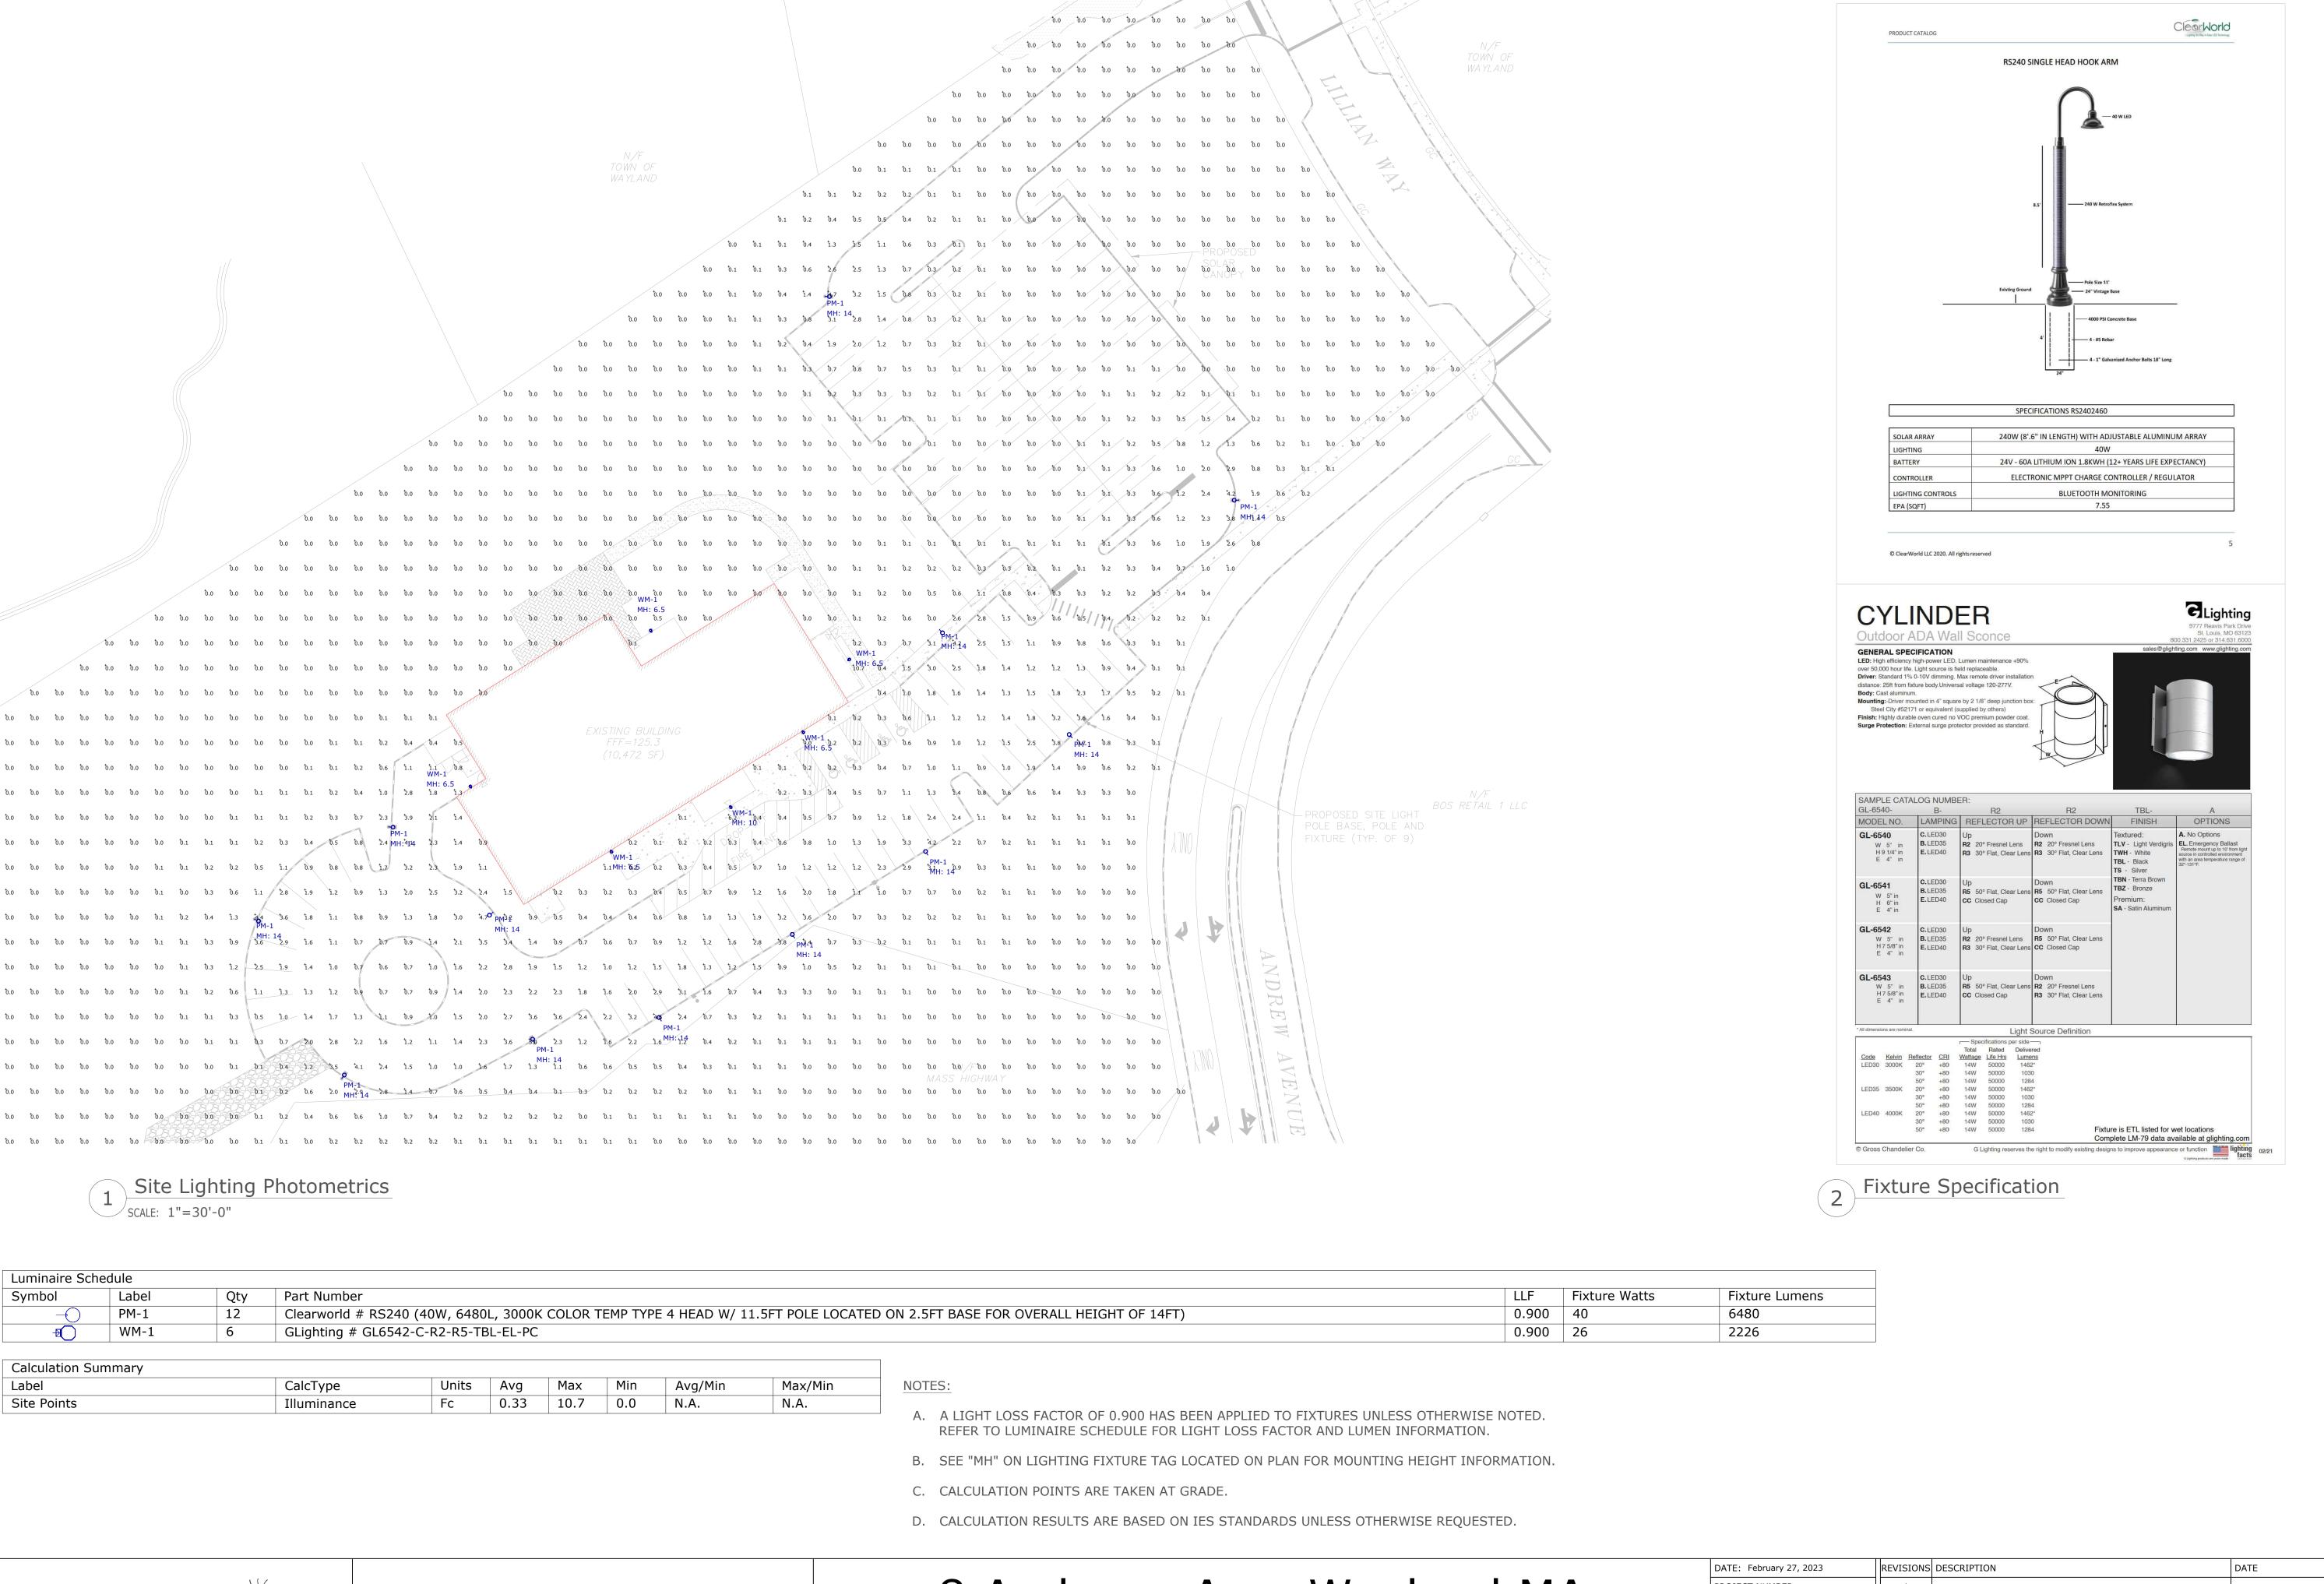

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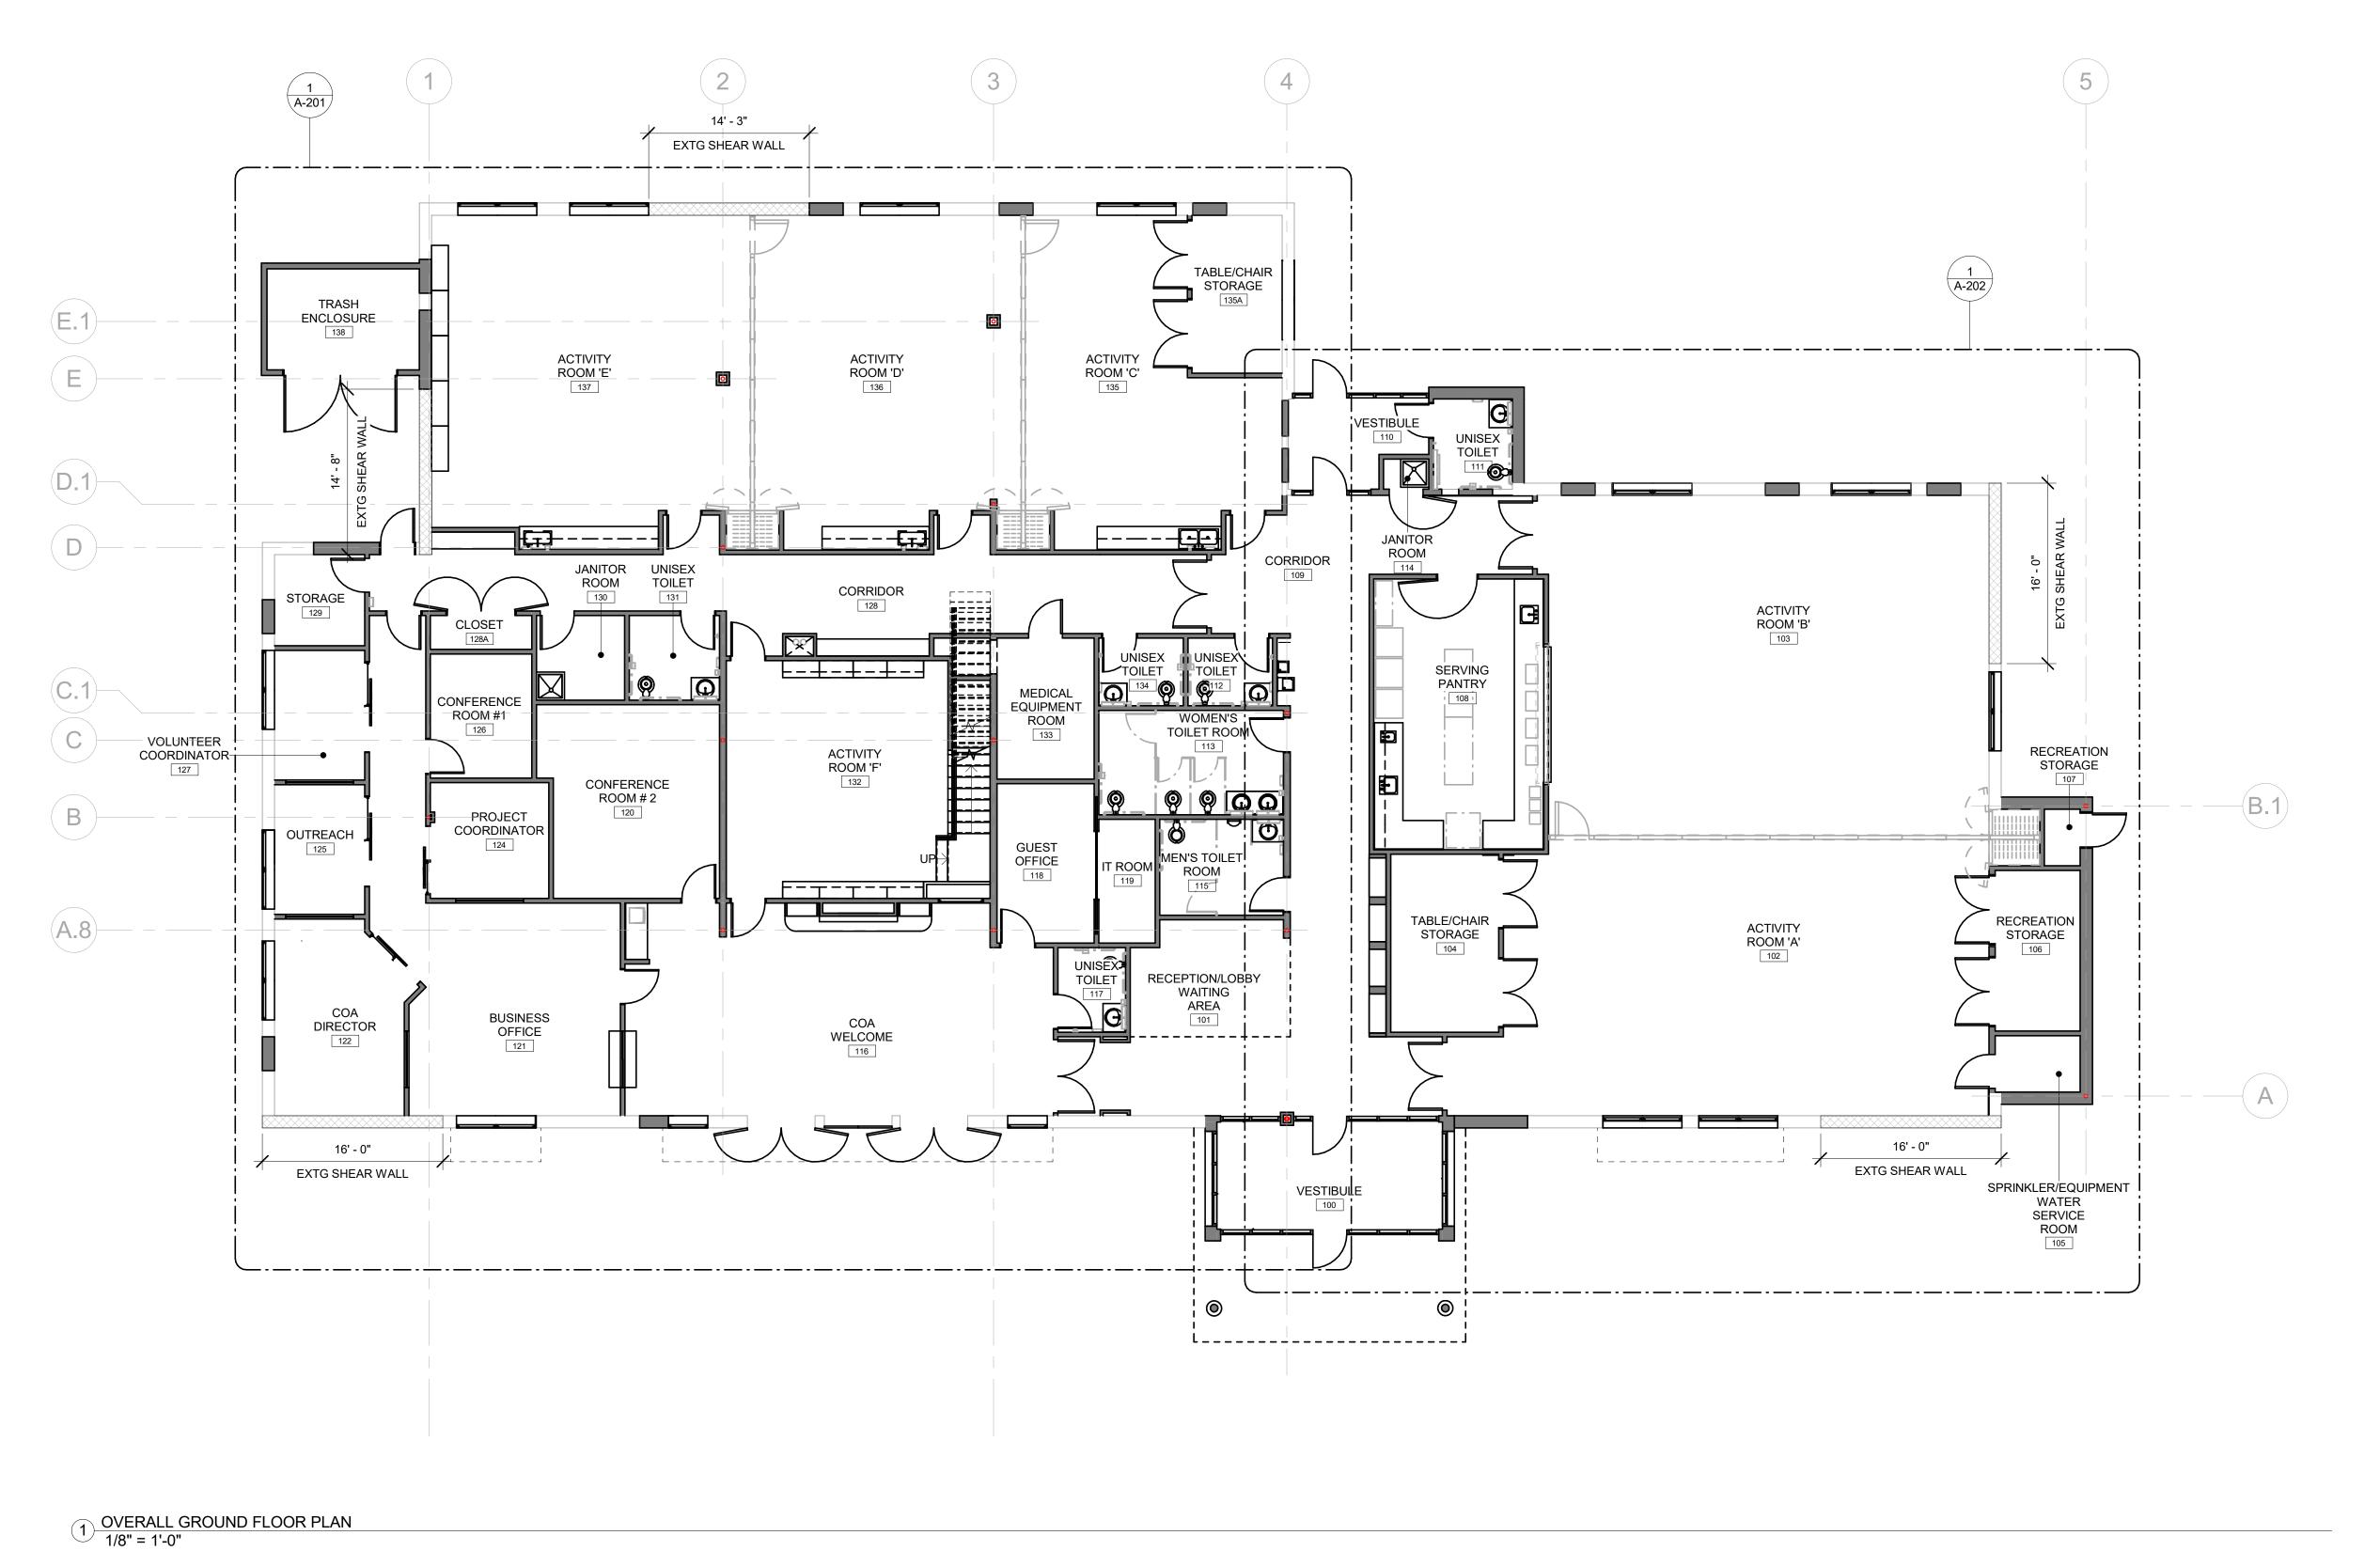
529 Main Street, Suite 3303 Boston, MA 02129

8 Andrews Ave, Wayland MA

Site Lighting Photometrics, Schedules & Specifications

REVISIONS DESCRIPTION	DATE
1	
2	
3	
4	
5	
6	
7	
	1 2 3 4 5 5 6

SL1



LOCATION OF RELOCATED

A 09/19/2022 100% DD SET
B 10/12/2022 50% CD SET
C 11/23/2022 90% CD SET
D 01/04/2023 PLANNING BOARD APPLICATION

ISSUE/REVISION:

NO: DATE:

CONSULTANT:

TOWN OF WAYLAND

COMMUNITY CENTER

A LiRo Group Company

PORTLAND

529 MAIN STREET, SUITE 3303

BOSTON, MA 02129 TEL. 617.723.7100

500 WASHINGTON AVE

TEL. 207.582.2400

FAX. 207.582.8320


FAX. 617.723.9113

WAYLAND CoA

8 ANDREW AVENUE,

WAYLAND, MA 01778

KEN DI

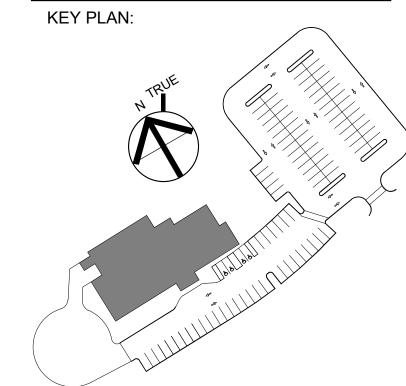

DRAWING TITLE:
OVERALL GROUND AND
MEZZENINE FLOOR PLAN

DRAWN BY:

MK

CHECKED BY:

TA

SCALE:

1/8" = 1'-0"

PROJECT NO.:

21-125-2125.04

DRAWING NO.:

A-200

PROJECT LOCATION:
BIM 360://Town of Wayland On Call TASK ORDER#4/Wayland On 08-24-22.rvt

DATE & TIME PRINTED: 11/23/2022 2:55:53 PM


APPROXIMATE BUILDING AREA CALCULATIONS:

GROUND FLOOR: 11,000 SF MEZZANINE: 1,800 SF GROSS FLOOR AREA: 12,800 SF 2 MEZZENINE FLOOR PLAN 1/8" = 1'-0"

GENERAL NOTES

- WALLS CALLED OUT AS EXISTING MAY BE DEMOLISHED IN PART FOR NEW CONSTRUCTION REQUIREMENTS. THE CONTRACTOR IS RESPONSIBLE TO RECONSTRUCT THESE WALL AS PART OF THE PROJECT.
- CONTRACTOR IS RESPONSIBLE FOR VERIFYING EXISTING CONDITIONS. NOTIFY ARCHITECT OF ANY DISCREPANCIES BETWEEN CONSTRUCTION DOCUMENTS AND FIELD CONDITIONS.

 CONTRACTOR TO PROVIDE IN WALL BLOCKING FOR ALL MOUNTED FURNITURE AND
- CONTRACTOR TO PROVIDE IN WALL BLOCKING FOR ALL MOUNTED FURNITURE AND EQUIPMENT. CONTRACTOR TO DETERMINE LOCATIONS WHERE IN WALL BLOCKING OR RECESSED EQUIPMENT IS NOT POSSIBLE DUE TO EXISTING WALL CONSTRUCTION. NOTIFY ARCHITECT OF ANY DISCREPANCIES.
- CONTRACTOR TO VERIFY THE EXISTENCE AND LOCATION OF UTILITIES AND PLUMBING, MECHANICAL AND ELECTRICAL SYSTEMS. THE EXISTENCE AND LOCATIONS INDICATED IN THE CONSTRUCTION DOCUMENTS ARE NOT GUARANTEED.

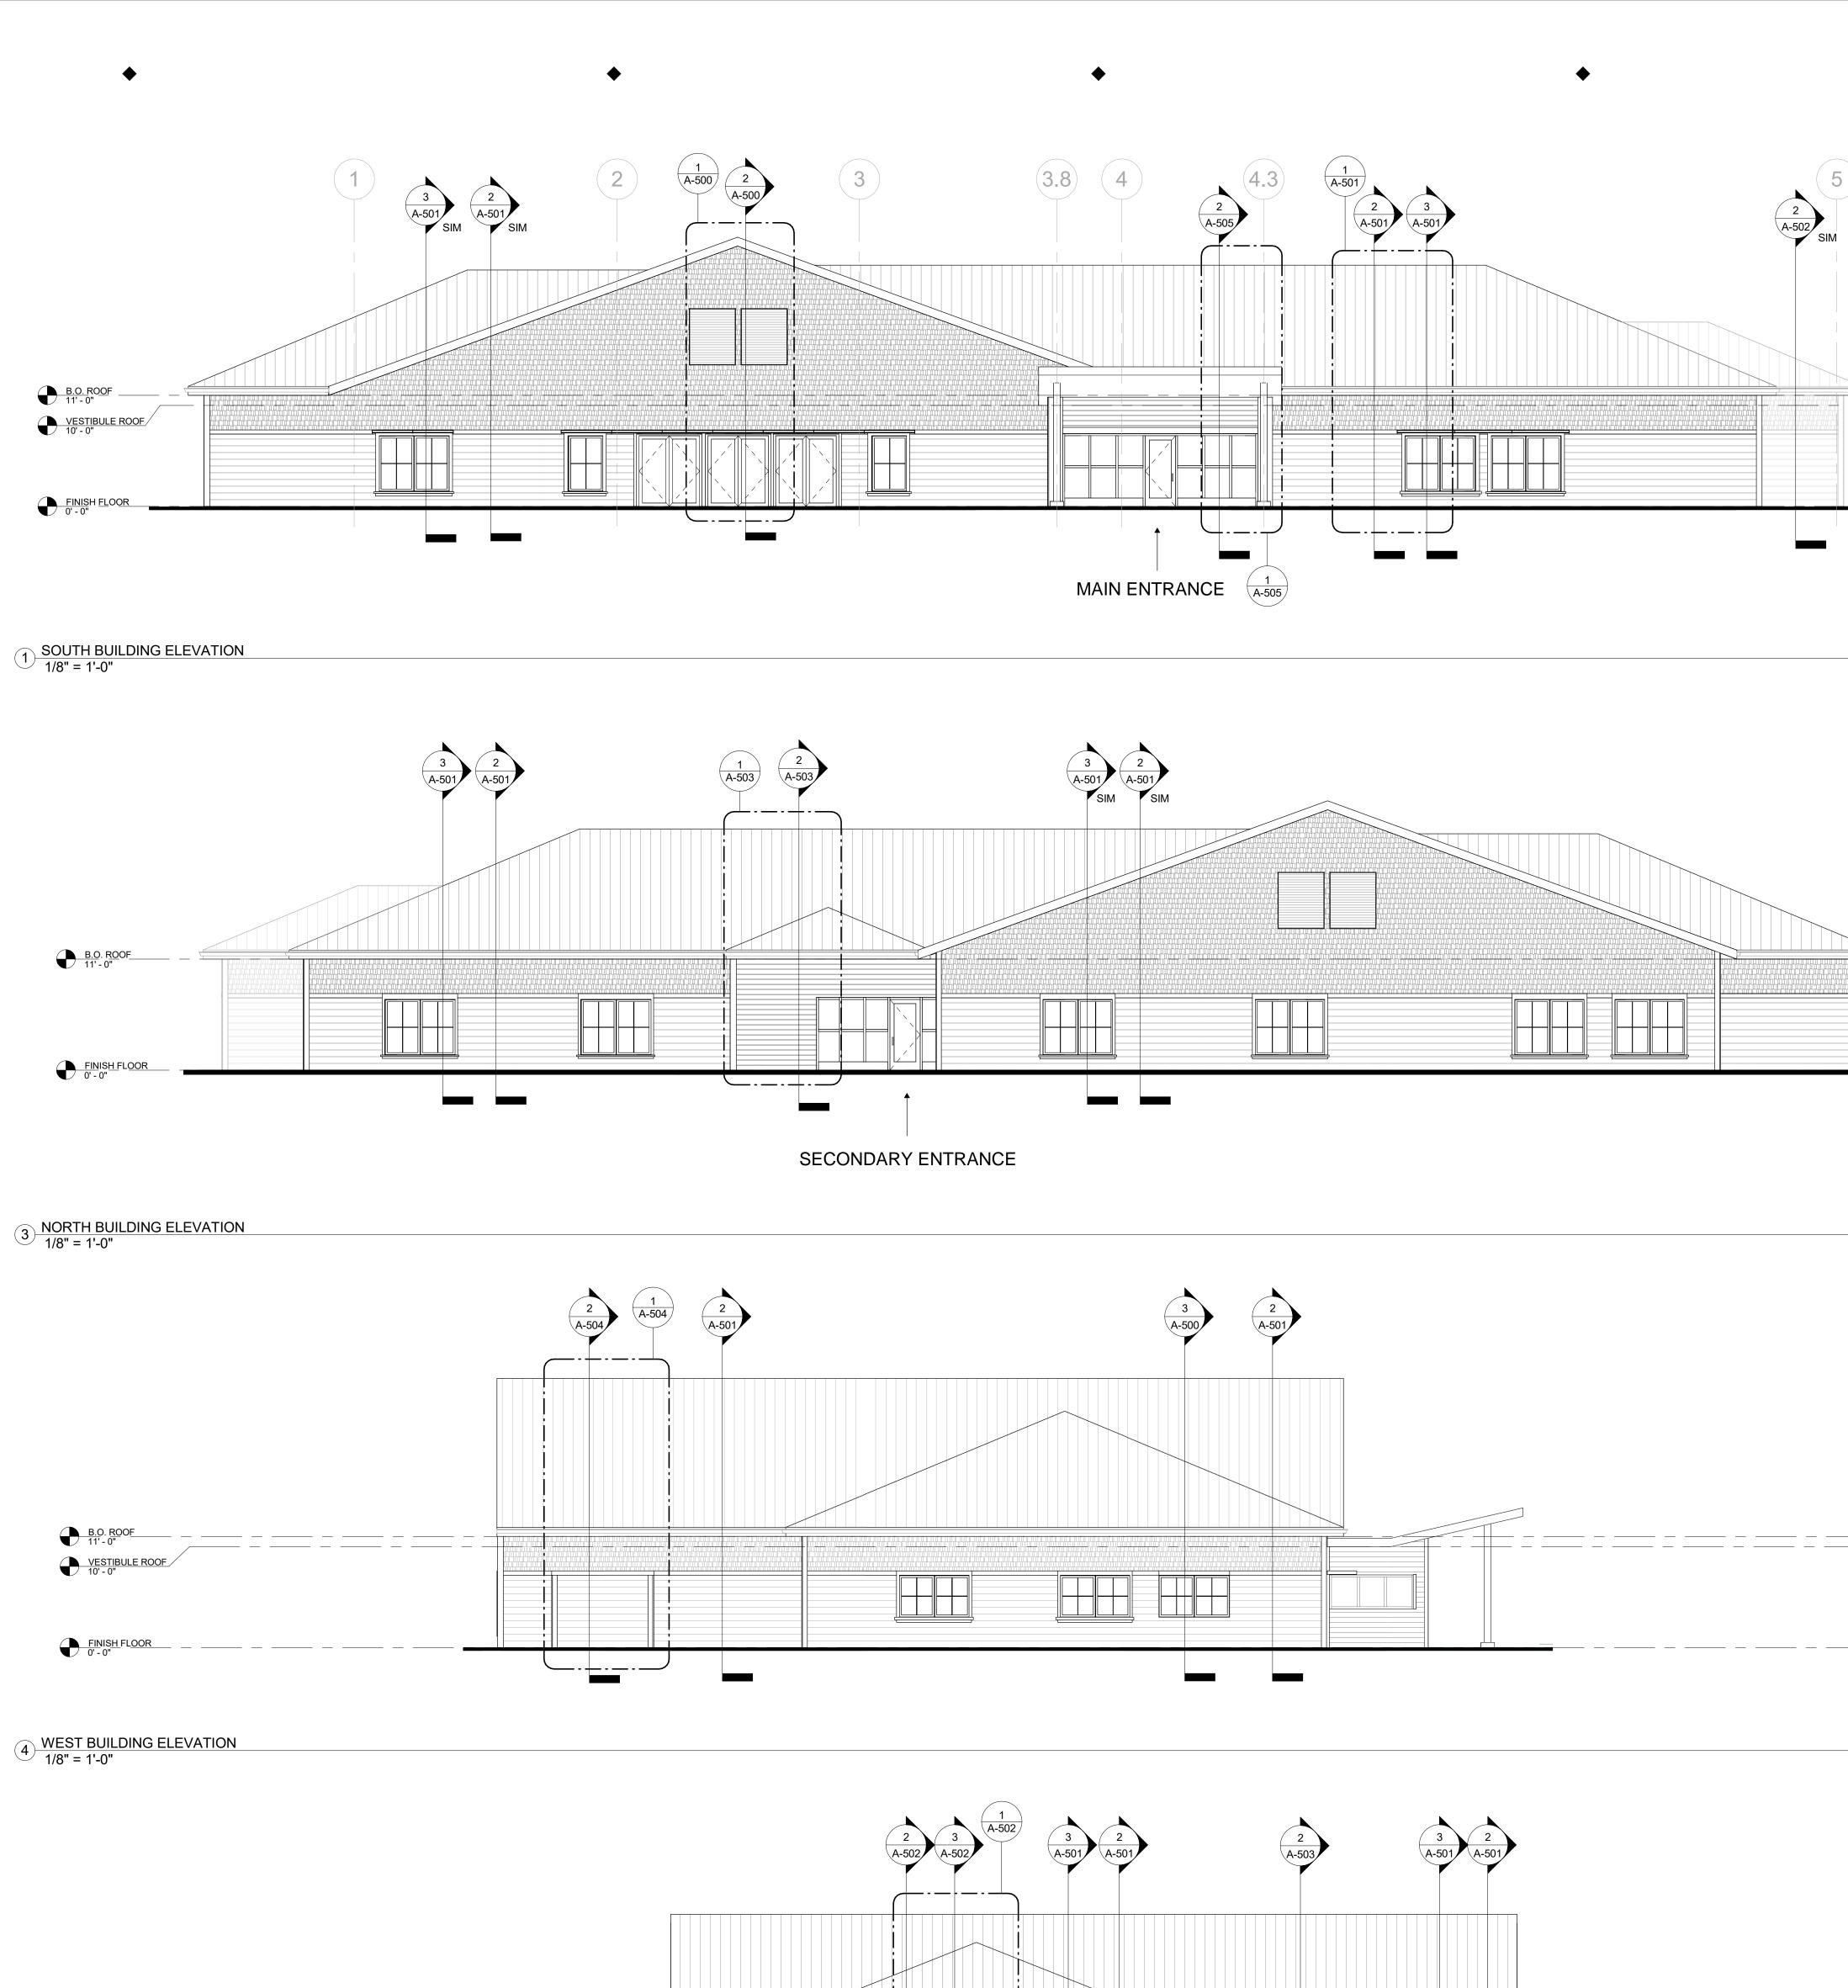

VESTIBULE ROOF 10' - 0"

2 EAST BUILDING ELEVATION 1/8" = 1'-0"



TOWN OF WAYLAND

WAYLAND CoA
COMMUNITY CENTER
8 ANDREW AVENUE,
WAYLAND, MA 01778



CHITECTURE

ANNING
ERIOR DESIGN

B.O. ROOF 11' - 0"

VESTIBULE ROOF 10' - 0"

> FINISH FLOOR 0' - 0"

> > B.O. ROOF 11' - 0"

VESTIBULE ROOF 10' - 0"

VESTIBULE ROOF 10' - 0" BOSION

529 MAIN STREET, SUITE 3303

BOSTON, MA 02129

TEL. 617.723.7100

FAX. 617.723.9113


PORTLAND

500 WASHINGTON AVE
PORTLAND, ME 04103
TEL. 207.582.2400
FAX. 207.582.8320

CONSULTANT:

NO:	DATE:	DESCRIPTION:
A	09/19/2022	100% DD SET
В	10/12/2022	50% CD SET
C	11/23/2022	90% CD SET
D	01/04/2023	PLANNING BOARD APPLICATION
		_

KEV DI /

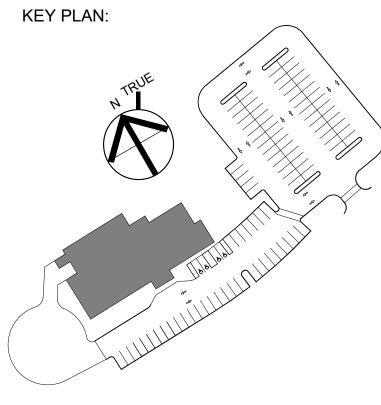

DRAWING TITLE:
EXTERIOR ELEVATIONS

DRAWN BY:	SEAL:
CHECKED BY:	
TA	
SCALE:	
1/8" = 1'-0"	
PROJECT NO.:	
21-125-2125.04	
DRAWING NO.:	

A-400

PROJECT LOCATION:
BIM 360://Town of Wayland On Call TASK ORDER#4/Wayland On 08-24-22.rvt

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